

CITY OF COLWOOD

3300 Wishart Road | Colwood | BC V9C 1R1 | 250 294-8153 planning@colwood.ca | www.colwood.ca

File: DP-23-003

DEVELOPMENT PERMIT DP-23-003

THIS PERMIT, issued March 29 2023 is,

ISSUED BY: CITY OF COLWOOD, a municipality incorporated under the Local Government Act, 3300 Wishart Road, Victoria, BC, V9C 1R1

(the "City")

PURSUANT TO: Section 490 of the Local Government Act, RSBC 2015, Chapter 1

ISSUED TO: Verity Construction Ltd 106-1039 Langford Parkway Victoria, BC V9B 0A6

(the "Permittee")

 This Form and Character Development Permit applies to those lands within the City of Colwood described below, and any and all buildings, structures, and other development thereon:

> LOT 72, 73 & 74 PLAN EPP117070 SECTION 38 ESQUIMALT 404, 401 & 405 Rock Dove Place (the "Lands")

- This Development Permit regulates the development and alterations of the Land, and supplements the "Colwood Land Use Bylaw, 1989" (Bylaw No. 151), to ensure the form and character considerations for 3 single family home with secondary suites and associated site improvements are consistent with the design guidelines for areas designated as "Neighbourhood – Intensive Residential" in the City of Colwood Official Community Plan (Bylaw No. 1700).
- 3. This Development Permit is NOT a Building Permit or a subdivision approval.
- This Development Permit is issued subject to compliance with all of the bylaws of the City of Colwood that apply to the development of the Lands, except as specifically varied by Council or supplemented by this Permit, including DP-21-008.
- 5. The Director of Development Services or their delegate may approve minor variations to the schedules attached to and forming part of this Development Permit, provided that such minor variations are consistent with the overall intent of the original plans and do not alter the form and character of the development authorized by those plans.
- If the Permittee does not substantially start the construction permitted by this Permit within 24 months of the date of this Permit, the Permit shall lapse and be of no further force and effect.

DEVELOPMENT PERMIT DP-23-003_404, 401 & 405 Rock Dove Place

The development is to be constructed in accordance with the following plans and specifications, which are attached to and form as part of this permit:

Schedule 1	Site Plan, Architectural Drawings, Elevation Drawings, Landscape Plan and
	Grading Plan for 404 Rock Dove Place dated March 14, 2023
Schedule 2	Site Plan, Architectural Drawings, Elevation Drawings, Landscape Plan and
	Grading Plan for 401 Rock Dove Place dated March 16, 2023
Schedule 3	Site Plan, Architectural Drawings, Elevation Drawings, Landscape Plan and
	Grading Plan for 405 Rock Dove Place dated March 22, 2023

 This Development Permit authorizes the construction of 3 single family home with secondary suites along with any associated site works. The Land shall not be altered, nor any buildings or structures constructed, except in accordance with the following conditions:

FORM AND CHARACTER CONDITIONS

General

8.1. The form and character of the building to be constructed on the Lands shall conform to the drawings attached to this permit as schedules.

Building Features

- 8.2. The form and character of the buildings to be constructed on the Lands shall conform to the Site Plan and Architectural Drawings prepared by Victoria Design Group (Schedules 1, 2 and 3).
- 8.3. Any future additions of telecommunications antennas or equipment to the exterior of the buildings and/or structures included in this Permit shall be architecturally integrated into the buildings and/or structures they are mounted on or screened from views so as not to be visually obtrusive, to the satisfaction of the Director of Development Services.
- 8.4. No future construction/installation of unenclosed or enclosed outdoor storage areas, and recycling/refuse collection and storage areas shall be undertaken without the issuance of a further Development Permit or amendment to this Permit.
- 8.5. All mechanical roof elements, including mechanical equipment, elevator housings, and vents shall be visually screened with sloped roofs or parapets, or other forms of solid screening to the satisfaction of the Director of Development Services.

Landscaping

8.6. The design and construction of the proposed landscaping shall be in substantial compliance with the Landscape Plan prepared by Verity Construction (Schedules 1, 2 and 3).


Grading


8.7. The site specific lot grading shall be in substantial compliance with the Building Grading Slip prepared by Gablecraft Homes (Schedules 1, 2 and 3).

ISSUED ON THIS <u>29</u> DAY OF MARCH, 2023 Robert Earl


Chief Administrative Officer

SITE DATA	RBCD5	LOT 72
ITEMS	PERMITTED	PROPOSED
LOT AREA	368 sq.m.	485.89 sq.m.
LOT COVERAGE	50.00 %	32.28 %
BUILDING HEIGHT	9.50 m.	6.80 m.
LOT WIDTH	10.97 m.	19.51 m.
Setbacks		
- FRONT	3.00 m.	6.11 m.
- FRONT (GARAGE)	6.00 m.	6.83 m.
- REAR	6.00 m.	6.00 m.
- SIDE	1.20 m.	1.37 m.
- SIDE	1.20 m.	1.27 m.
PROPOSED FLOOR AREA		
- MAIN		145.39 sq.m.
- LOWER		91.16 sq.m.
- GARAGE		52.35 sq.m.
SUB-TOTAL G.F.A.		288.90 sq.m.
GARAGE ALLOWANCE	50.00 sq.m.	-50.00 sq.m.
GROSS FLOOR AREA		238.90 sq.m.
F.A.R.		0.49 TO 1.0
SECONDARY SUITE		
FLOOR AREA (%)	40.00 %	32.16 %
FLOOR AREA (SQ.M.)	90.00 sq.m.	76.84 sq.m.

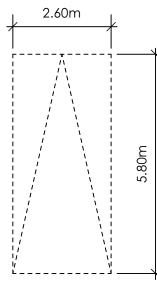

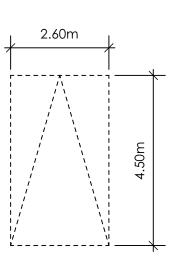



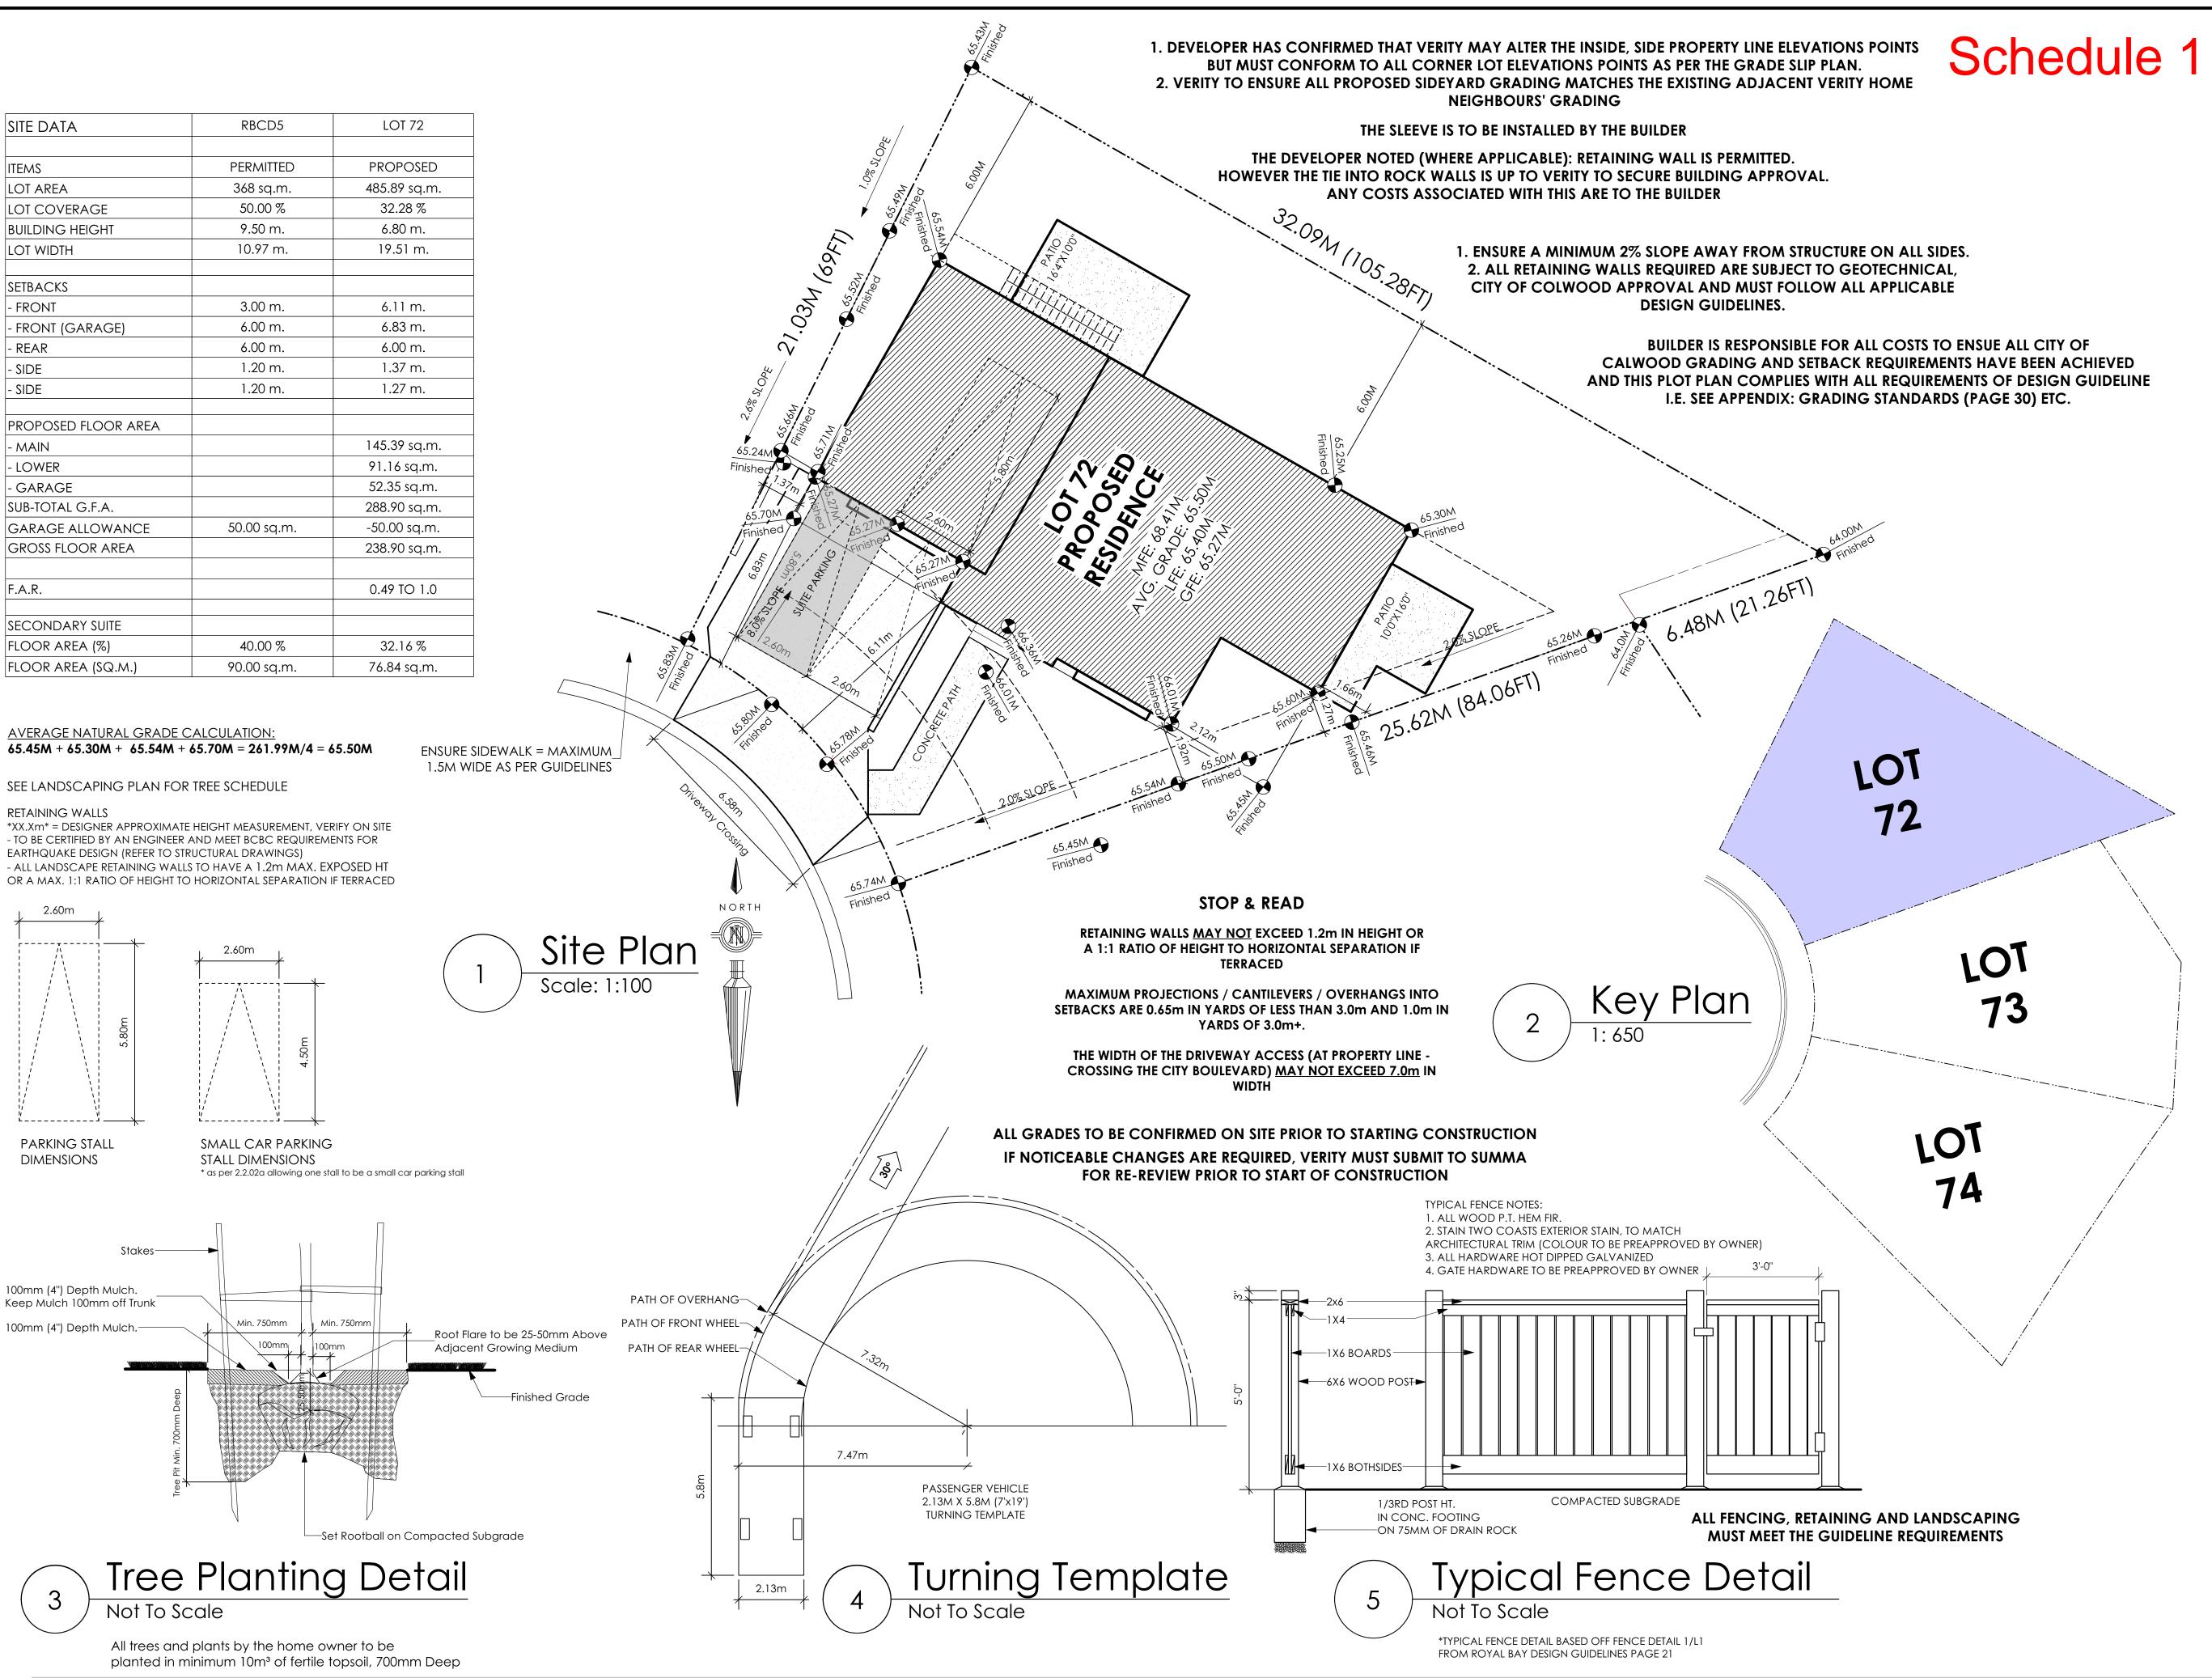



#103 - 891 ATTREE AVENUE VICTORIA, B.C. V9B 0A6 P. 250.382.7374 F. 250.382.7364

APPROVED BY VERITY CONSTRUCTION

DATE

APPROVED BY REALTOR

DATE

'BEARING' - TRADITIONAL

Date MAR 14 2023


Project Address 404 Rock Dove Place Royal Bay - Sector 7 Colwood, B.C.

Prepared for Verity Construction

> Project # 8298

Scale As Noted

Drawn By MIS

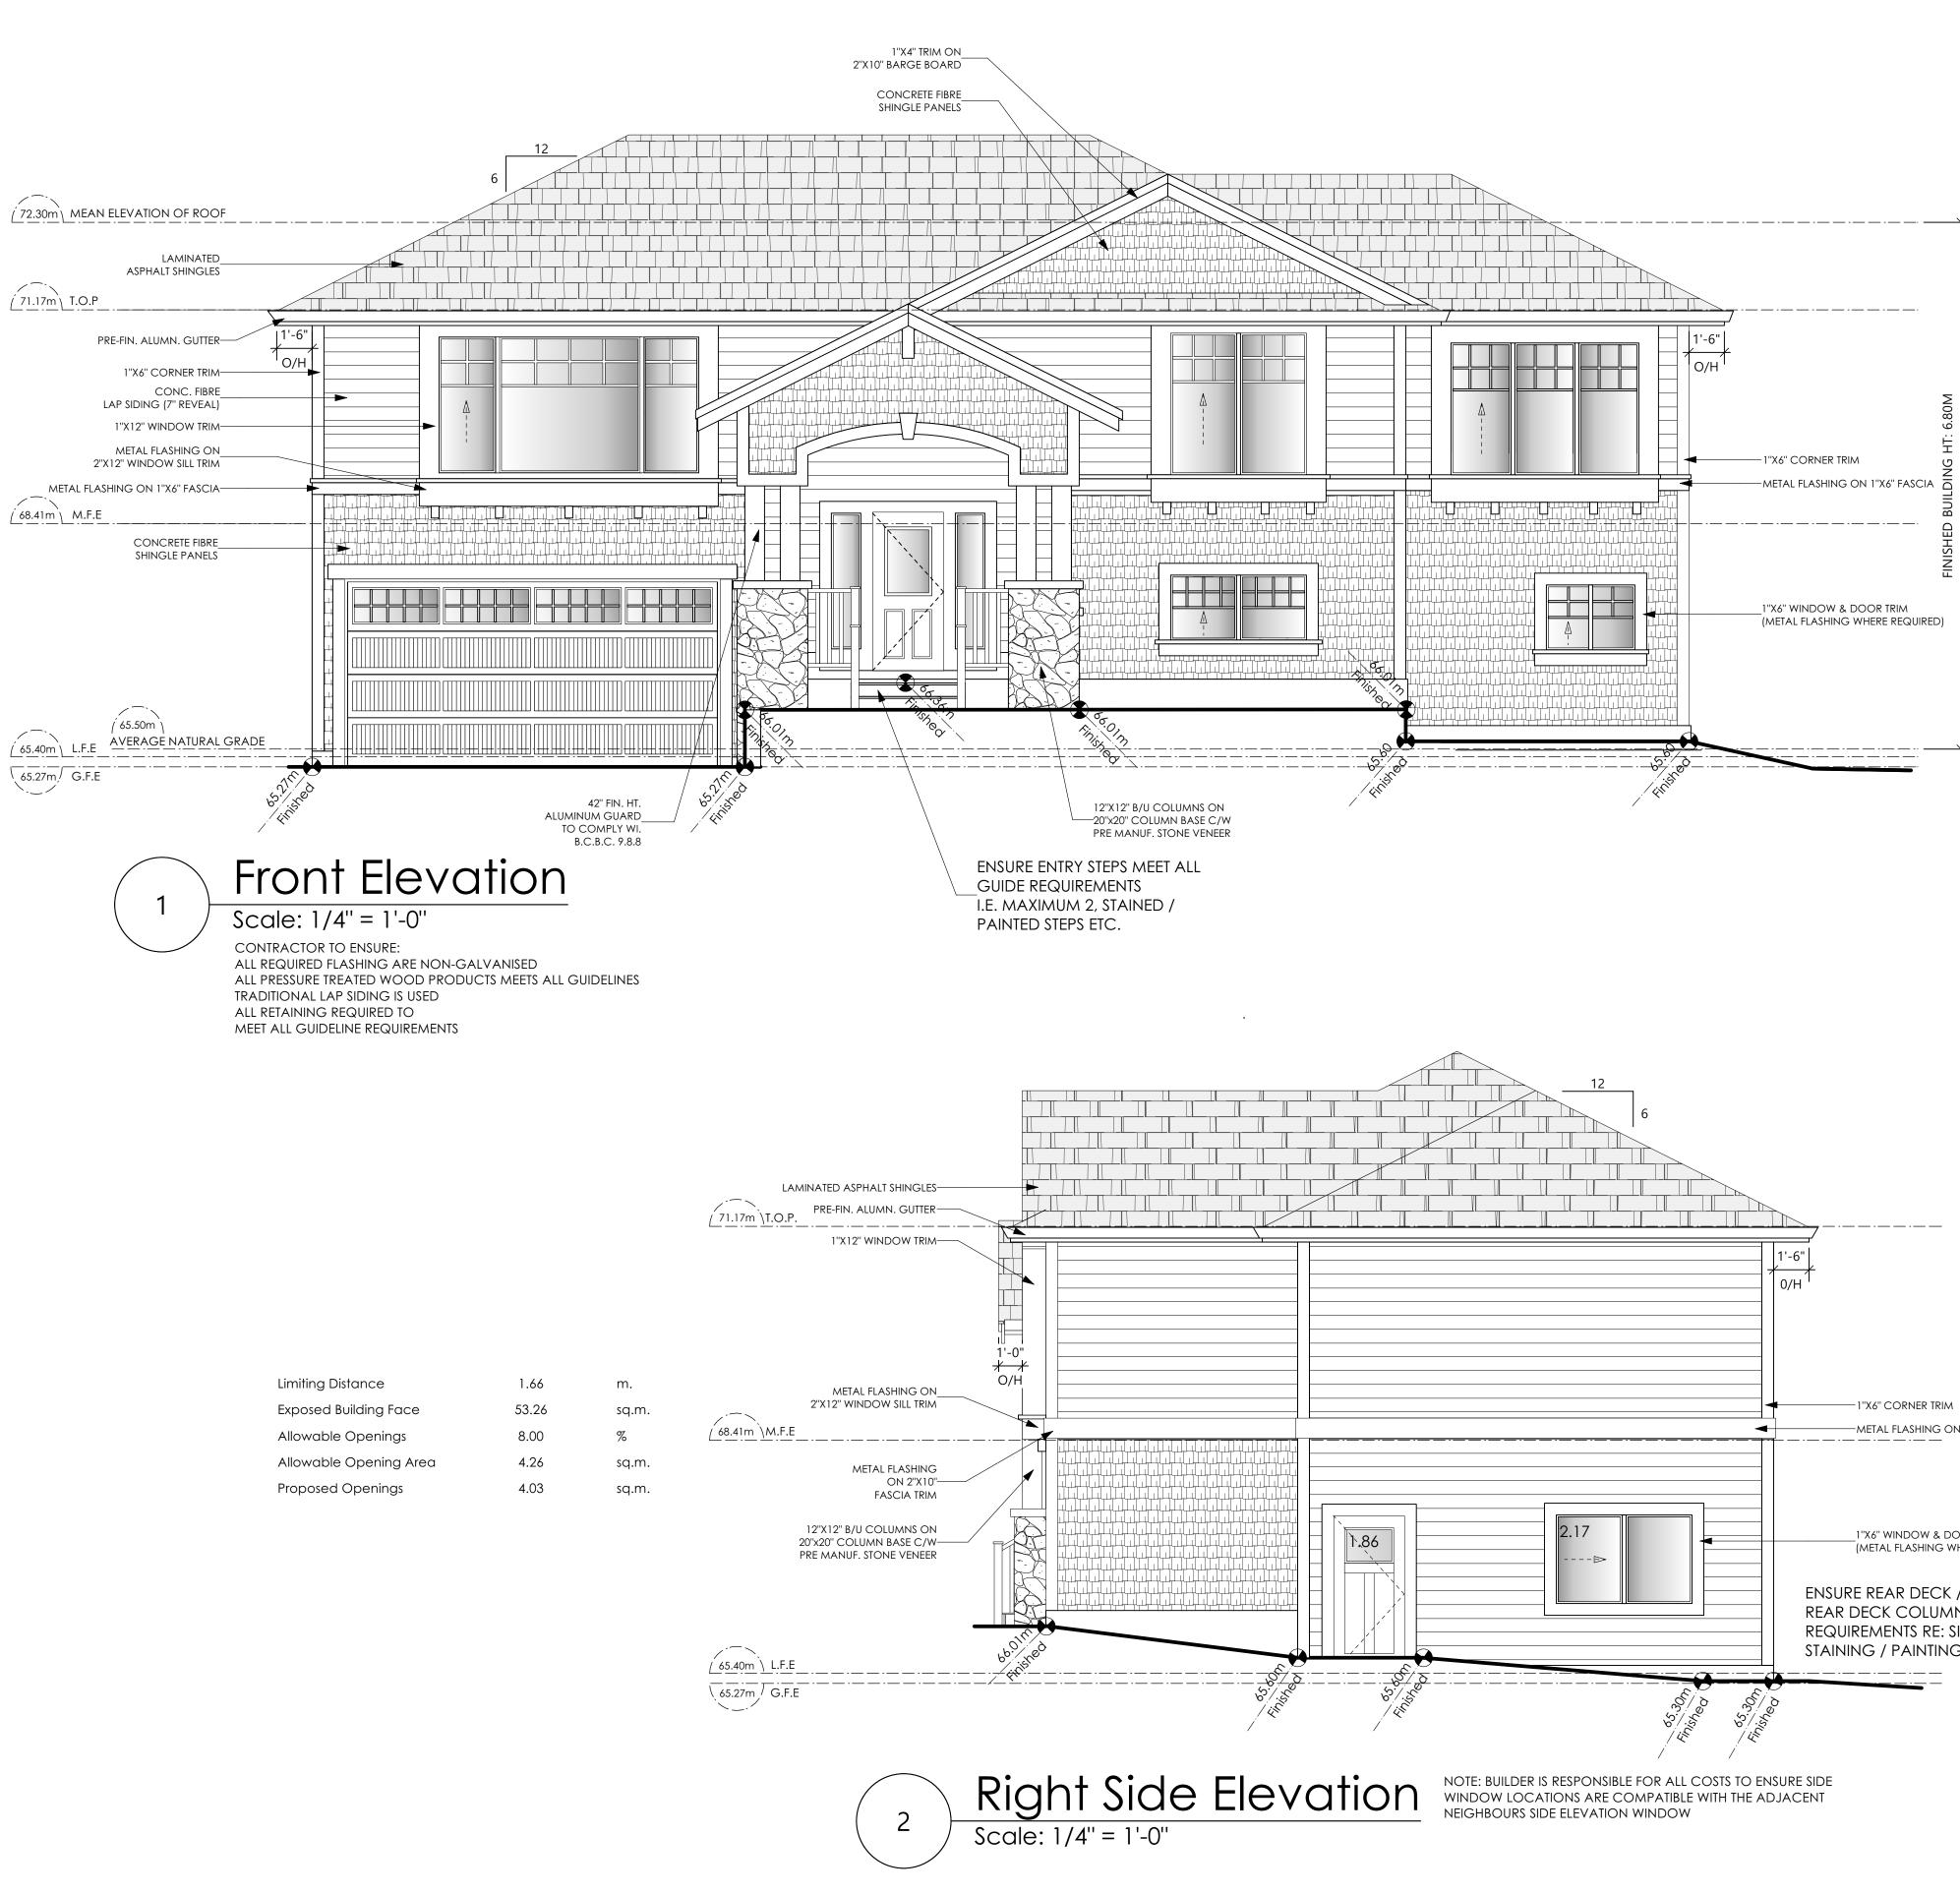

Limiting Distance	1.66	m.	
Exposed Building Face	53.26	sq.m.	
Allowable Openings	8.00	%	
Allowable Opening Area	4.26	sq.m.	
Proposed Openings	4.03	sq.m.	

SLAB ON GRADE PREVIOUSLY ACCEPTED BY THE DEVELOPER ON OTHER LOTS

SIZE OF HOUSE PROPOSED FOR THIS LOT IS ACCEPTED BY DEVELOPER AS LONG AS ALL BUILDING CODE/BYLAWS, GUIDELINES AND CITY OF COLWOOD REQUIREMENTS HAVE BEEN ACHIEVED

-METAL FLASHING ON 1"X6" FASCIA

1"X6" WINDOW & DOOR TRIM (METAL FLASHING WHERE REQUIRED)

ENSURE REAR DECK / REAR DECK STAIRS / REAR DECK COLUMN MEET ALL GUIDELINES REQUIREMENTS RE: SIZE REQUIREMENTS, STAINING / PAINTING WHERE REQUIRED ETC.

9 design group

#103 - 891ATTREE AVENUE VICTORIA, B.C. V9B 0A6 P. 250.382.7374 F. 250.382.7364

'BEARING' - TRADITIONAL

Date MAR 14 2023

Project Address 404 Rock Dove Place Royal Bay - Sector 7 Colwood, B.C.


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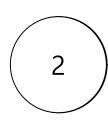
1"X6" CORNER TRIM-CONC. FIBRE LAP SIDING (7" REVEAL)


METAL FLASHING ON 2"X10" FASCIA TRIM-

68.41m \M.F.E

ENSURE REAR DECK / REAR DECK STAIRS / REAR DECK COLUMN MEET ALL GUIDELINES REQUIREMENTS RE: SIZE REQUIREMENTS, STAINING / PAINTING WHERE REQUIRED ETC.

> (65.40m \ L.F.E 65.27m G.F.E

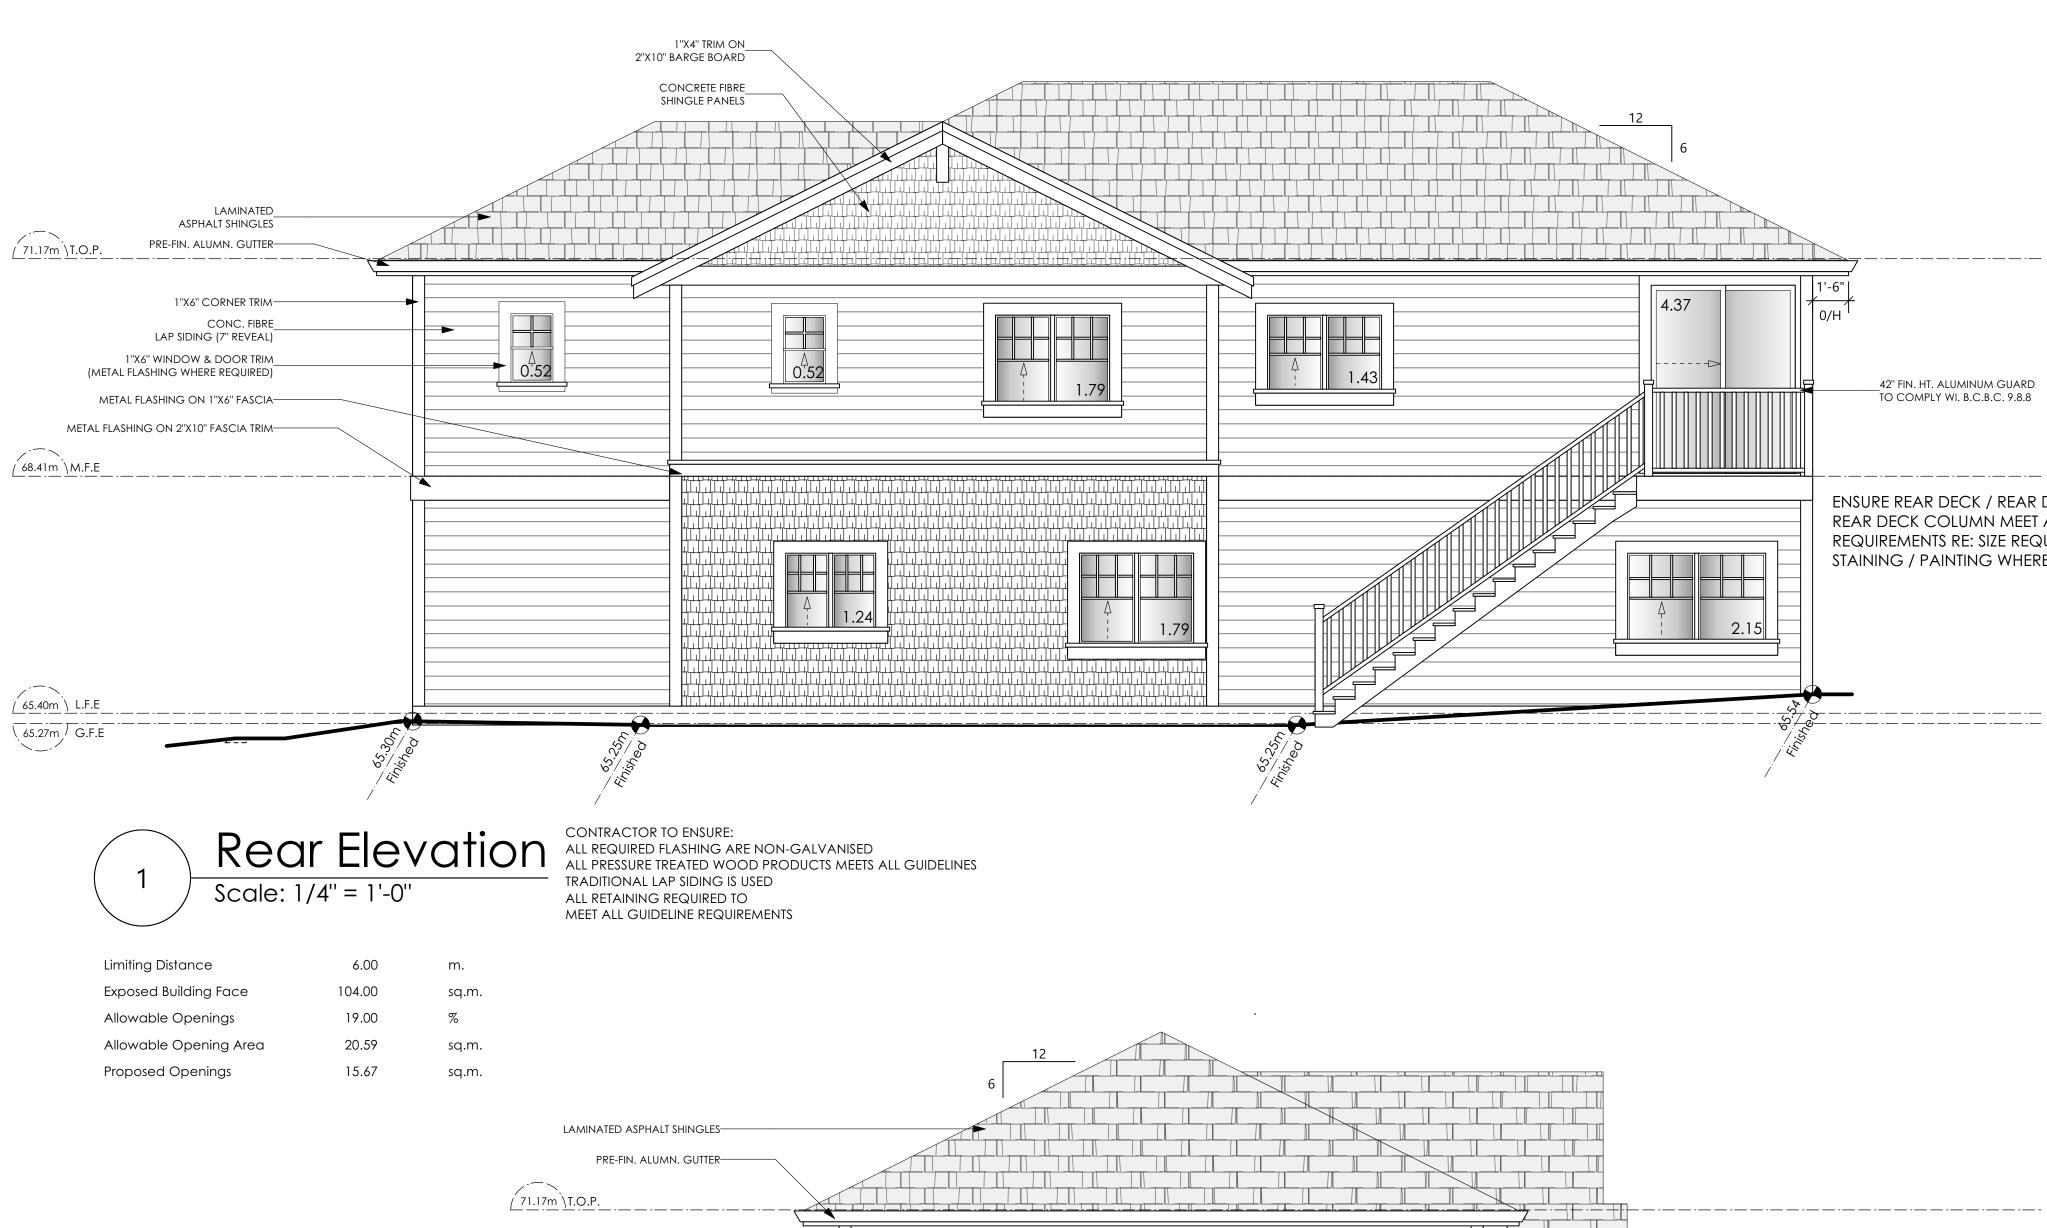

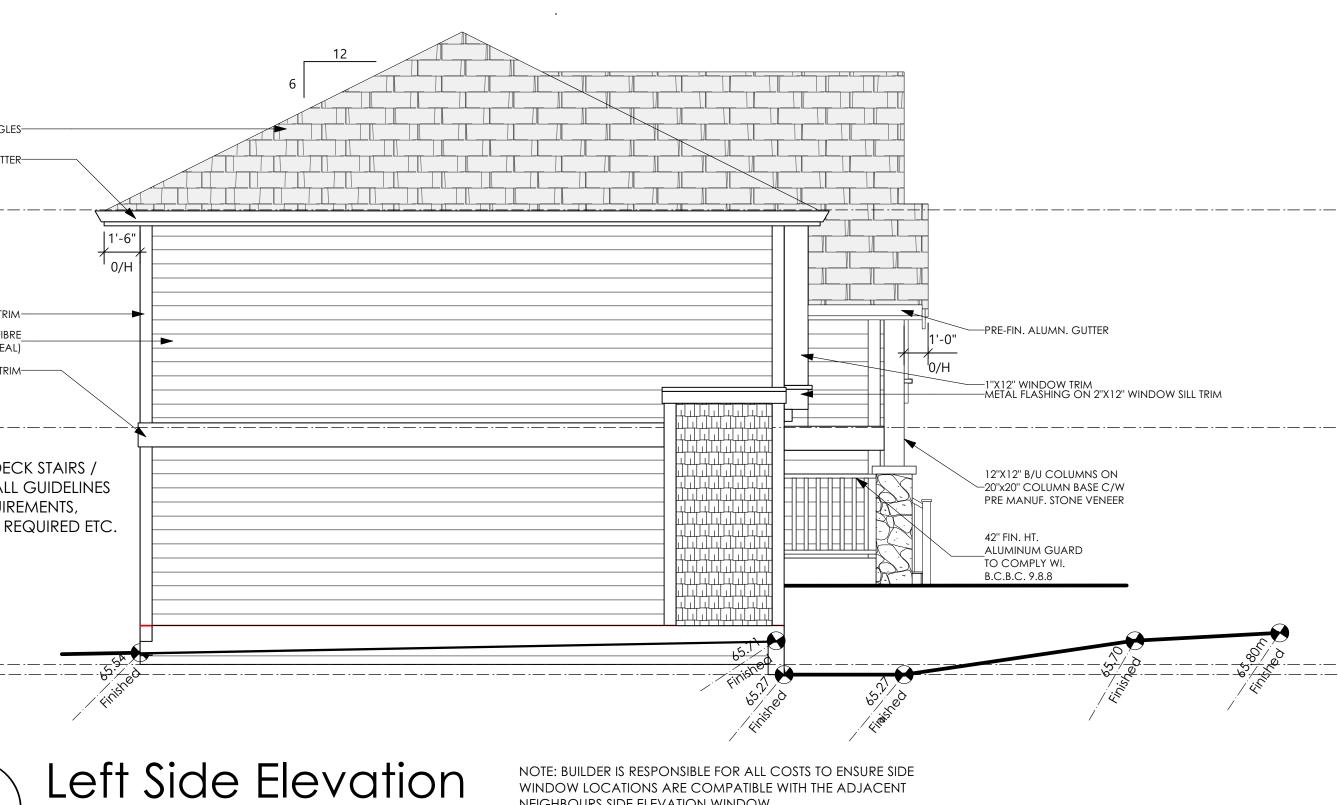

Scale: 1/4" = 1'-0"

NEIGHBOURS SIDE ELEVATION WINDOW

Development Permit Presentation

42" FIN. HT. ALUMINUM GUARD

ENSURE REAR DECK / REAR DECK STAIRS / REAR DECK COLUMN MEET ALL GUIDELINES REQUIREMENTS RE: SIZE REQUIREMENTS, STAINING / PAINTING WHERE REQUIRED ETC.

'BEARING' - TRADITIONAL

9 design group

#103 - 891ATTREE AVENUE

VICTORIA, B.C.

V9B 0A6

P. 250.382.7374

F. 250.382.7364

Date DEC 22 2022


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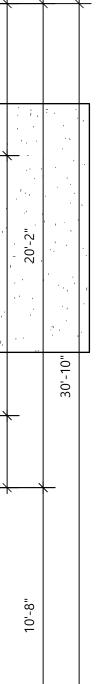
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'BEARING' - TRADITIONAL

Date DEC 22 2022


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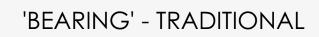
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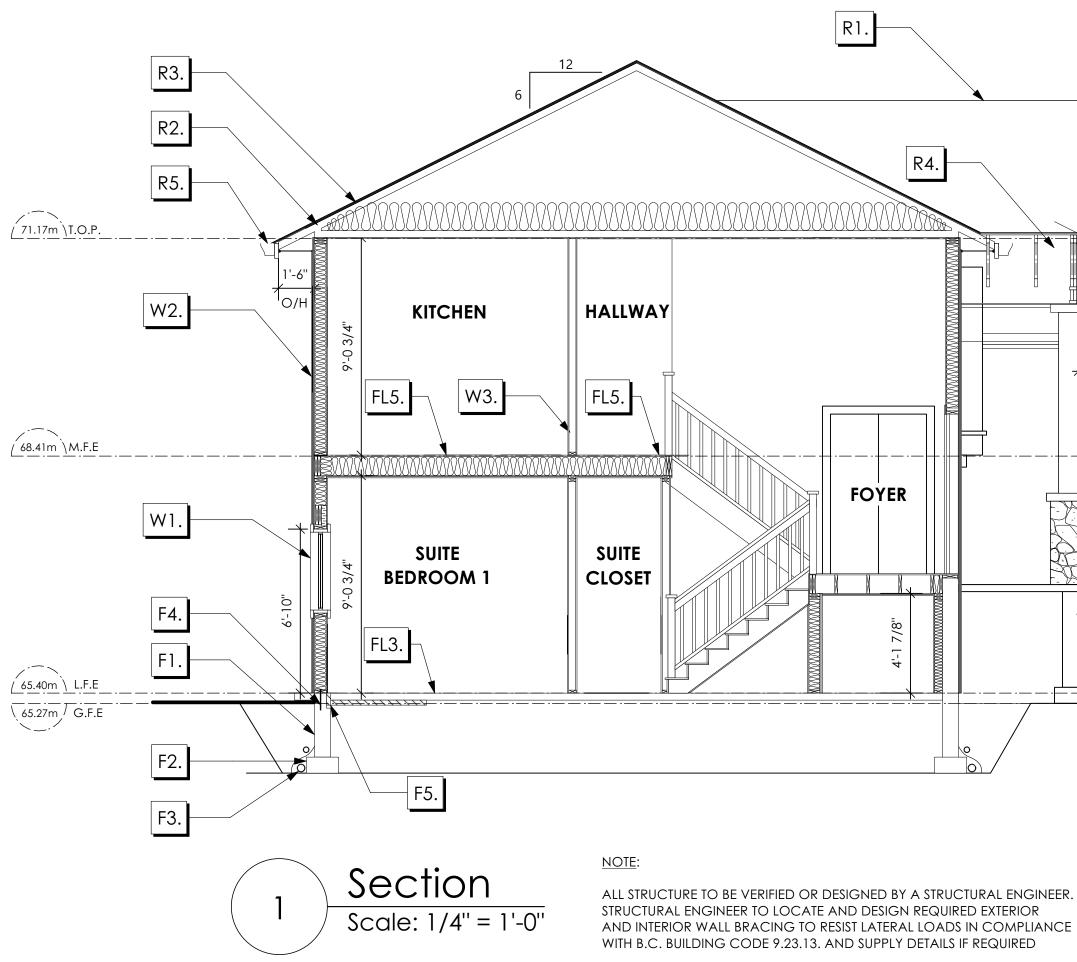
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Scale As Noted

Drawn By MIS

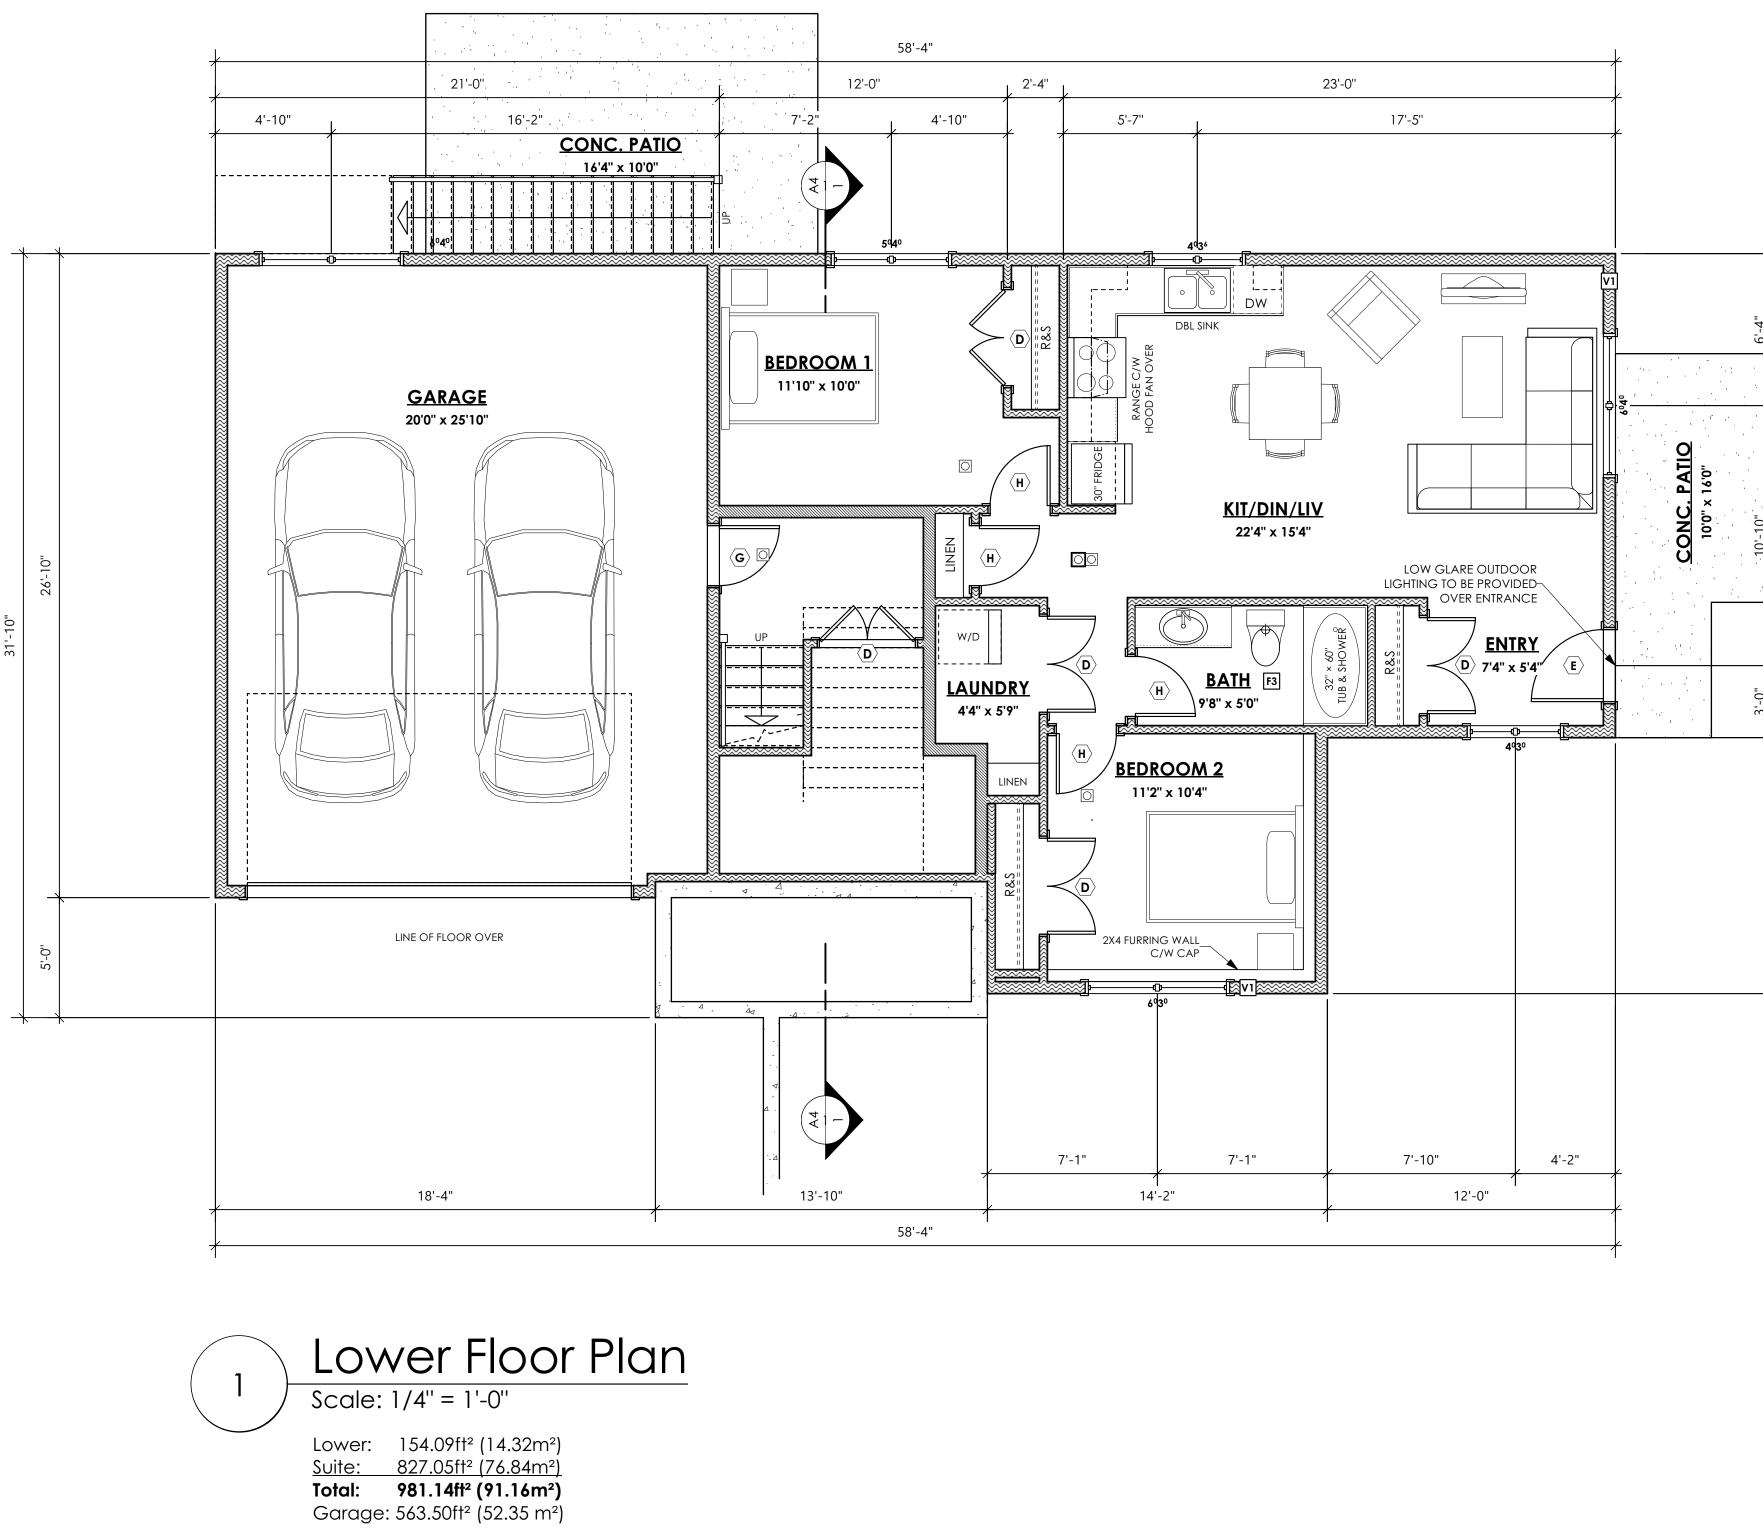

STRUCTURAL WOOD ELEMENTS WITHIN 150MM (6") FROM FINISHED GROUND LEVEL SHALL BE PRESSURE TREATED WITH A PRESERVATIVE FOR TERMITE AND DECAY PROTECTION B.C.B.C. 9.3.2.9.(3)

Section Notes

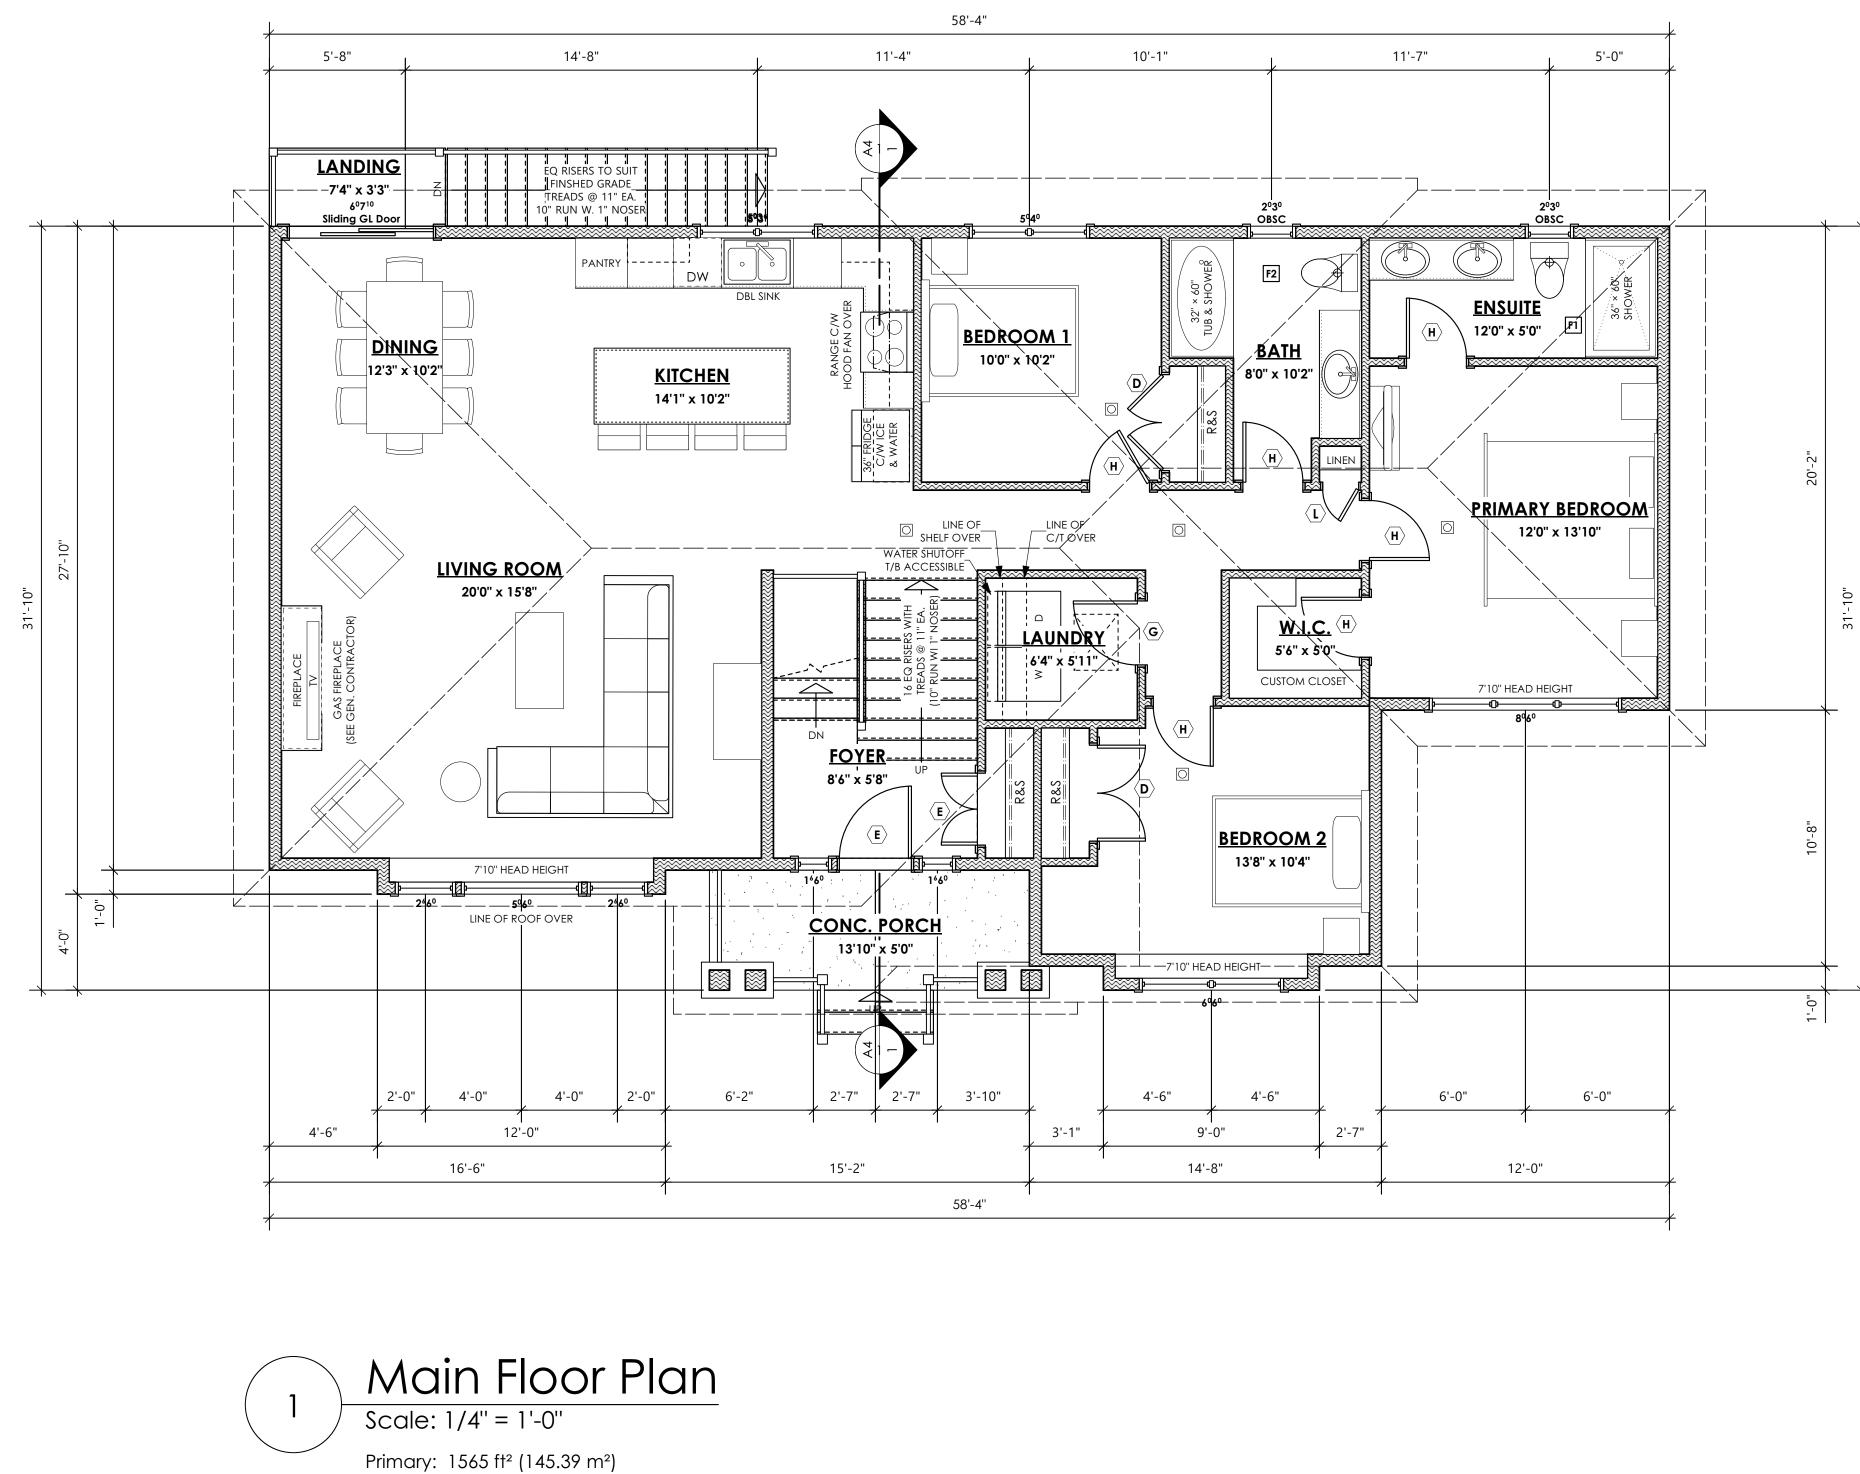* SEE A1 FOR EFFECTIVE RSI CALCULATIONS

ROOFS

- R1. LAMINATED ASPHALT SHINGLES ON 7/16" ORIENTED STRAND BOARD C/W "H" CLIPS WD TRUSSES (DESIGNED BY MANUF.) R-40 FIBRE GLASS BATT INSULATION OR 14 1/2" FIBRE GLASS LOOSE FILL INSULATION 6 MIL POLY'N V.B. 5/8" GYPSUM BOARD
- R2. PROVIDE 2 1/2" (63MM) CLEAR BETWEEN INSULATION AND SHEATHING. (MIN. R-20 @ ROOF-WALL CONNECTION FOR 4'-0" (1.2M) AROUND PERIMETER OF BUILDING. AIR VENTILATION BAFFLES TO BE INSTALLED WHERE REQUIRED IN AS PER BCBC 9.19.)
- EAVE PROTECTION R3. CONT. UP ROOF SLOPE FOR 12" PAST EXTERIOR WALL.
- R4. PROVIDE 1 SQ.FT. ATTIC VENT PER 300 SQ.FT. OF INSULATED AREA MIN. 25% OF REQUIRED TO BE @ TOP AND BOTTOM (TO COMPLY WI. B.C. BLDG. CODE 9.19.1)
- R5. PRE-FIN. FASCIA GUTTER 2×4 SUB. FASCIA BD. VENTED SOFFIT (SEE CONTRACTOR)

FLOORS

- FL1. FINISHED FLOORING ON 19/32" ORIENTED STRAND BOARD OR EQ. (FASTENED & GLUED TO FLOOR STRUCT. BELOW) ON 2×10 FLOOR JOISTS @ 16" O/C C/W 2×2 X-BRIDGING @ 7.0' O/C (MAX) 1/2'' GYPSUM BOARD (NOT SHOWN IN SECTION)
- FL2. FINISHED FLOORING ON 19/32" ORIENTED STRAND BOARD OR EQ. (FASTENED & GLUED TO FLOOR STRUCT. BELOW) ON 2×10 FLOOR JOISTS @ 16" O/C C/W 2×2 X-BRIDGING @ 7.0' O/C (MAX) **R-31 INSULATION** 6 MIL. POLY'N VAPOUR BARRIER 5/8" X-TYPE GYPSUM BOARD (BETWEEN GARAGE AND LIVING SPACE)
- (NOT SHOWN IN SECTION) FL3. 3 1/2" CONCRETE SLAB 6 MIL. POLY'N V.B. 6" COMPACTED GRAVEL OR SAND
- FL4. 3 1/2" CONCRETE SLAB 6 MIL. POLY'N V.B. 6" COMPACTED GRAVEL OR SAND SLOPE TO DOORS 1" (NOT SHOWN IN SECTION)
- FL5. B.C. BUILDING CODE (TABLE-9.10.3.1.B) RATED FLOOR ASSEMBLY F8D FINISHED FLOORING ON (NOT FINISHED FLOORING UNDER STAIRS) 19/32" ORIENTED STRAND BOARD (FASTENED & GLUED TO FLOOR STRUCT. BELOW) ON 2×10 FLOOR JOISTS @ 16" OR 12" O/C C/W 2×2 X-BRIDGING @ 7.0' O/C (MAX) **R-31 INSULATION** RESILIENT METAL CHANNELS @ 24" O/C 1 LAYER 5/8" X-TYPE GYPSUM BOARD 30 MINUTE F.R.R., 50 S.T.C.
- FL6. FINISHED FLOORING ON 19/32" ORIENTED STRAND BOARD (FASTENED & GLUED TO FLOOR STRUCT. BELOW) ON 2×10 FLOOR JOISTS @ 16" OR 12" O/C C/W 2×2 X-BRIDGING @ 7.0' O/C (MAX) PROVIDE R-31 F/G BATT INSULATION IN JOIST CAVITY BUILDING WRAP VENTED SOFFIT (TO OWNERS SPEC'S) TO ALL SUSPENDED FLOOR AREAS (NOT SHOWN IN SECTION)

WALLS

- W1. DOUBLE GLAZING ENERGY STAR LOW "E" RATING THERMAL BREAK FRAMES 2/2"X10" LINTEL OVER (@ bear (TYPICAL, wi. R-10 F/G BATT IN FLASHING OVER @ EXTERIOR (glazing in all exterior doors & of exterior doors to be shatte STARLINE WINDOWS TO ENSUI TO COMPLY WITH B.C. BLDG. WDMA/CSA 101/I.S.2/A440, LANGFORD R - PG20 (220) A2 RATINGS MUST BE CLEARLY LA WINDOW UNITS UPON INSTAL
- W2. CONC. FIBRE SIDING ON 9.5mm (3/8") AIR SPACE / STR 3/8"×2" BORATE TREATED PLYV HOUSE WRAP (A.B.) (TYVEK O 7/16" ORIENTED STRAND BOA 2×6 STUDS @ 16" O/C R-20 F/G BATT INSULATION 6 MIL. POLY'N V.B. 1/2" GYPSUM BOARD (REFER TO DETAILS ON D1)
- W3. INTERIOR PARTITION 1/2" GYPSUM BOARD ON EAC OF 2×4 STUDS @ 16" O/C OR 2×6 STUDS @ 16" O/C (IF NOTE
- W4. 5/8" X-TYPE GYPSUM BOARD 2×6 STUDS @ 16" o/c c/w **R-20 INSULATION** 6MIL. PO LY'N V.B 1/2" GYPSUM BOARD (BETWEEN GARAGE & LIVING (NOT SHOWN IN SECTION)
- W5. B.C. BUILDING CODE (TABLE RATED WALL ASSEMBLY W3c 1 LAYER 1/2" X-TYPE GYPSUM BOARD RESILIENT METAL CHANNELS @ 24" O/C 2×4 STUDS @ 16" O/C OR 2×6 STUDS @ 16" O/C (IF NOTED) C/W 3 1/2" FIBRE GLASS SOUND BATTS 1 LAYER 1/2" X-TYPE GYPSUM BOARD 45 MIN. F.R.R 43 S.T.C (BETWEEN PRIMARY LIVING & SECONDARY SUITE)

Development Permit Presentation

_ _ . _ . _ . _ . _ . _ . _ . _

9 design group

#103 - 891ATTREE AVENUE VICTORIA, B.C. V9B 0A6 P. 250.382.7374 F. 250.382.7364

FOUNDATION WALLS

G IN	F1.	DAMPROC 8'' THK. CC C/W 15 M
rring walls only) NSUL'N.)	F2.	16"X 8" CC C/W 2 (TW
& within 3 ft. erproof (SP)) IRE ALL WINDOWS & DOORS . CODE 9.7 & AAMA/ NAFS & A440S1-09 Class	F3.	ON UNDIS 4" PERIMET 3" TIGHT PI DRAIN RO
2 ABELED ON ALL .LATION FOR INSPECTION.	F4.	anchor C/w Sill C
RAPPING WOOD STRAPPING DR EQ.) RD	F5.	UNDER SLA 2 1/2" (RSI RIGID INSL CONT. AR SLAB INSTA (VERIFY W
	F6.	STEP DOW MAY VARY (NOT SHO
CH SIDE		
ED)		
ON		
5)		
9.10.3.1.A)		

OFING (WHERE REQUIRED) ON ONC. FOUNDATION WALL A BARS @ 24" O/C B/W

ONC. FOOTINGS NO) 15M BARS CONT. 3 IN. FROM BOTT. STURBED SOIL (SOLID BEARING)

TER DRAIN PIPE FOR RWL DCK

BOLTS @ 4.0 FT. O/C MAX GASKETS

AB INSULATION 2.15) EXTRUDED POLYSTYRENE ULATION 4'-0" (1.2M) ROUND PERIMETER UNDER ALLED HORIZONTALLY OR VERTICALLY (ITH MUNICIPALITY DEPTH OF FROST LINE)

VN TO GARAGE SLAB Y, VERIFY EXTENT ON SITE OWN IN SECTION)

'BEARING' - TRADITIONAL

Date DEC 22 2022

Project Address 404 Rock Dove Place Royal Bay - Sector 7 Colwood, B.C.


Prepared for Verity Construction


> Project # 8298

Scale As Noted


Drawn By MIS

SITE DATA	RBCD5	LOT 72
ITEMS	PERMITTED	PROPOSED
LOT AREA	368 sq.m.	485.89 sq.m.
LOT COVERAGE	50.00 %	32.28 %
BUILDING HEIGHT	9.50 m.	6.80 m.
LOT WIDTH	10.97 m.	19.51 m.
Setbacks		
- FRONT	3.00 m.	6.11 m.
- FRONT (GARAGE)	6.00 m.	6.83 m.
- REAR	6.00 m.	6.00 m.
- SIDE	1.20 m.	1.37 m.
- SIDE	1.20 m.	1.27 m.
PROPOSED FLOOR AREA		
- MAIN		145.39 sq.m.
- LOWER		91.16 sq.m.
- GARAGE		52.35 sq.m.
SUB-TOTAL G.F.A.		288.90 sq.m.
GARAGE ALLOWANCE	50.00 sq.m.	-50.00 sq.m.
GROSS FLOOR AREA		238.90 sq.m.
F.A.R.		0.49 TO 1.0
SECONDARY SUITE		
FLOOR AREA (%)	40.00 %	32.16 %
FLOOR AREA (SQ.M.)	90.00 sq.m.	76.84 sq.m.

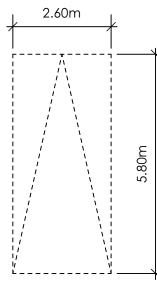

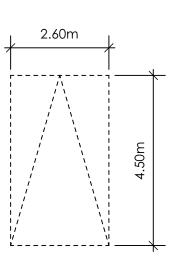



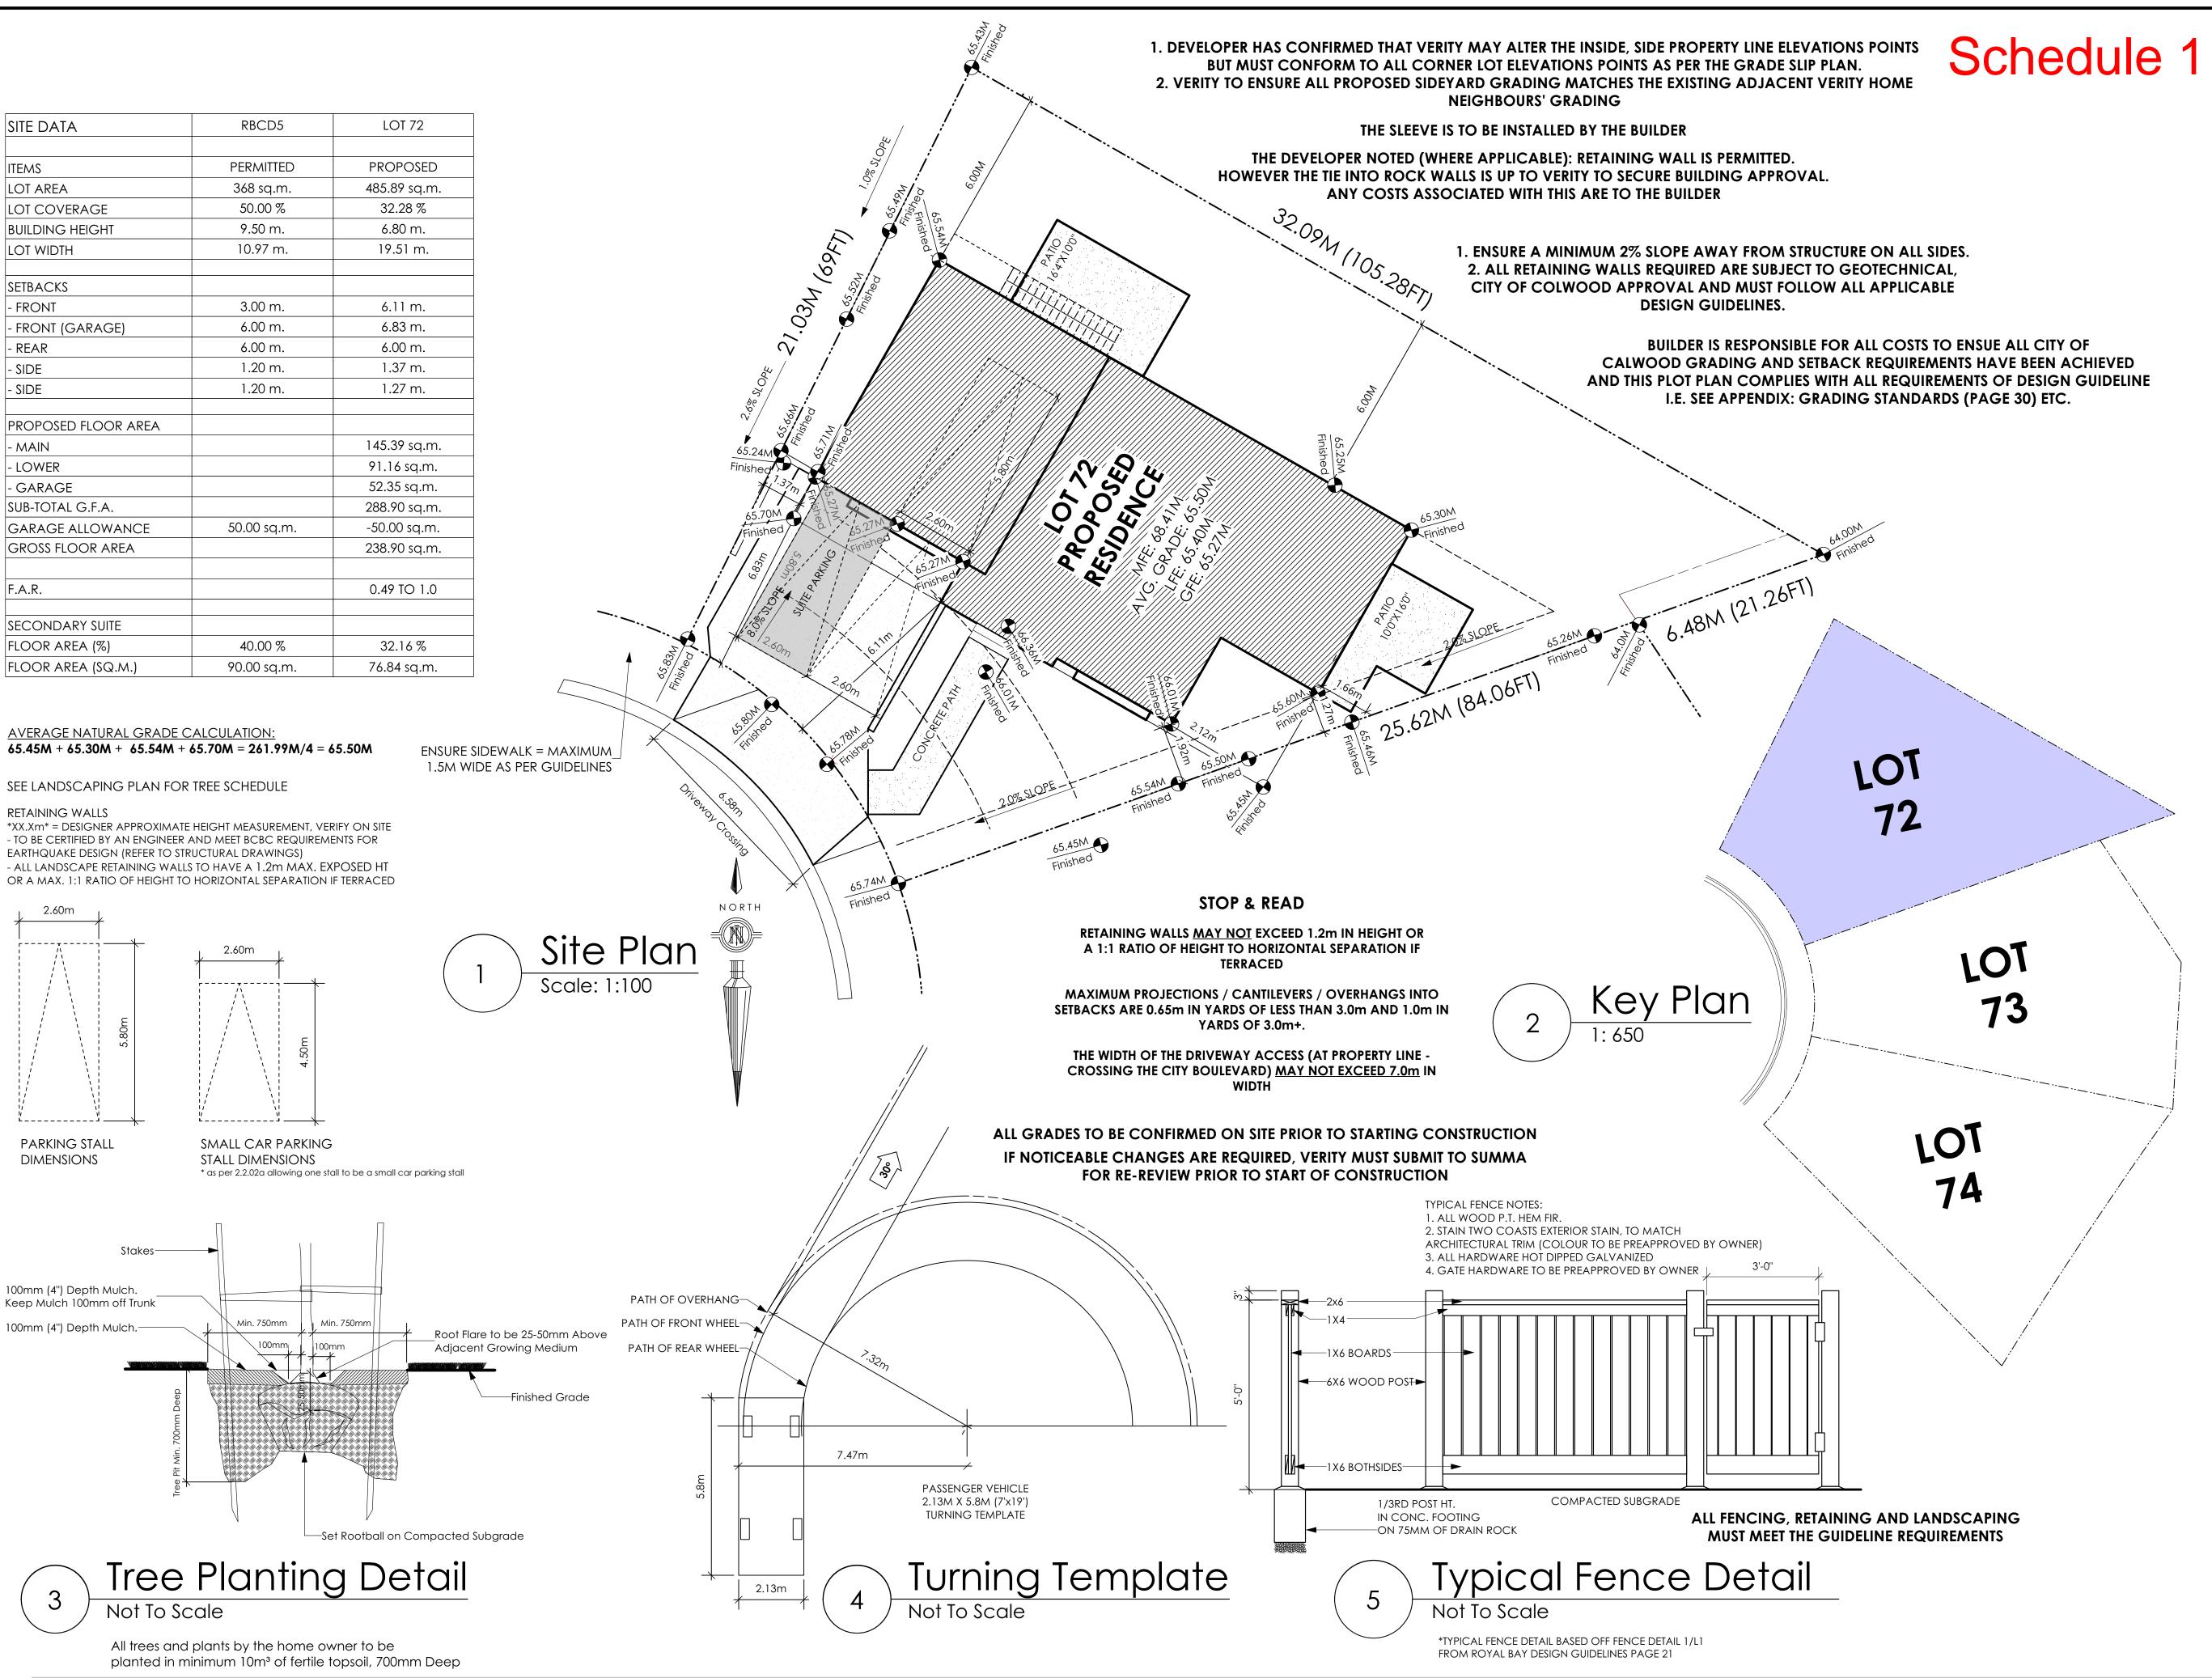



#103 - 891 ATTREE AVENUE VICTORIA, B.C. V9B 0A6 P. 250.382.7374 F. 250.382.7364

APPROVED BY VERITY CONSTRUCTION

DATE

APPROVED BY REALTOR

DATE

'BEARING' - TRADITIONAL

Date MAR 14 2023

Project Address 404 Rock Dove Place Royal Bay - Sector 7 Colwood, B.C.

Prepared for Verity Construction

> Project # 8298

Scale As Noted

Drawn By MIS

GABLECRAFT HOMES BUILDING GRADE SLIP

WSP Project No: <u>201-08151-00</u>

Issue Date: _____

		P.I.D.
ADDRESS 404 Rock Dove Place		PLAN
72		
VERITY HOMES		SUBDIVISION ROYAL BAY SECTOR 7
ADDRESS		DEVELOPER MEADOWS DEVELOPMENT LP
REPRESENTATIVE PH.		CONSULTANT WSP CANADA INC
PROPOSED BUILDING GRADES		PLAN
ALL ELEVATIONS ARE METRIC GEODETIC +		LOT: PLAN:
(TOP OF JOISTS)	JOIST DEPTH	
FRONT ELEV. 65.27/ REAR ELEV. 65.54/65.25/65.30 (FINISHED GRADE) 66.01 (FINISHED GRADE)		
FINISHED GRADE AT GARAGE 65.71/65.27		IL STA
	HEADROOM	64.0
	IEADF	64.0
pat provided		72 EG 63.2
ACTUAL TOP OF FOOTING <u>not provided</u> ELEVATION (ATF)		MFE 66.07 GFE 65.87 MSE 62.46
LOWEST PERMITTED TOP OF <u>not provided</u> FOOTING ELEVATION (LTF) (BOTTOM OF BASEMENT SLAB	FLOOR SLAB	S 62.71 D 62.00
(BUTTOM OF BASEMENT SLAB FROST WALLS ARE REQUIRED.)		
SERVICES FRONT REAR CENTER REF		
	19	65.78
SANITARY		
STORM	100	ROAD A
COMMENTS	YES NO	
DRAIN TO SUMP PUMP LIKELY REQUIRED		
(FOR BASEMENT IF INSTALLED)		LEGEND
SEWER TO SUMP PUMP LIKELY REQUIRED (FOR BASEMENT IF INSTALLED)		STREET
SERVICES INSTALLED TO m INSIDE PROPERTY		Signal Si
FOUNDATION SOIL BEARING INVESTIGATION CERTIFICATION REQUIRED		(m) SROW (m) - SERVICE LOCATION (SHOWN ON ABOVE PLAN)
GEOTECHNICAL RESTRICTIONS APPLY		
(SEE GEOTECHNICAL REPORT)		GRAIC
ENVIRONMENTAL RESTRICTIONS APPLY (SEE ENVIRONMENTAL REPORT)		
UTILITY EASEMENTS AFFECT THIS LOT		LFE/MFE 47.70 - LOWER/MAIN FLOOR ELEVATION
UTILITY LASEMENTS AFFECT THIS LOT		GFE 47.55 - GARAGE FLOOR ELEVATION
		MSE 52.20 - MINIMUM SANITARY SERVICABLE ELEVATION BY GRAVITY
		D 49.12 (P) D 49.12 (P) FOR BASEMENT IF INSTALLED
		$\dot{\psi}$ FOR BASEMENT IF INSTALLED
		L CO L CO L CO L CO L CO L CO L CO L CO L CO L CO L CO L CO L CO L CO L CO L CO CO L CO CO CO CO CO CO CO CO CO CO
NOTES		– LOT TYPE (L/LB/LBT)
1. IT IS THE RESPONSIBILITY OF THE BUILDER TO ENSUR		- PROPOSED REAR CORNER ELEVATIONS
ARE PLACED ON A PROPER BASE THAT IS FREE FROM EXCESSIVE MOISTURE AND DELETERIOUS MATERIALS AN APPROPRIATE FROST PROTECTION WHEN COMPLETED.		
 THE INFORMATION CONTAINED HEREIN IS BASED ON TH LOT GRADING PLAN FOR THIS SUBDIVISION. UN-AUTH DEVIATIONS WILL BE THE RESPONSIBILITY OF THE BUIL 	IORIZED	
ENSURE COMPLIANCE WITH ALL LOCAL BYLAWS.		I, THE BUILDER'S REPRESENTATIVE,, CERTIFY THAT THE FINAL HOUSE PLANS PROVIDED IN THE BUILDING PERMIT APPLICATION ARE THE SAME AS PROCESSED UNDER THIS GRADE SLIP AND
3. OTHER NOTES:		THAT I UNDERSTAND THE INFORMATION AND THE REQUIREMENTS CONTAINED HEREIN AND WILL BUILD ACCORDINGLY.
		AUTHORIZED BUILDER'S REPRESENTATIVE DATE THE INFORMATION CONTAINED HEREIN IS BASED ON THE APPROVED
		LOT GRADING PLAN FOR THIS SUBDIVISION, DATED
		C. Hume - REDO - Oct. 5/22
		ISSUED BY DEVELOPER'S AUTHORIZED REPRESENTATIVE DATE

SITE DATA	RBCD5	LOT 73
ITEMS	PERMITTED	PROPOSED
LOT AREA	368 sq.m.	440.06 sq.m.
LOT COVERAGE	50.00 %	35.99 %
BUILDING HEIGHT	9.50 m.	7.82 m.
LOT WIDTH	10.97 m.	13.30 m.
Setbacks		
- FRONT (W)	3.00 m.	6.01 m.
- FRONT (GARAGE)(W)	6.00 m.	6.01 m.
- REAR (E)	6.00 m.	8.19 m.
- SIDE (N)	1.20 m.	1.28 m.
- SIDE (S)	1.20 m.	1.26 m.
PROPOSED FLOOR AREA		
- UPPER		90.70 sq.m.
- MAIN		100.80 sq.m.
- LOWER		100.80 sq.m.
- GARAGE		42.27 sq.m.
SUB-TOTAL G.F.A.		334.57 sq.m.
GARAGE ALLOWANCE	50.00 sq.m.	-42.27 sq.m.
GROSS FLOOR AREA		292.30 sq.m.
F.A.R.		0.66 TO 1.0
SECONDARY SUITE		
FLOOR AREA (%)	40.00 %	20.24 %
FLOOR AREA (SQ.M.)	90.00 sq.m.	59.17 sq.m.



THE DEVELOPER NOTED: RETAINING WALLS ARE PERMITTED, HOWEVER THE TIE IN TO ROCK WALLS IS UP TO VERITY TO SECURE BUILDING APPROVAL. ANY COSTS ASSOCIATED WITH THIS ARE TO THE BUILDER

1. DEVELOPER HAS CONFIRMED THAT VERITY MAY ALTER THE INSIDE, SIDE PROPERTY LINE ELEVATIONS POINTS BUT MUST CONFORM TO ALL CORNER LOT ELEVATION POINTS AS PER THE GRADE SLIP PLAN. 2. VERITY TO ENSURE ALL PROPOSED SIDE YARD GRADING MATCHES THE EXISTING ADJACENT VERITY HOME NEIGHBOURS GRADING

REQUIRED.

65.74r

Finisher

AVERAGE NATURAL GRADE CALCULATION


65.85 m. + 65.85 m. + 65.85 m. + 65.63 m. + 65.23 m. + 62.83 m. + 62.83 m.v= 454.07 m. divided by 7 = ave. grade 64.87 m.

SEE LANDSCAPING PLAN FOR TREE SCHEDULE


RETAINING WALLS

XX.Xm = DESIGNER APPROXIMATE HEIGHT MEASUREMENT, VERIFY ON SITE - TO BE CERTIFIED BY AN ENGINEER AND MEET BCBC REQUIREMENTS FOR EARTHQUAKE DESIGN (REFER TO STRUCTURAL DRAWINGS) - ALL LANDSCAPE RETAINING WALLS TO HAVE A 1.2m MAX. EXPOSED HT


OR A MAX. 1:1 RATIO OF HEIGHT TO HORIZONTAL SEPARATION IF TERRACED

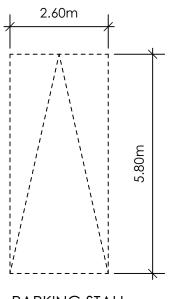

PARKING STALL DIMENSIONS

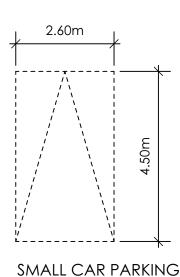

STALL DIMENSIONS * as per 2.2.02a allowing one stall to be a small car parking stal

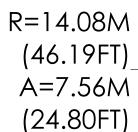

INSTALL RETAINING-WALL TO HOLD UP FRONT & SIDEYARD

6<u>5.71m</u>


Finished

CONC.

DRIVEWAY

OVERSIZED DRIVEWAY IS CONDITIONAL ON VERITY COMPLETING AN AMENDMENT TO THE CITY APPROVED LANDSCAPE PLAN. ENSURE <u>NO</u> IMPACT TO CITY TREES. ALL LANDSCAPING REQUIREMENTS MUST BE ATTAINABLE -CHANGES MAY BE REQUIRED TO ACCOMMODATE.


VERITY IS RESPONSIBLE FOR ALL COSTS TO ENSURE ALL **REQUIREMENTS RE: MFE & LFE ARE ACHIEVED**

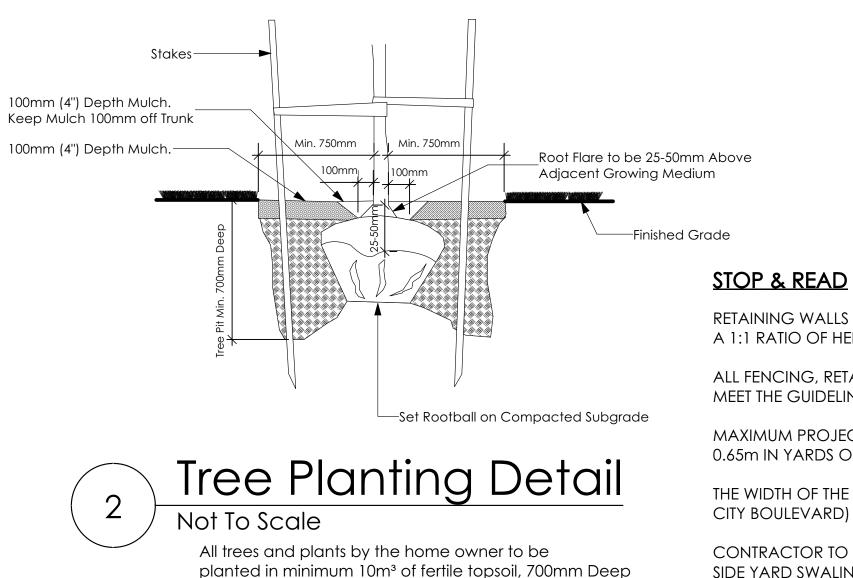

ALL FENCING, RETAINING AND LANDSCAPING MUST MEET THE GUIDELINE REQUIREMENTS

THE WIDTH OF THE DRIVEWAY ACCESS (AT PROPERTY LINE - CROSSING THE CITY BOULEVARD) MAY NOT EXCEED 7.0m IN WIDTH

CONTRACTOR TO ENSURE A MINIMUM 2% SLOPE SIDE YARD SWALING (BOTH SIDES) MAY BE REQUIRED

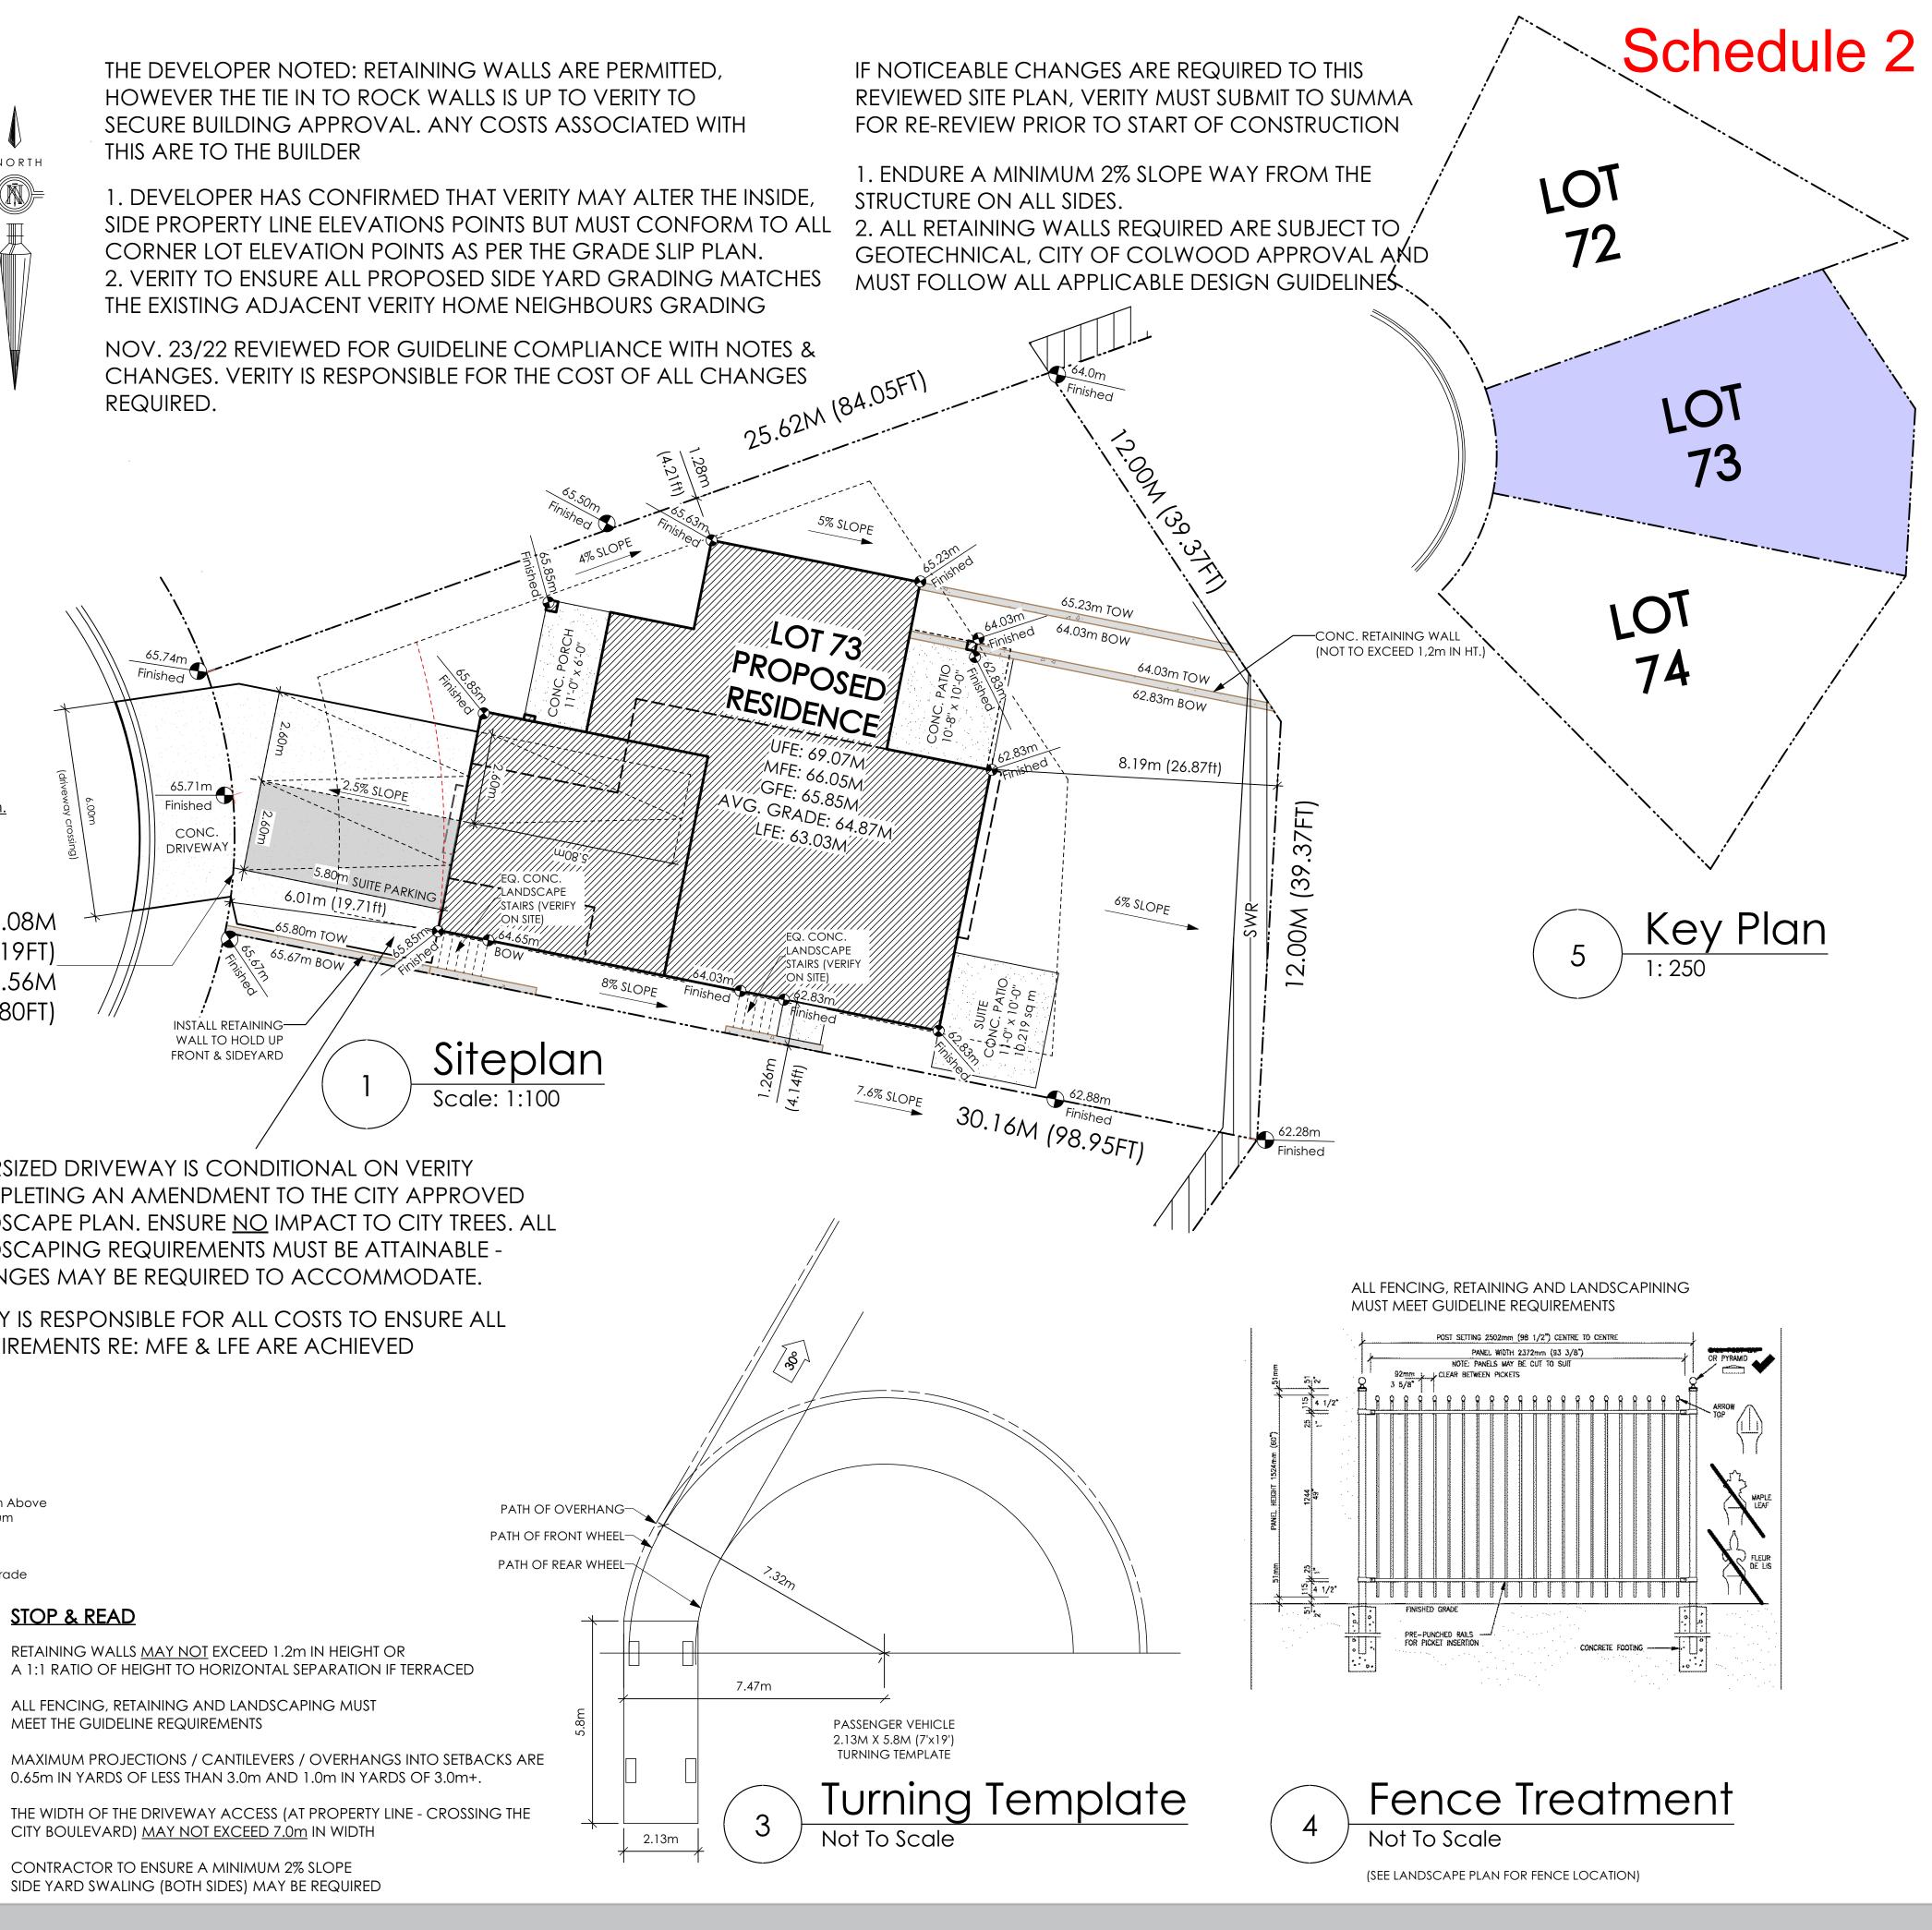

Development Permit Presentation



#103 - 891ATTREE AVENUE VICTORIA, B.C. V9B 0A6 P. 250.382.7374 F. 250.382.7364

CARAVEL TRADITIONAL

Date March 22, 2023


Project Address Lot 73 - 401 Rock Dove Place Royal Bay - Sector 7 Colwood, B.C. Prepared for

Verity Construction

Project # 8298

Scale As Noted

Drawn By LIS

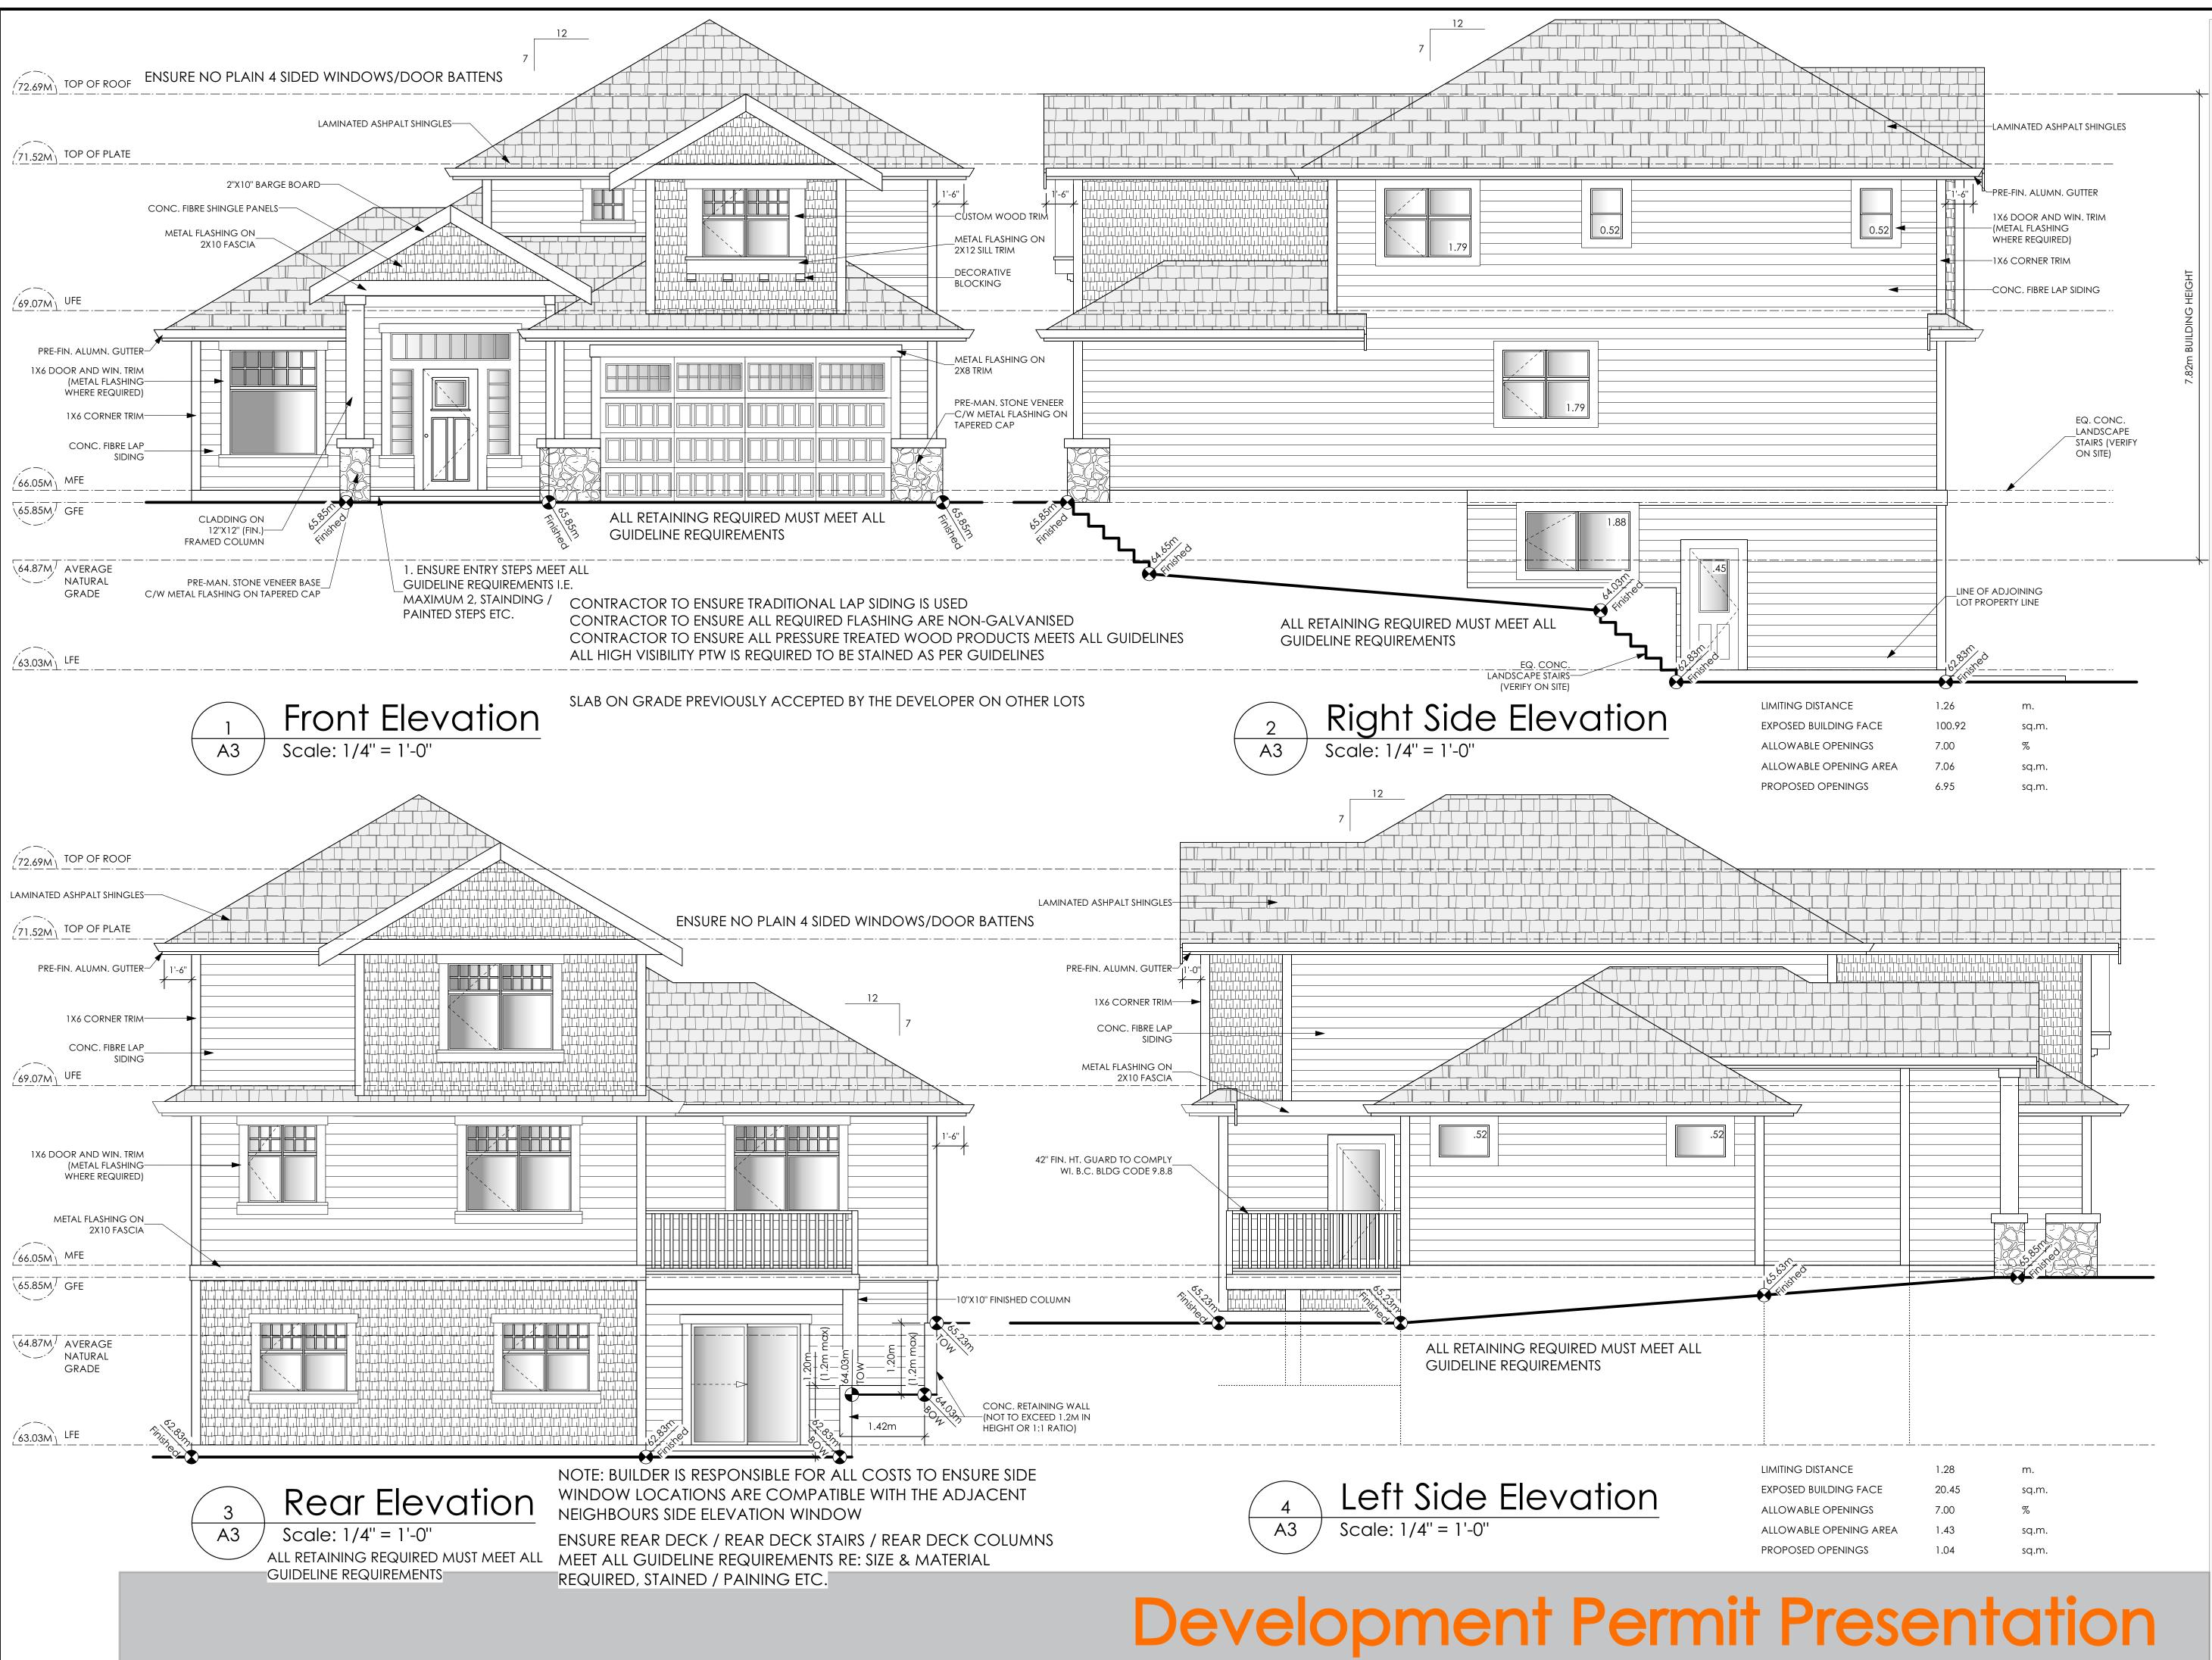

9 design group #103 - 891ATTREE AVENUE VICTORIA, B.C. V9B 0A6 P. 250.382.7374 F. 250.382.7364

CARAVEL TRADITIONAL

Date March 22, 2023


Project Address Lot 73 - 401 Rock Dove Place Royal Bay - Sector 7 Colwood, B.C. Prepared for


Verity Construction


Project # 8298

Scale As Noted

Drawn By LIS

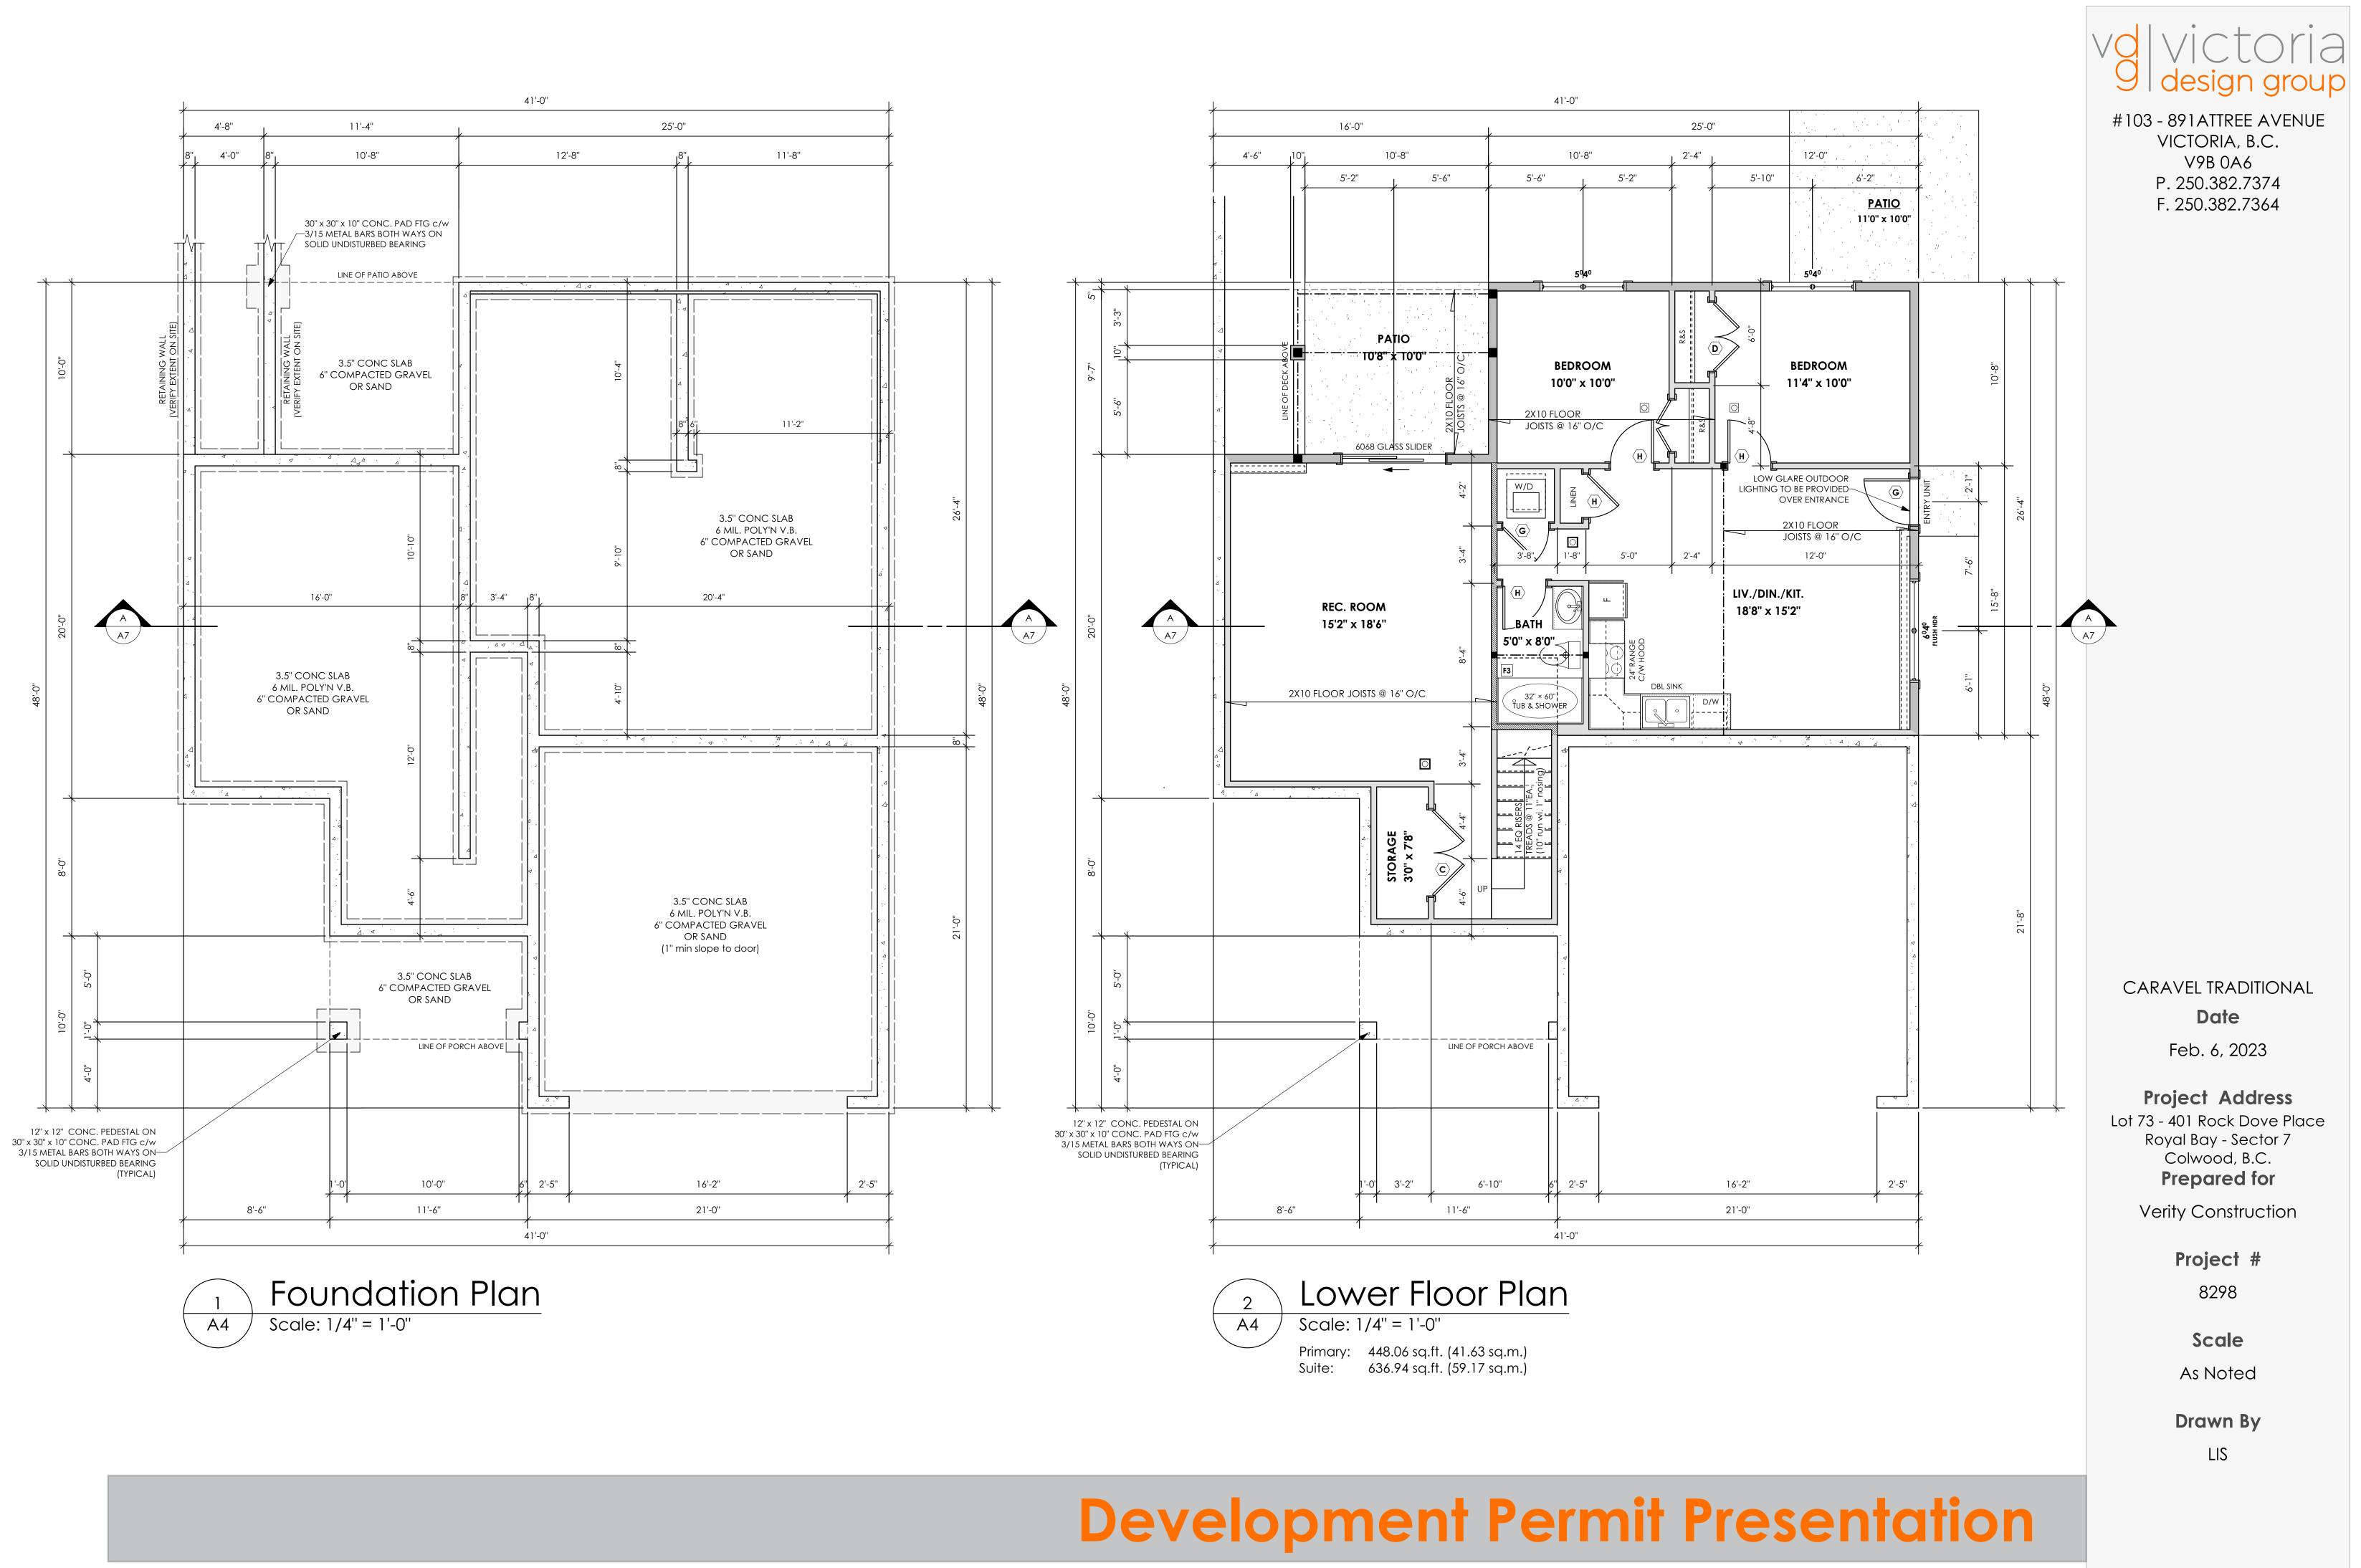

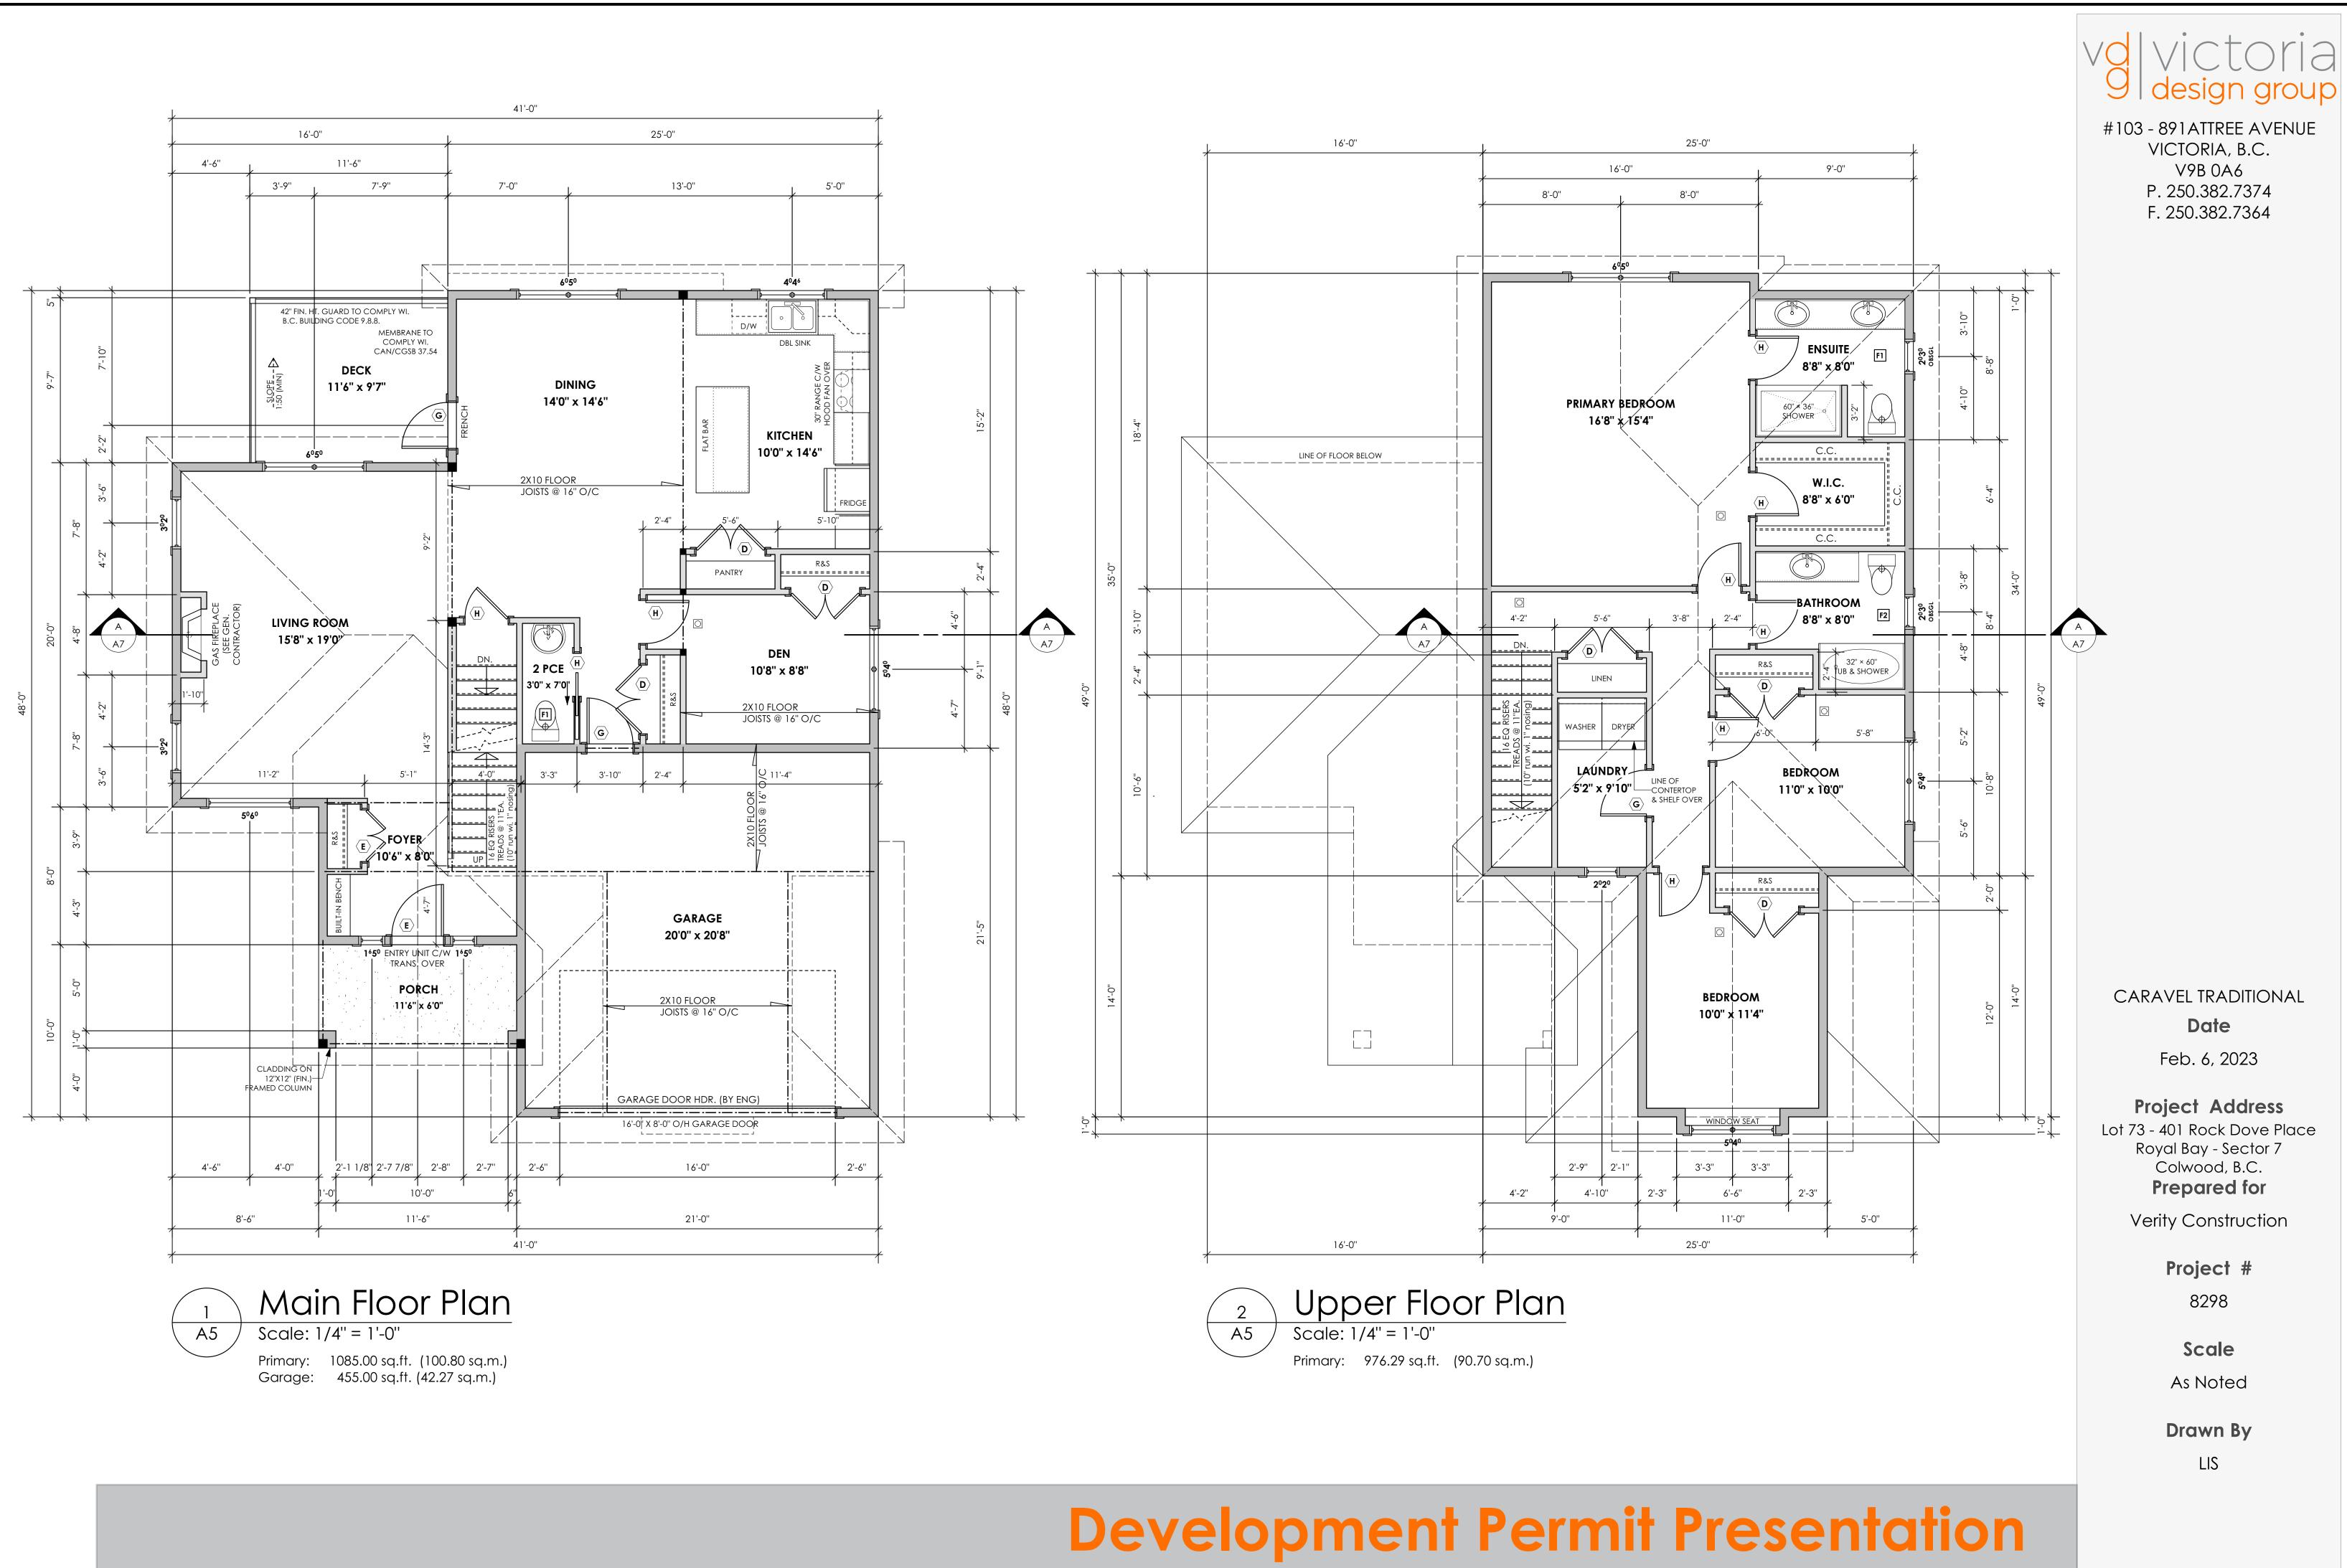

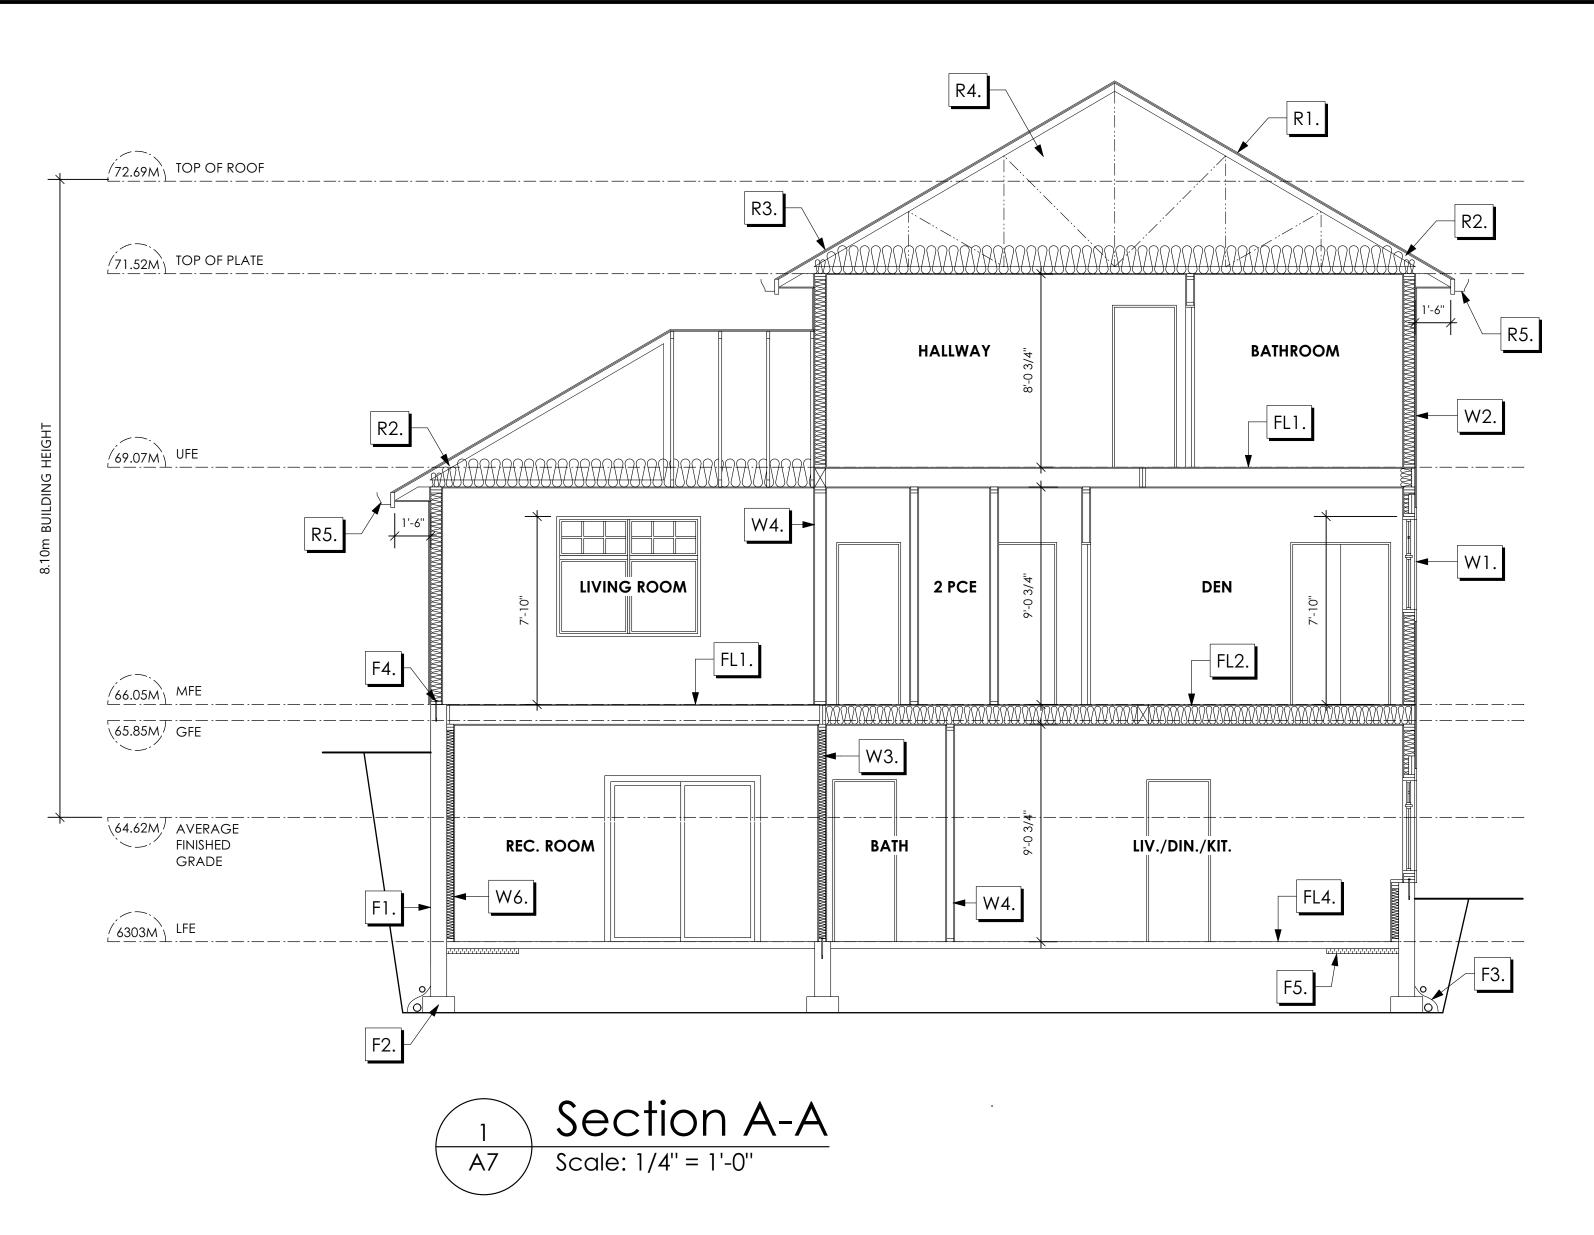

ROOFS

R1.	LAMINATED ASPHALT SHINGLES ON 7/16" ORIENTED STRAND BOARD C/W "H" CLIPS WD TRUSSES (DESIGNED BY MANUF.) R-40 FIBRE GLAS BATT INSULATION OR 14 1/2" FIBRE GLASS LOOSE FILL INSULATION 6 MIL POLY'N V.B. 5/8" GYPSUM BOARD	FL1
R2.	PROVIDE 2 1/2" (63mm) CLEAR BETWEEN R-20 INSULATION AND SHEATHING. (MIN. R-20 @ ROOF-WALL CONNECTION FOR 4'-0" (1.2m) AROUND PERIMETER OF BUILDING. AIR VENTILATION BAFFLES TO BE INSTALLED WHERE REQUIRED IN AS PER BCBC 9.19.)	FL2
R3.	EAVE PROTECTION CONT. UP ROOF SLOPE FOR 12" PAST EXTERIOR WALL.	
R4.	PROVIDE 1 SQ.FT. ATTIC VENT PER 300 SQ.FT. OF INSULATED AREA MIN. 25% OF REQUIRED TO BE @ TOP AND BOTTOM (TO COMPLY WITH BCBC 9.19.1)	FL3
R5.	ALUMINUM GUTTER 2×8 FASCIA BD. 2×4 SUB. FASCIA BD. VENTED ALUMINUM SOFFIT	
R6.	ALUMINUM GUTTER 2×8 FASCIA BD. 2×4 SUB. FASCIA BD. 1/2" ORIENTED STRAND BOARD TO COMPLY WITH BCBC 9.10.15.5(11) USE WHEN SOFFIT IS WITHIN 1.2m FROM	FL4
	PROPERTY LINE VENTED ALUMINUM SOFFIT	FL5

Section Notes

FLOORS

WALLS

۶	FL1.	FINISHED FLOORING ON 11/16" ORIENTED STRAND BOARD (FASTENED & GLUED TO FLOOR STRUCT. BELOW) ON 2×10 FLOOR JOISTS @ 16" OR 12" O/C	W1.	DOUBLE GLAZING ENERGY STAR LOW "E" RATING IN THERMAL BREAK FRAMES 2/2"X10" LINTEL OVER (@ bearing walls only)	W4.	INTERIOR PARTITION 1/2" GYPSUM BOARD ON EACH SIDE OF 2×4 STUDS @ 16" O/C OR 2×6 STUDS @ 16" O/C (IF NOTED)	F1.
		C/W 2×2 X-BRIDGING @ 7.0' O/C (MAX) 1/2'' GYPSUM BOARD		(TYPICAL, wi. 2 1/2" XPS insulation) FLASHING OVER @ EXTERIOR	W5.	5/8" X-TYPE GYPSUM BOARD ON	F2.
	FL2.	B.C. BUILDING CODE (TABLE-9.10.3.1.B) RATED FLOOR ASSEMBLY F8D FINISHED FLOORING ON 11/16'' ORIENTED STRAND BOARD		(glazing in all exterior doors & within 3 ft. of exterior doors to be shatterproof (SP)) WINDOW REQUIREMENTS DERIVED FROM CITY OF COLWOOD BUILDING BYLAW AND ARE TO BE USED TO SATISFY		2×6 STUDS @ 16" O/C C/W R-20 INSULATION 6 MIL. POLY'N V.B 1/2" GYPSUM BOARD (BETWEEN GARAGE & LIVING)	F3.
		(FASTENED & GLUED TO FLOOR STRUCT. BELOW) ON 2×10 FLOOR JOISTS @ 16" OR 12" O/C C/W 2×2 X-BRIDGING @ 7.0' O/C (MAX)		THE REQUIREMENTS OF AAMA/WDMA/CSA 101/I.S.2/A440, "NAFS": COLWOOD, CLASS R - PG30 (220) A3,	W6	(not in section) 1/2" GYPSUM BOARD ON	F4.
		R-31 INSULATION RESILIENT METAL CHANNELS @ 24" O/C 1 LAYERS 5/8" X-TYPE GYPSUM BOARD		RATINGS MUST BE CLEARLY LABELED ON ALL UNITS UPON INSTALLATION FOR INSPECTION.		6 MIL. POLY'N V.B. 2×4 STUDS @ 24" O/C C/W R-12 BATT INSULATION	F5.
		30 MINUTE F.R.R., 50 S.T.C.	W2.	CONC. FIBRE BOARD ON 9.5MM (3/8'') AIR SPACE / STRAPPING		BUILDING WRAP OR 12.7MM (1/2'') AIR SPACE	
١	FL3.	FINISHED FLOORING ON 11/16" ORIENTED STRAND BOARD (FASTENED & GLUED TO FLOOR STRUCT. BELOW) ON 2×10 FLOOR JOISTS @ 16" OR 12" O/C C/W 2×2 X-BRIDGING @ 7.0' O/C (MAX) PROVIDE R-31 F/G BATT INSULATION IN JOIST CAVITY C/W BUILDING WRAP		3/8"×2" BORATE TREATED PLYWOOD STRAPPING HOUSE WRAP (A.B.) (TYVEK OR EQ.) 7/16" ORIENTED STRAND BOARD SHEATHING 2×6 STUDS @ 16" O/C R-20 INSULATION 6 MIL. POLYETHYLENE VAPOUR BARRIER 1/2" GYPSUM BOARD		(PROVIDE REQUIRED FIRE STOPS IN WALL ASSEMBLIES TO COMPLY WITH B.C. BLDG. CODE 9.10.16.)	
		VENTED SOFFIT (TO OWNERS SPEC'S) TO ALL SUSPENDED FLOOR AREAS (NOT IN SECTION)	W3.	B.C. BUILDING CODE (TABLE 9.10.3.1.A) RATED WALL ASSEMBLY W3c 1 LAYER 1/2" X-TYPE GYPSUM BOARD RESILIENT METAL CHANNELS @ 24" O/C			
	FL4.	3 1/2" CONCRETE SLAB 6 MIL. POLY'N V.B. 6" COMPACTED GRAVEL OR SAND		2×4 STUDS @ 16" O/C OR 2×6 STUDS @ 16" O/C (IF NOTED) C/W 3 1/2" FIBRE GLASS SOUND BATTS 1 LAYER 1/2" X-TYPE GYPSUM BOARD		ALL STRUCTUR STRUCTURAL E	
	FL5.	3 1/2" CONCRETE SLAB 6 MIL. POLY'N V.B. 6" COMPACTED GRAVEL OR SAND SLOPE TO DOORS 1" (NOT IN SECTION)		45 MIN. F.R.R 43 S.T.C (BETWEEN PRIMARY LIVING & SECONDARY SUITE)		AND INTERIOR WITH B.C. BUIL	

Development Permit Presentation



#103 - 891ATTREE AVENUE VICTORIA, B.C. V9B 0A6 P. 250.382.7374 F. 250.382.7364

FOUNDATION

DAMP PROOFING (WHERE REQUIRED) ON 8" THK. CONC. FOUNDATION WALL C/W 15 M BARS @ 24" O/C B/W

16"X 8" CONC. FOOTINGS C/W 2 (TWO) 15M BARS CONT. 3 IN. FROM BOTT. ON UNDISTURBED SOIL (SOLID BEARING)

4" PERIMETER DRAIN 3" TIGHT PIPE FOR RWL DRAIN ROCK

ANCHOR BOLTS @ 4.0 FT. O/C MAX C/W SILL GASKETS

UNDER SLAB INSULATION 2 1/2" (RSI 2.15) EXTRUDED POLYSTYRENE RIGID INSULATION 4'-0" (1.2M) CONT. AROUND PERIMETER UNDER SLAB INSTALLED HORIZONTALLY (VERIFY WITH MUNICIPALITY DEPTH OF FROST LINE)

D BE VERIFIED OR DESIGNED BY A STRUCTURAL ENGINEER. FINEER TO LOCATE AND DESIGN REQUIRED EXTERIOR ALL BRACING TO RESIST LATERAL LOADS IN COMPLIANCE IG CODE 9.23.13 AND SUPPLY DETAILS IF REQUIRED

CARAVEL TRADITIONAL Date Feb. 6, 2023

Project Address Lot 73 - 401 Rock Dove Place Royal Bay - Sector 7 Colwood, B.C. **Prepared for**


Verity Construction

Project # 8298

0270

Scale As Noted

Drawn By LIS

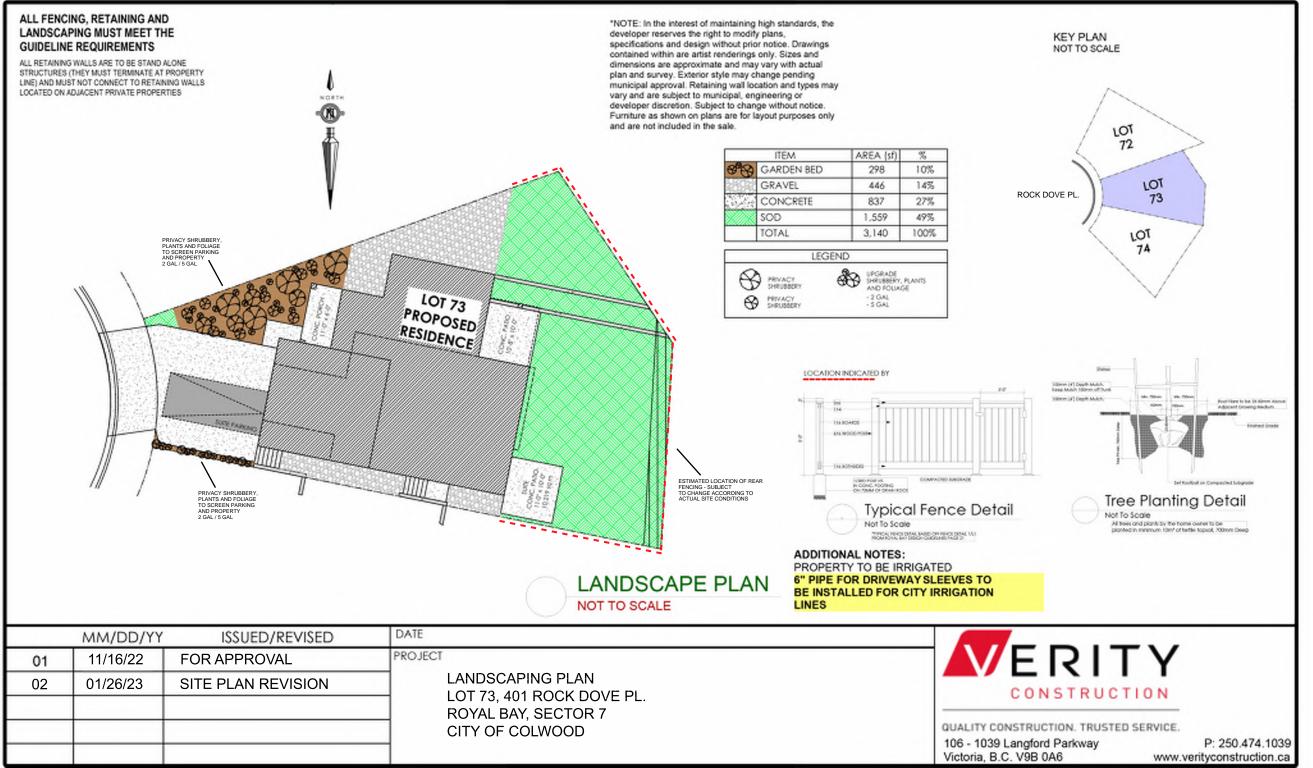

GABLECRAFT HOMES BUILDING GRADE SLIP

Issue Date: _____

MUNICIPAL ADDRESS 401 Rock Dove Place	P.I.D.
LOT 73	PLAN
	SUBDIVISION
ADDRESS	ROYAL BAY SECTOR 7 DEVELOPER
REPRESENTATIVE PH.	MEADOWS DEVELOPMENT LP CONSULTANT WSP CANADA INC
PROPOSED BUILDING GRADES ALL ELEVATIONS ARE METRIC GEODETIC +	PLAN LOT: PLAN:
MAIN FLOOR ELEVATION66.05	111.11
FRONT ELEV. 65.85 (FINISHED GRADE) (FINISHED GRADE) JOIST DEPTH	64.0
FINISHED GRADE AT GARAGE 65.85	64.0
HEADROOM	
ACTUAL TOP OF FOOTING not provided	LFE 63.23 GFE 65.78
ELEVATION (ATF)	MSE 62.03 S 61.50
FOOTING ELEVATION (LTF) (BOTTOM OF BASEMENT SLAB FROST WALLS ARE REQUIRED.)	
SERVICES FRONT REAR CENTER REFER SIZE TO PLAN (mm)	
WATER	E 65.71
SANITARY	65.78
STORM	ROAD A
COMMENTS YES NO	
DRAIN TO SUMP PUMP LIKELY REQUIRED (FOR BASEMENT IF INSTALLED)	LEGEND
SEWER TO SUMP PUMP LIKELY REQUIRED (FOR BASEMENT IF INSTALLED)	STREET
	NATE AND THE ADDRESS TO ADDRESS T
FOUNDATION SOIL BEARING INVESTIGATION CERTIFICATION REQUIRED	III - SERVICE LOCATION (SHOWN ON ABOVE PLAN)
GEOTECHNICAL RESTRICTIONS APPLY	- PROPOSED FRONT CORNER ELEVATIONS
(SEE GEOTECHNICAL REPORT)	L# 6 X H - LEGAL LOT NUMBER
(SEE ENVIRONMENTAL REPORT)	EG 49.90
UTILITY EASEMENTS AFFECT THIS LOT	LFE/MFE 47.70 - LOWER/MAIN FLOOR ELEVATION GFE 47.55 - GARAGE FLOOR ELEVATION
	MSE 52.20 - MINIMUM SANITARY SERVICABLE ELEVATION BY GRAVITY
	D 49.12 (P) D 49.12 (P) - SAN SERVICE INV. (P) DENOTES PUMP IS LIKELY REQUIRED FOR BASEMENT IF INSTALLED
	City City City City City City City City
	FOR BASEMENT IF INSTALLED
	L L L L L L L L L L L L L L L L L L L
NOTES 1. IT IS THE RESPONSIBILITY OF THE BUILDER TO ENSURE THE FOOTINGS	LANE/LOT - PROPOSED REAR CORNER ELEVATIONS
ARE PLACED ON A PROPER BASE THAT IS FREE FROM FROST, EXCESSIVE MOISTURE AND DELETERIOUS MATERIALS AND HAVE APPROPRIATE FROST PROTECTION WHEN COMPLETED.	
 THE INFORMATION CONTAINED HEREIN IS BASED ON THE APPROVED LOT GRADING PLAN FOR THIS SUBDIVISION. UN-AUTHORIZED 	
DEVIATIONS WILL BE THE RESPONSIBILITY OF THE BUILDER TO ENSURE COMPLIANCE WITH ALL LOCAL BYLAWS.	I, THE BUILDER'S REPRESENTATIVE, CERTIFY THAT THE FINAL HOUSE PLANS PROVIDED IN THE BUILDING PERMIT APPLICATION ARE THE SAME AS PROCESSED UNDER THIS GRADE SLIP AND
3. OTHER NOTES:	THAT I UNDERSTAND THE SAME AS PROCESSED UNDER THIS GRADE SLIP AND THAT I UNDERSTAND THE INFORMATION AND THE REQUIREMENTS CONTAINED HEREIN AND WILL BUILD ACCORDINGLY.
	AUTHORIZED BUILDER'S REPRESENTATIVE DATE
	THE INFORMATION CONTAINED HEREIN IS BASED ON THE APPROVED LOT GRADING PLAN FOR THIS SUBDIVISION, DATED
	C. Hume - Jan. 31/23 ISSUED BY DEVELOPER'S AUTHORIZED REPRESENTATIVE DATE

L J L J WSP - May 13, 2022 8:13 AM D:\2021\211-00627-00_ROYAL BAY - SECTOR 7\3_TECH\3_CADD\3_SHEETS\211-00627-00-BUILDING-GRADE-SLIPS.DWG

SITE DATA	RBCD5	LOT 74
ITEMS	PERMITTED	PROPOSED
LOT AREA	368 sq.m.	453.72 sq.m.
LOT COVERAGE	50.00 %	34.71 %
BUILDING HEIGHT	9.50 m.	8.64 m.
LOT WIDTH	10.97 m.	8.31 m.
Setbacks		
- FRONT	3.00 m.	6.79 m.
- FRONT (GARAGE)	6.00 m.	7.09 m.
- REAR	6.00 m.	6.00 m.
- SIDE	1.20 m.	1.24 m.
- SIDE	1.20 m.	1.39 m.
PROPOSED FLOOR AREA		
- UPPER		139.00 sq.m.
- MAIN		103.93 sq.m.
- LOWER		103.94 sq.m.
- GARAGE		39.02 sq.m.
SUB-TOTAL G.F.A.		385.89 sq.m.
GARAGE ALLOWANCE	50.00 sq.m.	-39.02 sq.m.
GROSS FLOOR AREA		346.87 sq.m.
F.A.R.		0.76 TO 1.0
SECONDARY SUITE		
FLOOR AREA (%)	40.00 %	18.60 %
FLOOR AREA (SQ.M.)	90.00 sq.m.	64.51 sq.m.


AVERAGE NATURAL GRADE CALCULATION <u>65.76 m. + 63.79 m. + 62.94 m. + 65.45 m. = 257.94 m.</u> divided by 4 = ave. grade 64.49 m.

SEE LANDSCAPING PLAN FOR TREE SCHEDULE

RETAINING WALLS


XX.Xm = DESIGNER APPROXIMATE HEIGHT MEASUREMENT, VERIFY ON SITE - TO BE CERTIFIED BY AN ENGINEER AND MEET BCBC REQUIREMENTS FOR EARTHQUAKE DESIGN (REFER TO STRUCTURAL DRAWINGS)

- ALL LANDSCAPE RETAINING WALLS TO HAVE A 1.2m MAX. EXPOSED HT OR A MAX. 1:1 RATIO OF HEIGHT TO HORIZONTAL SEPARATION IF TERRACED

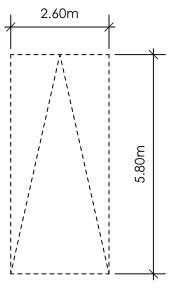


PARKING STALL DIMENSIONS

2

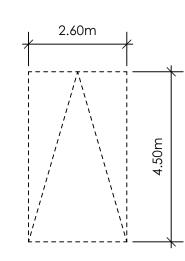


SMALL CAR PARKING STALL DIMENSIONS * as per 2.2.02a allowing one stall to be a small car parking stall

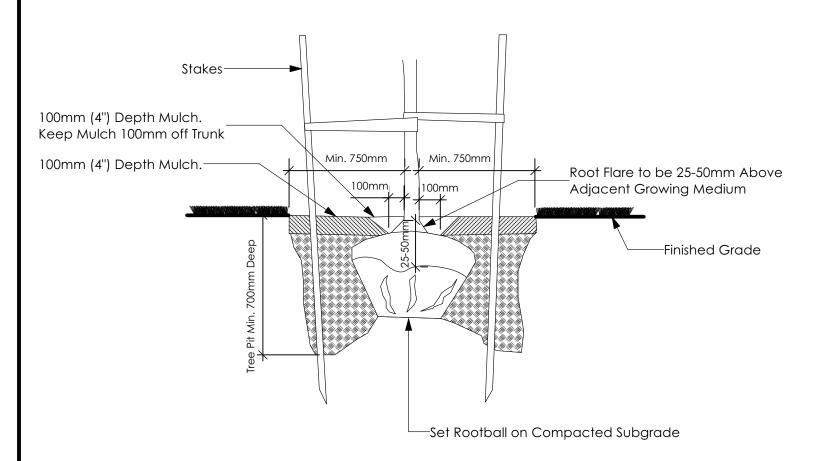

Tree Planting Detail Not To Scale


All trees and plants by the home owner to be planted in minimum 10m³ of fertile topsoil, 700mm Deep

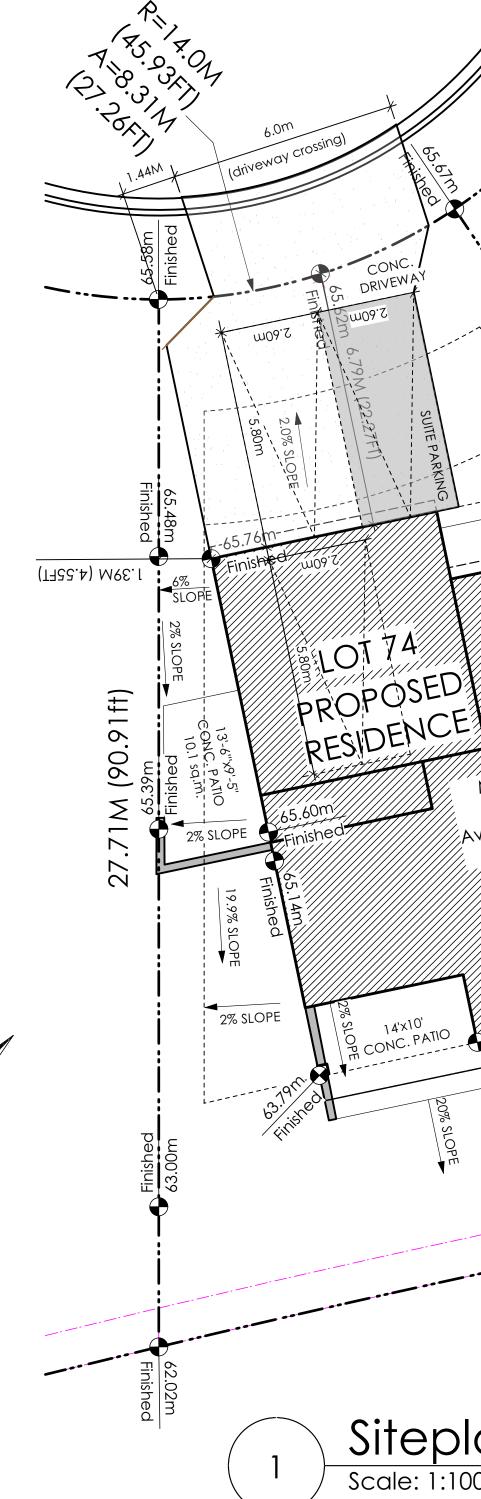



BUILDER IS RESPONSIBLE FOR ALL COSTS TO ENSURE ALL CITY OF COLWOOD GRADING AND SETBACK REQUIREMENTS HAVE BEEN ACHIEVED AND THIS PLOT PLAN COMPLIES WITH ALL REQUIREMENTS OF THE DESIGN GUIDELINES I.E. SEE APPENDIX: GRADING STANDARDS (PAGE 30) ETC.

1: ENSURE A MINIMUM 2% SLOPE AWAY FROM STRUCTURE ON ALL SIDES 2: ALL RETAINING REQUIRED MUST MEET GUIDELINE REQUIREMENTS

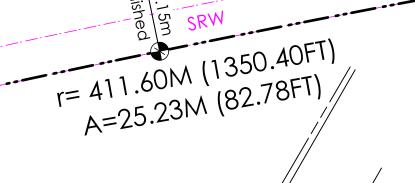

7.47m

3

2.13m

PASSENGER VEHICLE 2.13M X 5.8M (7'x19')

TURNING TEMPLATE

Not To Scale

Siteplan Scale: 1:100


14'x10' ONC. PATIO


PATH OF OVERHANG-

PATH OF FRONT WHEEL-PATH OF REAR WHEEL-

M.F.E.-65.96M G.F.E.-65.76M

Avg. Grade-64.49M

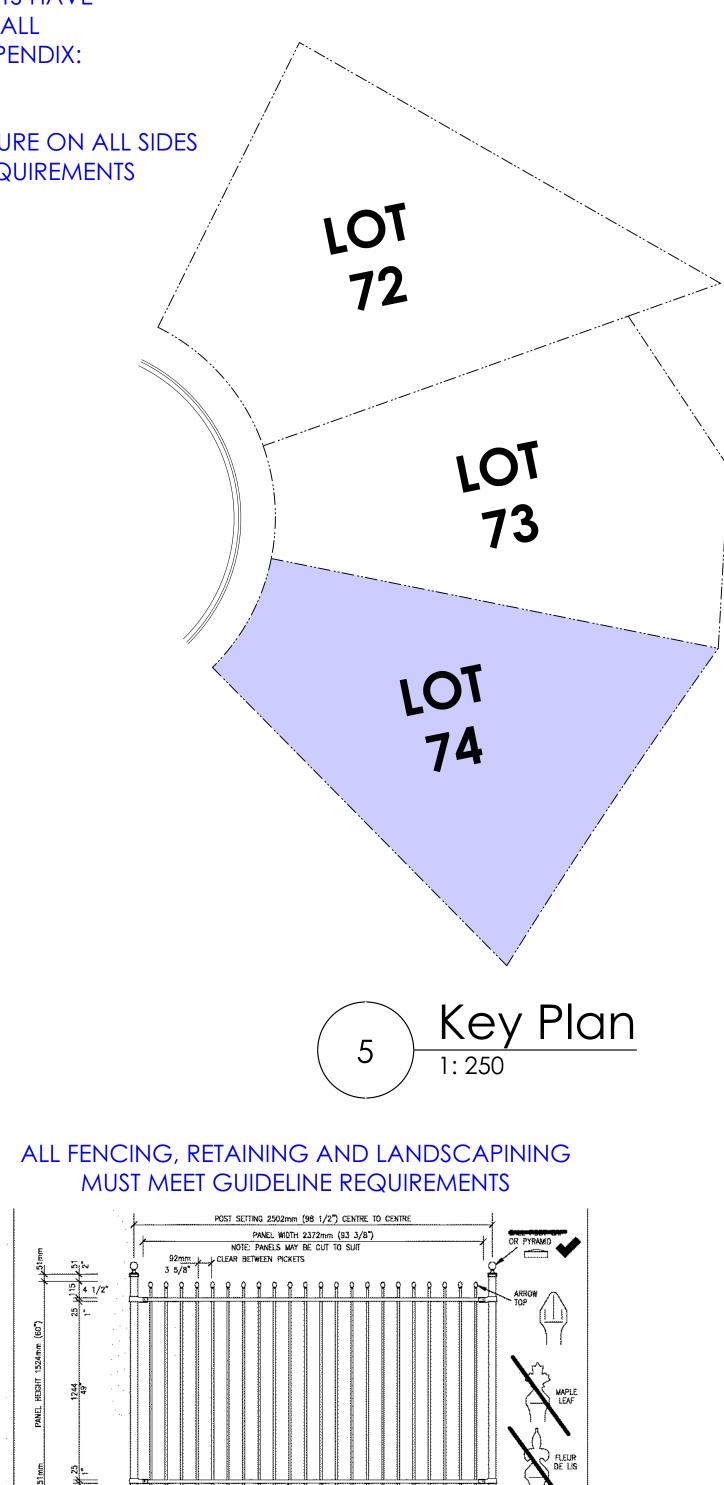

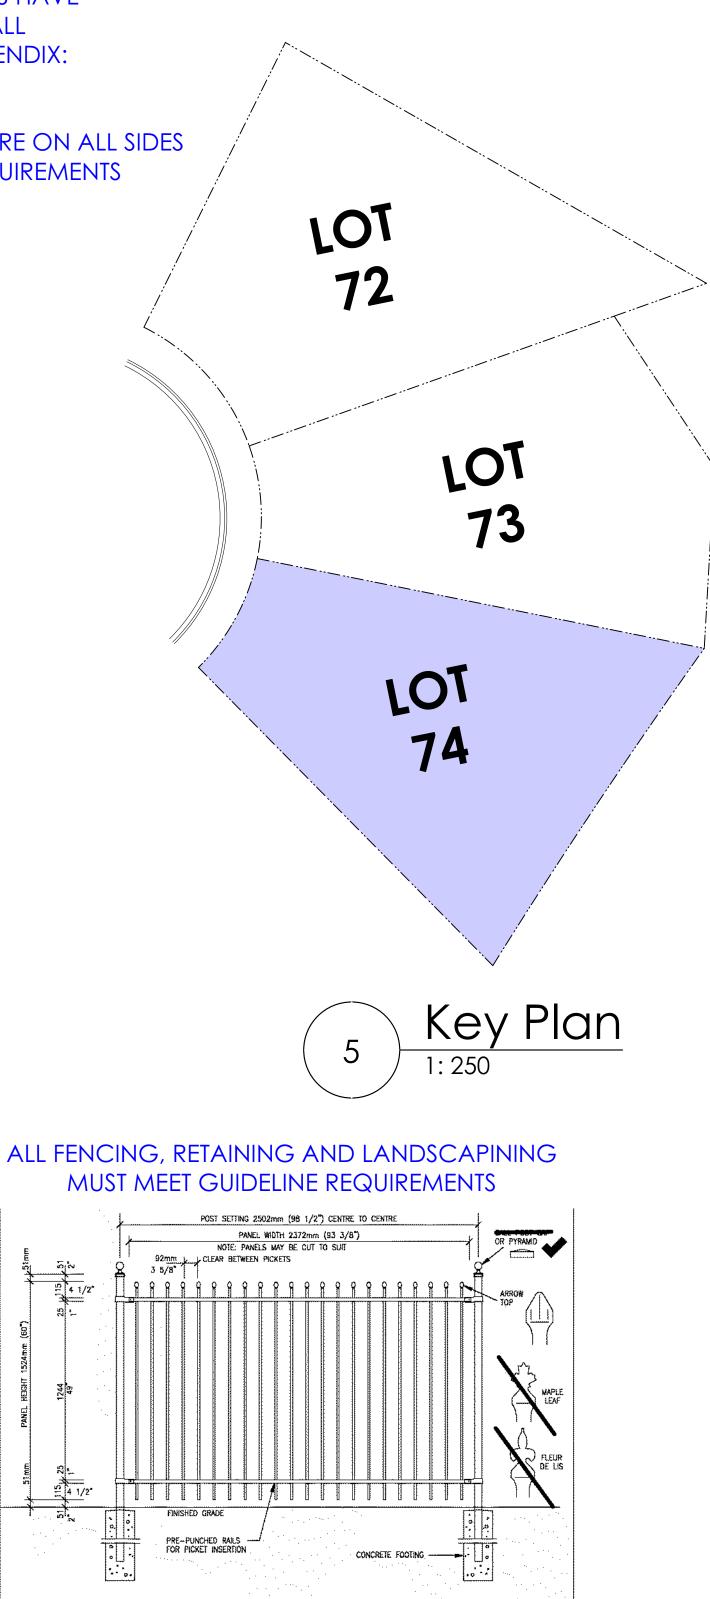

Turning Template



Development Permit Presentation



9 design group

#103 - 891ATTREE AVENUE VICTORIA, B.C. V9B 0A6 P. 250.382.7374 F. 250.382.7364

APPROVED BY VERITY CONSTRUCTION

DATE

APPROVED BY REALTOR

DATE

SPINNAKER COASTAL Date March 16, 2023


Project Address 405 Rock Dove Place Royal Bay - Sector 7 Colwood, B.C. Prepared for

Verity Construction

Project # 8298

Scale As Noted

Drawn By MRB

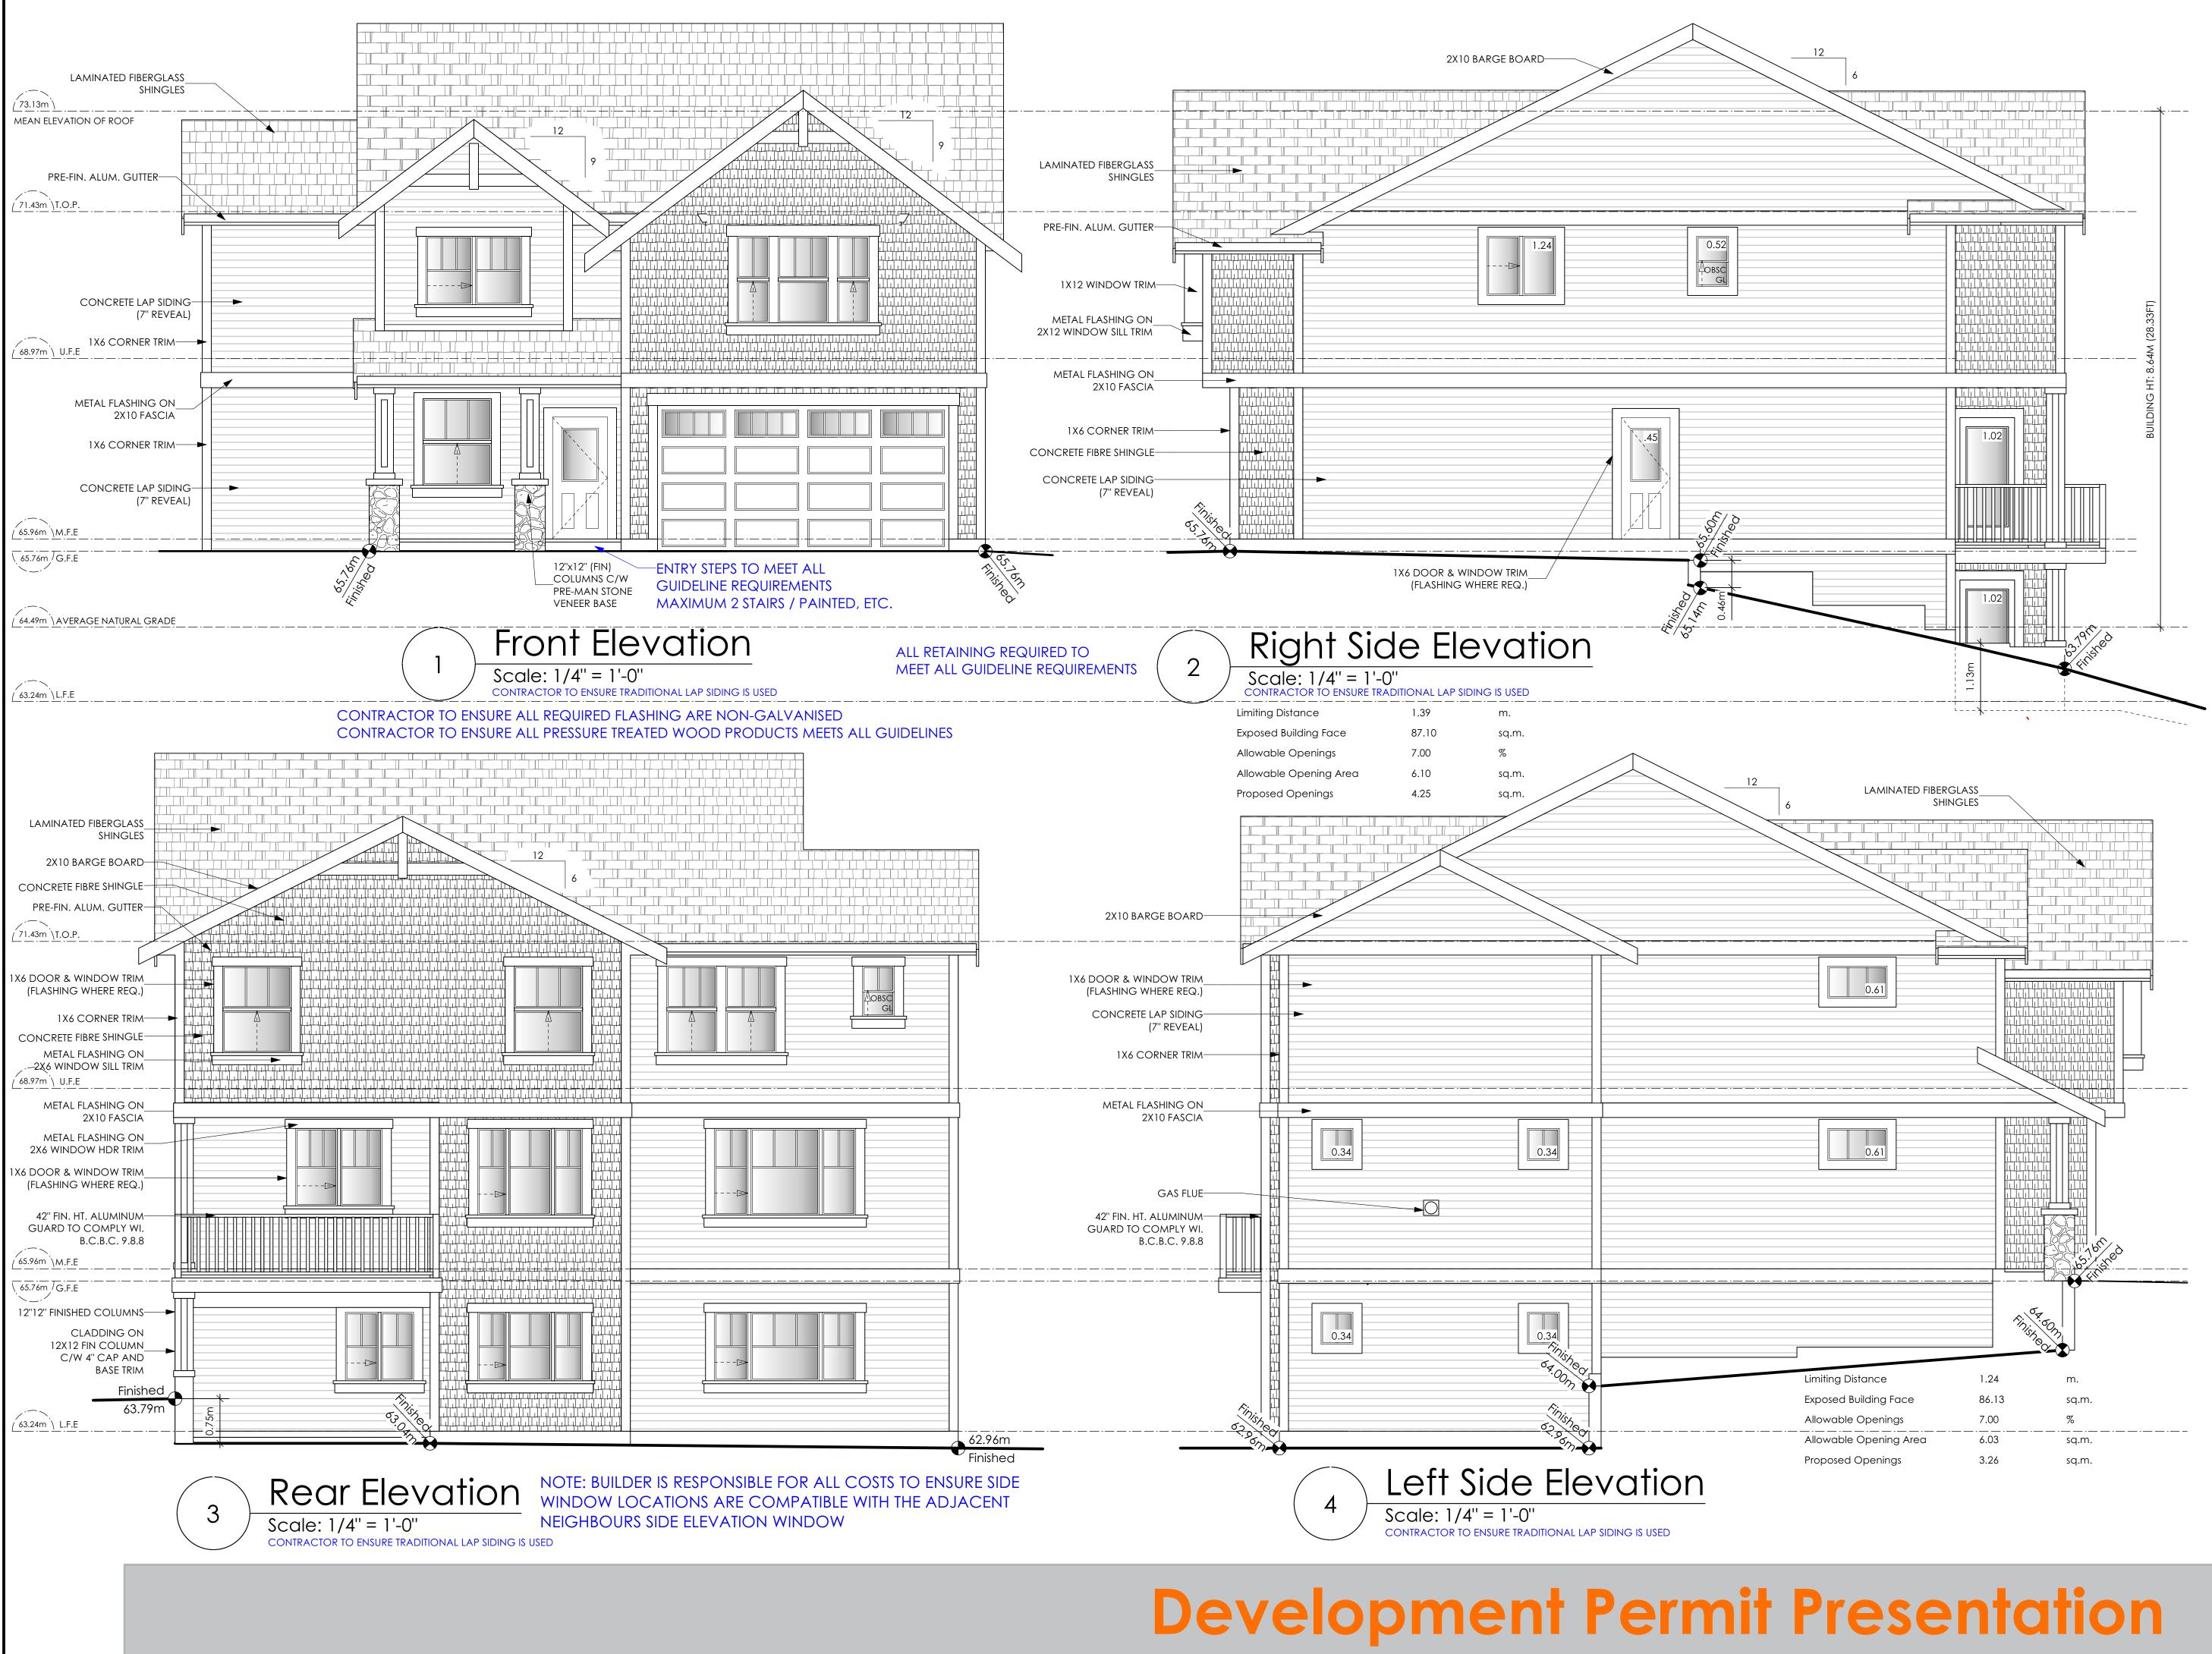

9 design group

#103 - 891 ATTREE AVENUE VICTORIA, B.C. V9B 0A6 P. 250.382.7374 F. 250.382.7364

SPINNAKER COASTAL Date March 16, 2023


Project Address 405 Rock Dove Place Royal Bay - Sector 7 Colwood, B.C. Prepared for


Verity Construction


Project # 8298

Scale A3 As Noted

Drawn By MRB

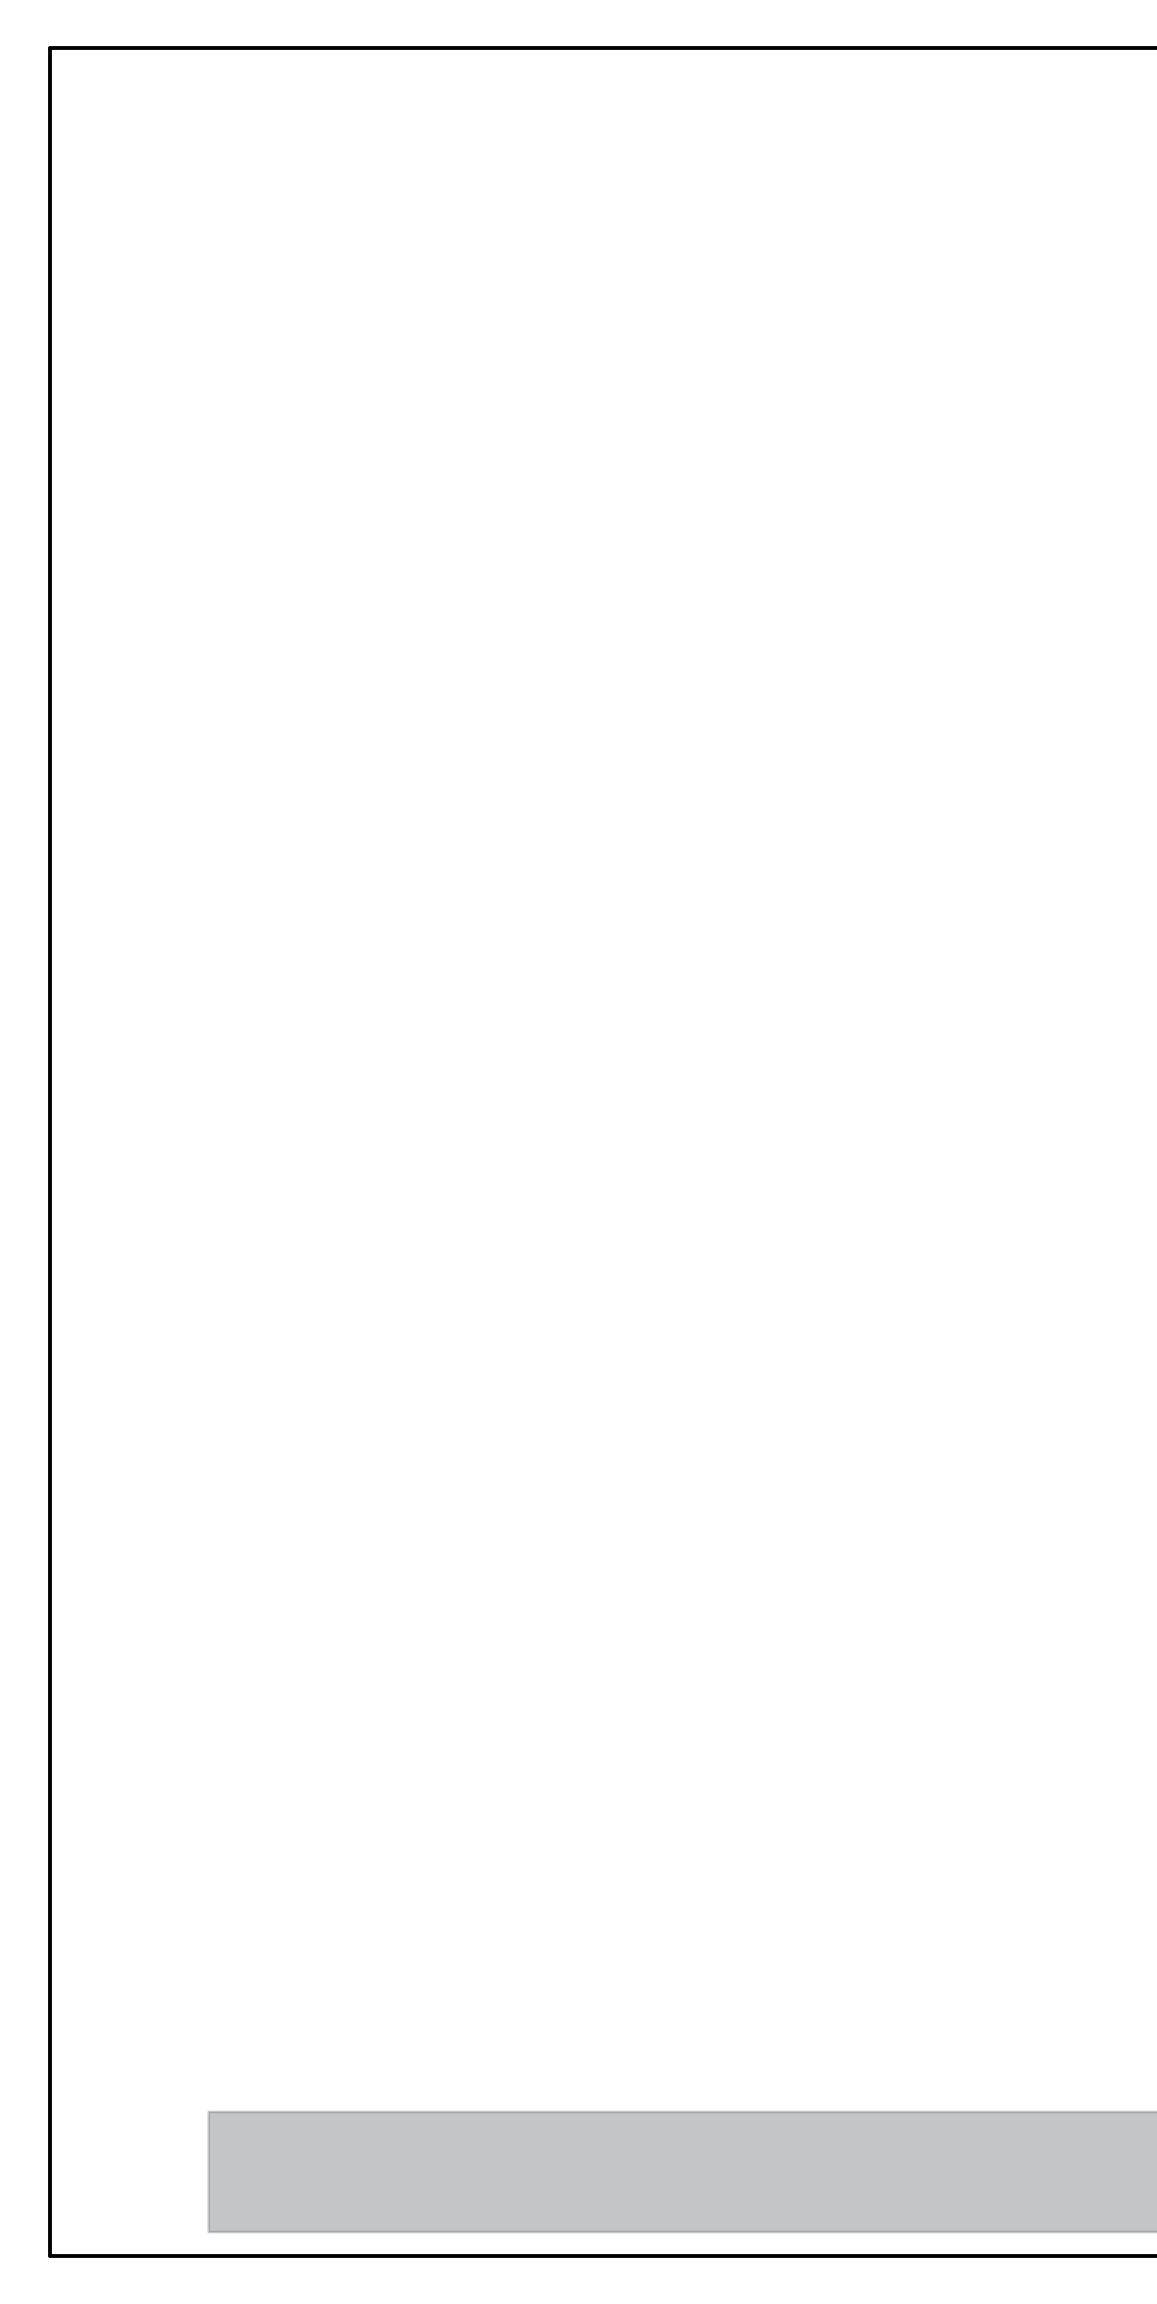

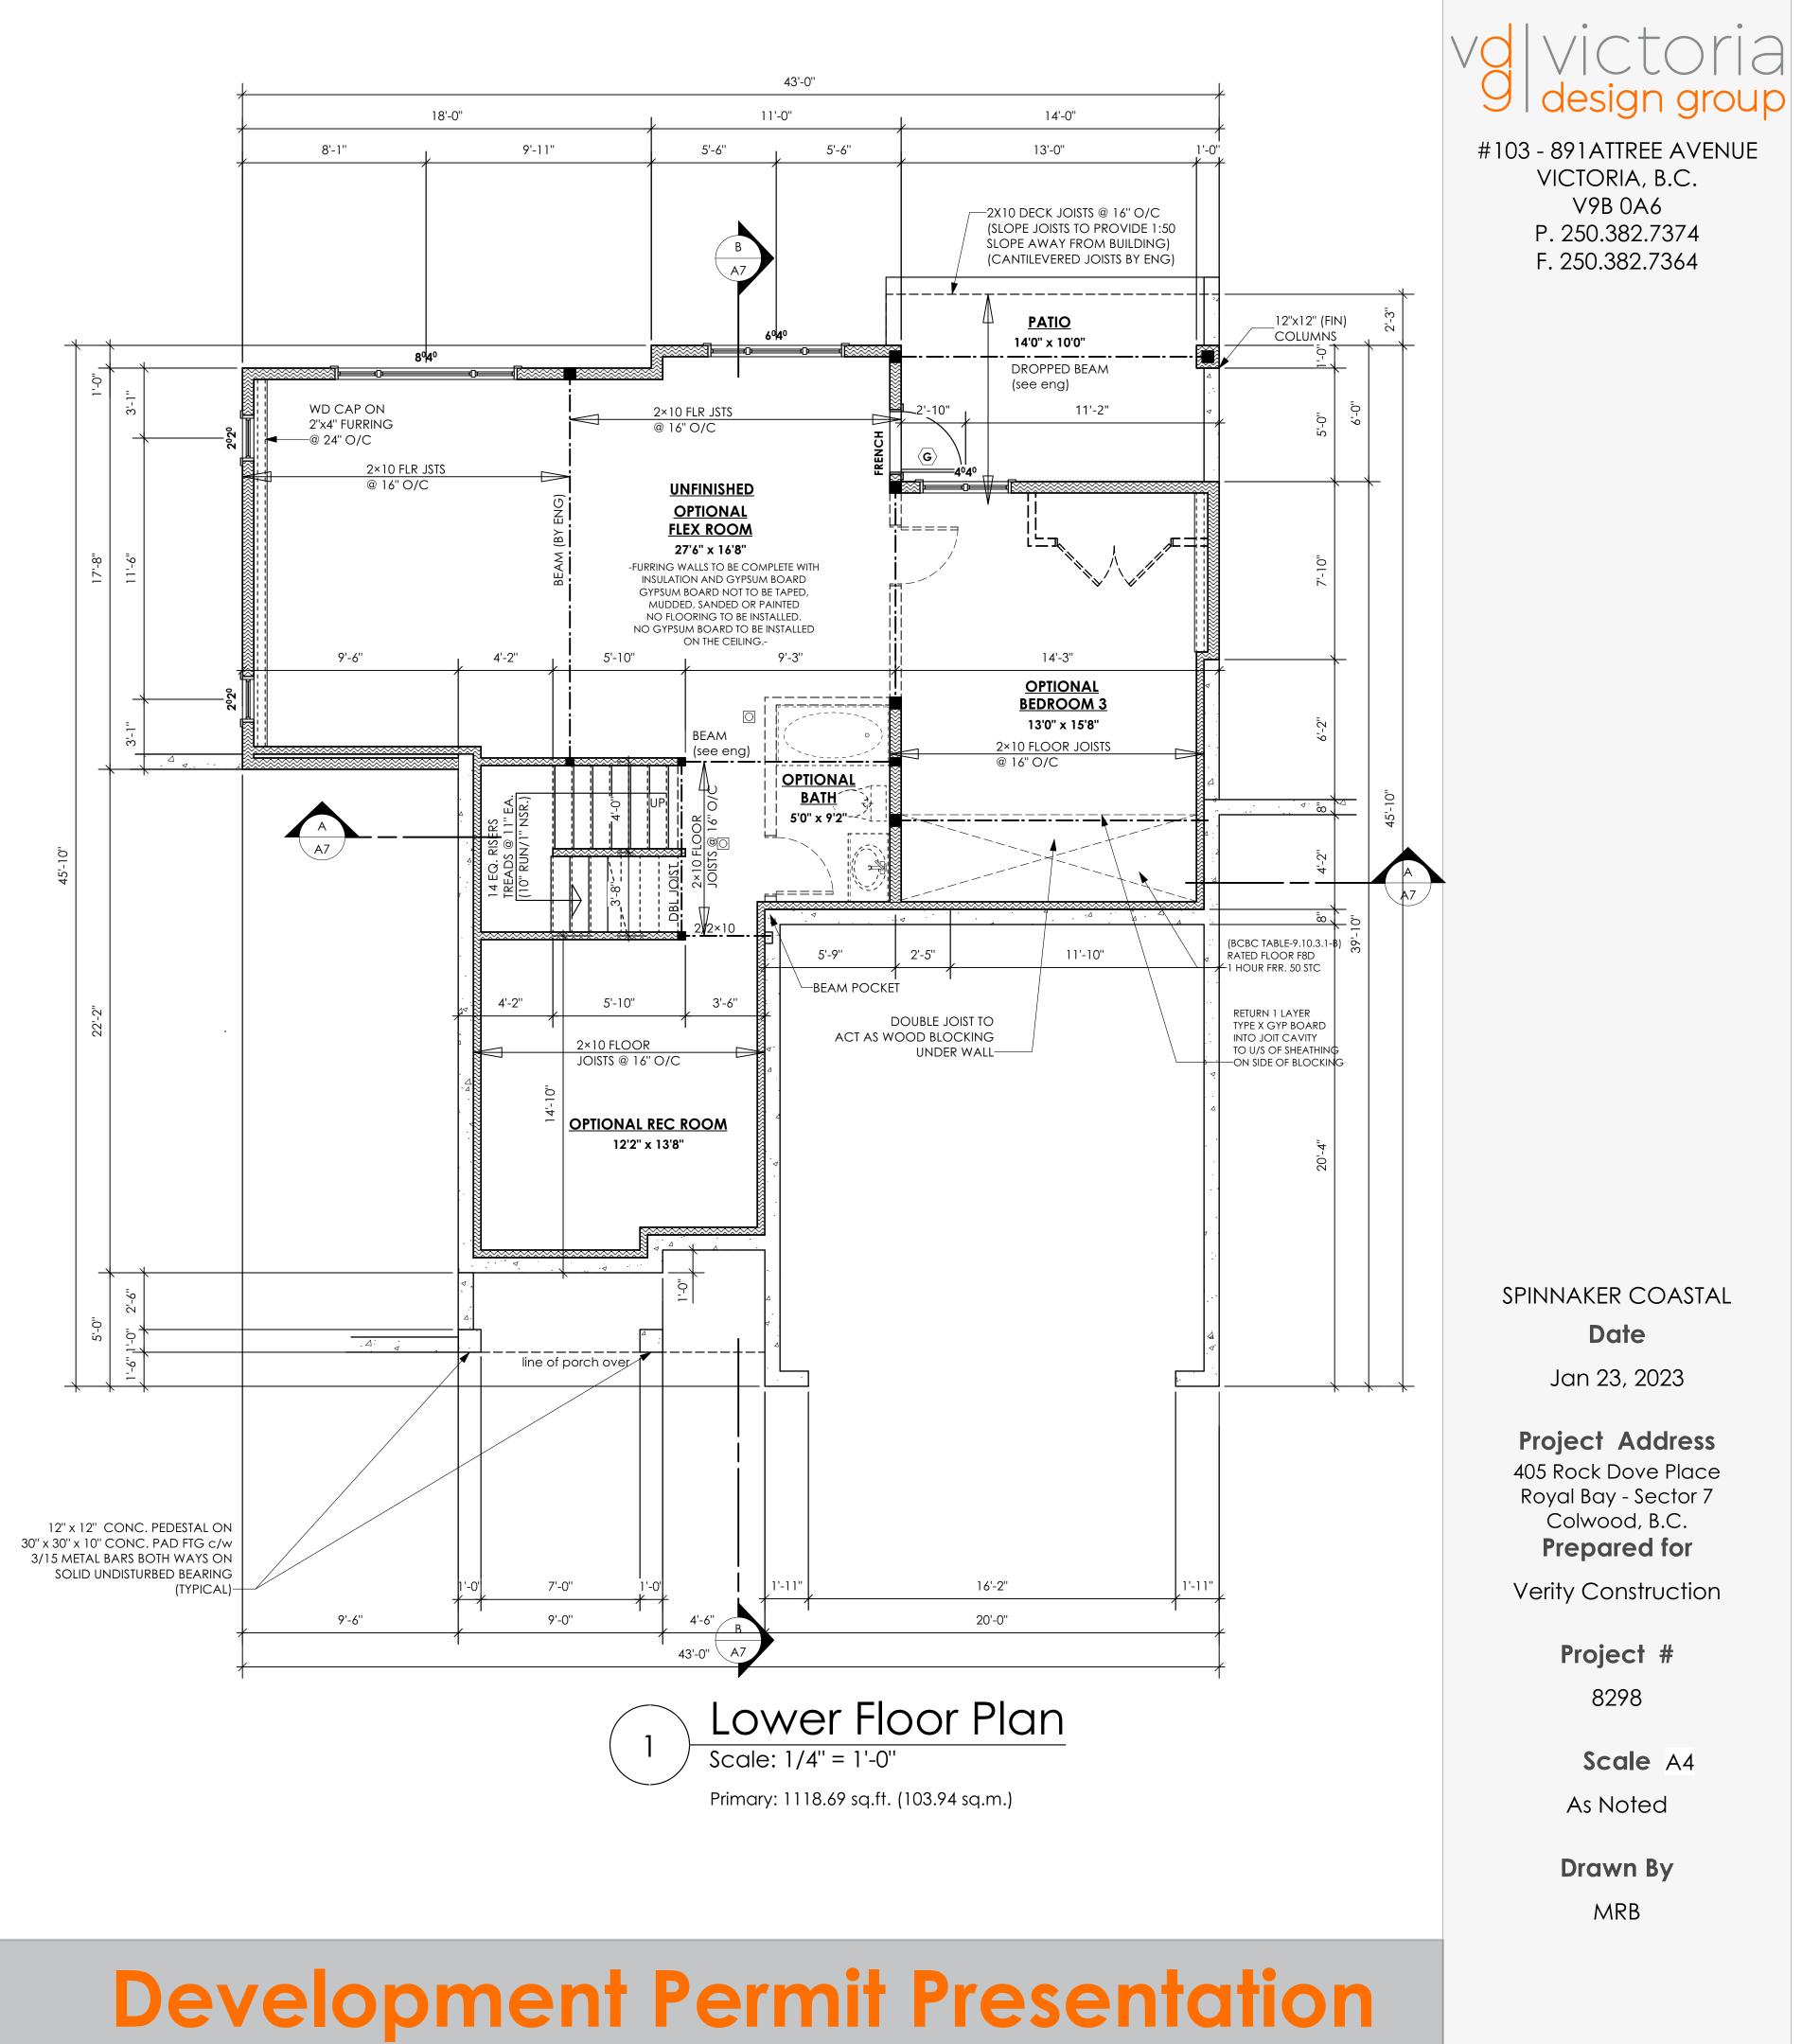

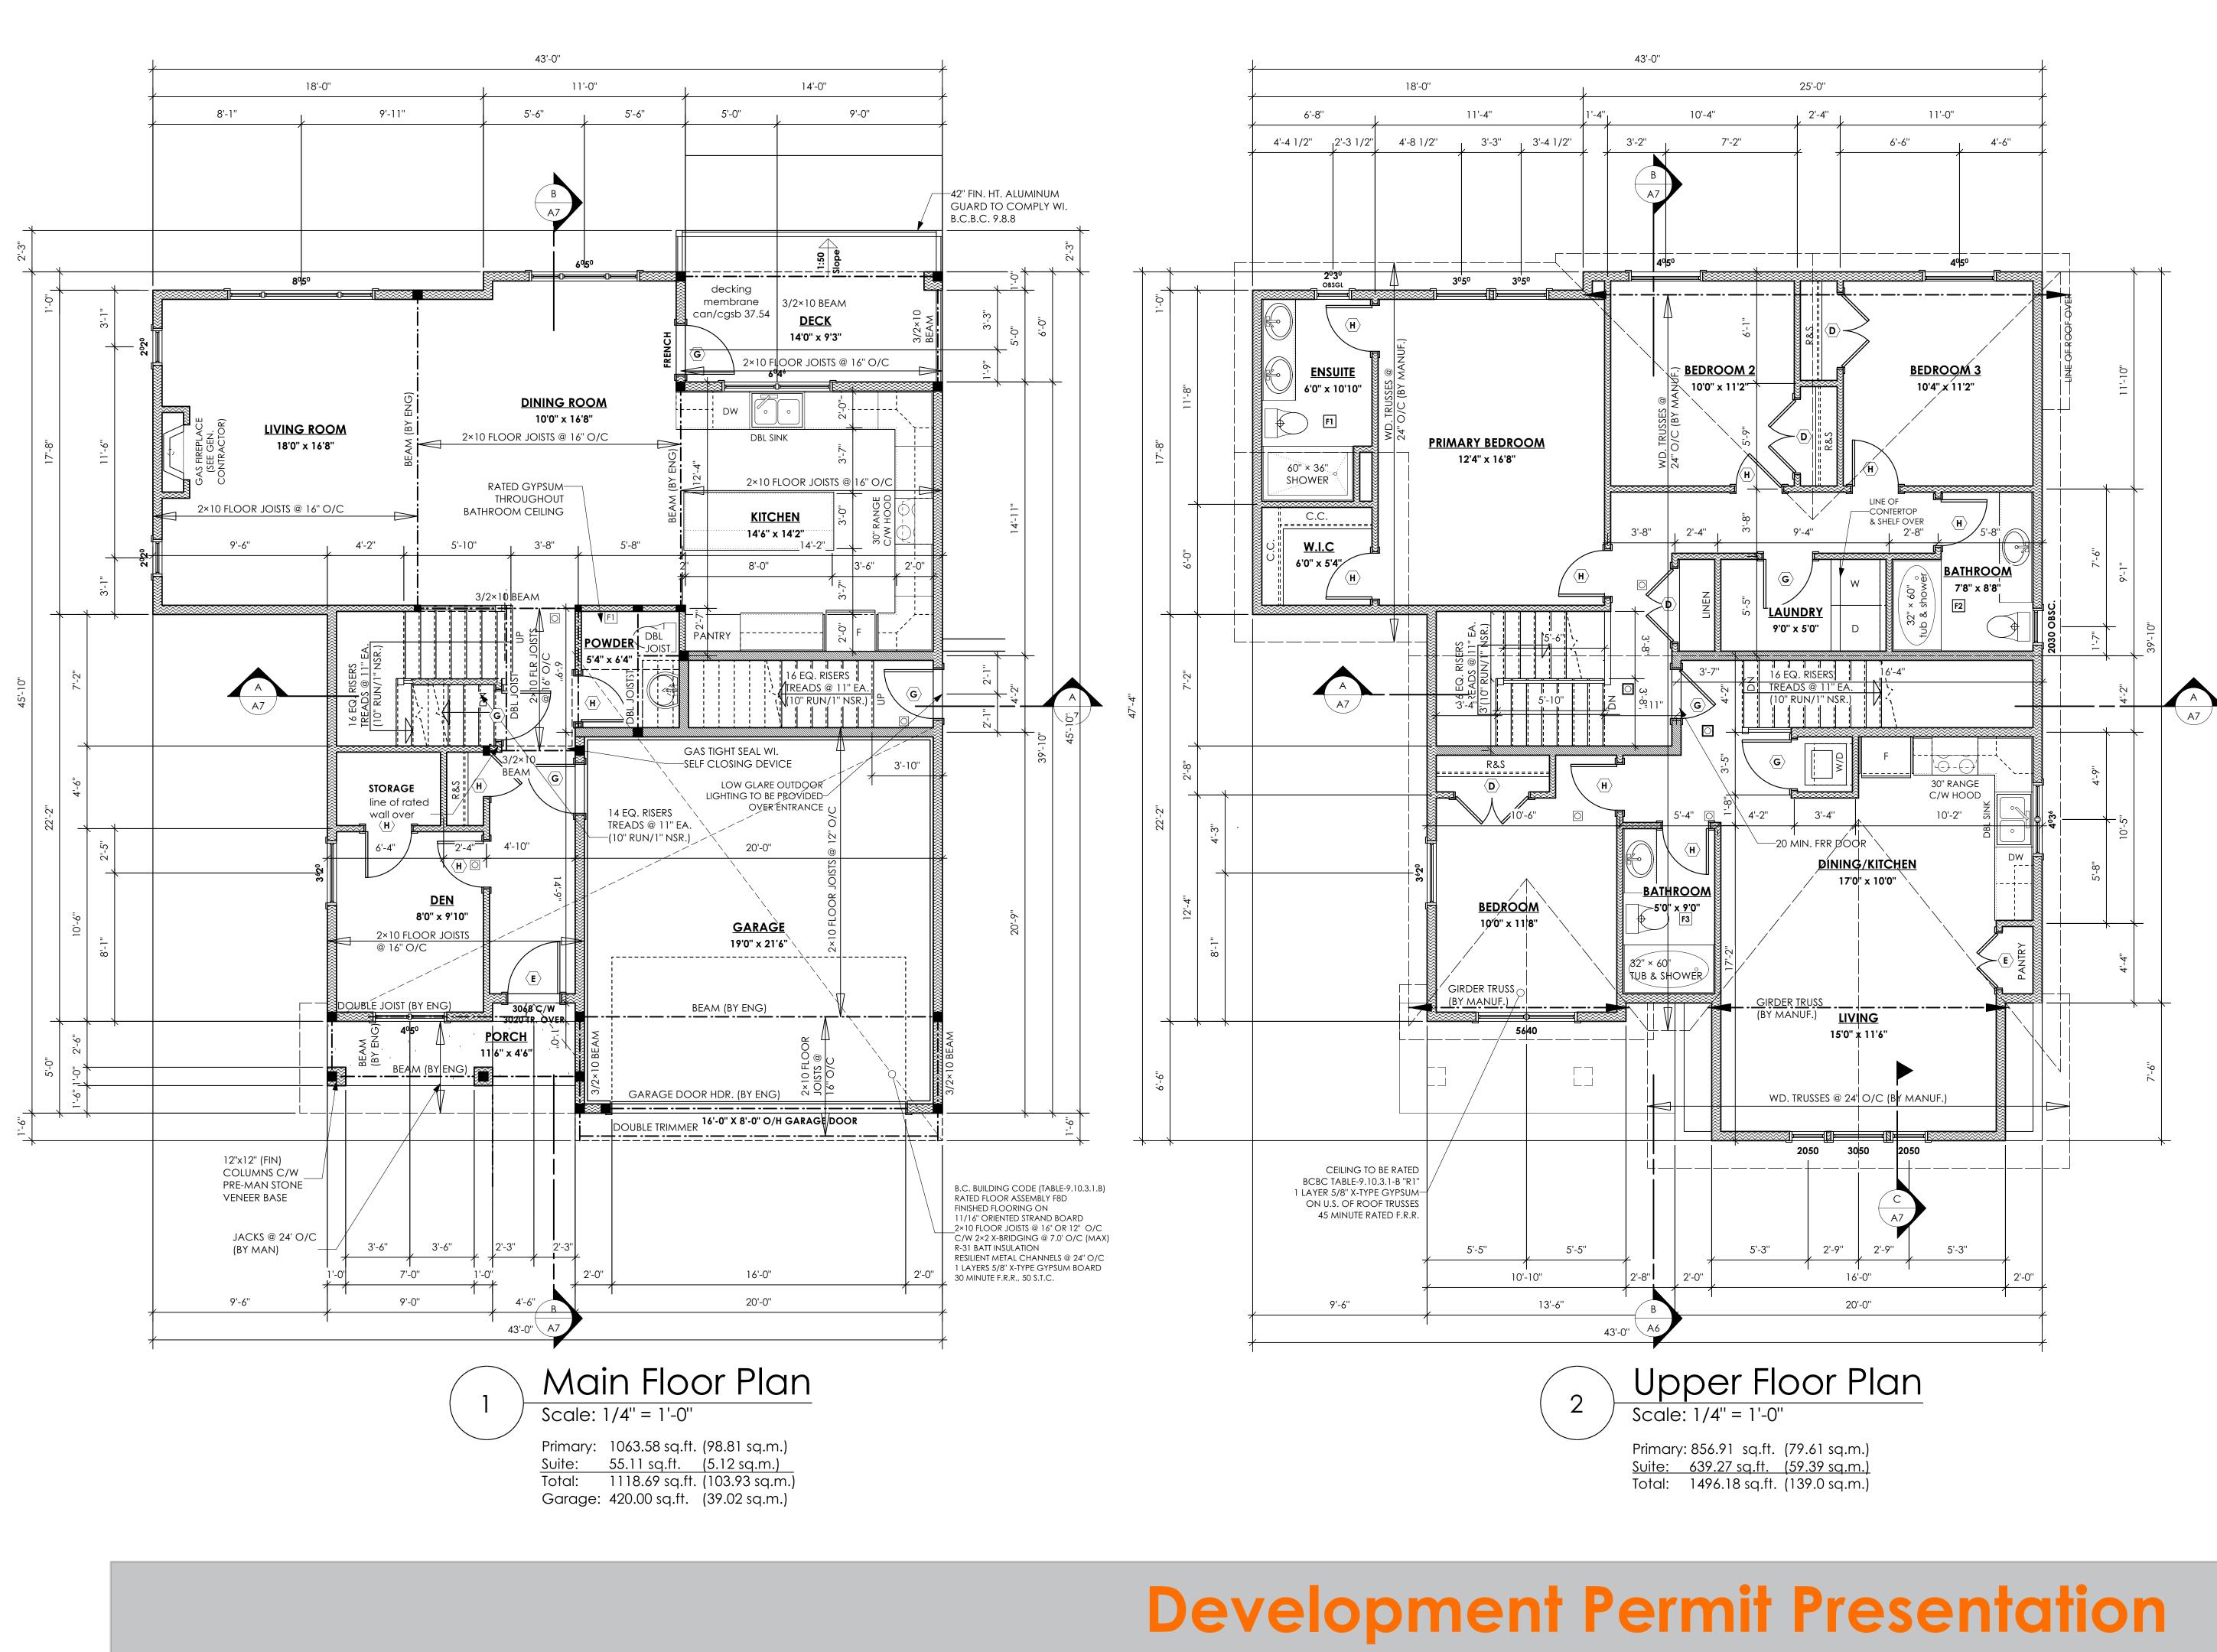

9 design group

#103 - 891ATTREE AVENUE VICTORIA, B.C. V9B 0A6 P. 250.382.7374 F. 250.382.7364

SPINNAKER COASTAL Date Jan 23, 2023


Project Address 405 Rock Dove Place Royal Bay - Sector 7 Colwood, B.C. Prepared for

Verity Construction

Project # 8298

Scale A5 As Noted

Drawn By MRB

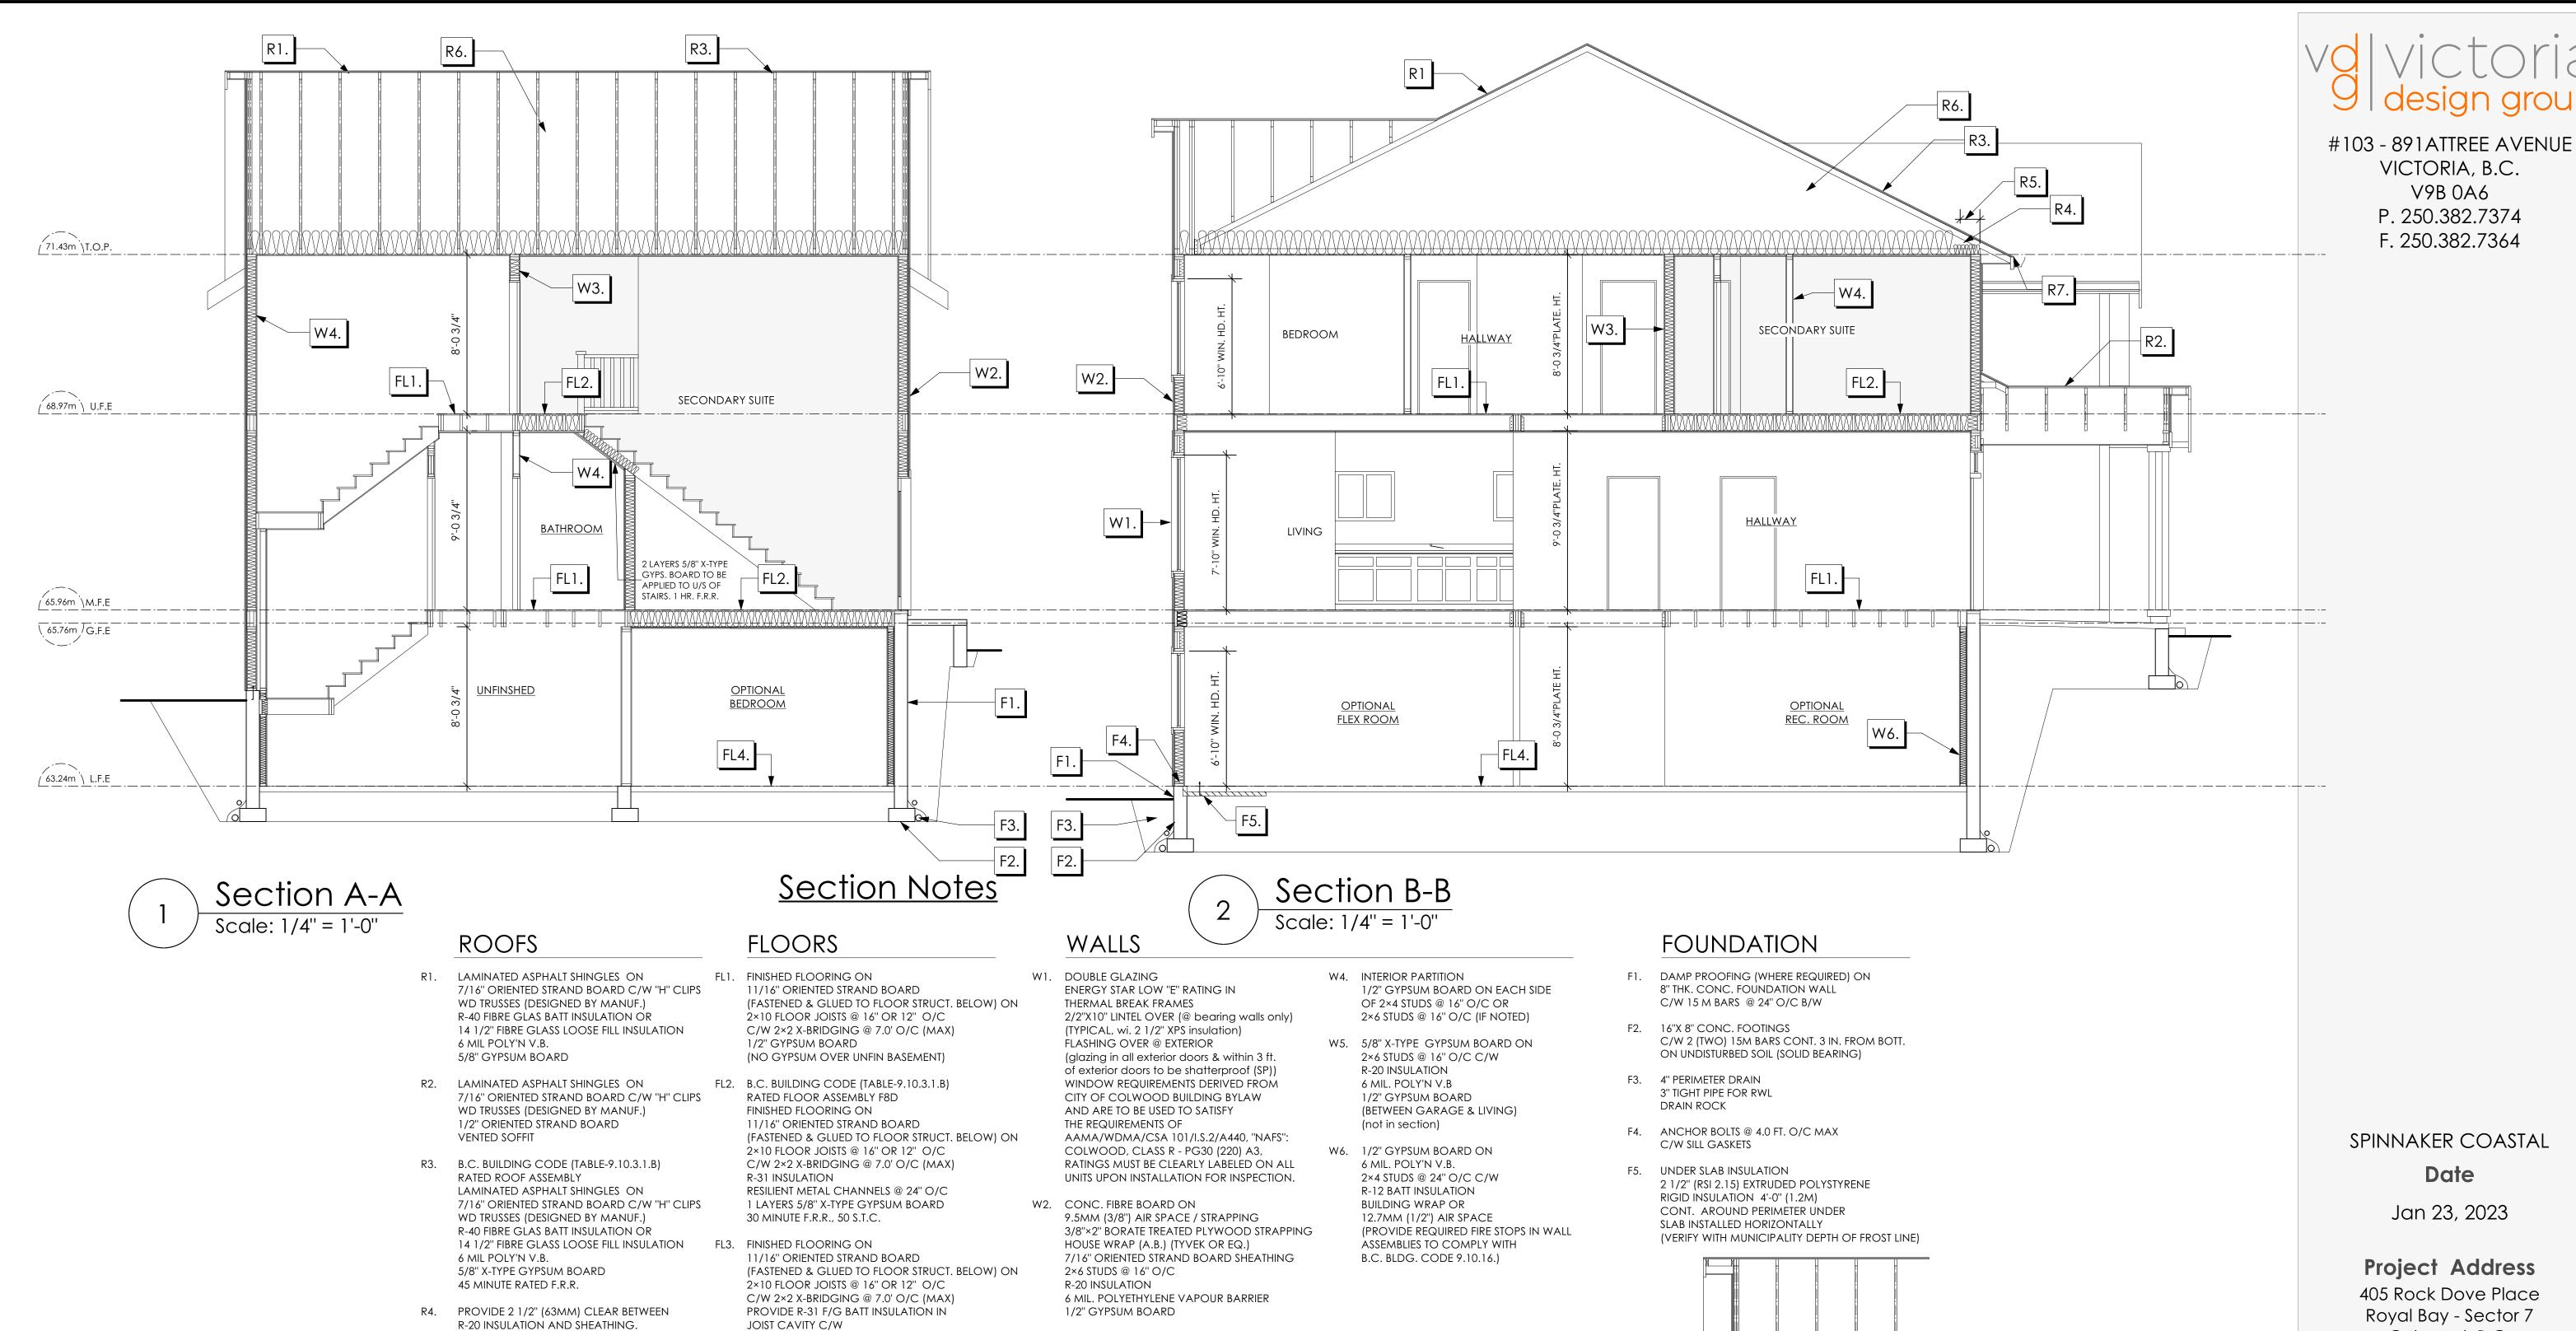

- R-20 INSULATION AND SHEATHING. (MIN. R-20 @ ROOF-WALL CONNECTION FOR 4'-0" (1.2M) AROUND PERIMETER OF BUILDING. AIR VENTILATION BAFFLES TO BE INSTALLED WHERE REQUIRED IN AS PER BCBC 9.19.)
- R5. EAVE PROTECTION CONT. UP ROOF SLOPE FOR 12" PAST EXTERIOR WALL.
- PROVIDE 1 SQ.FT. ATTIC VENT PER R6. 300 SQ.FT. OF INSULATED AREA MIN. 25% OF REQUIRED TO BE @ TOP AND BOTTOM (TO COMPLY WI. B.C. BLDG. CODE 9.19.1)
- PRE-FIN. FASCIA GUTTER R7. 2×8 FASCIA BD. 2×4 SUB. FASCIA BD. VENTED SOFFIT (SEE CONTRACTOR)

BUILDING WRAP


VENTED SOFFIT (TO OWNERS SPEC'S) TO ALL SUSPENDED FLOOR AREAS FL4. 3 1/2" CONCRETE SLAB

> 6 MIL. POLY'N V.B. 6" COMPACTED GRAVEL OR SAND

FL5. 3 1/2" CONCRETE SLAB 6 MIL. POLY'N V.B. 6" COMPACTED GRAVEL OR SAND SLOPE TO DOORS 1" (NOT IN SECTION)

W3. B.C. BUILDING CODE (TABLE 9.10.3.1.A) RATED WALL ASSEMBLY W3c 1 LAYER 1/2" X-TYPE GYPSUM BOARD RESILIENT METAL CHANNELS @ 24" O/C 2×4 STUDS @ 16" O/C OR 2×6 STUDS @ 16" O/C (IF NOTED) C/W 3 1/2" FIBRE GLASS SOUND BATTS 1 LAYER 1/2" X-TYPE GYPSUM BOARD 45 MIN. F.R.R 43 S.T.C

(BETWEEN PRIMARY LIVING & SECONDARY SUITE)

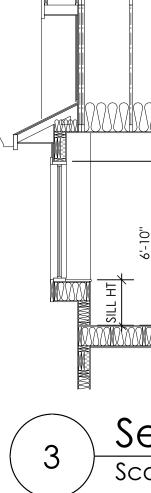

Development Permit Presentation

SUITE LIVING

<u>, 7 MA 7 8 M</u> GARAGE

Section C-C Scale: 1/4" = 1'-0"

SPINNAKER COASTAL Date Jan 23, 2023

l design group

VICTORIA, B.C.

V9B 0A6

P. 250.382.7374

F. 250.382.7364


Project Address 405 Rock Dove Place Royal Bay - Sector 7 Colwood, B.C. Prepared for

Verity Construction

Project # 8298

Scale A6 As Noted

Drawn By MRB

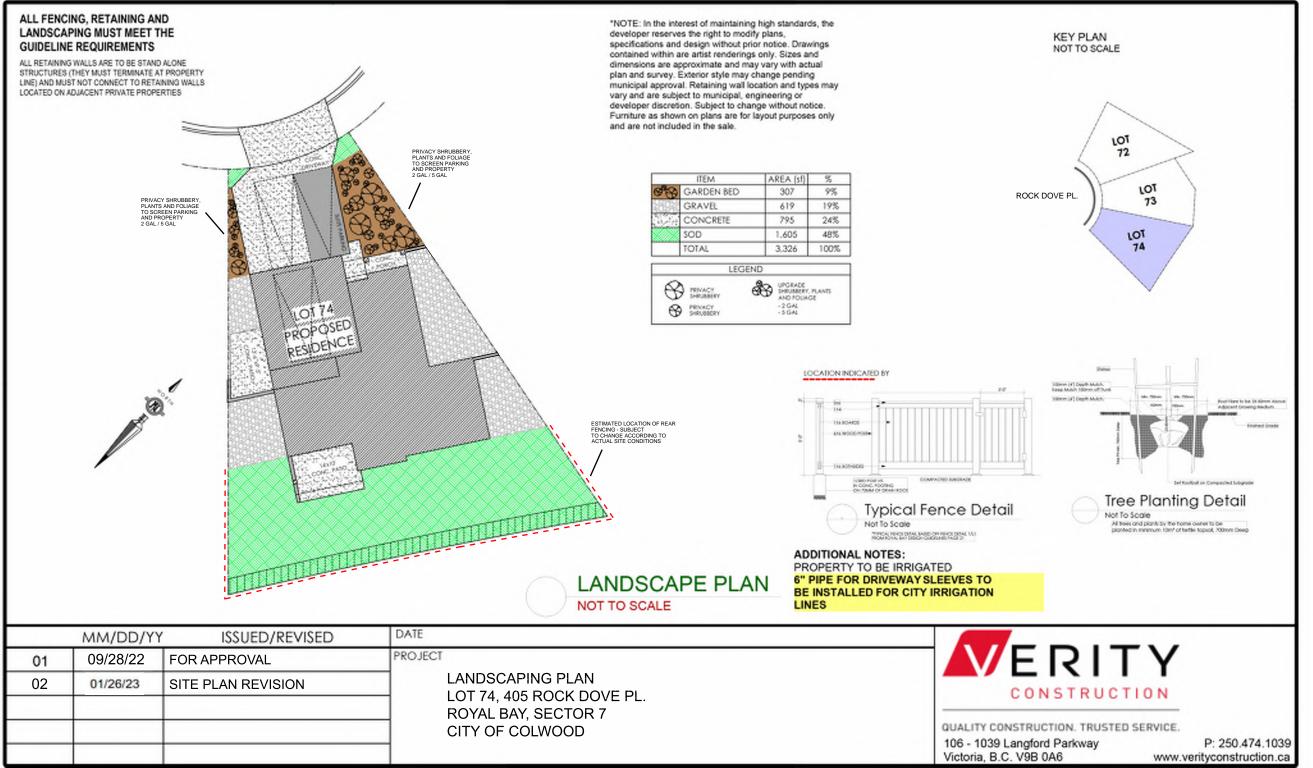

GABE? Craft HON7.29

BUILDING GRADE SLIP

Issue Date: _____

MUNICIPAL ADDRESS 405 Rock Dove Place	P.I.D.
LOT 74	PLAN
	SUBDIVISION ROYAL BAY SECTOR 7
ADDRESS	DEVELOPER MEADOWS DEVELOPMENT LP
REPRESENTATIVE PH.	CONSULTANT WSP CANADA INC
PROPOSED BUILDING GRADES ALL ELEVATIONS ARE METRIC GEODETIC + MAIN FLOOR ELEVATION	PLAN LOT: 74 PLAN:
WATER Image: Marking of the first of	ROAD A
COMMENTS YES NO	
DRAIN TO SUMP PUMP LIKELY REQUIRED (FOR BASEMENT IF INSTALLED)	
SEWER TO SUMP PUMP LIKELY REQUIRED (FOR BASEMENT IF INSTALLED) SERVICES INSTALLED TO m INSIDE PROPERTY FOUNDATION SOIL BEARING INVESTIGATION CERTIFICATION REQUIRED GEOTECHNICAL RESTRICTIONS APPLY (SEE GEOTECHNICAL RESTRICTIONS APPLY (SEE ENVIRONMENTAL RESTRICTIONS APPLY (SEE ENVIRONMENTAL REPORT) UTILITY EASEMENTS AFFECT THIS LOT UTILITY EASEMENTS AFFECT THIS LOT NOTES 1. IT IS THE RESPONSIBILITY OF THE BUILDER TO ENSURE THE FOOTINGS ARE PLACED ON A PROPER BASE THAT IS FREE FROM FROST, EXCESSIVE MOISTURE AND DELETERIOUS MATERIALS AND HAVE APPROPRIATE FROST PROTECTION WHEN COMPLETED. 2. THE INFORMATION CONTAINED HEREIN IS BASED ON THE APPROVED	LEGEND STREET
ADT GRADING PLAN FOR THIS SUBDIVISION. UN-AUTHORIZED DEVIATIONS WILL BE THE RESPONSIBILITY OF THE BUILDER TO ENSURE COMPLIANCE WITH ALL LOCAL BYLAWS. OTHER NOTES:	I, THE BUILDER'S REPRESENTATIVE, CERTIFY THAT THE FINAL HOUSE PLANS PROVIDED IN THE BUILDING PERMIT APPLICATION ARE THE SAME AS PROCESSED UNDER THIS GRADE SLIP AND THAT I UNDERSTAND THE INFORMATION AND THE REQUIREMENTS CONTAINED HEREIN AND WILL BUILD ACCORDINGLY. AUTHORIZED BUILDER'S REPRESENTATIVE DATE THE INFORMATION CONTAINED HEREIN IS BASED ON THE APPROVED
WSP - Wednesday, June 15, 2022 1:07 PM P:\2021\211-00627-00_ROYAL BAY - SECTOR 7\3_TECH\3_CADD\3_SHEETS\21	LOT GRADING PLAN FOR THIS SUBDIVISION, DATED