

CITY OF COLWOOD

3300 Wishart Road | Colwood | BC V9C 1R1 | 250-294-8153 planning@colwood.ca | www.colwood.ca

File: DP-22-023

DEVELOPMENT PERMIT DP-22-023

THIS PERMIT, issued April 4 2023 is,

ISSUED BY: CITY OF COLWOOD, a municipality incorporated under the Local Government Act, 3300 Wishart Road, Victoria, BC, V9C 1R1

(the "City")

PURSUANT TO: Section 490 of the Local Government Act, RSBC 2015, Chapter 1

ISSUED TO: Verity Construction Ltd 106-1039 Langford Parkway Victoria, BC V9B 0A6

(the "Permittee")

 This Form and Character Development Permit applies to those lands within the City of Colwood described below, and any and all buildings, structures, and other development thereon:

> Lots 47 – 48, PLAN EPP117070 SECTION 38 ESQUIMALT 3467 & 3469 Trumpeter Street (the "Lands")

- This Development Permit regulates the development and alterations of the Land, and supplements the "Colwood Land Use Bylaw, 1989" (Bylaw No. 151), to ensure the form & character considerations for 2 single family homes with secondary suites and associated site improvements are consistent with the guidelines for areas designated as "Neighbourhood – Intensive Residential" in the City of Colwood Official Community Plan (Bylaw No. 1700).
- 3. This Development Permit is NOT a Building Permit or a subdivision approval.
- This Development Permit is issued subject to compliance with all of the bylaws of the City of Colwood that apply to the development of the Lands, except as specifically varied by Council or supplemented by this Permit, including DP-21-008.
- 5. The Director of Development Services or their delegate may approve minor variations to the schedules attached to and forming part of this Development Permit, provided that such minor variations are consistent with the overall intent of the original plans and do not alter the form and character of the development authorized by those plans.

DEVELOPMENT PERMIT DP-22-023_3467 & 3469 Trumpeter St

- If the Permittee does not substantially start the construction permitted by this Permit within 24 months of the date of this Permit, the Permit shall lapse and be of no further force and effect.
- The development is to be constructed in accordance with the following plans and specifications, which are attached to and form as part of this permit:
 - Schedule 1 Site Plan, Architectural Drawings, Coloured Elevation Drawings, Landscape Plan, Parking Plan and Secondary Suite Landscape Plan for 3467 Trumpeter Street dated December 19th, 2022.
 - Schedule 2 Site Plan, Architectural Drawings, Coloured Elevation Drawings, Landscape Plan, Parking Plan and Secondary Suite Landscape Plan for 3469 Trumpeter Street dated December 22nd, 2022.
- 8. This Development Permit authorizes land alertations for the construction of 2 single family homes with secondary suites along with any associated site works. The Land shall not be altered, nor any buildings or structures constructed, except in accordance with the following conditions:

FORM AND CHARACTER CONDITIONS

General

8.1. The form and character of the buildings to be constructed on the Lands shall conform to the drawings attached to this permit as schedules.

Building Features

- 8.2. The form and character of the buildings to be constructed on the Lands shall conform to the Site Plan, Architectural Drawings and Elevation Drawings prepared by Victoria Design Group (Schedules 1-2).
- 8.3. Within any group of three adjacent homes on the lands, no two houses shall have the same dwelling unit design.
- 8.4. Any future additions of telecommunications antennas or equipment to the exterior of the buildings and/or structures included in this Permit shall be architecturally integrated into the buildings and/or structures they are mounted on or screened from views so as not to be visually obtrusive, to the satisfaction of the Director of Development Services.
- 8.5. No future construction/installation of unenclosed or enclosed outdoor storage areas, and recycling/refuse collection and storage areas shall be undertaken without the issuance of a further Development Permit or amendment to this Permit.
- 8.6. All mechanical roof elements, including mechanical equipment, elevator housings, and vents shall be visually screened with sloped roofs or parapets, or other forms of solid screening to the satisfaction of the Director of Development Services.

Landscaping

8.7. The design and construction of the proposed landscaping shall be in substantial compliance with the Landscape Plan prepared by Verity Construction (Schedules 1-2).

DEVELOPMENT PERMIT DP-22-023_3467 & 3469 Trumpeter St

Stormwater Management

 Issuance of a Building Permit is subject to the City of Colwood's approval of a site specific stormwater management plan.

Grading


 Lot preparations shall be in compliance with the site-specific grading plan by Gablecraft Homes as part of Schedules 1-2.


8.10. The geotechnical conditions are subject to all conditions outlined in covenant CA9828107.

ISSUED ON THIS TO DAY OF APRIL, 2023.


Yazmin Hernandez Director of Development Services

SITE DATA	RBCD5	LOT 47
ITEMS	PERMITTED	PROPOSED
LOT AREA	368 sq.m.	371.24 sq.m.
LOT COVERAGE	50.00 %	42.25 %
BUILDING HEIGHT	9.50 m.	6.50 m.
LOT WIDTH	10.97 m.	11.16 m.
Setbacks		
- FRONT	3.00 m.	5.44 m.
- FRONT (GARAGE)	6.00 m.	8.81 m.
- REAR	6.00 m.	6.00 m.
- RIGHT SIDE	1.20 m.	1.26 m.
- LEFT SIDE	1.20 m.	1.20 m.
PROPOSED FLOOR AREA		
- MAIN		138.12 sq.m.
- LOWER		108.80 sq.m.
- GARAGE		41.90 sq.m.
SUB-TOTAL G.F.A.		288.82 sq.m.
GARAGE ALLOWANCE	50.00 sq.m.	-41.90 sq.m.
GROSS FLOOR AREA		246.92 sq.m.
F.A.R.		0.67 TO 1.0
SECONDARY SUITE		
FLOOR AREA (%)	40.00 %	32.40 %
FLOOR AREA (SQ.M.)	90.00 sq.m.	80.01 sq.m.

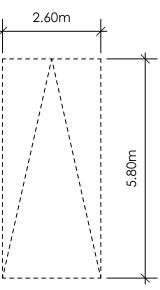

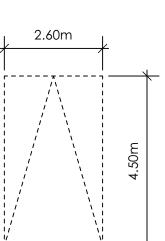

SMALL CAR PARKING STALL DIMENSIONS

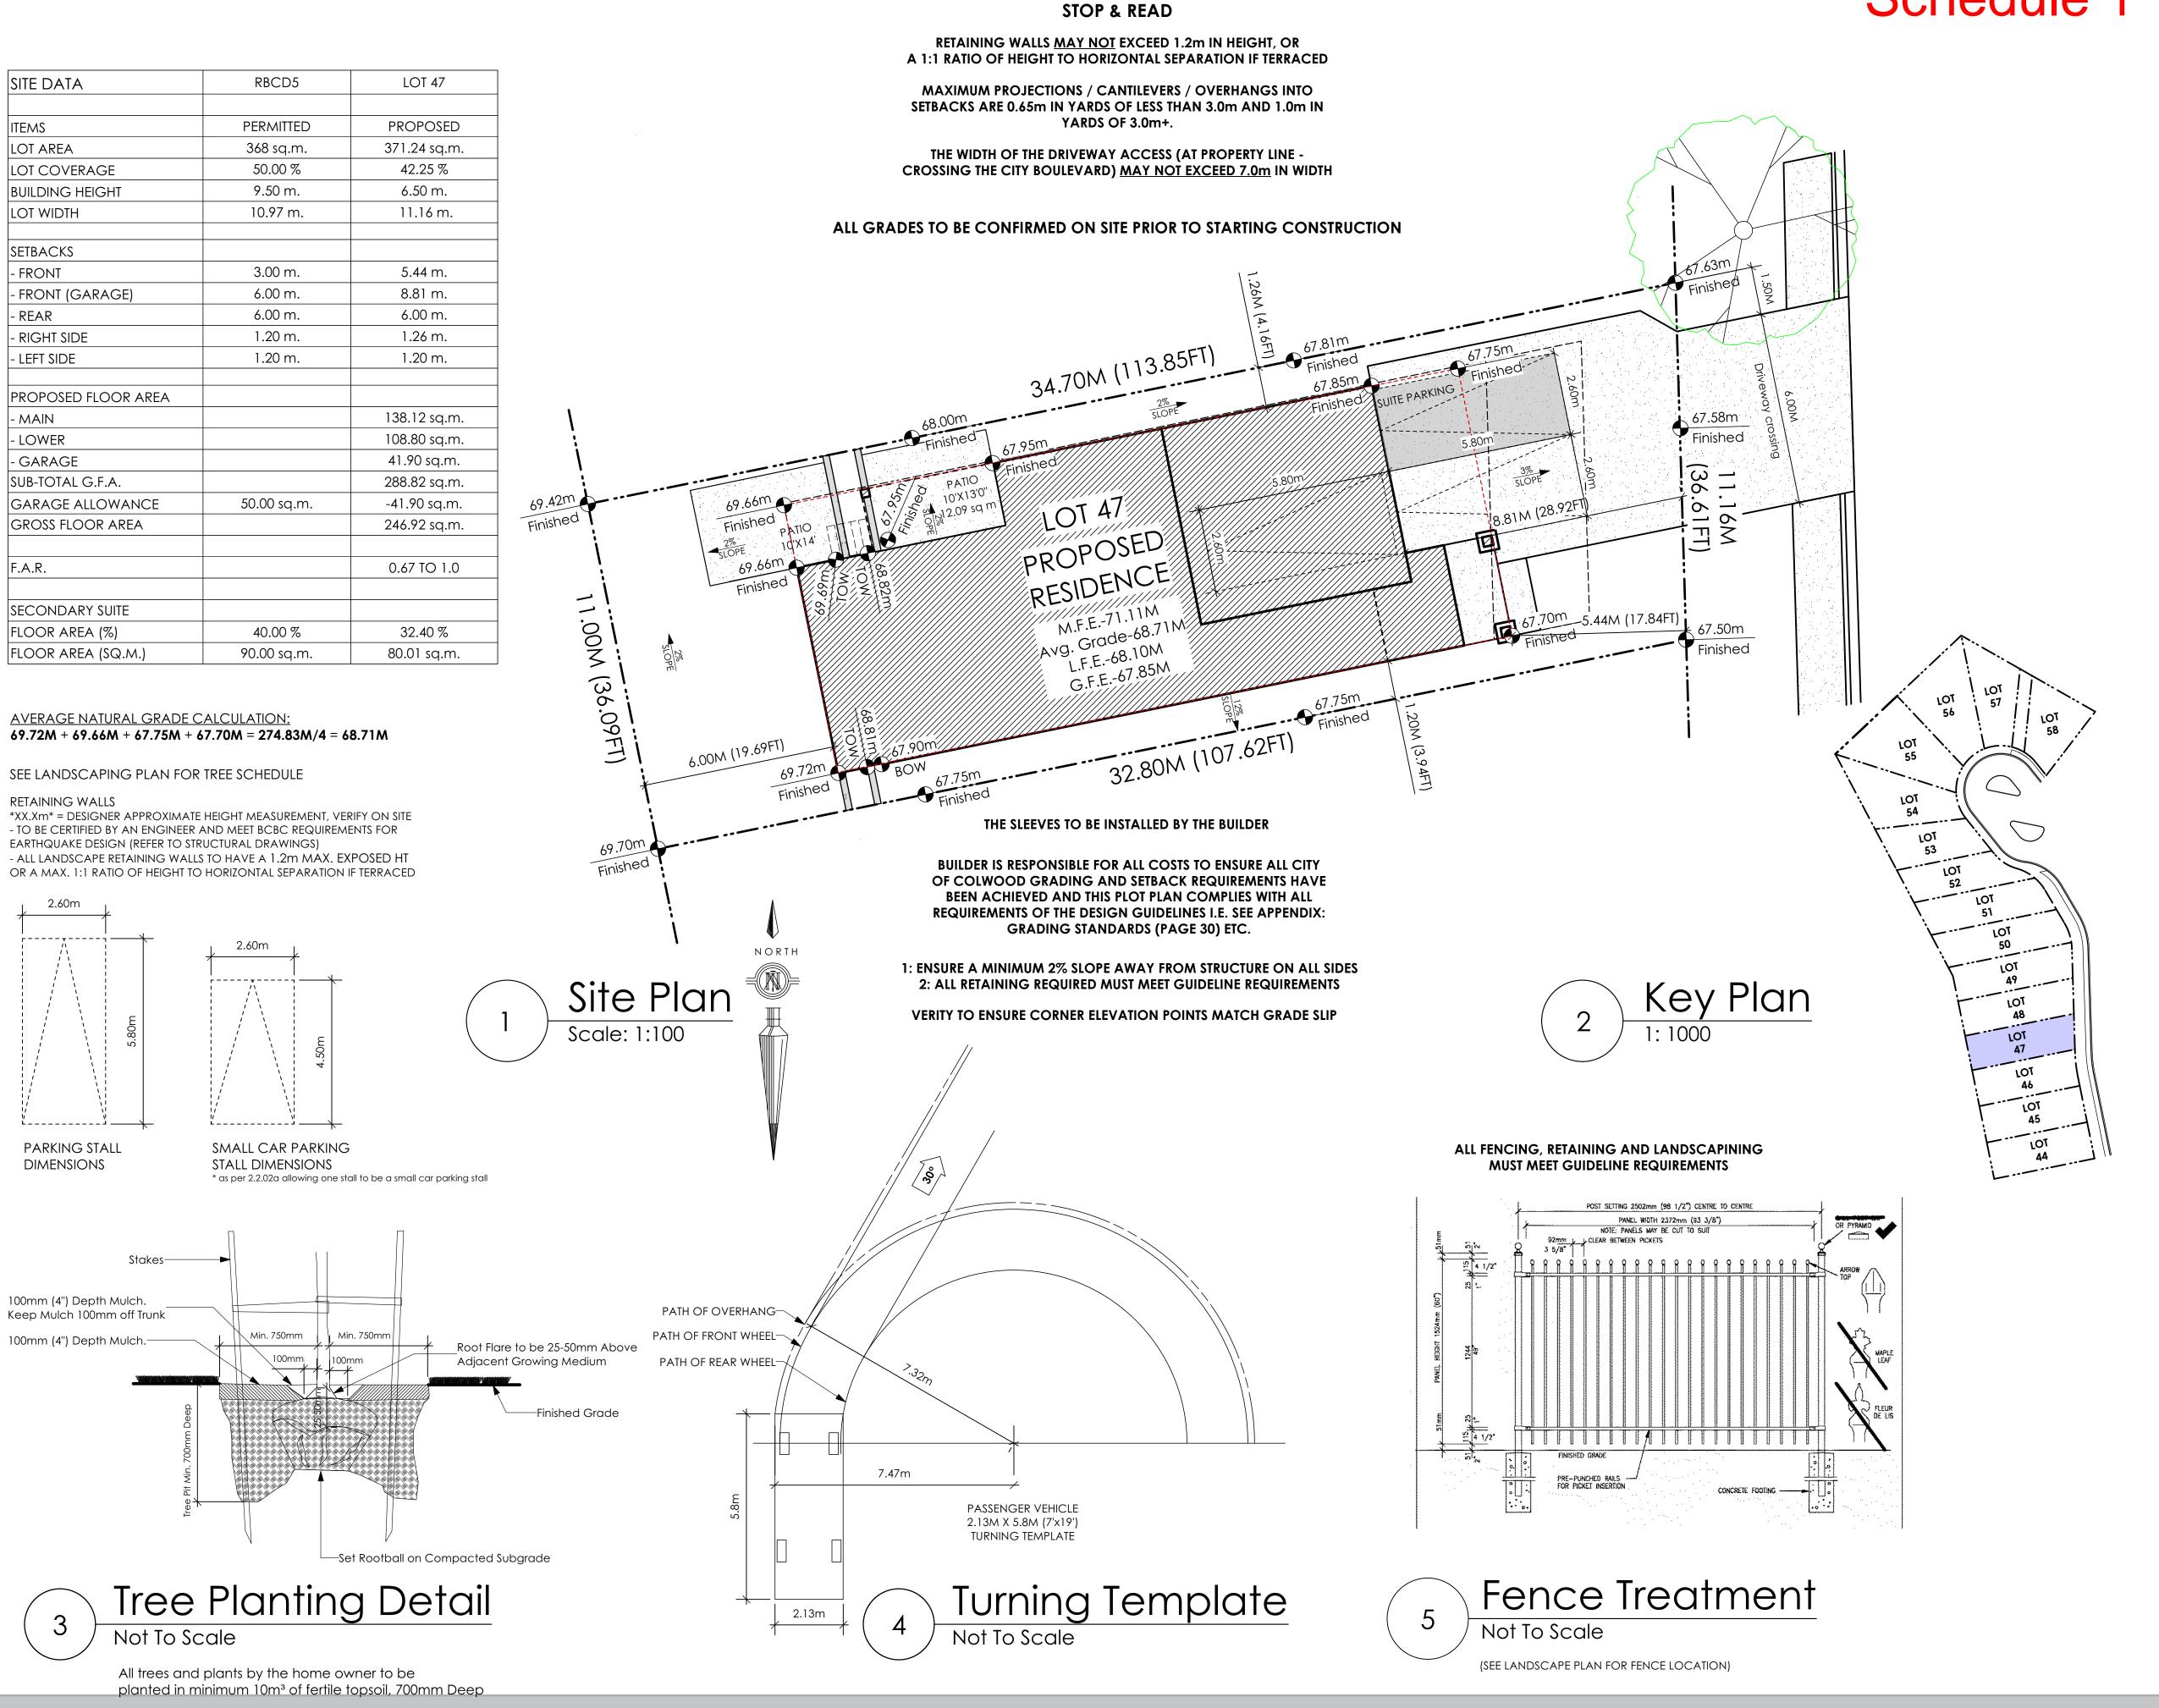

Development Permit Presentation





#103 - 891ATTREE AVENUE VICTORIA, B.C. V9B 0A6 P. 250.382.7374 F. 250.382.7364

'PORT' - TRADITIONAL

Date Dec 19 2022


Project Address 3467 Trumpeter Street Royal Bay - Sector 7 Colwood, B.C.

Prepared for Verity Construction


> Project # 8298

Scale As Noted

Drawn By MRB

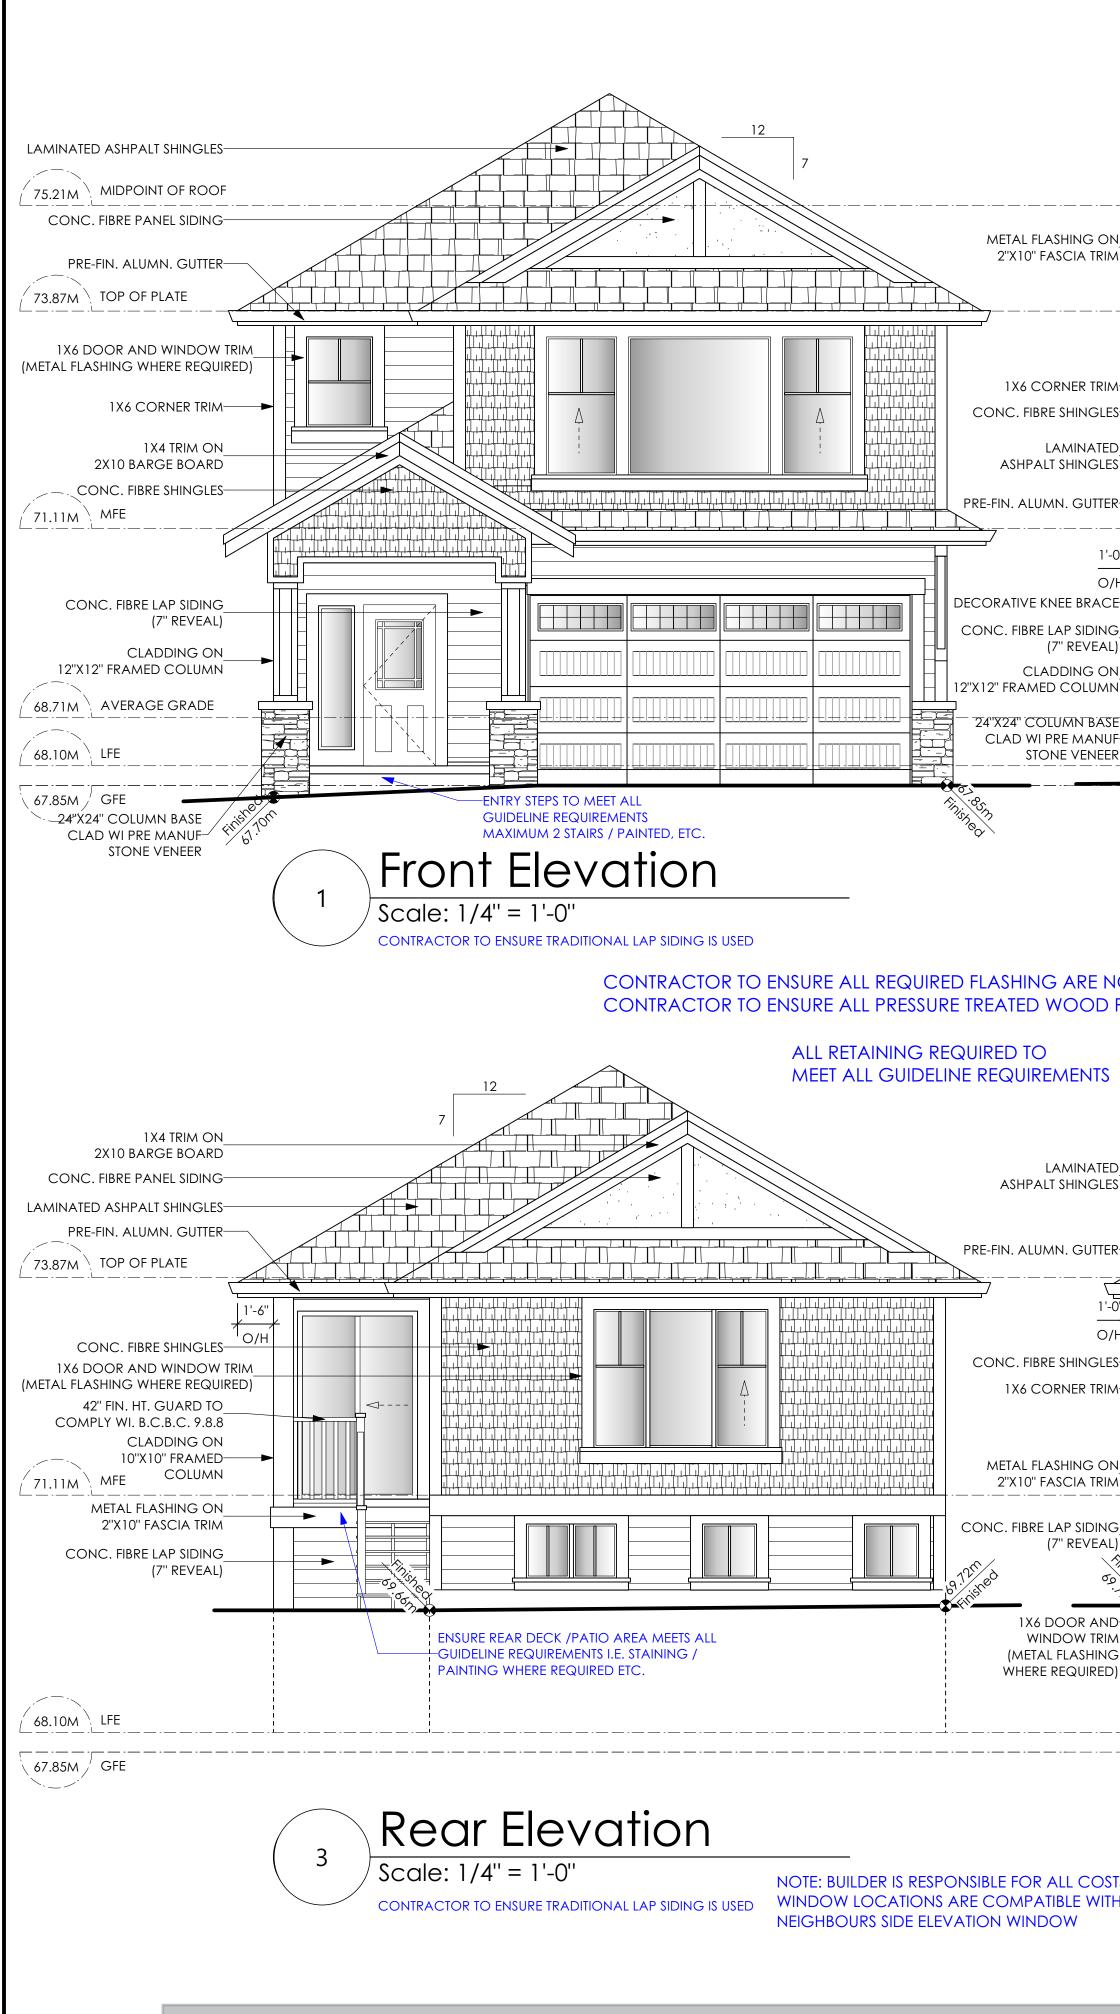

2 Right Side Elevation 2 Scale: 1/4" = 1'-0" CONTRACTOR TO ENSURE TRADITIONAL LAP SIDING IS USED	LIMITING DISTANCE 1.26 N EXPOSED BUILDING FACE 111.82 SG ALLOWABLE OPENINGS 7.00 % ALLOWABLE OPENING AREA 7.83 SG	Q.M. Q.M. Q.M.
PRODUCTS MEETS ALL GUIDELINES		
0.98m 0.98m Units to Ensure Side H THE ADJACENT Left Side Elevation Scale: 1/4" = 1'-0" CONTRACTOR TO ENSURE TRADITIONAL LAP SIDING IS USED	EXPOSED BUILDING FACE117.41ALLOWABLE OPENINGS7.0ALLOWABLE OPENING AREA8.22	M. SQ.M. % SQ.M. SQ.M.

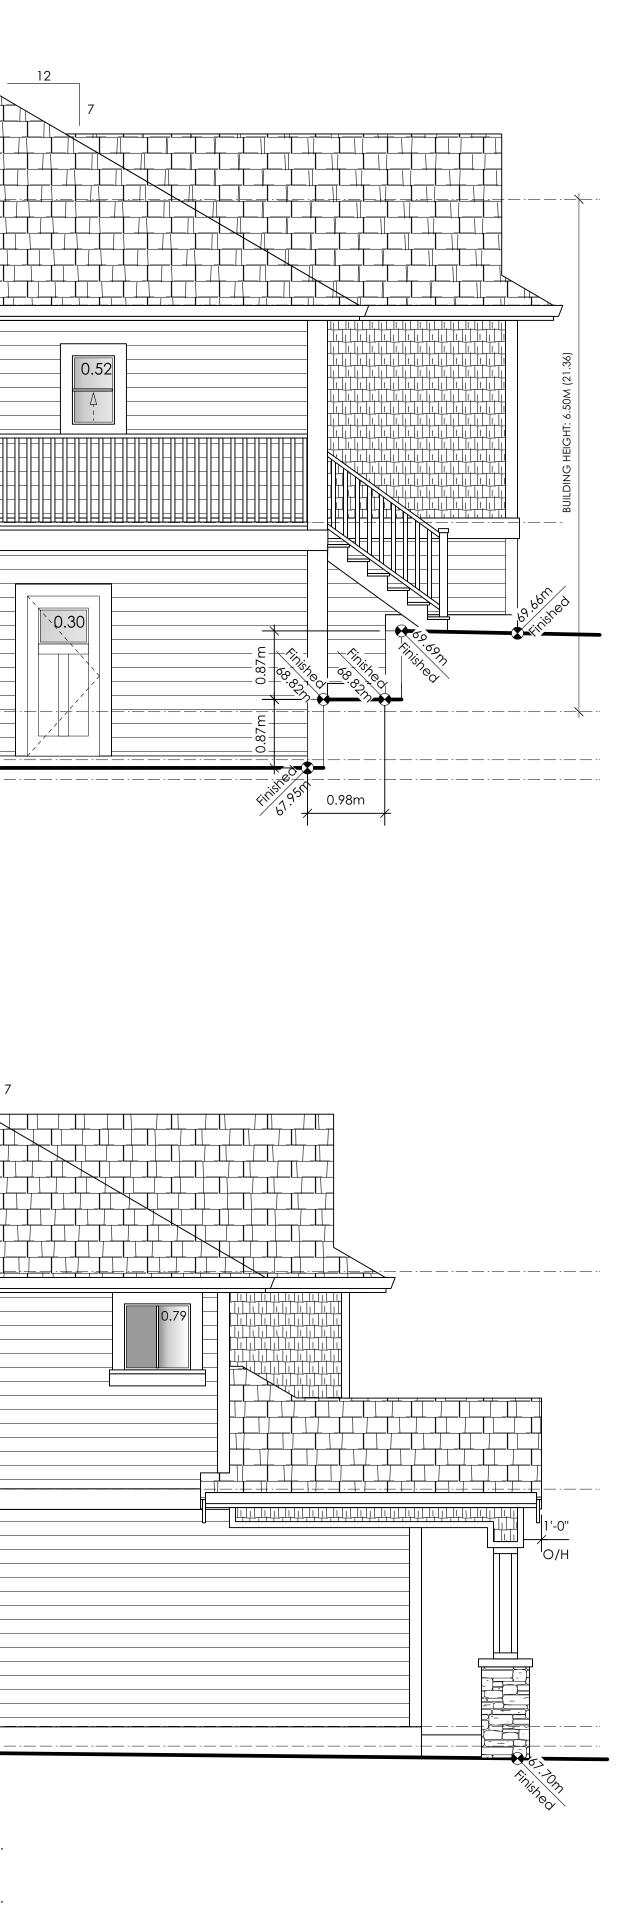

'd Victoria 9 design group

#103 - 891ATTREE AVENUE VICTORIA, B.C. V9B 0A6 P. 250.382.7374 F. 250.382.7364

'PORT' - TRADITIONAL

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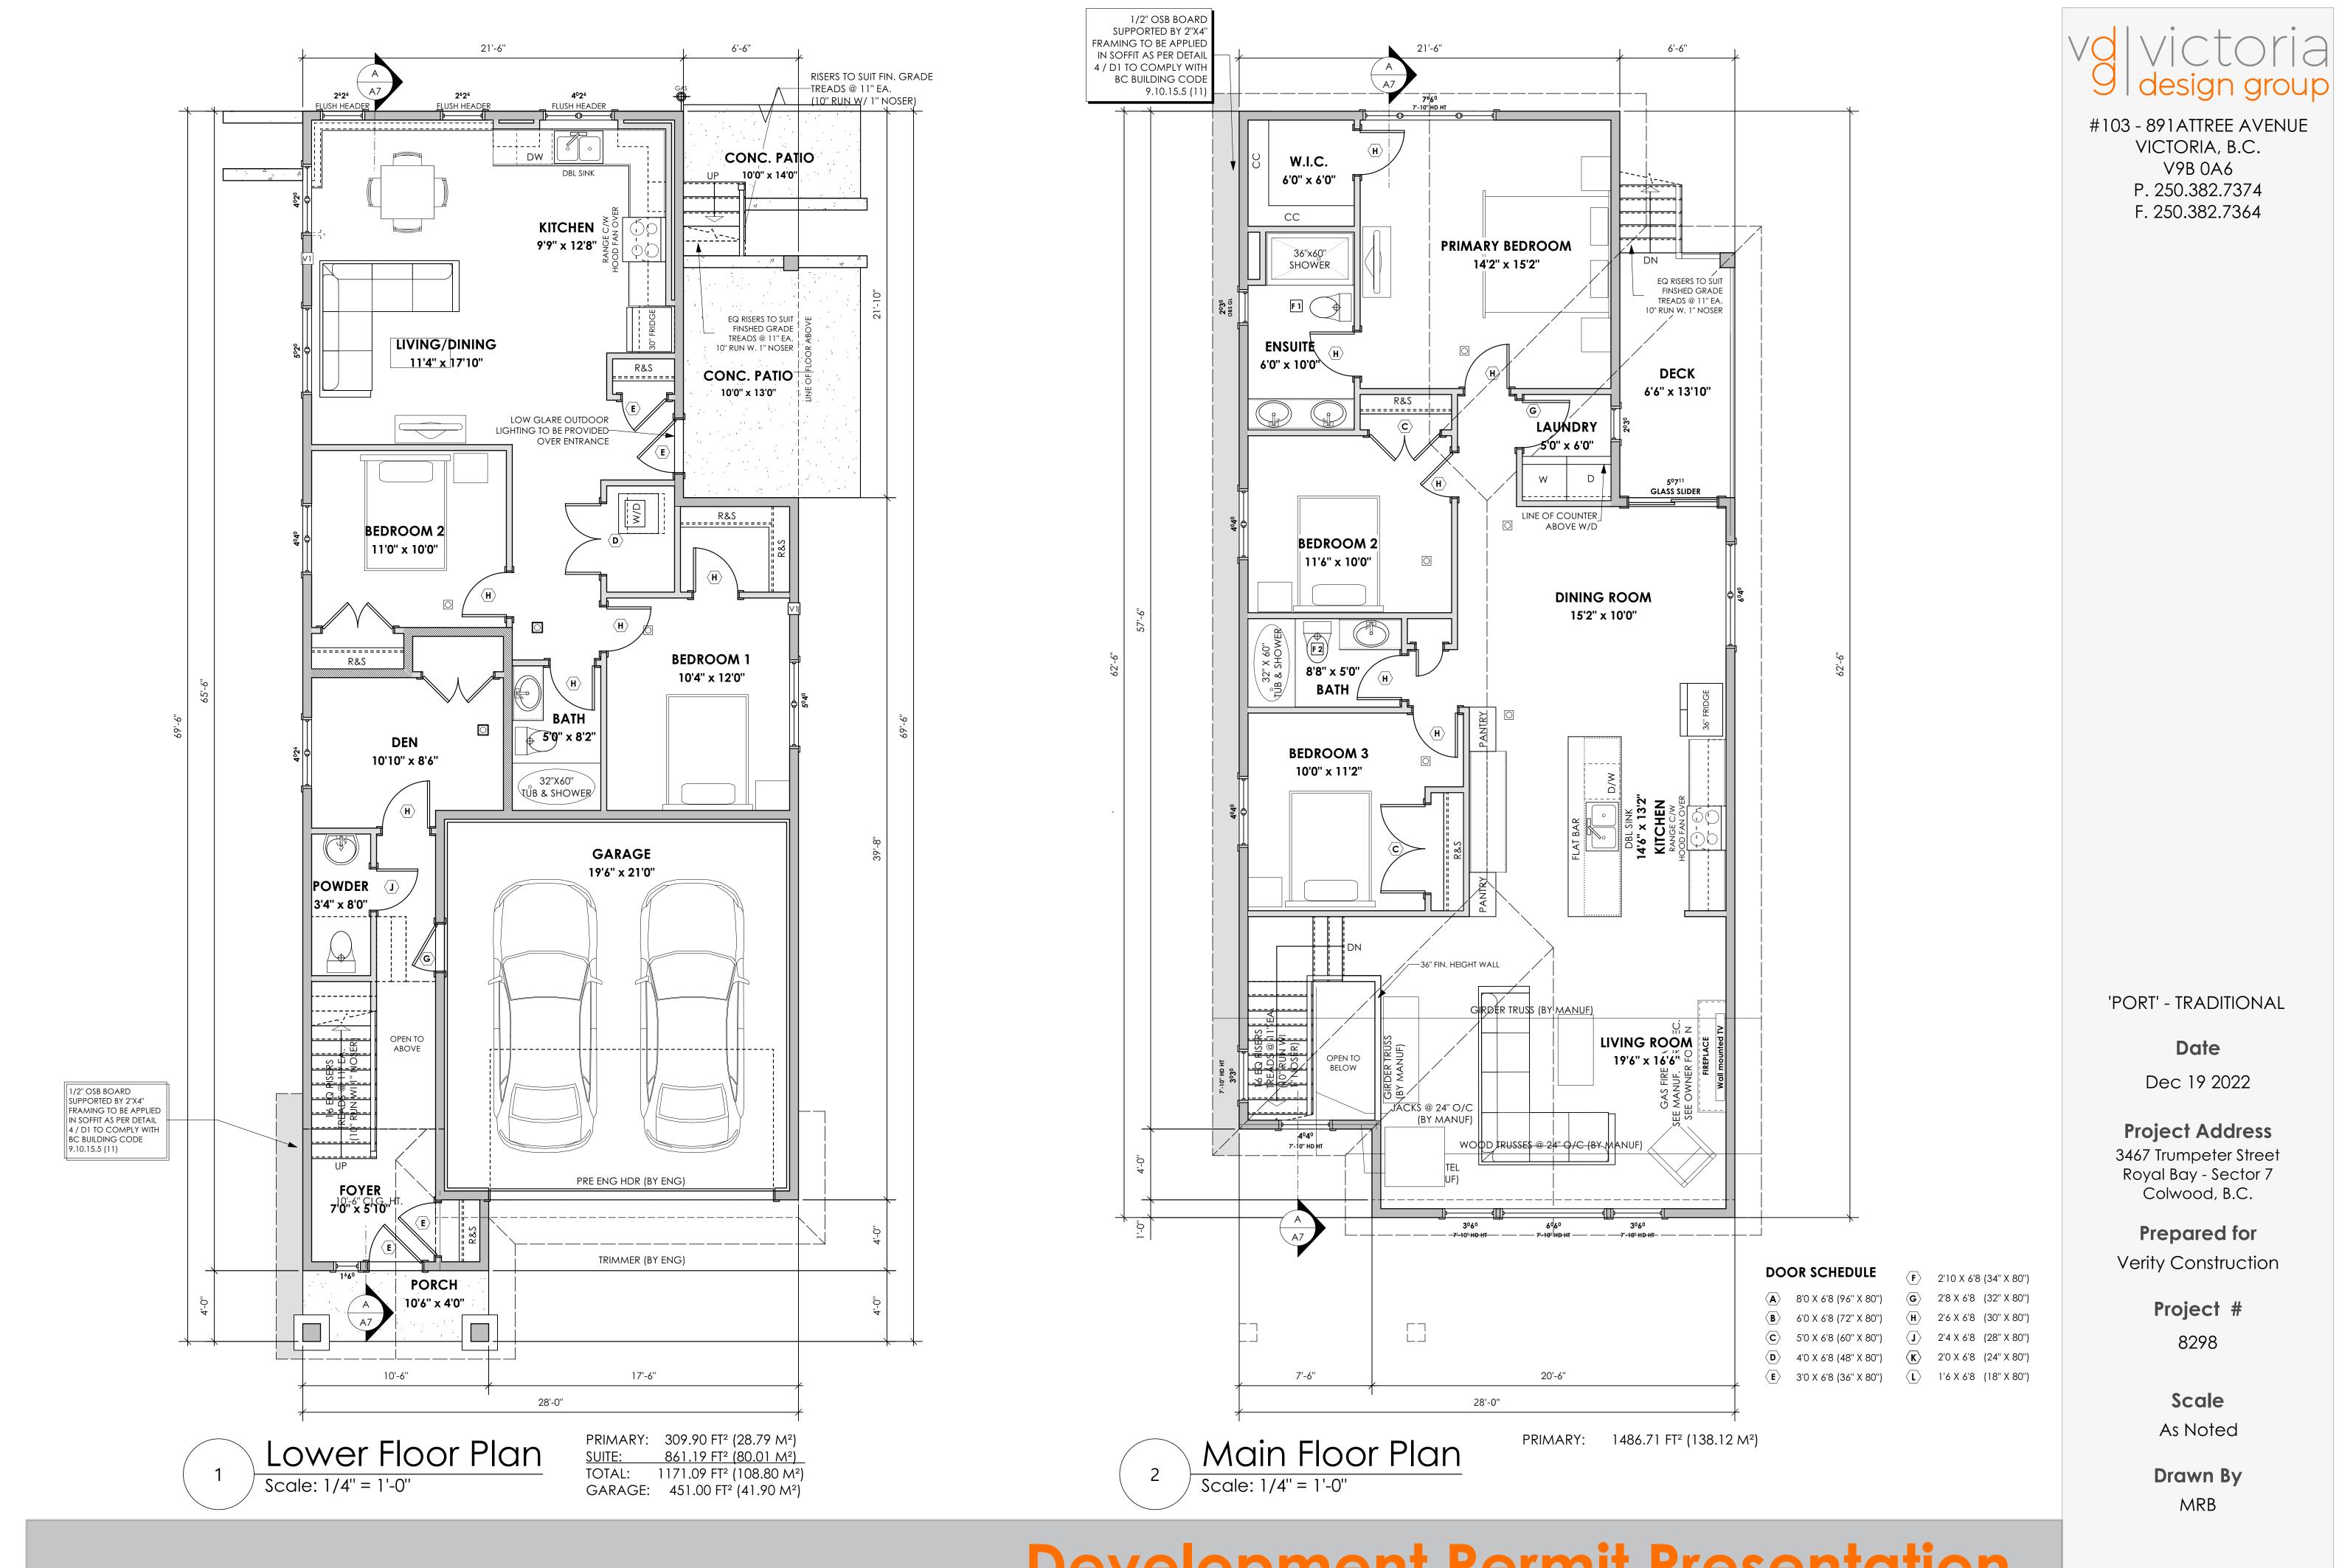
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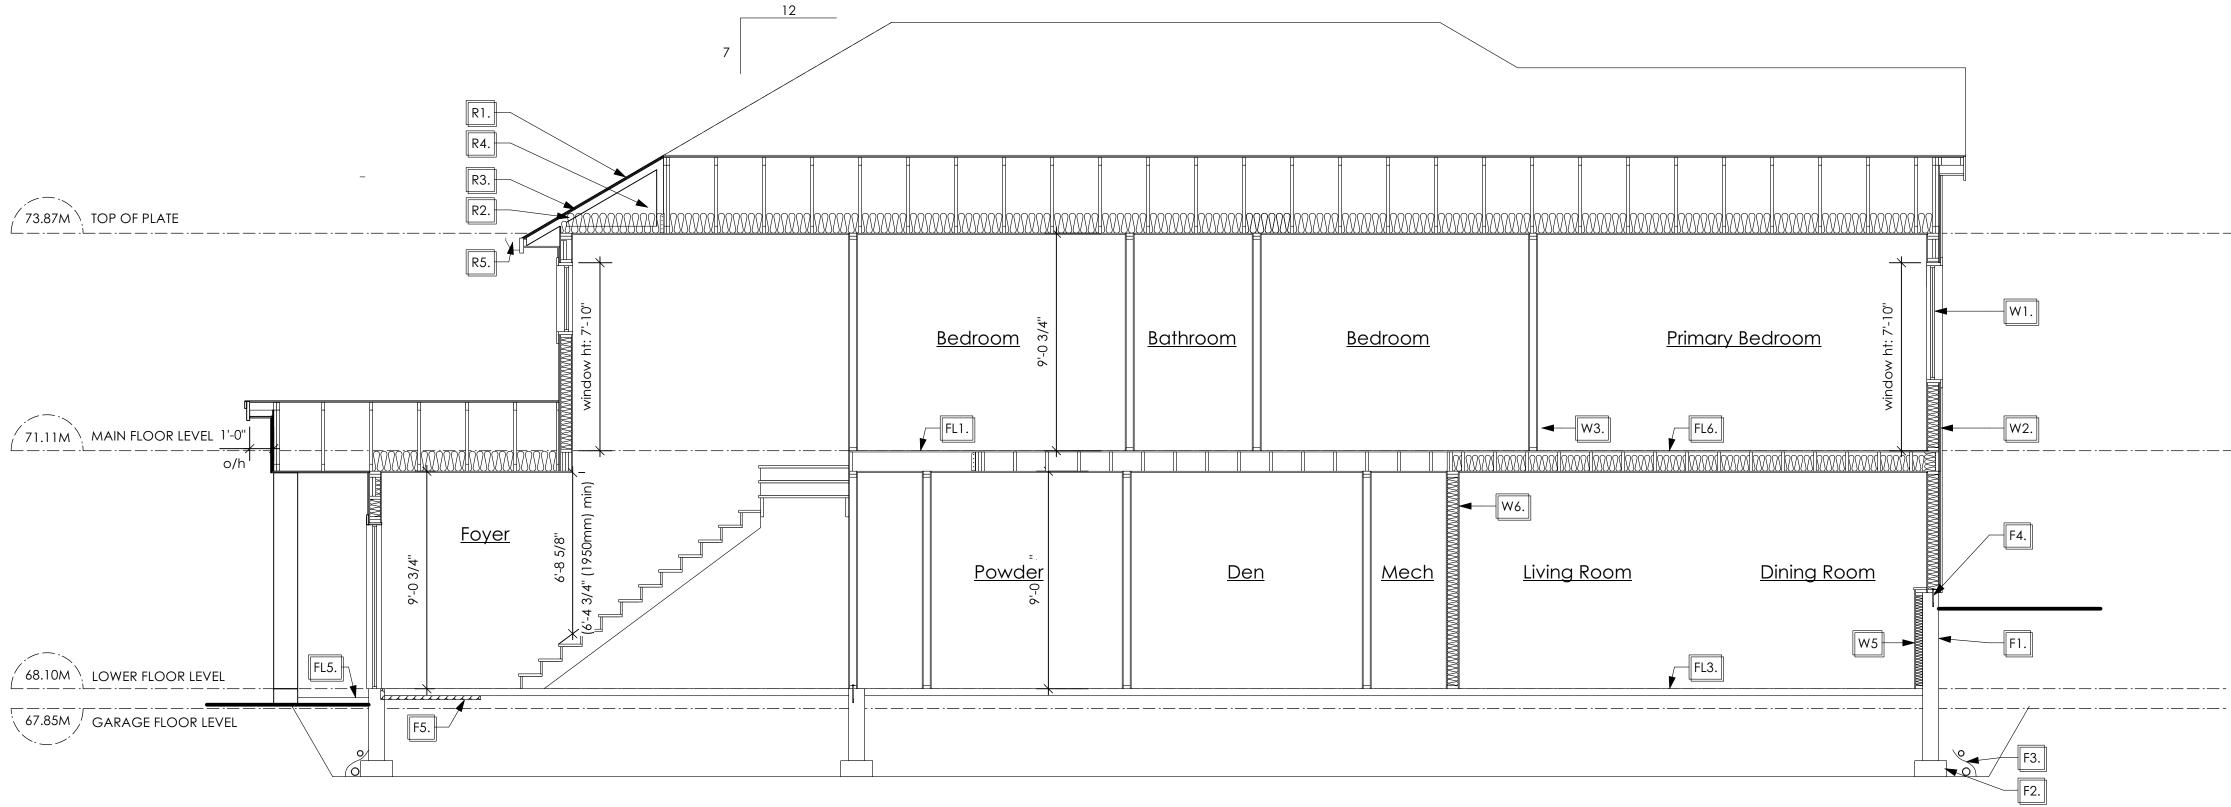
Prepared for Verity Construction

Project # 8298

Scale As Noted

Drawn By MRB







Roofs

- R1. LAMINATED ASPHALT SHINGLES ON 7/16" ORIENTED STRAND BOARD C/W "H" CLIPS WD TRUSSES (DESIGNED BY MANUF.) 14 1/2" FIBRE GLASS LOOSE FILL INSULATION (ALLOW FOR SETTLING) OR R-40 FIBRE GLASS BATT INSULATION 6 MIL POLY'N V.B. 5/8" GYPSUM BOARD
- R2. PROVIDE 2 1/2" (63mm) CLEAR BETWEEN R-20 INSULATION AND SHEATHING. (min. R-20 @ roof-wall connection for 4'-0" (1.2m) around perimeter of building. air ventelation baffles to be installed where required in as per BCBC 9.19.)
- EAVE PROTECTION R3. CONT. UP ROOF SLOPE FOR 12" PAST EXTERIOR WALL.
- R4. PROVIDE 1 SQ.FT. ATTIC VENT PER 300 SQ.FT. OF INSULATED AREA MIN. 25% OF REQUIREDTO BE @ TOP AND BOTTOM (to comply wi. B.C. bldg. code 9.19.1)
- R5. PRE-FN. FASCIA GUTTER 2×8 FASCIA BD. 2×4 SUB. FASCIA BD. VENTED SOFFIT (see contractor)

R6. PRE MANUF SOFFIT 1/2" OSB BOARD SUPPORTED BY 2"X4" FRAMING REFER TO DETAIL 4 / D1 (to be applied in any soffit that has less then 1.20m clearance to any proverty line. To comply with BC BUILDING CODE 9.10.15.5 (11)) (AS REQUIRED, VERIFY ON SITE) (NOT SHOWN IN SECTION)

Floors

	19/32" ((NAILEE 2×10 FL C/W 2× 1/2" GY
FL2.	FINISHEI 19/32" ((NAILEE 2×10 FL C/W 2× R-31 FIB 5/8" X-T (BETWEI (NOT SH
FL3.	3 1/2" C 6 MIL. P 6" CON
FL4.	3 1/2" C 6 MIL. P 6" CON SLOPE T (NOT SH
FL5.	3 1/2" C (CONTR EXTERIC

FL6. F8d RATED CEILING ASSEMBLY (BC BUILDING CODE TABLE 9.10.3.1.B) FINISHED FLOORING ON 19/32" ORIENTED STRAND BOARD OR EQ. (FASTENED & GLUED TO FLOOR STRUCT. BELOW) ON 2×10 FLOOR JOISTS @ 16" OR 12" O/C C/W 2×2 X-BRIDGING @ 7.0' O/C (MAX) **R-31 INSULATION** RESILIENT METAL CHANNELS @ 24" O/C 1 LAYERS 5/8" X-TYPE GYPSUM BOARD 30 MINUTE F.R.R., 50 S.T.C.

SECTION NOTES

FL1. FINISHED FLOORING ON 19/32" ORIENTED STRAND BOARD OR EQUAL ED & GLUED TO FLOOR STRUCT. BELOW) ON

LOOR JOISTS @ 16" OR 12" O/C ×2 X-BRIDGING @ 7.0' O/C (MAX) YPSUM BOARD

ED FLOORING ON ORIENTED STRAND BOARD OR EQUAL D & GLUED TO FLOOR STRUCT. BELOW) ON

LOOR JOISTS @ 16" OR 12" O/C ×2 X-BRIDGING @ 7.0' O/C (MAX) BRE GLASS BATT INSULATION

type gypsum board EEN GARAGE AND LIVING SPACE) HOWN IN SECTION)

CONCRETE SLAB POLY'N V.B.

MPACTED GRAVEL OR SAND

CONCRETE SLAB POLY'N V.B. MPACTED GRAVEL OR SAND TO DOORS 1" HOWN IN SECTION)

CONCRETE SLAB

TRACTOR TO VERIFY EXTENT OF OR SLABS AND FINISHES) (SLOPE AWAY FROM BUILDING @ 2% MIN.) 6" COMPACTED GRAVEL OR SAND

Walls

W1. DOUBLE GLAZING ENERGY STAR LOW "E" RATING IN THERMAL BREAK FRAMES 2/2"X10" LINTEL OVER (@ BEARING WALLS ONLY) (TYPICAL, WI. 2 1/2" XPS INSULATION) FLASHING OVER @ EXTERIOR (GLAZING IN ALL EXTERIOR DOORS & WITHIN 3 FT. OF EXTERIOR DOORS TO BE SHATTERPROOF (SP)) WINDOW REQUIREMENTS DERIVED FROM BCBC TABLE C-5 AS PER BCBC 9.7.4.3. AND ARE TO BE USED TO SATISFY THE REQUIREMENTS OF AAMA/WDMA/CSA 101/I.S.2/A440, "NAFS": COLWOOD, CLASS R, DP 1440, PG 30, WATER RESIST. 220, A2, RATINGS MUST BE CLEARLY LABELED ON ALL WINDOW UNITS UPON INSTALLATION FOR INSPECTION. W2. CONC. FIBRE BOARD ON 9.5MM (3/8") AIR SPACE / STRAPPING 3/8"×2" BORATE TREATED PLYWOOD STRAPPING

STRUCTURAL WOOD ELEMENTS WITHIN 150MM (6") FROM FINISHED GROUND LEVEL SHALL BE PRESSURE TREATED WITH

PROTECTION B.C.B.C. 2012 9.3.2.9.(3)

A PRESERVATIVE FOR TERMITE AND DECAY

- HOUSE WRAP (A.B.) (TYVEK OR EQ.) 7/16" ORIENTED STRAND BOARD SHEATHING 2×6 STUDS (SEE APCING BELOW) **R-20 INSULATION** 6 MIL. POLYETHYLENE VAPOUR BARRIER 1/2" GYPSUM BOARD (REFER TO DETAILS ON D1)
- W3. INTERIOR PARTITION 1/2" GYPSUM BOARD ON EACH SIDE OF 2×4 STUDS (SEE SPACING BELOW) OR 2×6 STUDS (SEE SPACING BELOW) (IF NOTED)

W4.	5/8" X-TYPE GYPSUM BOARD ON 2×6 STUDS (SEE SPACING BELOW) R-20 INSULATION	F1.	DAMP 8" THK. C/W 1
	6 MIL. POLY'N V.B 1/2" GYPSUM BOARD (BETWEEN GARAGE & LIVING) (NOT SHOWN IN SECTION)	F2.	16"X 8" C/W 2 ON UN
W5.		F3.	4" PERI 3" TIGH DRAIN
	OR 2x6 STUDS (SEE SPACING BELOW) (IF NOTED) R-12 BATT INSULATION HOUSE WRAP (A.B.) (TYVEK OR EQ.) OR	F4.	ANCH c/w SII
	12.7MM (1/2") AIR SPACE (PROVIDE REQUIRED FIRE STOPS IN WALL ASSEMBLIES TO COMPLY WITH B.C. BLDG. CODE 9.10.16.)	F5.	UNDER 2 1/2" RIGID I CONT.
W6.	B.C. BUILDING CODE (TABLE 9.10.3.1.A) RATED WALL ASSEMBLY W3C 1 LAYER 1/2" X-TYPE GYPSUM BOARD RESILIENT METAL CHANNELS @ 24" O/C 2×4 STUDS @ 16" O/C OR 2×6 STUDS @ 16" O/C (IF NOTED) C/W 3 1/2" FIBRE GLASS SOUND BATTS 1 LAYER 1/2" X-TYPE GYPSUM BOARD 45 MIN. F.R.R 43 S.T.C (BETWEEM PRIMARY LIVING & SECONDARY SUITE)		SLAB IN (VERIF)
W7.	STUD SPACING		

STUD SPACING	
- UPPER FLOOR:	2"X6" @ 24" O/C
- MAIN FLOOR:	2"X6" @ 24" O/C
- LOWER FLOOR:	2"X6" @ 16" O/C
(if applicable)	
- INTERIOR PARTITION:	2"X4"" @ 24" O/C
- LOAD BEARING:	2"X4"" @ 16" O/C
- PARTY WALL	2''X4'''' @ 24'' O/C
(if applicable)	

N ROCK

CHOR BOLTS @ 4.0 FT. o/c MAX SILL GASKETS

DER SLAB INSULATION (RSI 2.15) EXTRUDED POLYSTYRENE INSULATION 4'-0" (1.2M) T. AROUND PERIMETER UNDER INSTALLED HORIZONTALLY

RIFY WITH MUNICIPALITY DEPTH OF FROST LINE)

Development Permit Presentation

aesign group

#103 - 891ATTREE AVENUE VICTORIA, B.C. V9B 0A6 P. 250.382.7374 F. 250.382.7364

Foundation Walls

DAMPROOFING (where required) ON . CONC. FOUNDATION WALL 15 M BARS @ 24" o/c B/W 8" CONC. FOOTINGS 2 (TWO) 15m BARS CONT. 3 IN. FROM BOTT. INDISTURBED SOIL (SOLID BEARING)

RIMETER DRAIN GHT PIPE FOR RWL

'PORT' - TRADITIONAL

Date Dec 19 2022

Project Address 3467 Trumpeter Street Royal Bay - Sector 7 Colwood, B.C.

Prepared for Verity Construction

> Project # 8298

Scale As Noted


Drawn By MRB


ALL FENCING, RETAINING AND LANDSCAPING MUST MEET THE GUIDELINE REQUIREMENTS

ALL RETAINING WALLS ARE TO BE STAND ALONE STRUCTURES (THEY MUST TERMINATE AT PROPERTY LINE) AND MUST NOT CONNECT TO RETAINING WALLS LOCATED ON ADJACENT PRIVATE PROPERTIES

"NOTE: In the interest of maintaining high standards, the developer reserves the right to modify plans, specifications and design without prior notice. Drawings contained within are artist renderings only. Sizes and dimensions are approximate and may vary with actual plan and survey. Exterior style may change pending municipal approval. Retaining wall location and types may vary and are subject to municipal, engineering or developer discretion. Subject to change without notice. Furniture as shown on plans are for layout purposes only and are not included in the sale.

KEY PLAN NOT TO SCALE

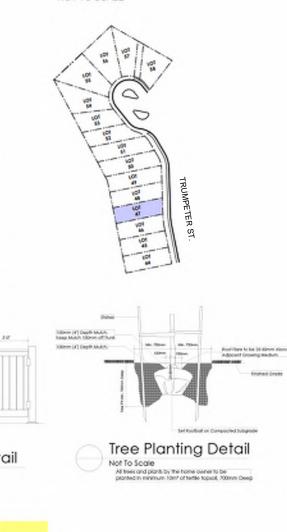

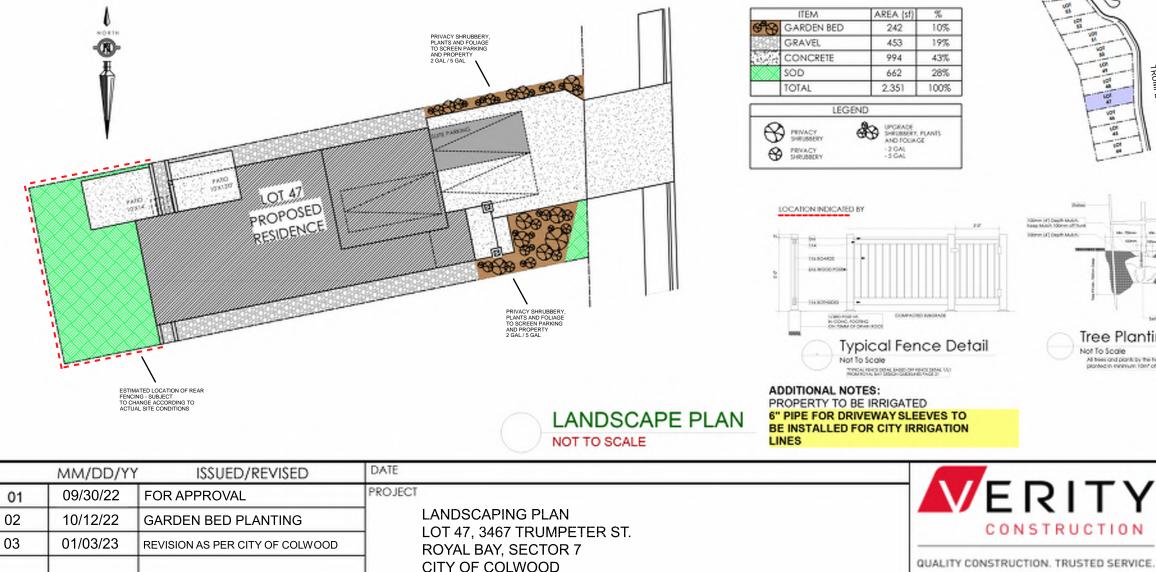

QUALITY CONSTRUCTION. TRUSTED SERVICE. 106 - 1039 Langford Parkway

CONSTRUCTION

Victoria, B.C. V9B 0A6

P: 250.474.1039 www.verityconstruction.ca

GABLECRAFT HOMES BUILDING GRADE SLIP

WSP Project No: <u>201-08151-00</u>

Issue Date: _____

MUNICIPAL ADDRESS 3467 Trumpeter Street	P.I.D.
LOT 47	PLAN
	SUBDIVISION ROYAL BAY SECTOR 7
ADDRESS	DEVELOPER MEADOWS DEVELOPMENT LP
REPRESENTATIVE PH.	CONSULTANT WSP CANADA INC
PROPOSED BUILDING GRADES	PLAN
ALL ELEVATIONS ARE METRIC GEODETIC +	LOT: <u>47</u> PLAN: TRUMPETER ST.
(TOP OF JOISTS) JOIST	
(FINISHED GRADE) (FINISHED GRADE)	
FINISHED GRADE AT GARAGE 67.85	
HEADROOM	67.58
ACTUAL TOP OF FOOTING	18 47 80 10 19 EG 67.0 10 10 18 MFE 68.24 80 80
LOWEST PERMITTED TOP OF <u>not provided</u> <u>FLOOR SLAB</u> FOOTING ELEVATION (LTF) (BOTTOM OF BASEMENT SLAB	
FROST WALLS ARE REQUIRED.)	MSE 64.49 S 64.41 D 64.47 LB
SERVICES FRONT REAR CENTER REFER SIZE TO PLAN (mm)	
WATER	9800 ¥
SANITARY	
STORM STORM	<u>9.4</u> <u>69.4</u> <u>69.7</u>
COMMENTS YES NO	nnn
DRAIN TO SUMP PUMP LIKELY REQUIRED (FOR BASEMENT IF INSTALLED)	LEGEND
SEWER TO SUMP PUMP LIKELY REQUIRED (FOR BASEMENT IF INSTALLED)	STREET
SERVICES INSTALLED TO m INSIDE PROPERTY	NAS
FOUNDATION SOIL BEARING INVESTIGATION CERTIFICATION REQUIRED	- SERVICE LOCATION (SHOWN ON ABOVE PLAN)
GEOTECHNICAL RESTRICTIONS APPLY (SEE GEOTECHNICAL REPORT)	SROW SROW
ENVIRONMENTAL RESTRICTIONS APPLY	L# 6 L# 6 L# 6 L# 6 L# 6 L = LEGAL LOT NUMBER
	「 のこころで のこころで のこころで していたいでの していでの していたいでの していたいでの していたいでの していでの していたいでの していたいでの していたいでの していたいでの していたいでの していたいでの していたいでの していたいでの していたいでの していたいでの していたいでの していたいでの していたいでの していでの していたいでの していでの していでの していでの していたいでの していたいでの していでの していでの していでの してい
UTILITY EASEMENTS AFFECT THIS LOT	GFE 47.55 - GARAGE FLOOR ELEVATION
	MSE 52.20 – MINIMUM SANITARY SERVICABLE ELEVATION BY GRAVITY S 49.12 (P) – SAN SERVICE INV.
	(P) D 49.12 (P) (P) DENOTES PUMP IS LIKELY REQUIRED FOR BASEMENT IF INSTALLED
	(P) DENOTES PUMP IS LIKELY REQUIRED FOR BASEMENT IF INSTALLED
	L
NOTES	– LOT TYPE (L/LB/LBT) – PROPOSED REAR CORNER ELEVATIONS
 IT IS THE RESPONSIBILITY OF THE BUILDER TO ENSURE THE FOOTINGS ARE PLACED ON A PROPER BASE THAT IS FREE FROM FROST, EXCESSIVE MOISTURE AND DELETERIOUS MATERIALS AND HAVE APPROPRIATE FROST PROTECTION WHEN COMPLETED. 	LANE/LOT
 THE INFORMATION CONTAINED HEREIN IS BASED ON THE APPROVED LOT GRADING PLAN FOR THIS SUBDIVISION. UN-AUTHORIZED DEVIATIONS WILL BE THE RESPONSIBILITY OF THE BUILDER TO ENSURE COMPLIANCE WITH ALL LOCAL BYLAWS. 	I, THE BUILDER'S REPRESENTATIVE,, CERTIFY THAT THE FINAL HOUSE PLANS PROVIDED IN THE BUILDING PERMIT
3. OTHER NOTES:	APPLICATION ARE THE SAME AS PROCESSED UNDER THIS GRADE SLIP AND THAT I UNDERSTAND THE INFORMATION AND THE REQUIREMENTS CONTAINED HEREIN AND WILL BUILD ACCORDINGLY.
	AUTHORIZED BUILDER'S REPRESENTATIVE DATE THE INFORMATION CONTAINED HEREIN IS BASED ON THE APPROVED
	LOT GRADING PLAN FOR THIS SUBDIVISION, DATED
	C. Hume - Oct. 12/22 ISSUED BY DEVELOPER'S AUTHORIZED REPRESENTATIVE DATE
ا WSP - May 13, 2022 8:04 AM D:\2021\211-00627-00_ROYAL BAY - SECTOR 7\3_TECH\3_CADD\3_SHEETS\211-00627-00-E	3UILDING-GRADE-SLIPS.DWG


SITE DATA	RBCD5	LOT 48
ITEMS	PERMITTED	PROPOSED
LOT AREA	368 sq.m.	392.10 sq.m.
LOT COVERAGE	50.00 %	44.42 %
BUILDING HEIGHT	9.50 m.	6.74 m.
LOT WIDTH	10.97 m.	11.16 m.
Setbacks		
- FRONT	3.00 m.	6.74 m.
- FRONT (GARAGE)	6.00 m.	8.54 m.
- REAR	6.00 m.	7.20 m.
- RIGHT SIDE	1.20 m.	1.27 m.
- LEFT SIDE	1.20 m.	1.20 m.
PROPOSED FLOOR AREA		
- MAIN		138.15 sq.m.
- LOWER		108.80 sq.m.
- GARAGE		41.90 sq.m.
SUB-TOTAL G.F.A.		288.85 sq.m.
GARAGE ALLOWANCE	50.00 sq.m.	-41.90 sq.m.
GROSS FLOOR AREA		246.95 sq.m.
F.A.R.		0.63 TO 1.0
SECONDARY SUITE		
FLOOR AREA (%)	40.00 %	32.40 %
FLOOR AREA (SQ.M.)	90.00 sq.m.	80.01 sq.m.

AVERAGE NATURAL GRADE CALCULATION: $\overline{69.30M + 69.55M + 67.85M + 68.00M} = 274.70M/4 = 68.68M$


SEE LANDSCAPING PLAN FOR TREE SCHEDULE

RETAINING WALLS


XX.Xm = DESIGNER APPROXIMATE HEIGHT MEASUREMENT, VERIFY ON SITE - TO BE CERTIFIED BY AN ENGINEER AND MEET BCBC REQUIREMENTS FOR EARTHQUAKE DESIGN (REFER TO STRUCTURAL DRAWINGS) - ALL LANDSCAPE RETAINING WALLS TO HAVE A 1.2m MAX. EXPOSED HT OR A MAX. 1:1 RATIO OF HEIGHT TO HORIZONTAL SEPARATION IF TERRACED

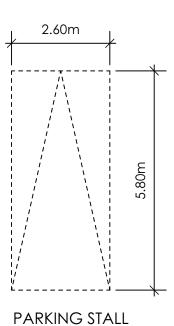

DIMENSIONS

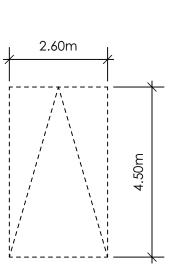

SMALL CAR PARKING STALL DIMENSIONS * as per 2.2.02a allowing one stall to be a small car parking stall

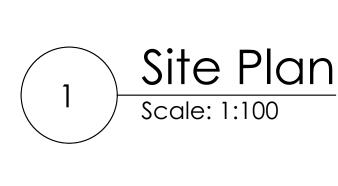

Finished


.00M (36.

,.09FT)

69.42m

Finished

-Oflog

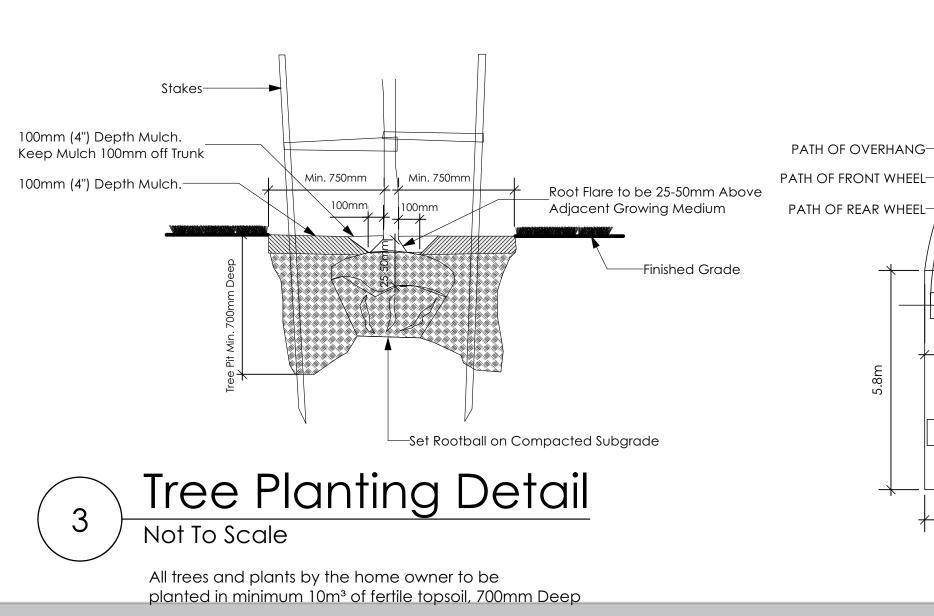


STOP & READ

RETAINING WALLS MAY NOT EXCEED 1.2m IN HEIGHT, OR A 1:1 RATIO OF HEIGHT TO HORIZONTAL SEPARATION IF TERRACED

MAXIMUM PROJECTIONS / CANTILEVERS / OVERHANGS INTO YARDS OF 3.0m+.

THE WIDTH OF THE DRIVEWAY ACCESS (AT PROPERTY LINE -

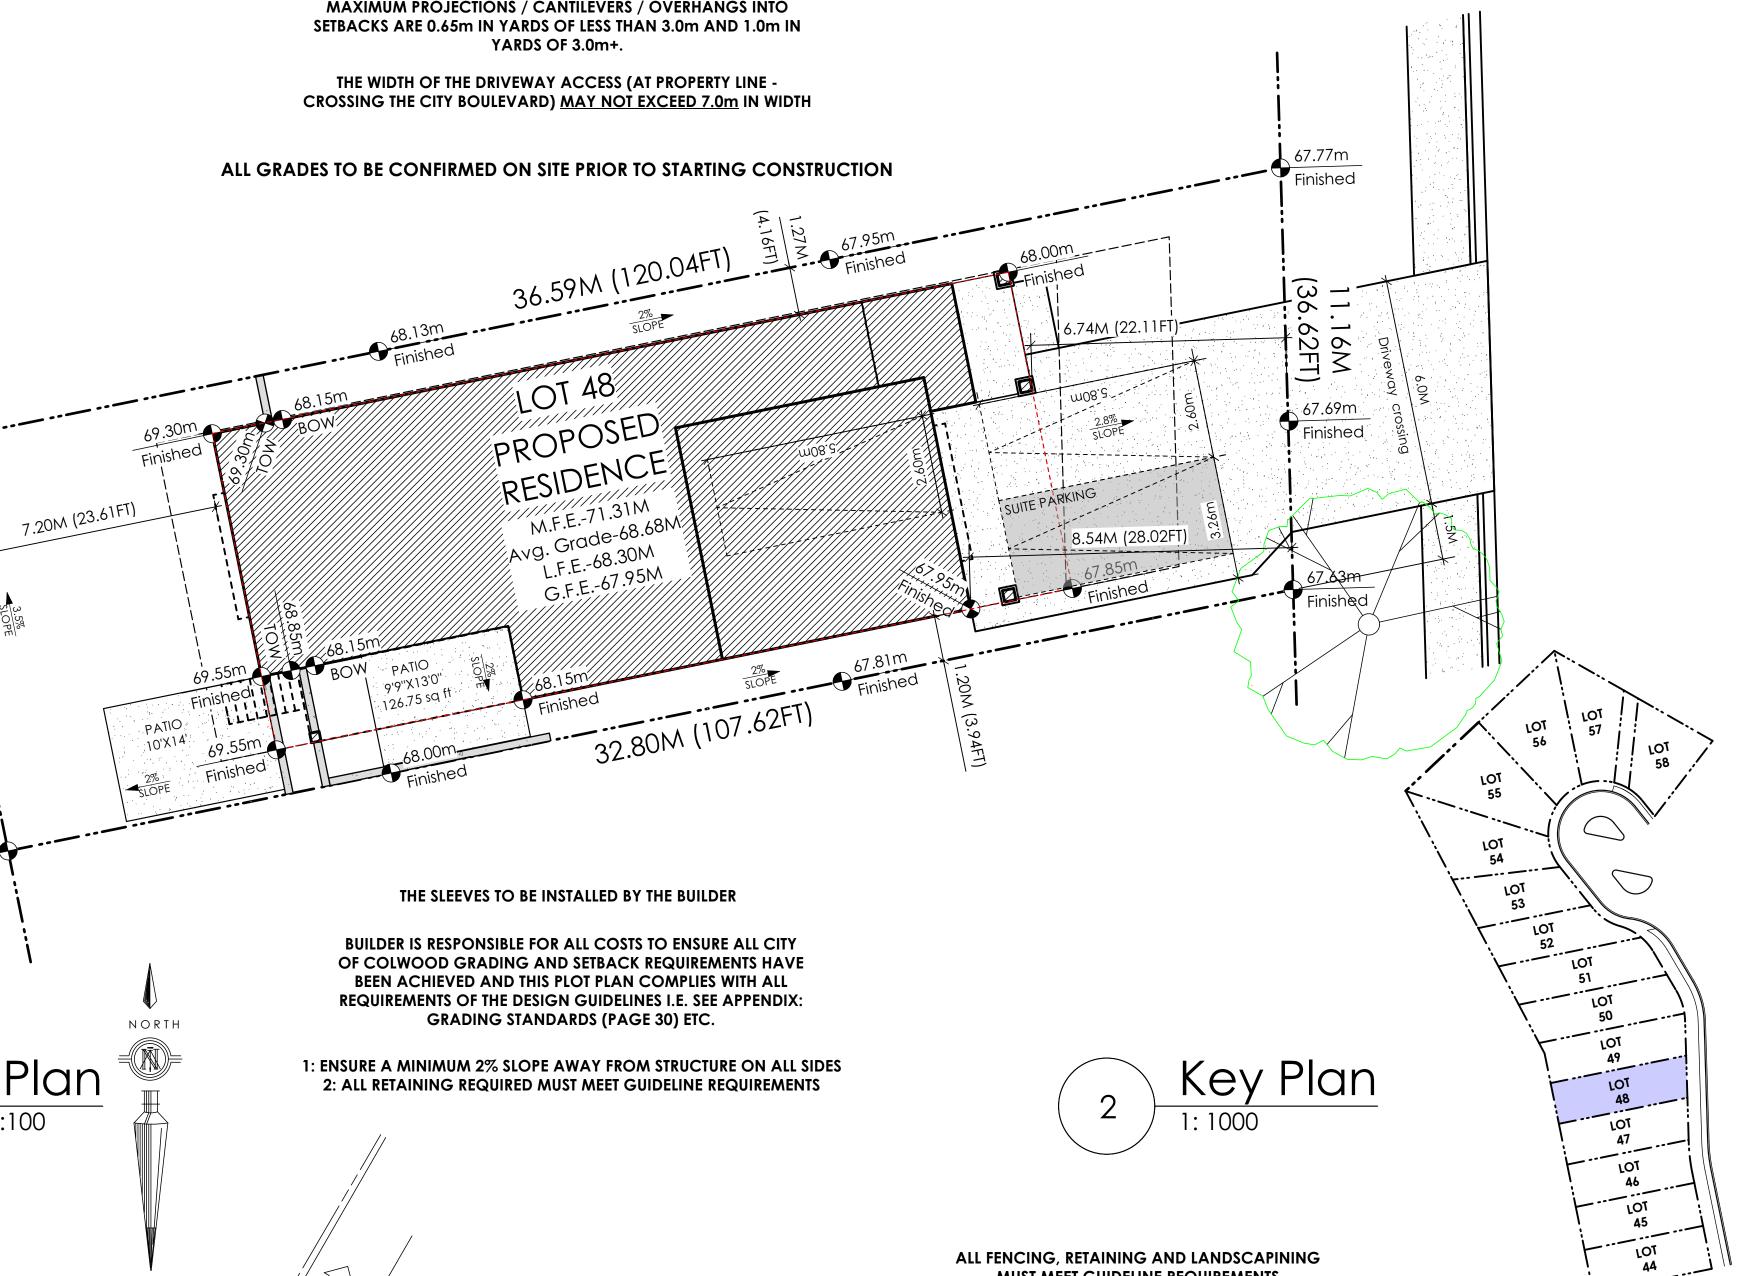

7.47m

4


2.13m

PASSENGER VEHICLE

2.13M X 5.8M (7'x19') TURNING TEMPLATE

Turning Template

MUST MEET GUIDELINE REQUIREMENTS

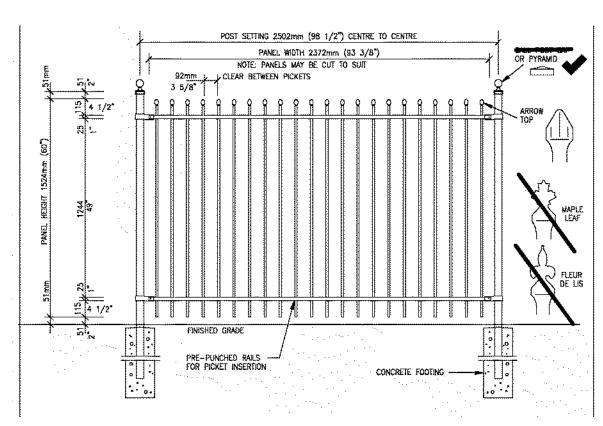



Development Permit Presentation

Schedule 2



#103 - 891ATTREE AVENUE VICTORIA, B.C. V9B 0A6 P. 250.382.7374 F. 250.382.7364

'PORT' - COASTAL

Date Dec 22 2022

Project Address 3469 Trumpeter Street Royal Bay - Sector 7 Colwood, B.C.


Prepared for Verity Construction

Project #


8298 A2

Scale As Noted

Drawn By MRB

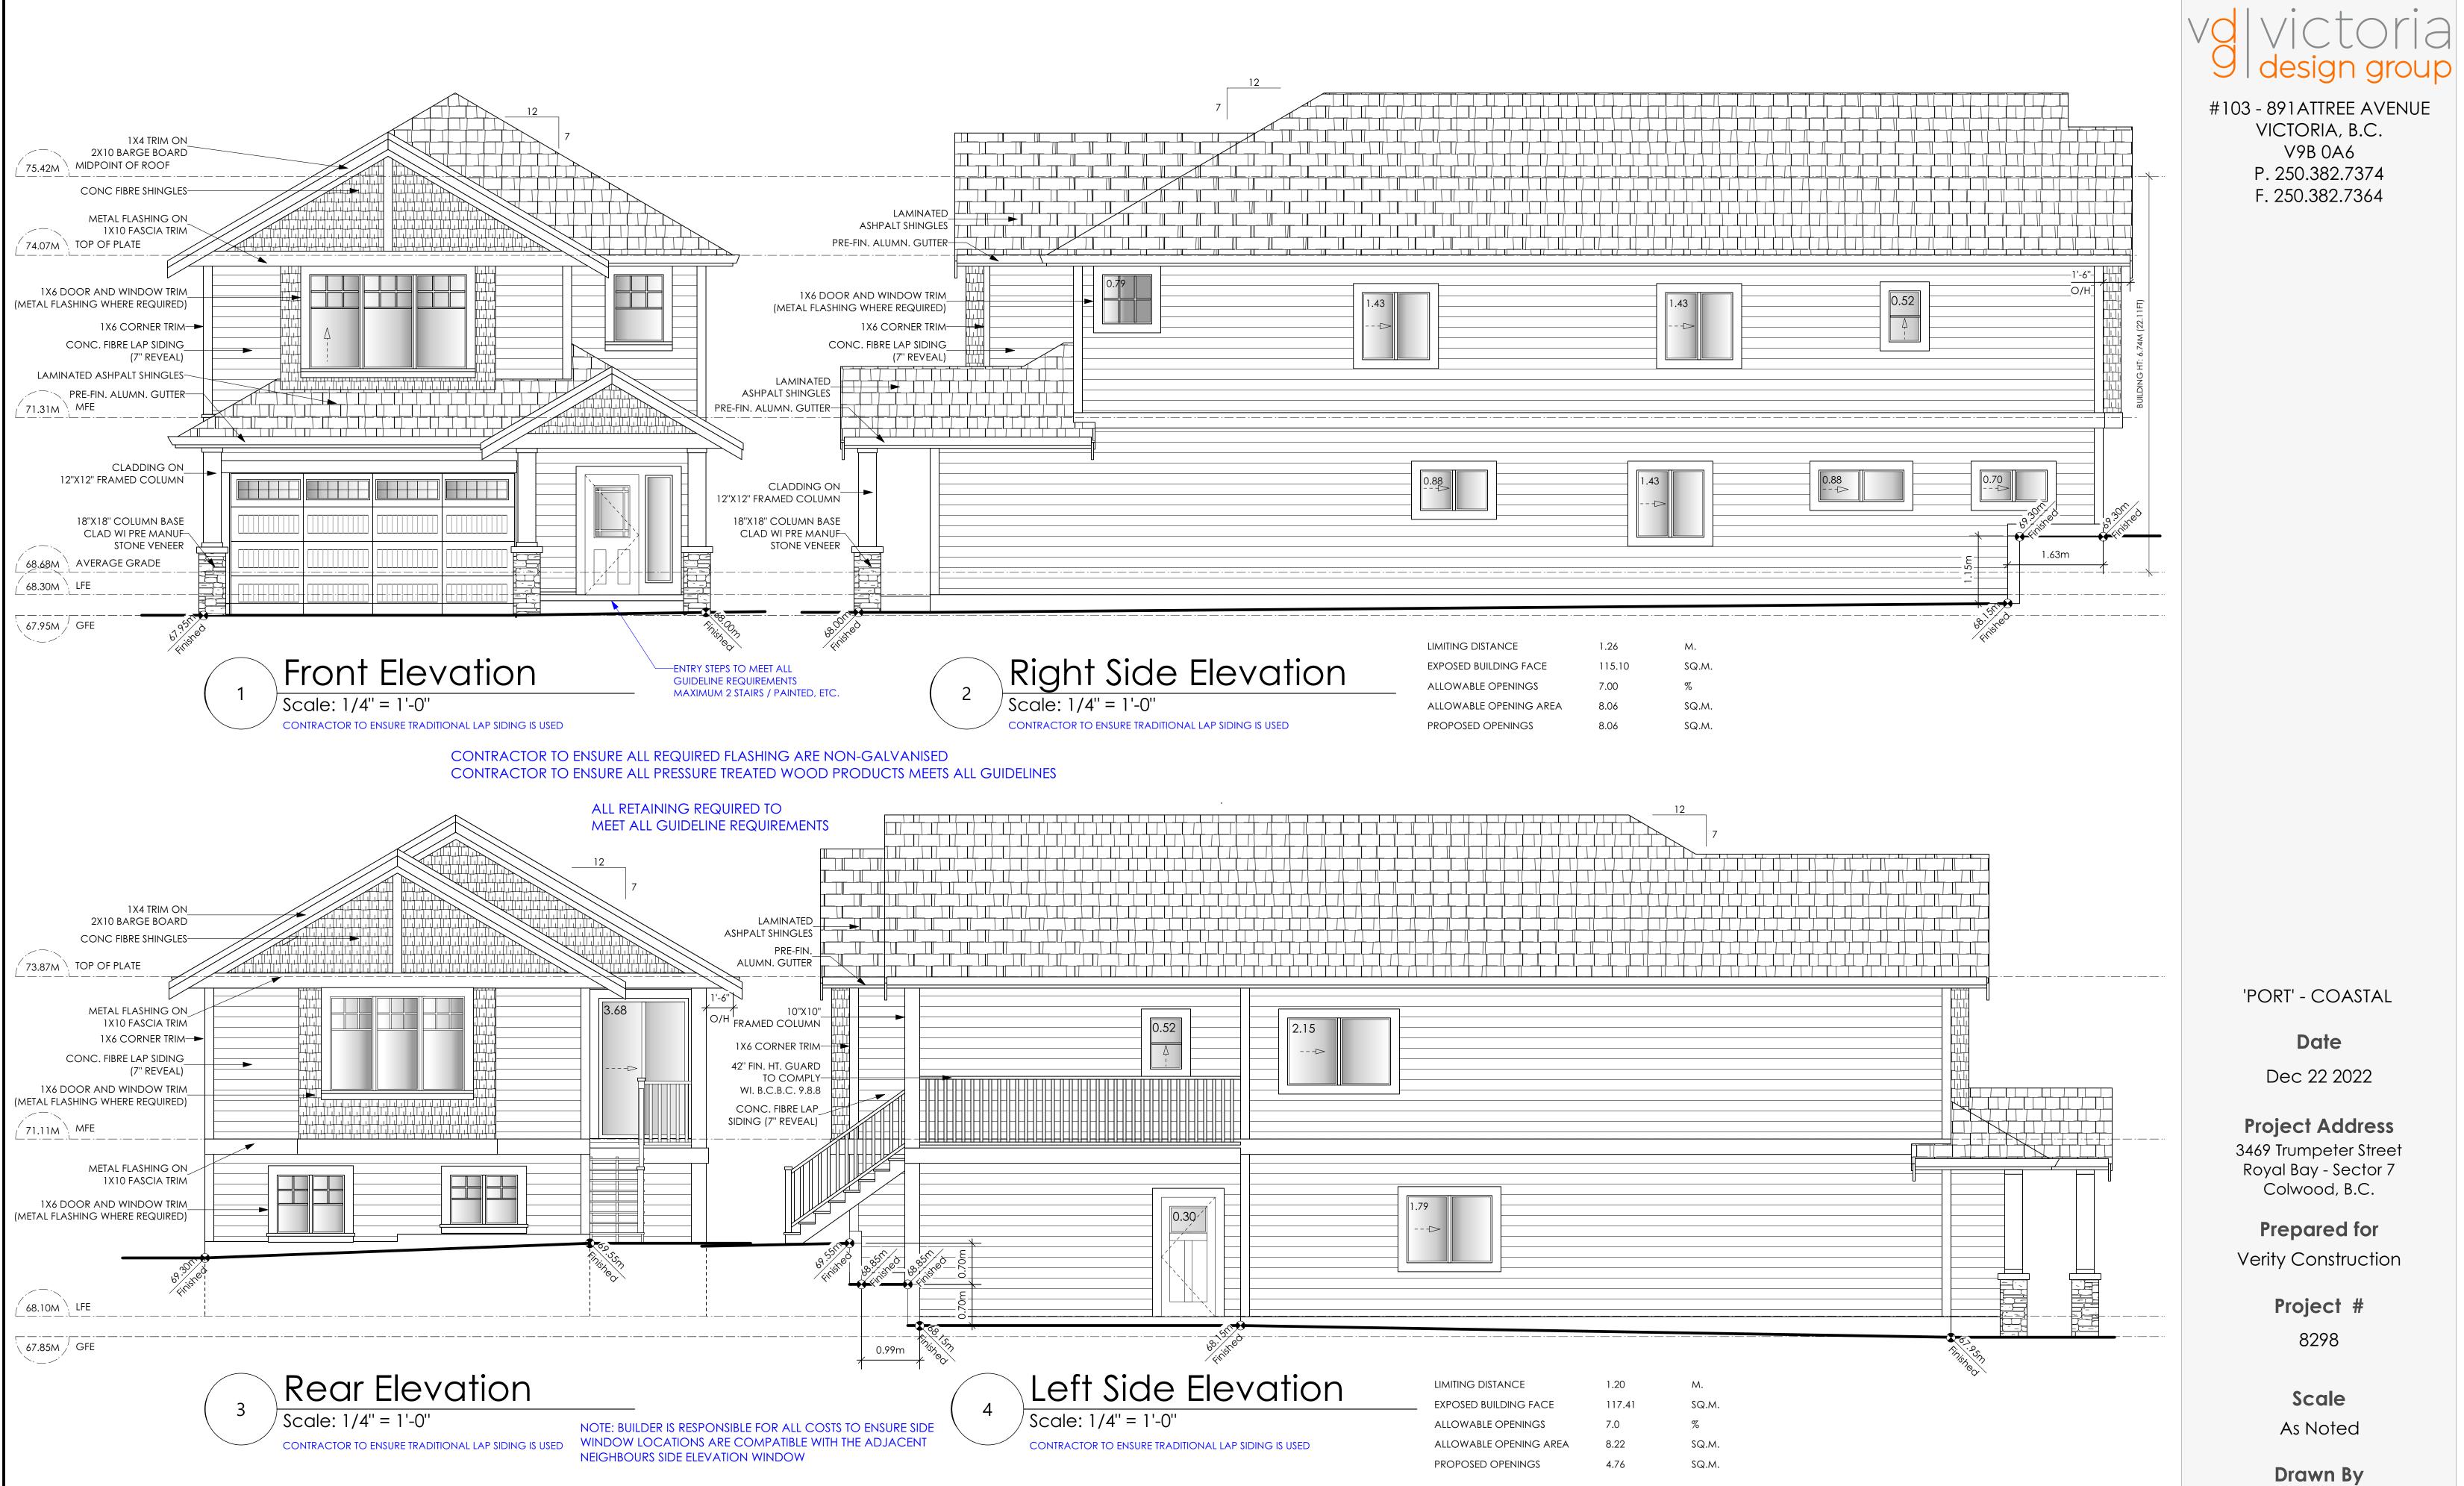

Drawn By MRB

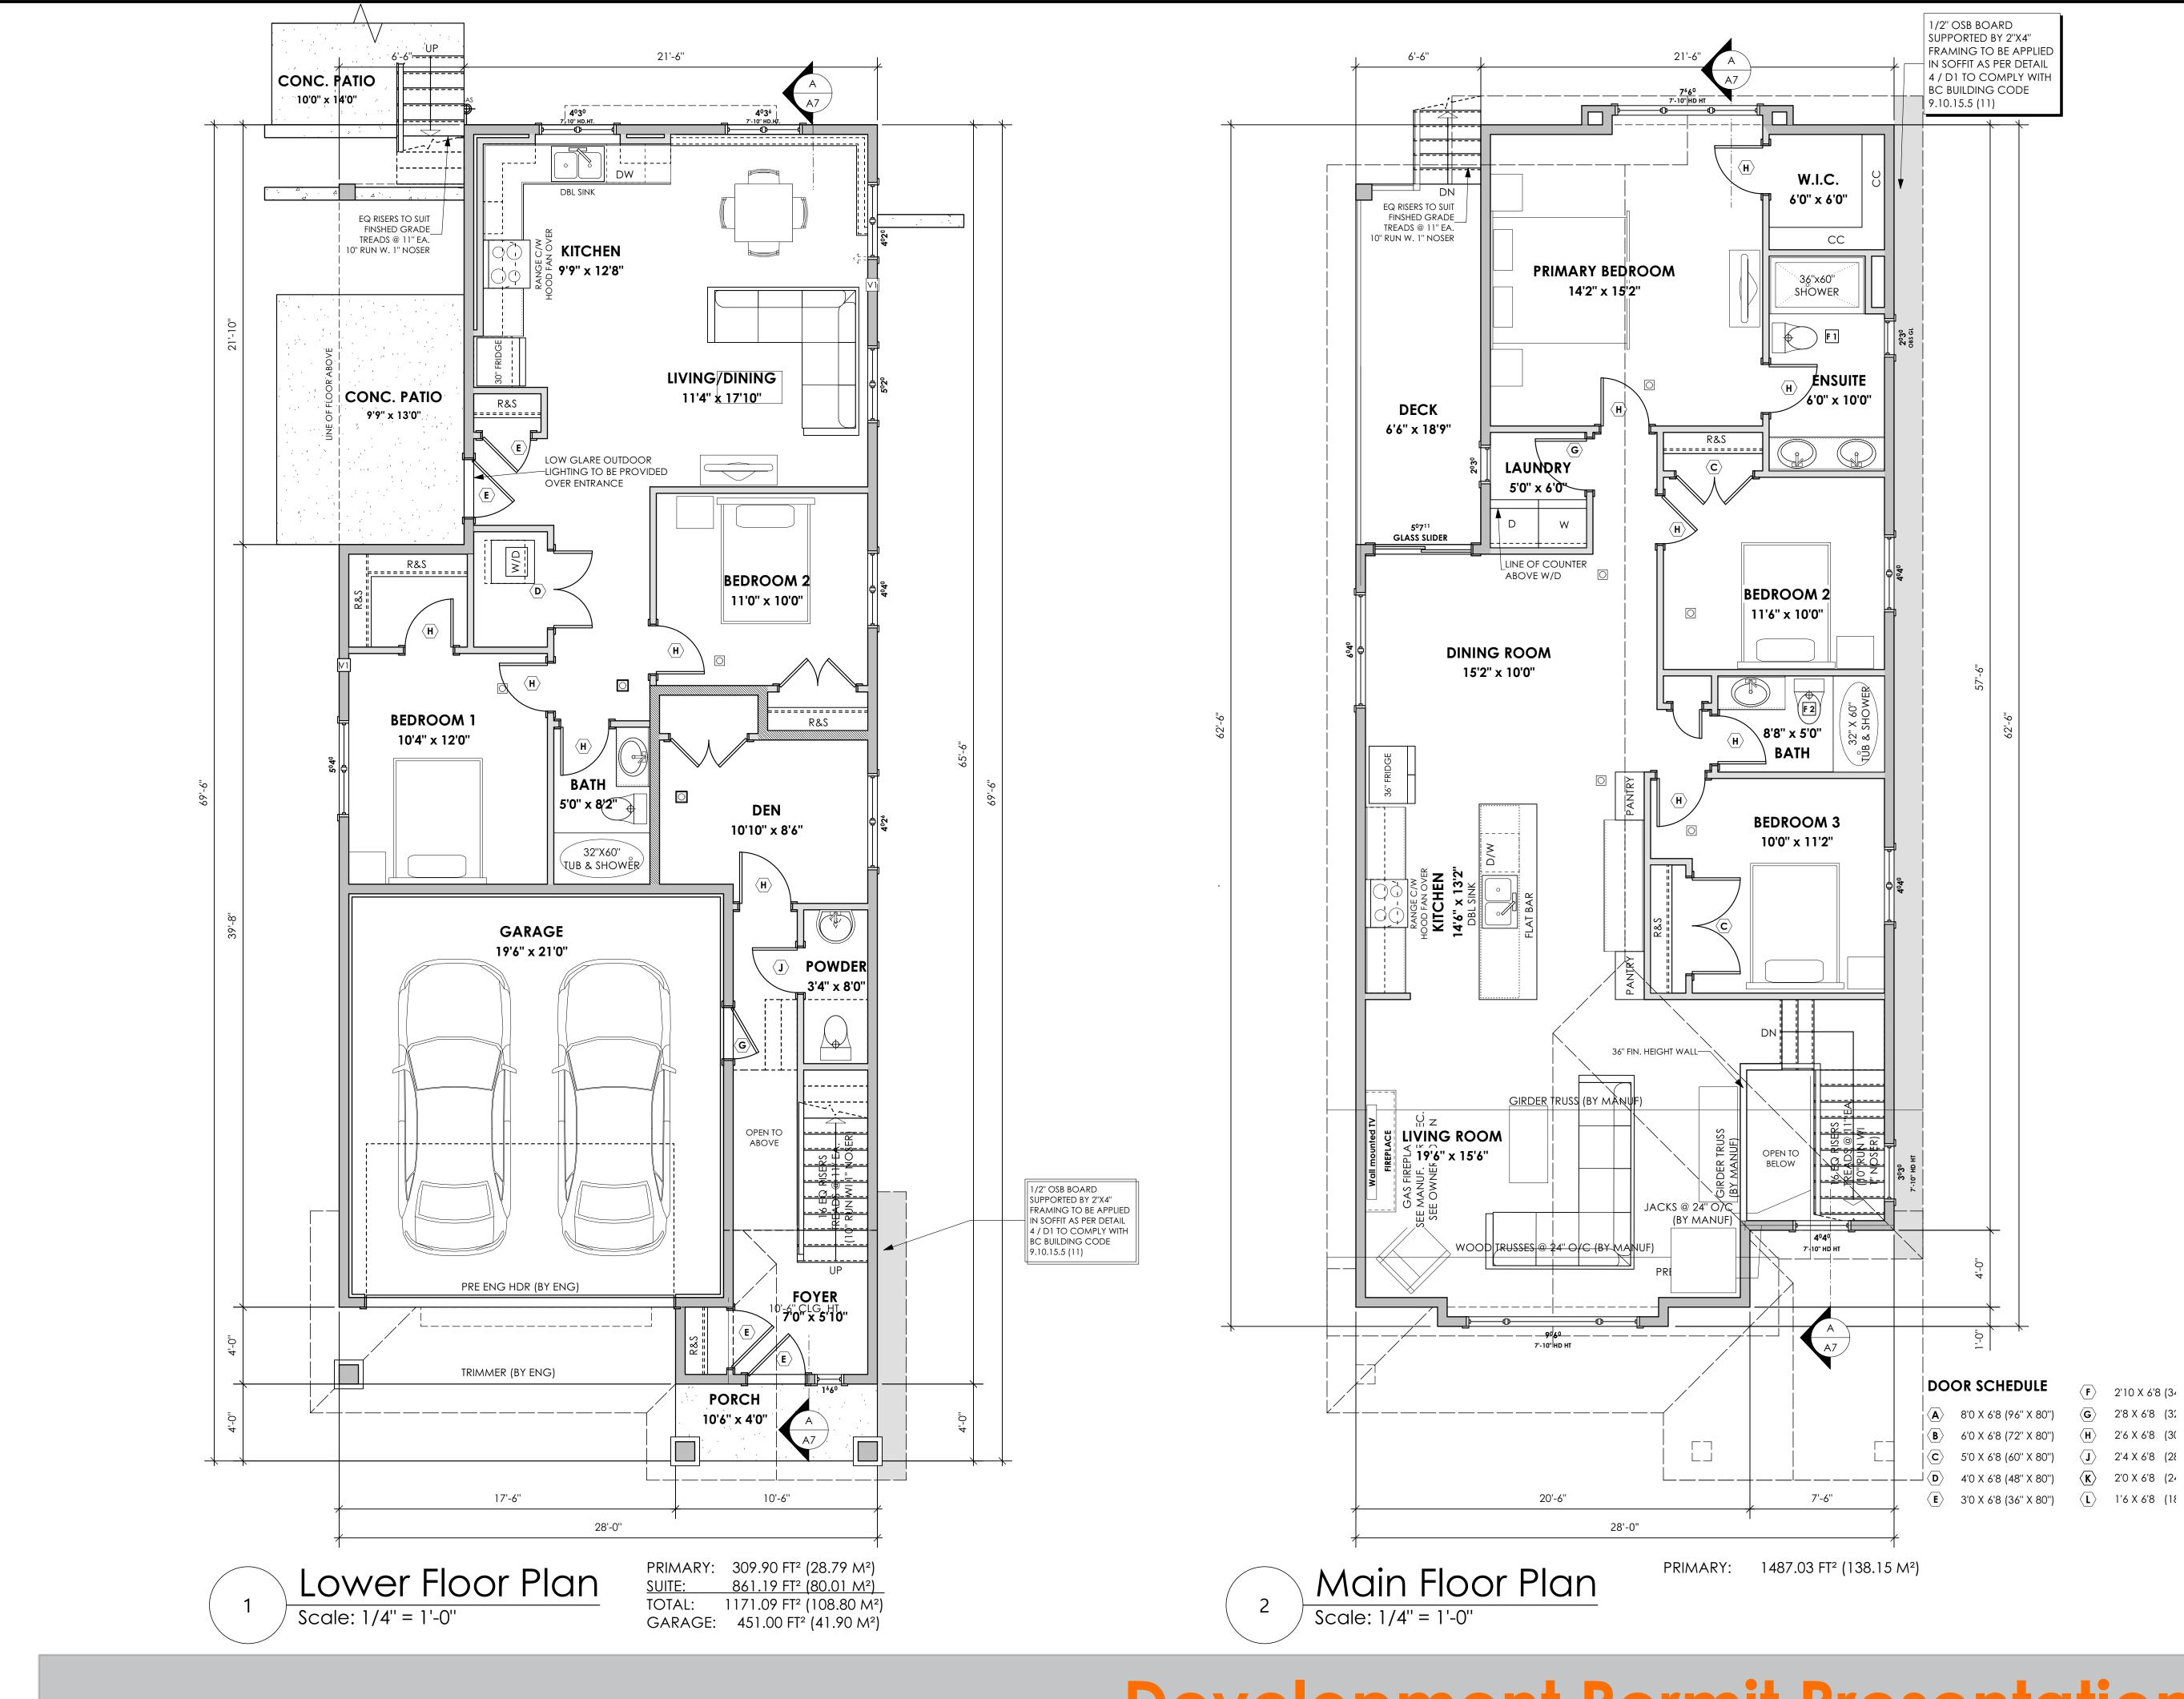

d victoria

#103 - 891ATTREE AVENUE VICTORIA, B.C. V9B 0A6 P. 250.382.7374 F. 250.382.7364

'PORT' - COASTAL

Date Dec 22 2022


Project Address 3469 Trumpeter Street Royal Bay - Sector 7 Colwood, B.C.

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Roofs

- R1. LAMINATED ASPHALT SHINGLES ON 7/16" ORIENTED STRAND BOARD C/W "H" CLIPS WD TRUSSES (DESIGNED BY MANUF.) 14 1/2" FIBRE GLASS LOOSE FILL INSULATION (ALLOW FOR SETTLING) OR R-40 FIBRE GLASS BATT INSULATION 6 MIL POLY'N V.B. 5/8" GYPSUM BOARD
- R2. PROVIDE 2 1/2" (63mm) CLEAR BETWEEN R-20 INSULATION AND SHEATHING. (min. R-20 @ roof-wall connection for 4'-0" (1.2m) around perimeter of building. air ventelation baffles to be installed where required in as per BCBC 9.19.)
- R3. EAVE PROTECTION CONT. UP ROOF SLOPE FOR 12" PAST EXTERIOR WALL.
- R4. PROVIDE 1 SQ.FT. ATTIC VENT PER 300 SQ.FT. OF INSULATED AREA MIN. 25% OF REQUIREDTO BE @ TOP AND BOTTOM (to comply wi. B.C. bldg. code 9.19.1)
- R5. PRE-FN. FASCIA GUTTER 2×8 FASCIA BD. 2×4 SUB. FASCIA BD. VENTED SOFFIT (see contractor)

R6. PRE MANUF SOFFIT

1/2" OSB BOARD SUPPORTED BY 2"X4" FRAMING REFER TO DETAIL 4 / D1 (to be applied in any soffit that has less then 1.20m clearance to any proverty line. To comply with BC BUILDING CODE 9.10.15.5 (11)) (AS REQUIRED, VERIFY ON SITE) (NOT SHOWN IN SECTION)

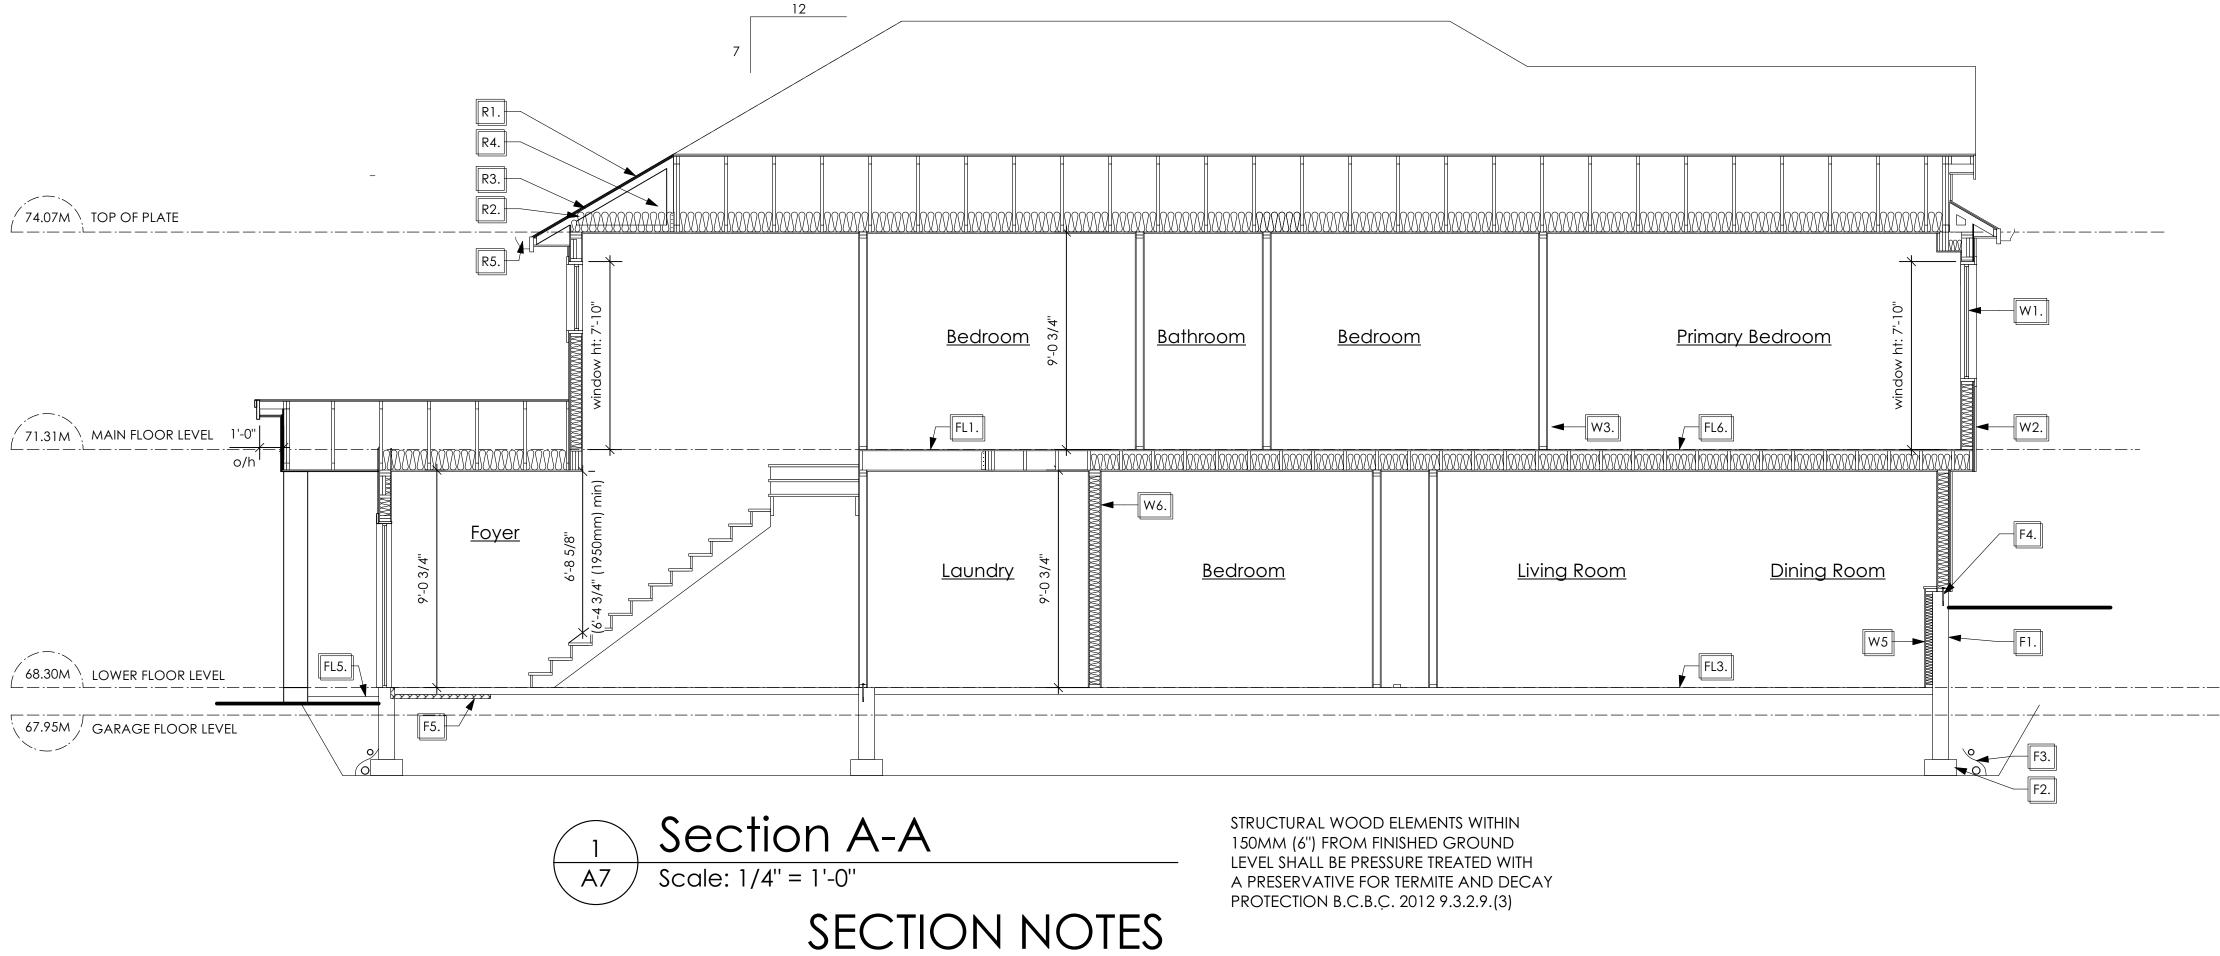Floors

FLI.	FINISHEL 19/32" C (NAILED 2×10 FLC C/W 2×2 1/2" GYF
FL2.	FINISHEE 19/32" C (NAILED 2×10 FLC C/W 2×2 R-31 FIBF 5/8" X-TY (BETWEE (NOT SH
FL3.	3 1/2" C 6 MIL. PC 6" COM
FL4.	3 1/2" C 6 MIL. PC

(NOT SHOWN IN SECTION) FL5. 3 1/2" CONCRETE SLAB (CONTRACTOR TO VERIFY EXTENT OF EXTERIOR SLABS AND FINISHES) (SLOPE AWAY FROM BUILDING @ 2% MIN.) 6" COMPACTED GRAVEL OR SAND

FL6. F8d RATED CEILING ASSEMBLY (BC BUILDING CODE TABLE 9.10.3.1.B) FINISHED FLOORING ON 19/32" ORIENTED STRAND BOARD OR EQ. (FASTENED & GLUED TO FLOOR STRUCT. BELOW) ON 2×10 FLOOR JOISTS @ 16" OR 12" O/C C/W 2×2 X-BRIDGING @ 7.0' O/C (MAX)

FL1. FINISHED FLOORING ON ORIENTED STRAND BOARD OR EQUAL) & GLUED TO FLOOR STRUCT. BELOW) ON LOOR JOISTS @ 16" OR 12" O/C ×2 X-BRIDGING @ 7.0' O/C (MAX)

'PSUM BOARD D FLOORING ON ORIENTED STRAND BOARD OR EQUAL 0 & GLUED TO FLOOR STRUCT. BELOW) ON

LOOR JOISTS @ 16" OR 12" O/C ×2 X-BRIDGING @ 7.0' O/C (MAX) BRE GLASS BATT INSULATION

type gypsum board EN GARAGE AND LIVING SPACE) HOWN IN SECTION)

CONCRETE SLAB POLY'N V.B.

MPACTED GRAVEL OR SAND CONCRETE SLAB POLY'N V.B.

6" COMPACTED GRAVEL OR SAND SLOPE TO DOORS 1"

R-31 INSULATION RESILIENT METAL CHANNELS @ 24" O/C 1 LAYERS 5/8" X-TYPE GYPSUM BOARD 30 MINUTE F.R.R., 50 S.T.C.

Walls

- W1. DOUBLE GLAZING ENERGY STAR LOW "E" RATING IN THERMAL BREAK FRAMES 2/2"X10" LINTEL OVER (@ BEARING WALLS ONLY) (TYPICAL, WI. 2 1/2" XPS INSULATION) FLASHING OVER @ EXTERIOR (GLAZING IN ALL EXTERIOR DOORS & WITHIN 3 FT. OF EXTERIOR DOORS TO BE SHATTERPROOF (SP)) WINDOW REQUIREMENTS DERIVED FROM BCBC TABLE C-5 AS PER BCBC 9.7.4.3. AND ARE TO BE USED TO SATISFY THE REQUIREMENTS OF AAMA/WDMA/CSA 101/I.S.2/A440, "NAFS": COLWOOD, CLASS R, DP 1440, PG 30, WATER RESIST. 220, A2, RATINGS MUST BE CLEARLY LABELED ON ALL WINDOW UNITS UPON INSTALLATION FOR INSPECTION.
- W2. CONC. FIBRE BOARD ON 9.5MM (3/8") AIR SPACE / STRAPPING 3/8"×2" BORATE TREATED PLYWOOD STRAPPING HOUSE WRAP (A.B.) (TYVEK OR EQ.) 7/16" ORIENTED STRAND BOARD SHEATHING 2×6 STUDS (SEE APCING BELOW) **R-20 INSULATION** 6 MIL. POLYETHYLENE VAPOUR BARRIER 1/2'' GYPSUM BOARD (REFER TO DETAILS ON D1)
- W3. INTERIOR PARTITION 1/2" GYPSUM BOARD ON EACH SIDE OF 2×4 STUDS (SEE SPACING BELOW) OR 2×6 STUDS (SEE SPACING BELOW) (IF NOTED)

W4.	5/8" X-TYPE GYPSUM BOARD ON 2×6 STUDS (SEE SPACING BELOW) R-20 INSULATION		F1.	DAM 8'' THI C/W
	6 MIL. POLY'N V.B 1/2" GYPSUM BOARD (BETWEEN GARAGE & LIVING) (NOT SHOWN IN SECTION)		F2.	16"X 8 C/W ON U
W5.	1/2" GYPSUM BOARD ON 6 MIL. POLY'N V.B. 2×4 STUDS (SEE SPACING BELOW)		F3.	4" PEI 3" TIG DRAII
	OR 2x6 STUDS (SEE SPACING BELO' R-12 BATT INSULATION HOUSE WRAP (A.B.) (TYVEK OR EQ		F4.	ANCI c/w S
	12.7MM (1/2") AIR SPACE (PROVIDE REQUIRED FIRE STOPS IN ASSEMBLIES TO COMPLY WITH B.C. BLDG. CODE 9.10.16.)	WALL	F5.	UNDE 2 1/2 RIGIE CON
W6.	B.C. BUILDING CODE (TABLE 9. RATED WALL ASSEMBLY W3C 1 LAYER 1/2" X-TYPE GYPSUM BE RESILIENT METAL CHANNELS @ 2 2×4 STUDS @ 16" O/C OR 2×6 STUDS @ 16" O/C (IF NOTED 3 1/2" FIBRE GLASS SOUND BAT 1 LAYER 1/2" X-TYPE GYPSUM BE 45 MIN. F.R.R 43 S.T.C (BETWEEM PRIMARY LIVING & S	OARD 24" O/C D) C/W TS OARD		SLAB (VERI
W7.	STUD SPACING - UPPER FLOOR: - MAIN FLOOR: - LOWER FLOOR:	2"X6" @ 24" O/C 2"X6" @ 24" O/C 2"X6" @ 16" O/C		

2"X4"" @ 24" O/C

2"X4"" @ 16" O/C

2"X4"" @ 24" O/C

(if applicable)

- LOAD BEARING:

- PARTY WALL

(if applicable)

- INTERIOR PARTITION:

Development Permit Presentation

X 8" CONC. FOOTINGS

F1.

PERIMETER DRAIN IGHT PIPE FOR RWL AIN ROCK

v SILL GASKETS

DER SLAB INSULATION 2" (RSI 2.15) EXTRUDED POLYSTYRENE ID INSULATION 4'-0" (1.2M) NT. AROUND PERIMETER UNDER B INSTALLED HORIZONTALLY



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Foundation Walls

DAMPROOFING (where required) ON HK. CONC. FOUNDATION WALL V 15 M BARS @ 24" o/c B/W

> V 2 (TWO) 15m BARS CONT. 3 IN. FROM BOTT. UNDISTURBED SOIL (SOLID BEARING)

CHOR BOLTS @ 4.0 FT. o/c MAX

RIFY WITH MUNICIPALITY DEPTH OF FROST LINE)

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ALL FENCING, RETAINING AND LANDSCAPING MUST MEET THE GUIDELINE REQUIREMENTS

ALL RETAINING WALLS ARE TO BE STAND ALONE STRUCTURES (THEY MUST TERMINATE AT PROPERTY LINE) AND MUST NOT CONNECT TO RETAINING WALLS LOCATED ON ADJACENT PRIVATE PROPERTIES

10/12/22

01/03/23

02

03

"NOTE: In the interest of maintaining high standards, the developer reserves the right to modify plans, specifications and design without prior notice. Drawings contained within are artist renderings only. Sizes and dimensions are approximate and may vary with actual plan and survey. Exterior style may change pending municipal approval. Retaining wall location and types may vary and are subject to municipal, engineering or developer discretion. Subject to change without notice. Furniture as shown on plans are for layout purposes only and are not included in the sale.

ITEM

114 TRABOARDS

A14 10 10 10 10 10 10

TALICTHERE.

In CONC. NOOTING ON: TOMAL OF ORACLEDOX

Not To Scale

AREA (sf

277

480

979

825

2.561

- 2 GAL

UFGRADE SHRUBBERT, PLANIS AND FOULAGE

COMPACIED REGISTER

Victoria, B.C. V9B 0A6

Typical Fence Detail

THECA, RECEDENAL BASE-CHI FENCE DEAL VLI MOM ROVALENT DEECH CARENHEI VACED

LEGEND

٩

%

11%

19%


38%

32%

100%

KEY PLAN NOT TO SCALE

Correct (#) Depth Multin. itasp Multih 100mm of their Miner (4) Depth Mulch.

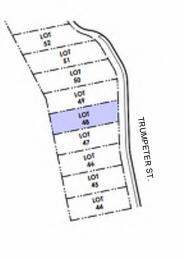

Realitions to be 36 allows above Adjound Growing Readom

bel Rusbal or Compacted Subgrade


www.verityconstruction.ca

Tree Planting Detail

All frees and plants by the home owner to be planted in minimum Idm? of tertile topsol, 700mm Deep

Not To Scale

Finished Grade

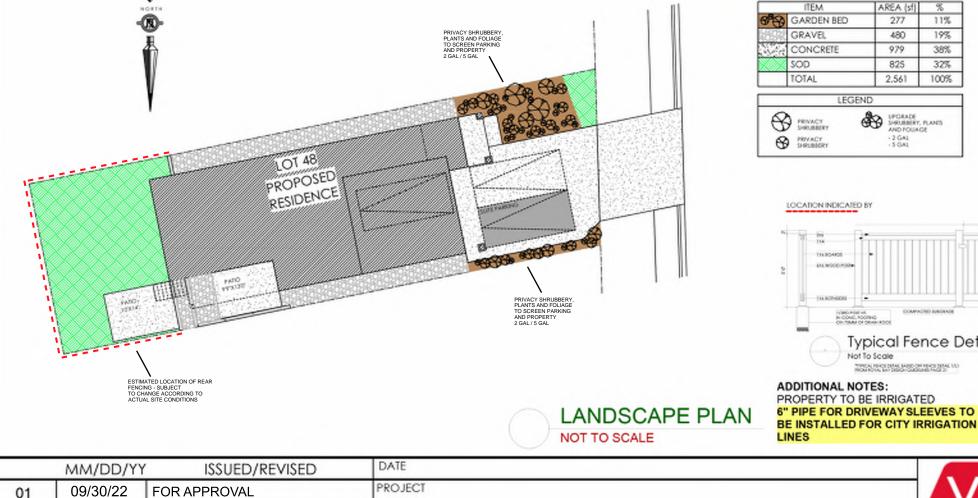

Y	ISSUED/REVISED	DATE
	FOR APPROVAL	
	GARDEN BED PLANTING	LANDSCAPING PLAN
	REVISION AS PER CITY OF COLWOOD	LOT 48, 3469 TRUMPETER ST.
		CITY OF COLWOOD QUALITY CONSTRUCTION. TRUSTED SERVICE. 106 - 1039 Langford Parkway P: 250.474.1039
	· · · · · · · · · · · · · · · · · · ·	100 - 1036 Langiold Palkway P. 230,474,1035

GABLECRAFT HOMES BUILDING GRADE SLIP

WSP Project No: <u>201-08151-00</u>

Issue Date: _____

ADDRESS 3469 Trumpeter Street	P.I.D.
LOT 48	PLAN
BUILDER VERITY HOMES	SUBDIVISION ROYAL BAY SECTOR 7
ADDRESS	DEVELOPER MEADOWS DEVELOPMENT LP
REPRESENTATIVE PH.	CONSULTANT WSP CANADA INC
PROPOSED BUILDING GRADES	PLAN
ALL ELEVATIONS ARE METRIC GEODETIC +	LOT: PLAN: TRUMPETER ST.
(TOP OF JOISTS) JOIST	
(FINISHED GRADE) (FINISHED GRADE)	
FINISHED GRADE AT GARAGE 67.95	
HEADROOM	
HEA	
ACTUAL TOP OF FOOTING	4 <u>4</u> 4 <u>8</u> 4 <u>8</u> 4 4 4 4 4 4 4 4 4 4 4 4 4
LOWEST PERMITTED TOP OF not provided FLOOR SLAB	EG 67.9 MFE 68.36 GFE 68.16
(BOTTOM OF BASEMENT ŚLAB FROST WALLS ARE REQUIRED.)	MSE 64.99 ○ 5 64.49 □ D 64.58
SERVICES FRONT REAR CENTER REFER SIZE TO PLAN (mm)	₩
WATER	
SANITARY SANITARY	
STORM	
COMMENTS YES NO	
DRAIN TO SUMP PUMP LIKELY REQUIRED (FOR BASEMENT IF INSTALLED)	
SEWER TO SUMP PUMP LIKELY REQUIRED (FOR BASEMENT IF INSTALLED)	STREET
	STRA STRAC MALT: WALT:
FOUNDATION SOIL BEARING INVESTIGATION CERTIFICATION REQUIRED	III - SERVICE LOCATION SROW (SHOWN ON ABOVE PLAN)
	SROW (S) - PROPOSED FRONT CORNER ELEVATIONS
(SEE GEOTECHNICAL REPORT)	L# 6 L# 6 LEGAL LOT NUMBER
(SEE ENVIRONMENTAL REPORT)	EG 49.90 - EXISTING GROUND ELEVATION
UTILITY EASEMENTS AFFECT THIS LOT	LFE/MFE 47.70 - LOWER/MAIN FLOOR ELEVATION GFE 47.55 - GARAGE FLOOR ELEVATION
	MSE 52.20 - MINIMUM SANITARY SERVICABLE ELEVATION BY GRAVITY
	D 49.12 (P) D 49.12 (P) - SAN SERVICE INV. (P) DENOTES PUMP IS LIKELY REQUIRED FOR BASEMENT IF INSTALLED
	(P) DENOTES PUMP IS LIKELY REQUIRED
	- PROPOSED REAR SIDE YARD GRADES
NOTES	L L L L L L L L L L L L L L L L L L L
1. IT IS THE RESPONSIBILITY OF THE BUILDER TO ENSURE THE FOOTINGS	LANE/LOT - PROPOSED REAR CORNER ELEVATIONS
ARE PLACED ON A PROPER BASE THAT IS FREE FROM FROST, EXCESSIVE MOISTURE AND DELETERIOUS MATERIALS AND HAVE APPROPRIATE FROST PROTECTION WHEN COMPLETED.	
 THE INFORMATION CONTAINED HEREIN IS BASED ON THE APPROVED LOT GRADING PLAN FOR THIS SUBDIVISION. UN-AUTHORIZED DEVIATIONS WILL BE THE RESPONSIBILITY OF THE BUILDER TO ENSURE COMPLIANCE WITH ALL LOCAL BYLAWS. 	I, THE BUILDER'S REPRESENTATIVE,, CERTIFY THAT THE FINAL HOUSE PLANS PROVIDED IN THE BUILDING PERMIT
3. OTHER NOTES:	APPLICATION ARE THE SAME AS PROCESSED UNDER THIS GRADE SLIP AND THAT I UNDERSTAND THE INFORMATION AND THE REQUIREMENTS CONTAINED HEREIN AND WILL BUILD ACCORDINGLY.
	AUTHORIZED BUILDER'S REPRESENTATIVE DATE
	THE INFORMATION CONTAINED HEREIN IS BASED ON THE APPROVED LOT GRADING PLAN FOR THIS SUBDIVISION, DATED
	C. Hume - October 13/22
WSP - May 13, 2022 8:04 AM D:\2021\211-00627-00_ROYAL BAY - SECTOR 7\3_TECH\3_CADD\3_SHEETS\211-00627-00-R	