CITY OF COLWOOD



3300 Wishart Road | Colwood | BC V9C 1R1 | 250-294-8153 planning@colwood.ca | www.colwood.ca

File: DP-23-015

DEVELOPMENT PERMIT DP-23-015

THIS PERMIT, issued October 10 2023 is,

ISSUED BY:

CITY OF COLWOOD, a municipality incorporated under the Local Government Act,

3300 Wishart Road, Victoria, BC, V9C 1R1

(the "City")

PURSUANT TO:

Section 490 of the Local Government Act, RSBC 2015, Chapter 1

ISSUED TO:

Verity Construction LTD

106-1039 Langford Parkway

Victoria, BC V9B 0A5

(the "Permittee")

 This Form and Character (Intensive Residential) Development Permits applies to those lands within the City of Colwood described below, and any and all buildings, structures, and other development thereon:

Lot 36, 37, 38, 39, 67, 68, 69, & 70 Plan EPP117070, Section 38, Esquimalt Land District 3445, 3447, 3449, 3451, & 3462 Trumpeter Street 412, 416, & 420 Rock Dove Place

(the "Lands")

- This Development Permit regulates the development and alterations of the Land, and supplements
 the "Colwood Land Use Bylaw, 1989" (Bylaw No. 151), to ensure the form & character
 considerations for eight single family homes with secondary suites and associated site
 improvements are consistent with the guidelines for areas designated as "Intensive Residential" in
 the City of Colwood Official Community Plan (Bylaw No. 1700).
- 3. This Development Permit is **NOT** a Building Permit or a subdivision approval.
- 4. This Development Permit is issued subject to compliance with all of the bylaws of the City of Colwood that apply to the development of the Lands, except as specifically varied by Council or supplemented by this Permit.
- 5. The Director of Development Services or their delegate may approve minor variations to the

schedules attached to and forming part of this Development Permit, provided that such minor variations are consistent with the overall intent of the original plans and do not alter the form and character of the development authorized by those plans.

- 6. If the Permittee does not substantially start the construction permitted by this Permit within 24 months of the date of this Permit, the Permit shall lapse and be of no further force and effect.
- 7. The development is to be constructed in accordance with the following plans and specifications, which are attached to and form as part of this permit:

Schedule 1 Site Plans, Elevations, Floor Plans, Cross Sections prepared by Victoria Design Group for Lots 36, 67, 68, & 70 dated September 14, 2023, Lots 37, 38, & 39 dated August 31, 2023, and Lot 69 dated September 29, 2023.

Schedule 2 Landscape Plans prepared by Verity Construction for Lot 36 dated September 15, 2023, Lots 37 & 38 dated June 15, 2023, Lot 39 dated June 16, 2023, Lot 67 &70 dated September 18, 2023, Lot 68 dated April 11, 2023, and Lot 69 dated September 8, 2023.

8. This Development Permit authorizes the construction of eight single-family homes with secondary suites along with any associated site works. The Land shall not be altered, nor any buildings or structures constructed, except in accordance with the following conditions:

FORM AND CHARACTER CONDITIONS

Building Features

- 8.1. The form and character of the buildings to be constructed on the Lands shall conform to the Site Plans, Elevations, Floor Plans, and Cross Sections prepared by Victoria Design Group (Schedule 1).
- 8.2. Any future additions of telecommunications antennas or equipment to the exterior of the buildings and/or structures included in this Permit shall be architecturally integrated into the buildings and/or structures they are mounted on or screened from views so as not to be visually obtrusive, to the satisfaction of the Director of Development Services.
- 8.3. No future construction/installation of unenclosed or enclosed outdoor storage areas, and recycling/refuse collection and storage areas shall be undertaken without the issuance of a further Development Permit or amendment to this Permit.
- 8.4. All mechanical roof elements, including mechanical equipment, elevator housings, and vents shall be visually screened with sloped roofs or parapets, or other forms of solid screening to the satisfaction of the Director of Development Services.


Landscaping


8.5. The design and construction of the proposed landscaping shall be in substantial compliance with the Landscape Plan prepared by Verity Construction (Schedule 2).


ISSUED ON THIS DAY OF OCTOBER, 2023.

Yazmin Hernandez

Director of Development Services

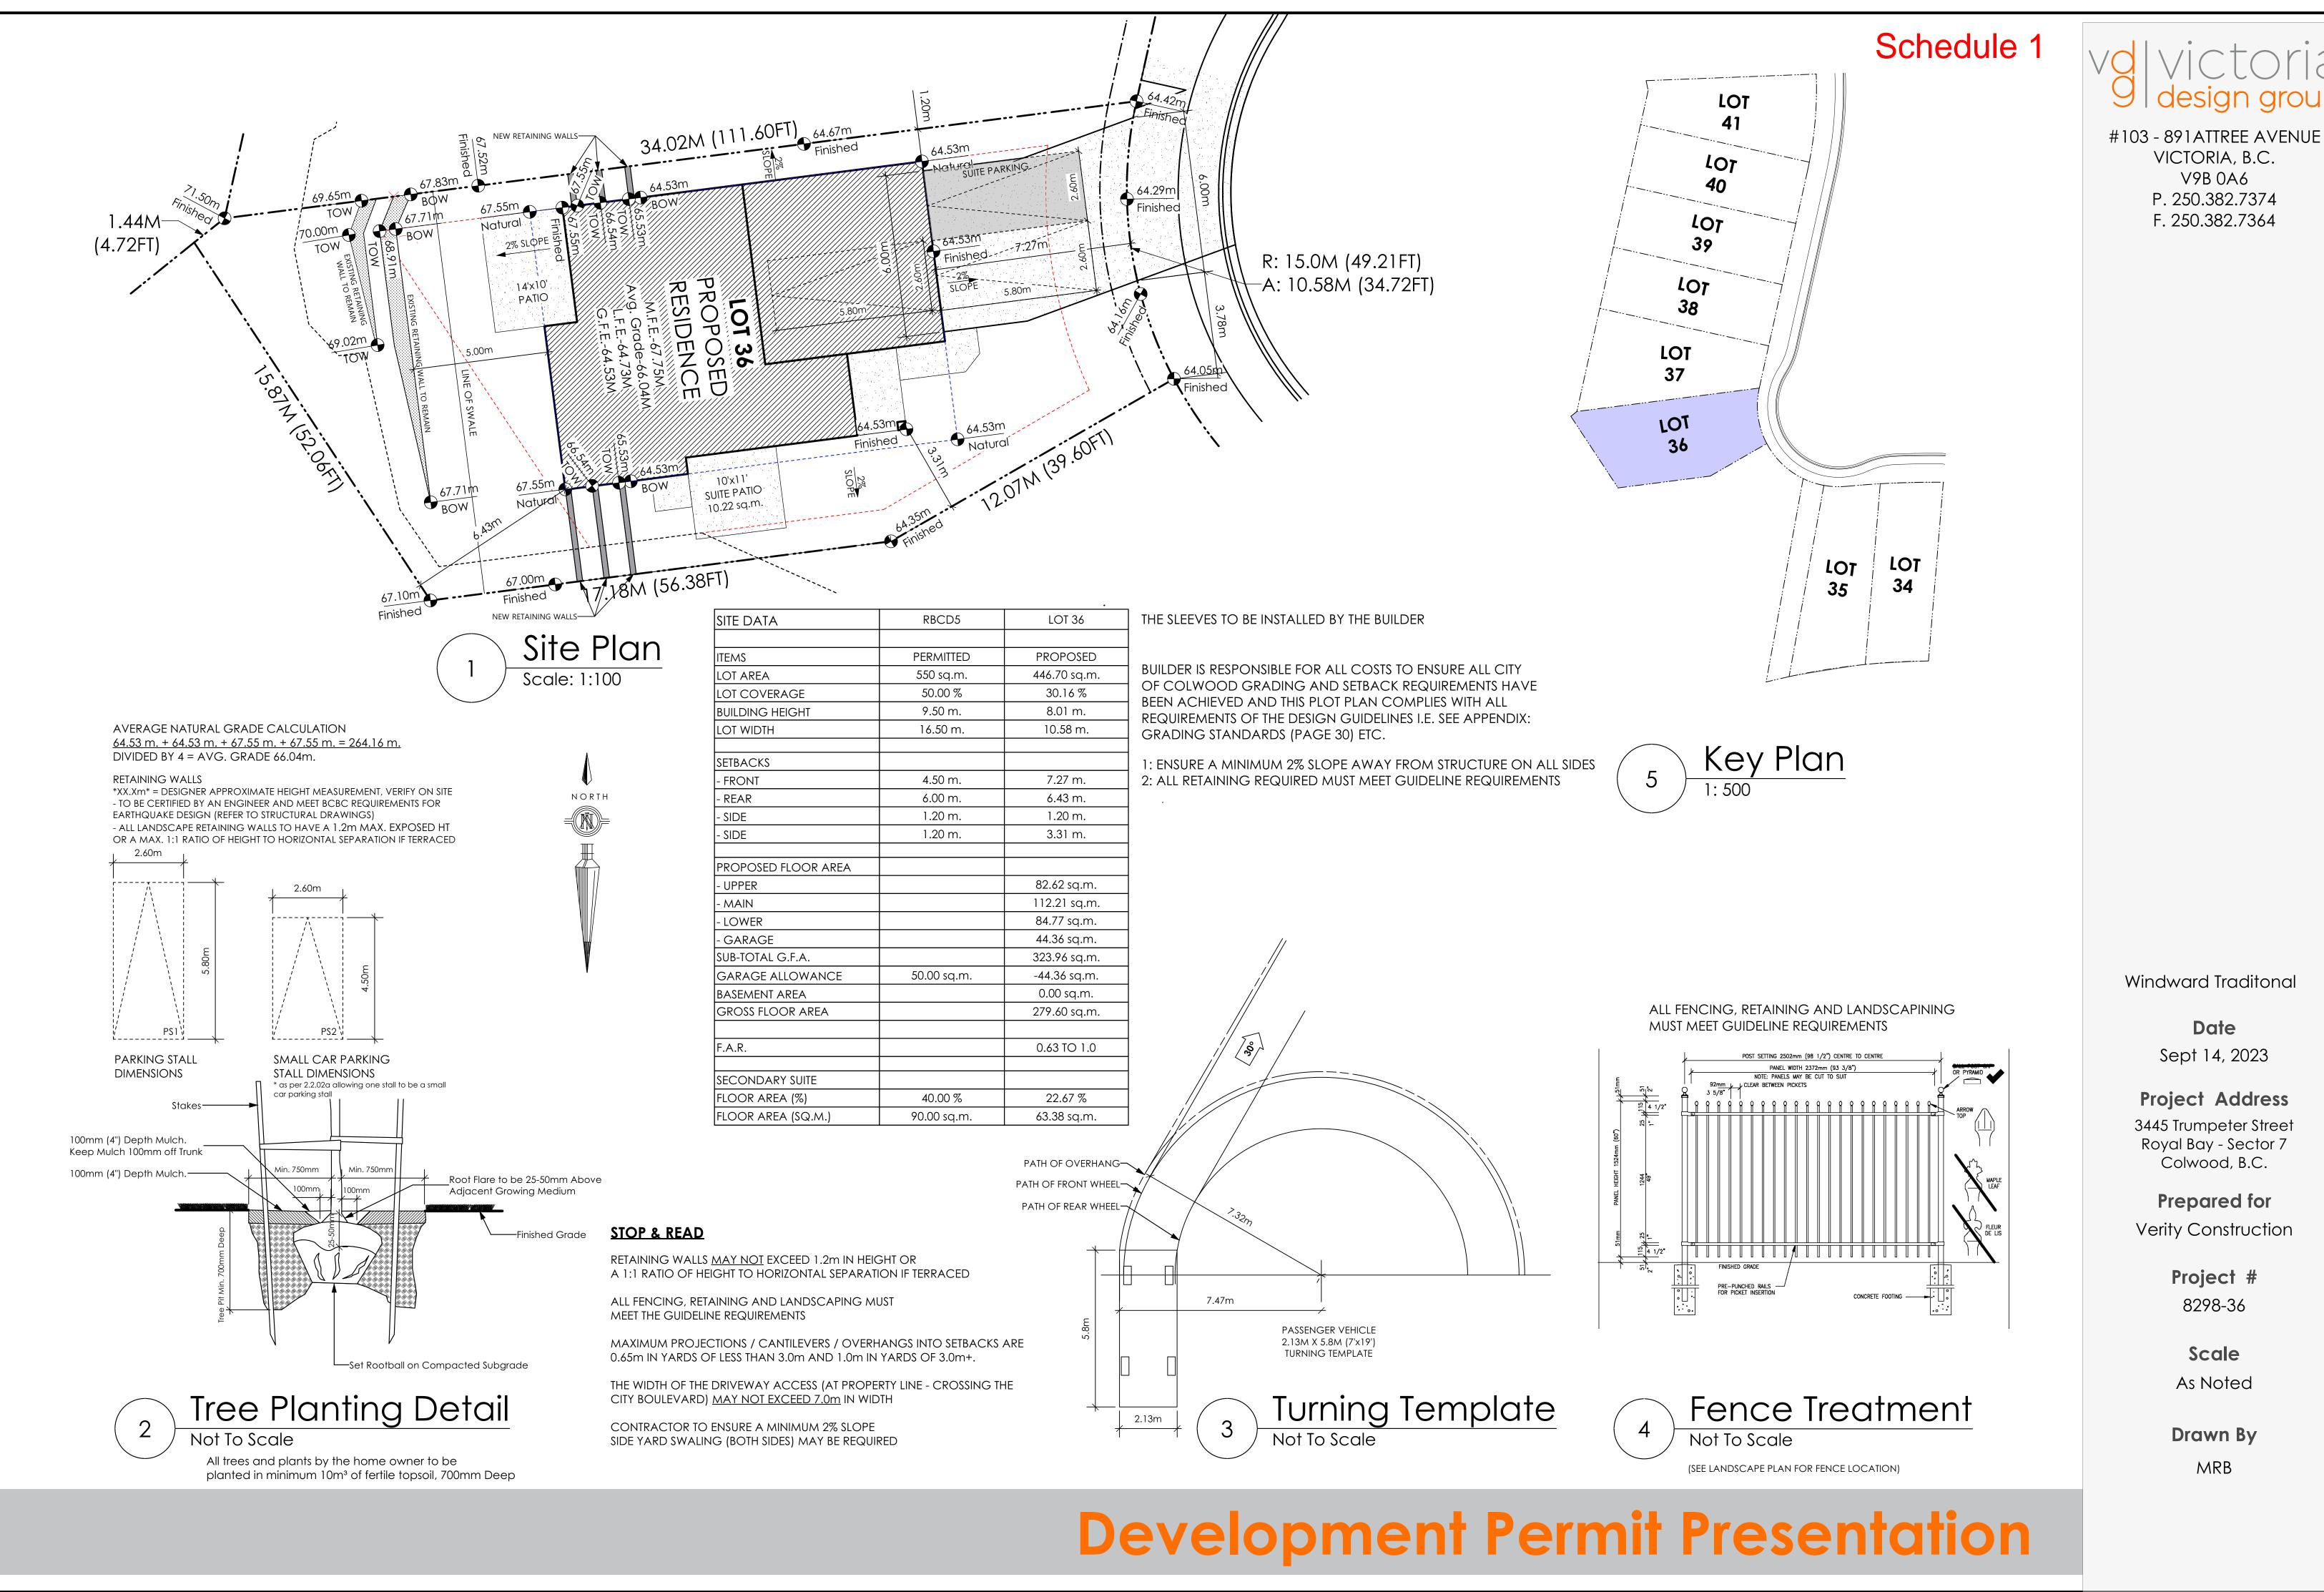

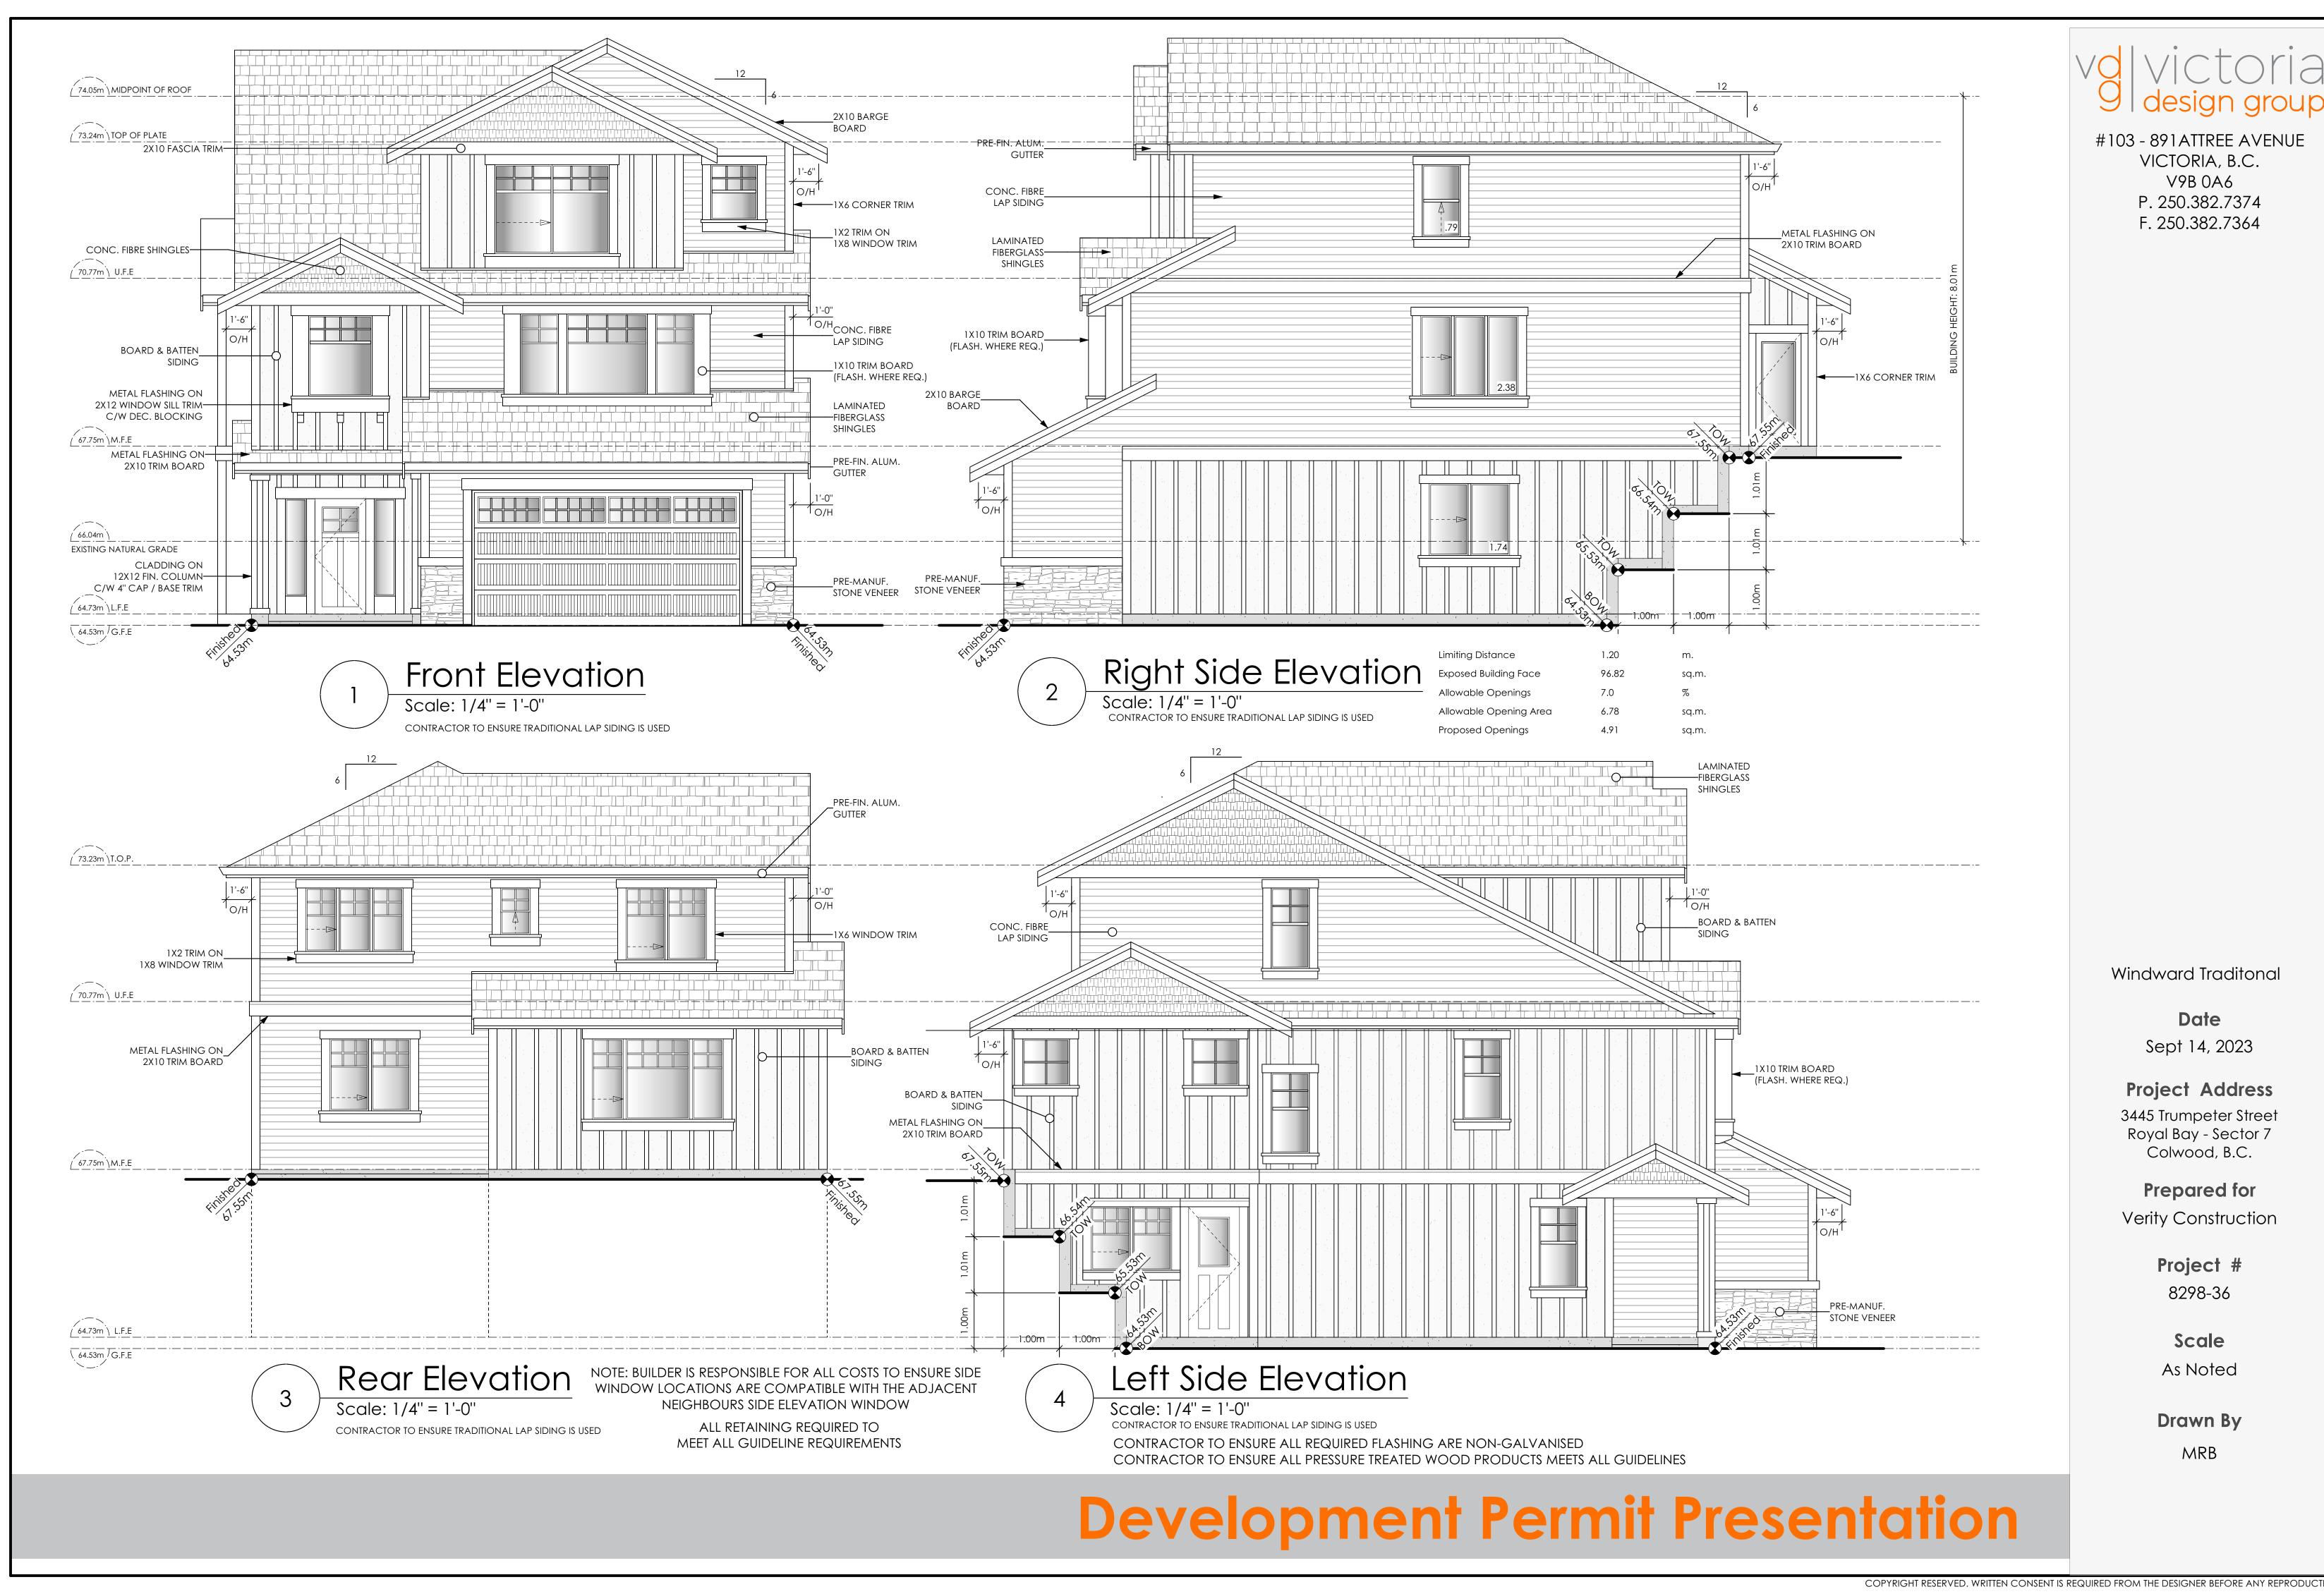

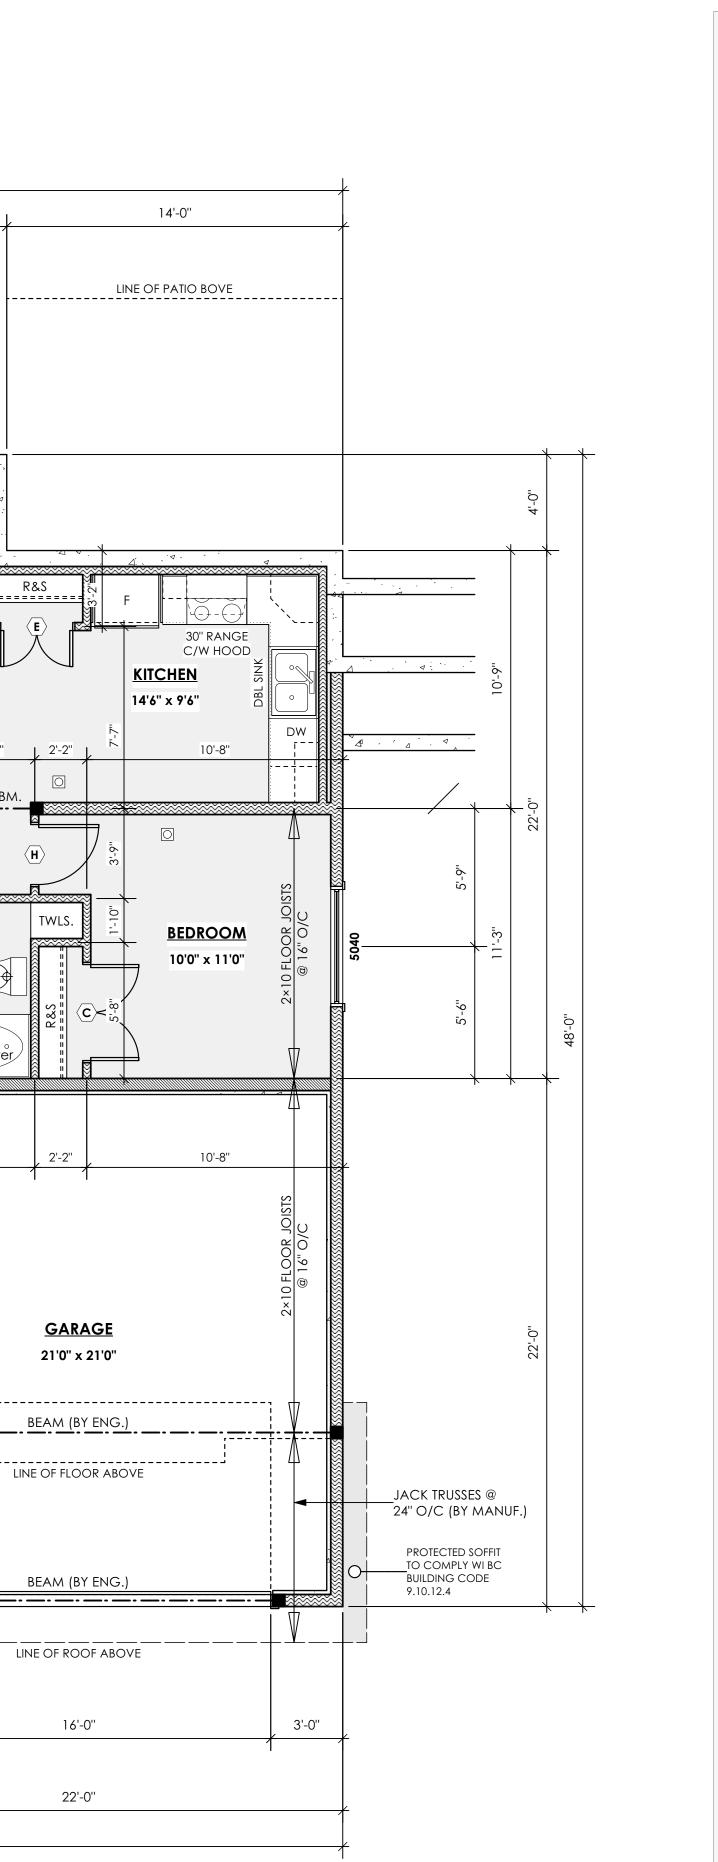

volvictoria 9 design group

> #103 - 891 ATTREE AVENUE VICTORIA, B.C. V9B 0A6 P. 250.382.7374 F. 250.382.7364

Windward Traditonal

Date Sept 14, 2023

30pi 14, 2020

Project Address

3445 Trumpeter Street
Royal Bay - Sector 7
Colwood, B.C.

Prepared for Verity Construction

Project # 8298-36

ScaleAs Noted

Drawn By

MRB

Lower Floor Plan Scale: 1/4" = 1'-0"

34'-0''

tub & shower

34'-0''

20'-0"

LIVING 5

18'0" x 13'6

LOW GLARE OUTDOOR

LIGHTING TO BE PROVIDED

STORAGE

FOYER

9'6" x 6'8"

3068 ENTRY DR

10'0" x 6'0"

3/2X10 BM.

2'-6" 2'-6"

10'-0"

SUITE PATIO

10'0" x 11'0"


16 EQ. RISERS TREADS @ 11" EA.— (10" RUN/1" NSR.)

2×10 FLOOR JOISTS____ @ 16" O/C

12"X12" B/U_

COLUMN

Primary: 230.19 sq.ft. (21.39 sq.m.) Suite: 682.23 sq.ft. (63.38 sq.m.) Total: 912.42 sq.ft. (84.77 sq.m.) Garage: 477.58 sq.ft. (44.36 sq.m.)

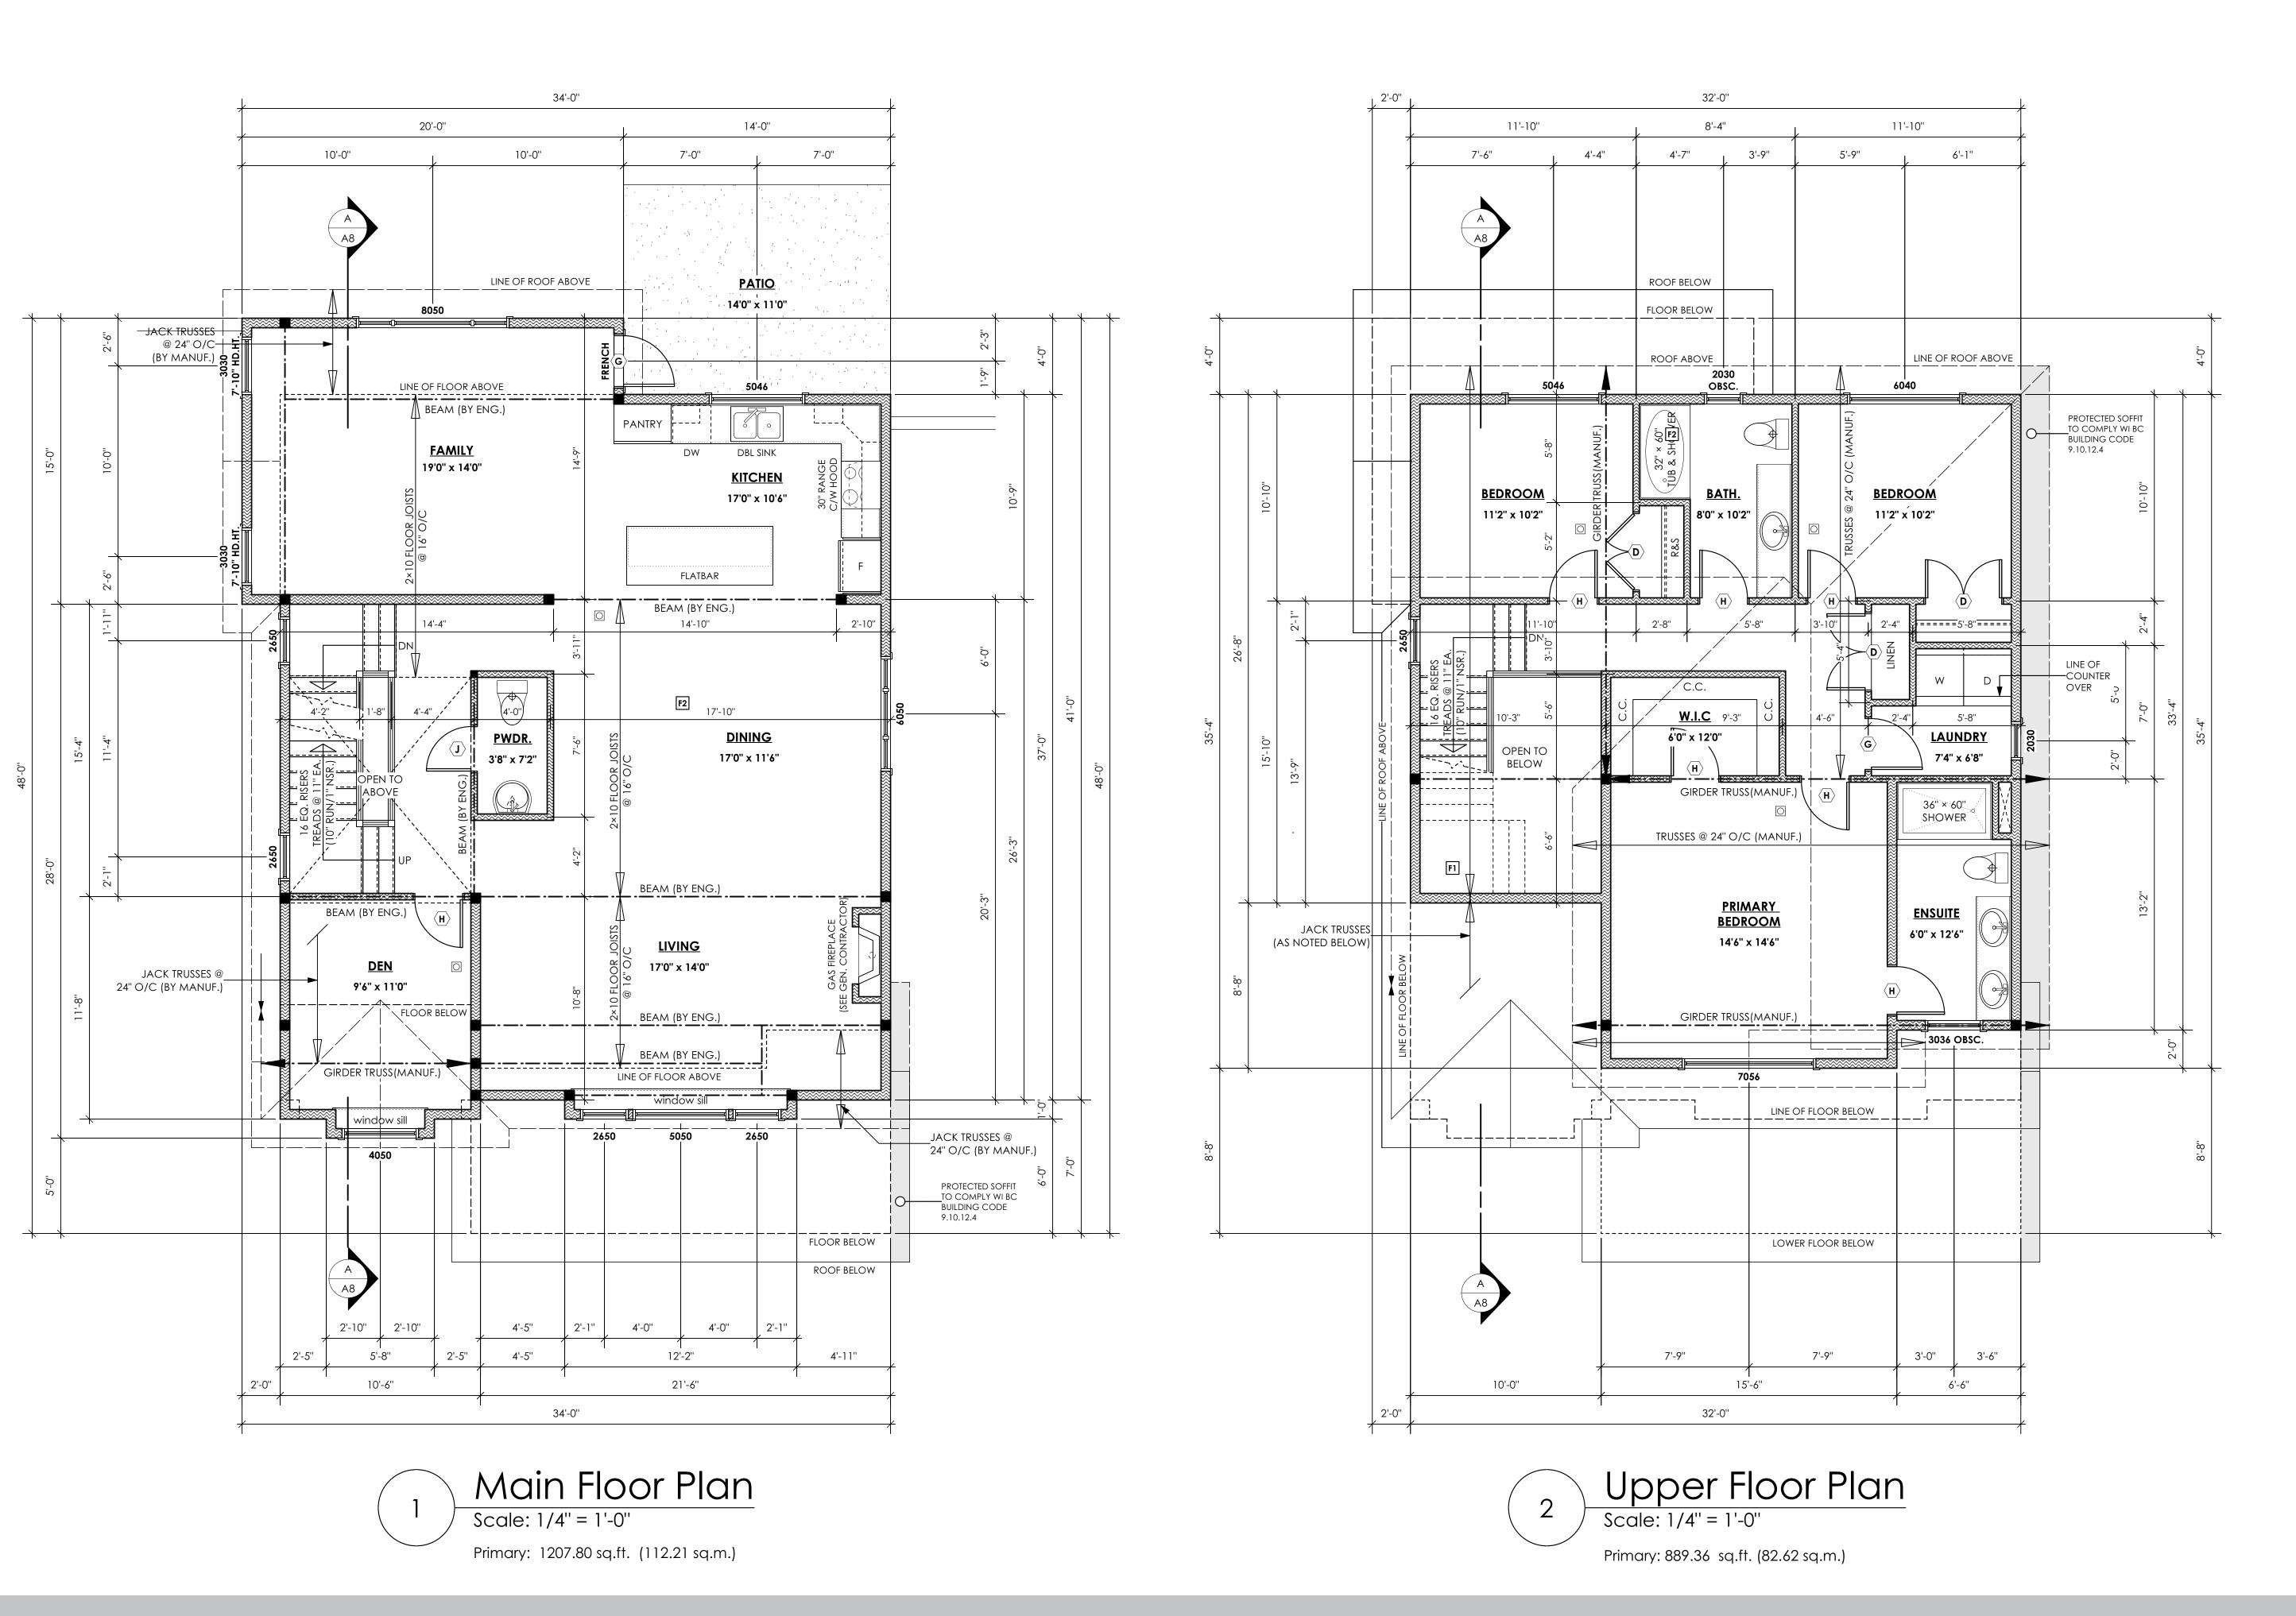

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Windward Traditonal

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3445 Trumpeter Street Royal Bay - Sector 7 Colwood, B.C.


Prepared for Verity Construction

> Project # 8298-36

Scale

As Noted

Drawn By MRB

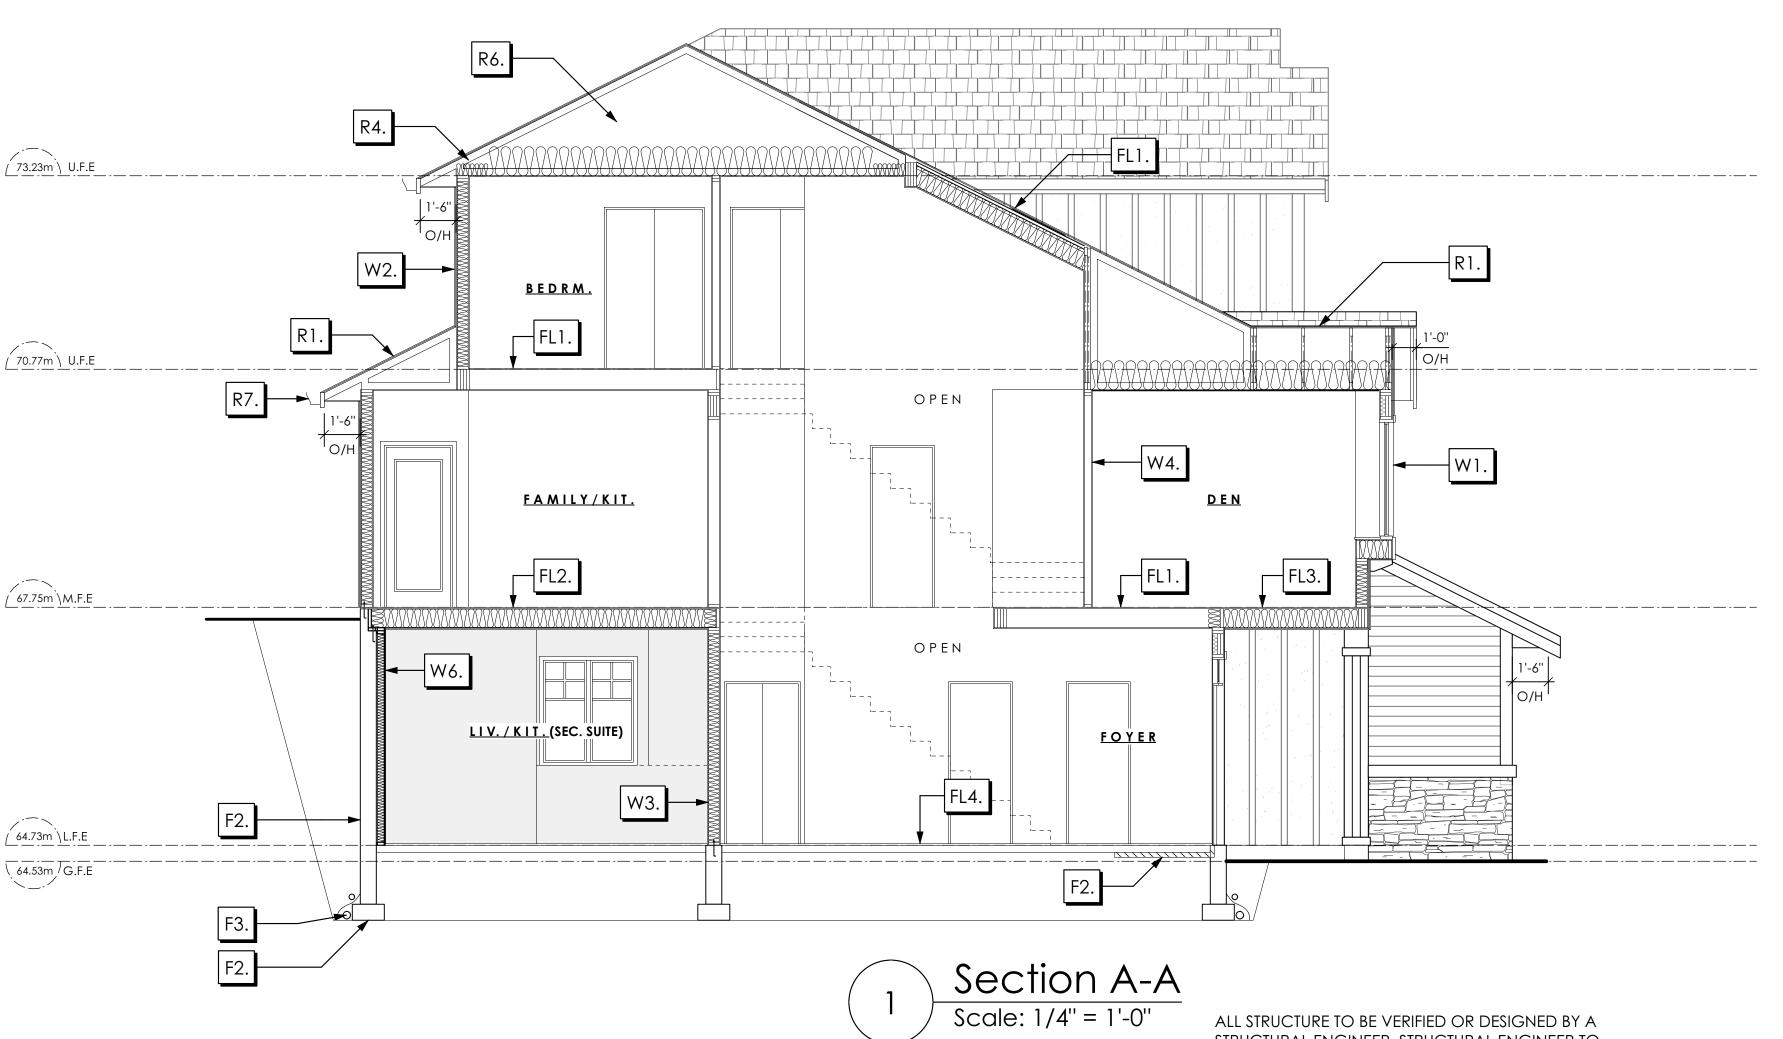

<u>Section Notes</u>

ALL STRUCTURE TO BE VERIFIED OR DESIGNED BY A STRUCTURAL ENGINEER. STRUCTURAL ENGINEER TO LOCATE AND DESIGN REQUIRED EXTERIOR AND INTERIOR BRACING TO RESIST LATERAL LOADS IN COMPLIANCE WITH B.C. BUILDING CODE 2012 9.23.13.3 AND SUPPLY DETAILS IF REQUIRED

1/2" GYPSUM BOARD ON EACH SIDE

OF 2×4 STUDS @ 16" O/C OR

W5. 5/8" X-TYPE GYPSUM BOARD ON

2×6 STUDS @ 16" O/C C/W

(BETWEEN GARAGE & LIVING)

(NOT SHOWN IN SECTION)

2×4 STUDS @ 24" O/C C/W

ASSEMBLIES TO COMPLY WITH

B.C. BLDG. CODE 9.10.16.)

(PROVIDE REQUIRED FIRE STOPS IN WALL

R-12 BATT INSULATION

BUILDING WRAP OR 12.7MM (1/2") AIR SPACE

2×6 STUDS @ 16" O/C (IF NOTED)

W4. INTERIOR PARTITION

R-20 INSULATION

6 MIL. POLY'N V.B

W6. 1/2" GYPSUM BOARD ON

6 MIL. POLY'N V.B.

1/2" GYPSUM BOARD

ROOFS

- R1. LAMINATED ASPHALT SHINGLES ON
 7/16" ORIENTED STRAND BOARD C/W "H" CLIPS
 WD TRUSSES (DESIGNED BY MANUF.)
 R-40 FIBRE GLAS BATT INSULATION OR
 14 1/2" FIBRE GLASS LOOSE FILL INSULATION
 6 MIL POLY'N V.B.
 5/8" GYPSUM BOARD
- R2. LAMINATED ASPHALT SHINGLES ON 7/16" ORIENTED STRAND BOARD C/W "H" CLIPS WD TRUSSES (DESIGNED BY MANUF.)
 1/2" ORIENTED STRAND BOARD VENTED SOFFIT
- R3. LAMINATED ASPHALT SHINGLES ON
 1/2" PLYWOOD SHEATHING C/W "H" CLIPS
 2×4 STRAPPING @ 16" O/C ON
 2×10 ROOF JOISTS @ 16" O/C
 R-28 BATT INSULATION
 1/2" EXTRUDED POLYSTYRENE INSULATION
 6 MIL POLY'N V.B.
 1/2" GYPSUM BOARD
- R4. PROVIDE 2 1/2" (63MM) CLEAR BETWEEN R-20 INSULATION AND SHEATHING.
 (MIN. R-20 @ ROOF-WALL CONNECTION FOR 4'-0" (1.2M) AROUND PERIMETER OF BUILDING. AIR VENTILATION BAFFLES TO BE INSTALLED WHERE REQUIRED IN AS PER BCBC 9.19.)
- R5. EAVE PROTECTION

 CONT. UP ROOF SLOPE FOR 12"

 PAST EXTERIOR WALL.
- R6. PROVIDE 1 SQ.FT. ATTIC VENT PER
 300 SQ.FT. OF INSULATED AREA MIN.
 25% OF REQUIRED TO BE @ TOP AND BOTTOM
 (TO COMPLY WI. B.C. BLDG. CODE 9.19.1)
- R7. PRE-FIN. FASCIA GUTTER
 2×8 FASCIA BD.
 2×4 SUB. FASCIA BD.
 VENTED SOFFIT
 (SEE CONTRACTOR)
- 28. PRE-FIN. FASCIA GUTTER
 2×8 FASCIA BD.
 2×4 SUB. FASCIA BD.
 1/2" ORIENTED STRAND BOARD
 VENTED SOFFIT

FLOORS

- FL1. FINISHED FLOORING ON
 11/16" ORIENTED STRAND BOARD
 (FASTENED & GLUED TO FLOOR STRUCT. BELOW) ON
 2×10 FLOOR JOISTS @ 16" OR 12" O/C
 C/W 2×2 X-BRIDGING @ 7.0' O/C (MAX)
 1/2" GYPSUM BOARD
- FL2. B.C. BUILDING CODE (TABLE-9.10.3.1.B)
 RATED FLOOR ASSEMBLY F8D

 S FINISHED FLOORING ON
 11/16" ORIENTED STRAND BOARD
 (FASTENED & GLUED TO FLOOR STRUCT. BELOW) ON
 2×10 FLOOR JOISTS @ 16" OR 12" O/C
 C/W 2×2 X-BRIDGING @ 7.0' O/C (MAX)
 R-31 INSULATION
 RESILIENT METAL CHANNELS @ 24" O/C
 1 LAYERS 5/8" X-TYPE GYPSUM BOARD
 30 MINUTE F.R.R., 50 S.T.C.
- FL3. FINISHED FLOORING ON

 11/16" ORIENTED STRAND BOARD

 (FASTENED & GLUED TO FLOOR STRUCT. BELOW) ON

 2×10 FLOOR JOISTS @ 16" OR 12" O/C

 C/W 2×2 X-BRIDGING @ 7.0' O/C (MAX)

 PROVIDE R-31 F/G BATT INSULATION IN

 JOIST CAVITY C/W

 BUILDING WRAP

 VENTED SOFFIT (TO OWNERS SPEC'S)

 TO ALL SUSPENDED FLOOR AREAS
- FL4. 3 1/2" CONCRETE SLAB 6 MIL. POLY'N V.B. 6" COMPACTED GRAVEL OR SAND
- FL5. 3 1/2" CONCRETE SLAB
 6 MIL. POLY'N V.B.
 6" COMPACTED GRAVEL OR SAND
 SLOPE TO DOORS 1"
 (NOT IN SECTION)

WALLS

- W1. DOUBLE GLAZING
 ENERGY STAR LOW "E" RATING IN
 THERMAL BREAK FRAMES
 2/2"X10" LINTEL OVER (@ bearing walls only)
 (TYPICAL, wi. 2 1/2" XPS insulation)
 FLASHING OVER @ EXTERIOR
 (glazing in all exterior doors & within 3 ft.
 of exterior doors to be shatterproof (SP))
 WINDOW REQUIREMENTS DERIVED FROM
 CITY OF COLWOOD BUILDING BYLAW
 AND ARE TO BE USED TO SATISFY
 THE REQUIREMENTS OF
 AAMA/WDMA/CSA 101/I.S.2/A440, "NAFS":
 COLWOOD, CLASS R PG30 (220) A3,
 RATINGS MUST BE CLEARLY LABELED ON ALL
- W2. CONC. FIBRE BOARD ON
 9.5MM (3/8") AIR SPACE / STRAPPING
 3/8"×2" BORATE TREATED PLYWOOD STRAPPING
 HOUSE WRAP (A.B.) (TYVEK OR EQ.)
 7/16" ORIENTED STRAND BOARD SHEATHING
 2×6 STUDS @ 16" O/C
 R-20 INSULATION
 6 MIL. POLYETHYLENE VAPOUR BARRIER

UNITS UPON INSTALLATION FOR INSPECTION.

W3. B.C. BUILDING CODE (TABLE 9.10.3.1.A)
RATED WALL ASSEMBLY W3c
1 LAYER 1/2" X-TYPE GYPSUM BOARD
RESILIENT METAL CHANNELS @ 24" O/C
2×4 STUDS @ 16" O/C OR
2×6 STUDS @ 16" O/C (IF NOTED) C/W
3 1/2" FIBRE GLASS SOUND BATTS
1 LAYER 1/2" X-TYPE GYPSUM BOARD
45 MIN. F.R.R 43 S.T.C
(BETWEEN PRIMARY LIVING & SECONDARY SUITE)

1/2" GYPSUM BOARD

FOUNDATION

- F1. DAMP PROOFING (WHERE REQUIRED) ON 8" THK. CONC. FOUNDATION WALL C/W 15 M BARS @ 24" O/C B/W
- F2. 16"X 8" CONC. FOOTINGS

 C/W 2 (TWO) 15M BARS CONT. 3 IN. FROM BOTT.

 ON UNDISTURBED SOIL (SOLID BEARING)
- F3. 4" PERIMETER DRAIN 3" TIGHT PIPE FOR RWL DRAIN ROCK
- F4. ANCHOR BOLTS @ 4.0 FT. O/C MAX C/W SILL GASKETS
- F5. STEP DOWN TO GARAGE SLAB MAY VARY, VERIFY EXTENT ON SITE (NOT IN SECTION)

Vol Victoria 9 design group

#103 - 891ATTREE AVENUE VICTORIA, B.C. V9B 0A6 P. 250.382.7374 F. 250.382.7364

Windward Traditonal

Date

Sept 14, 2023

Project Address

3445 Trumpeter Street Royal Bay - Sector 7 Colwood, B.C.


Prepared for Verity Construction

Project # 8298-36

Scale
As Noted

Drawn By

MRB

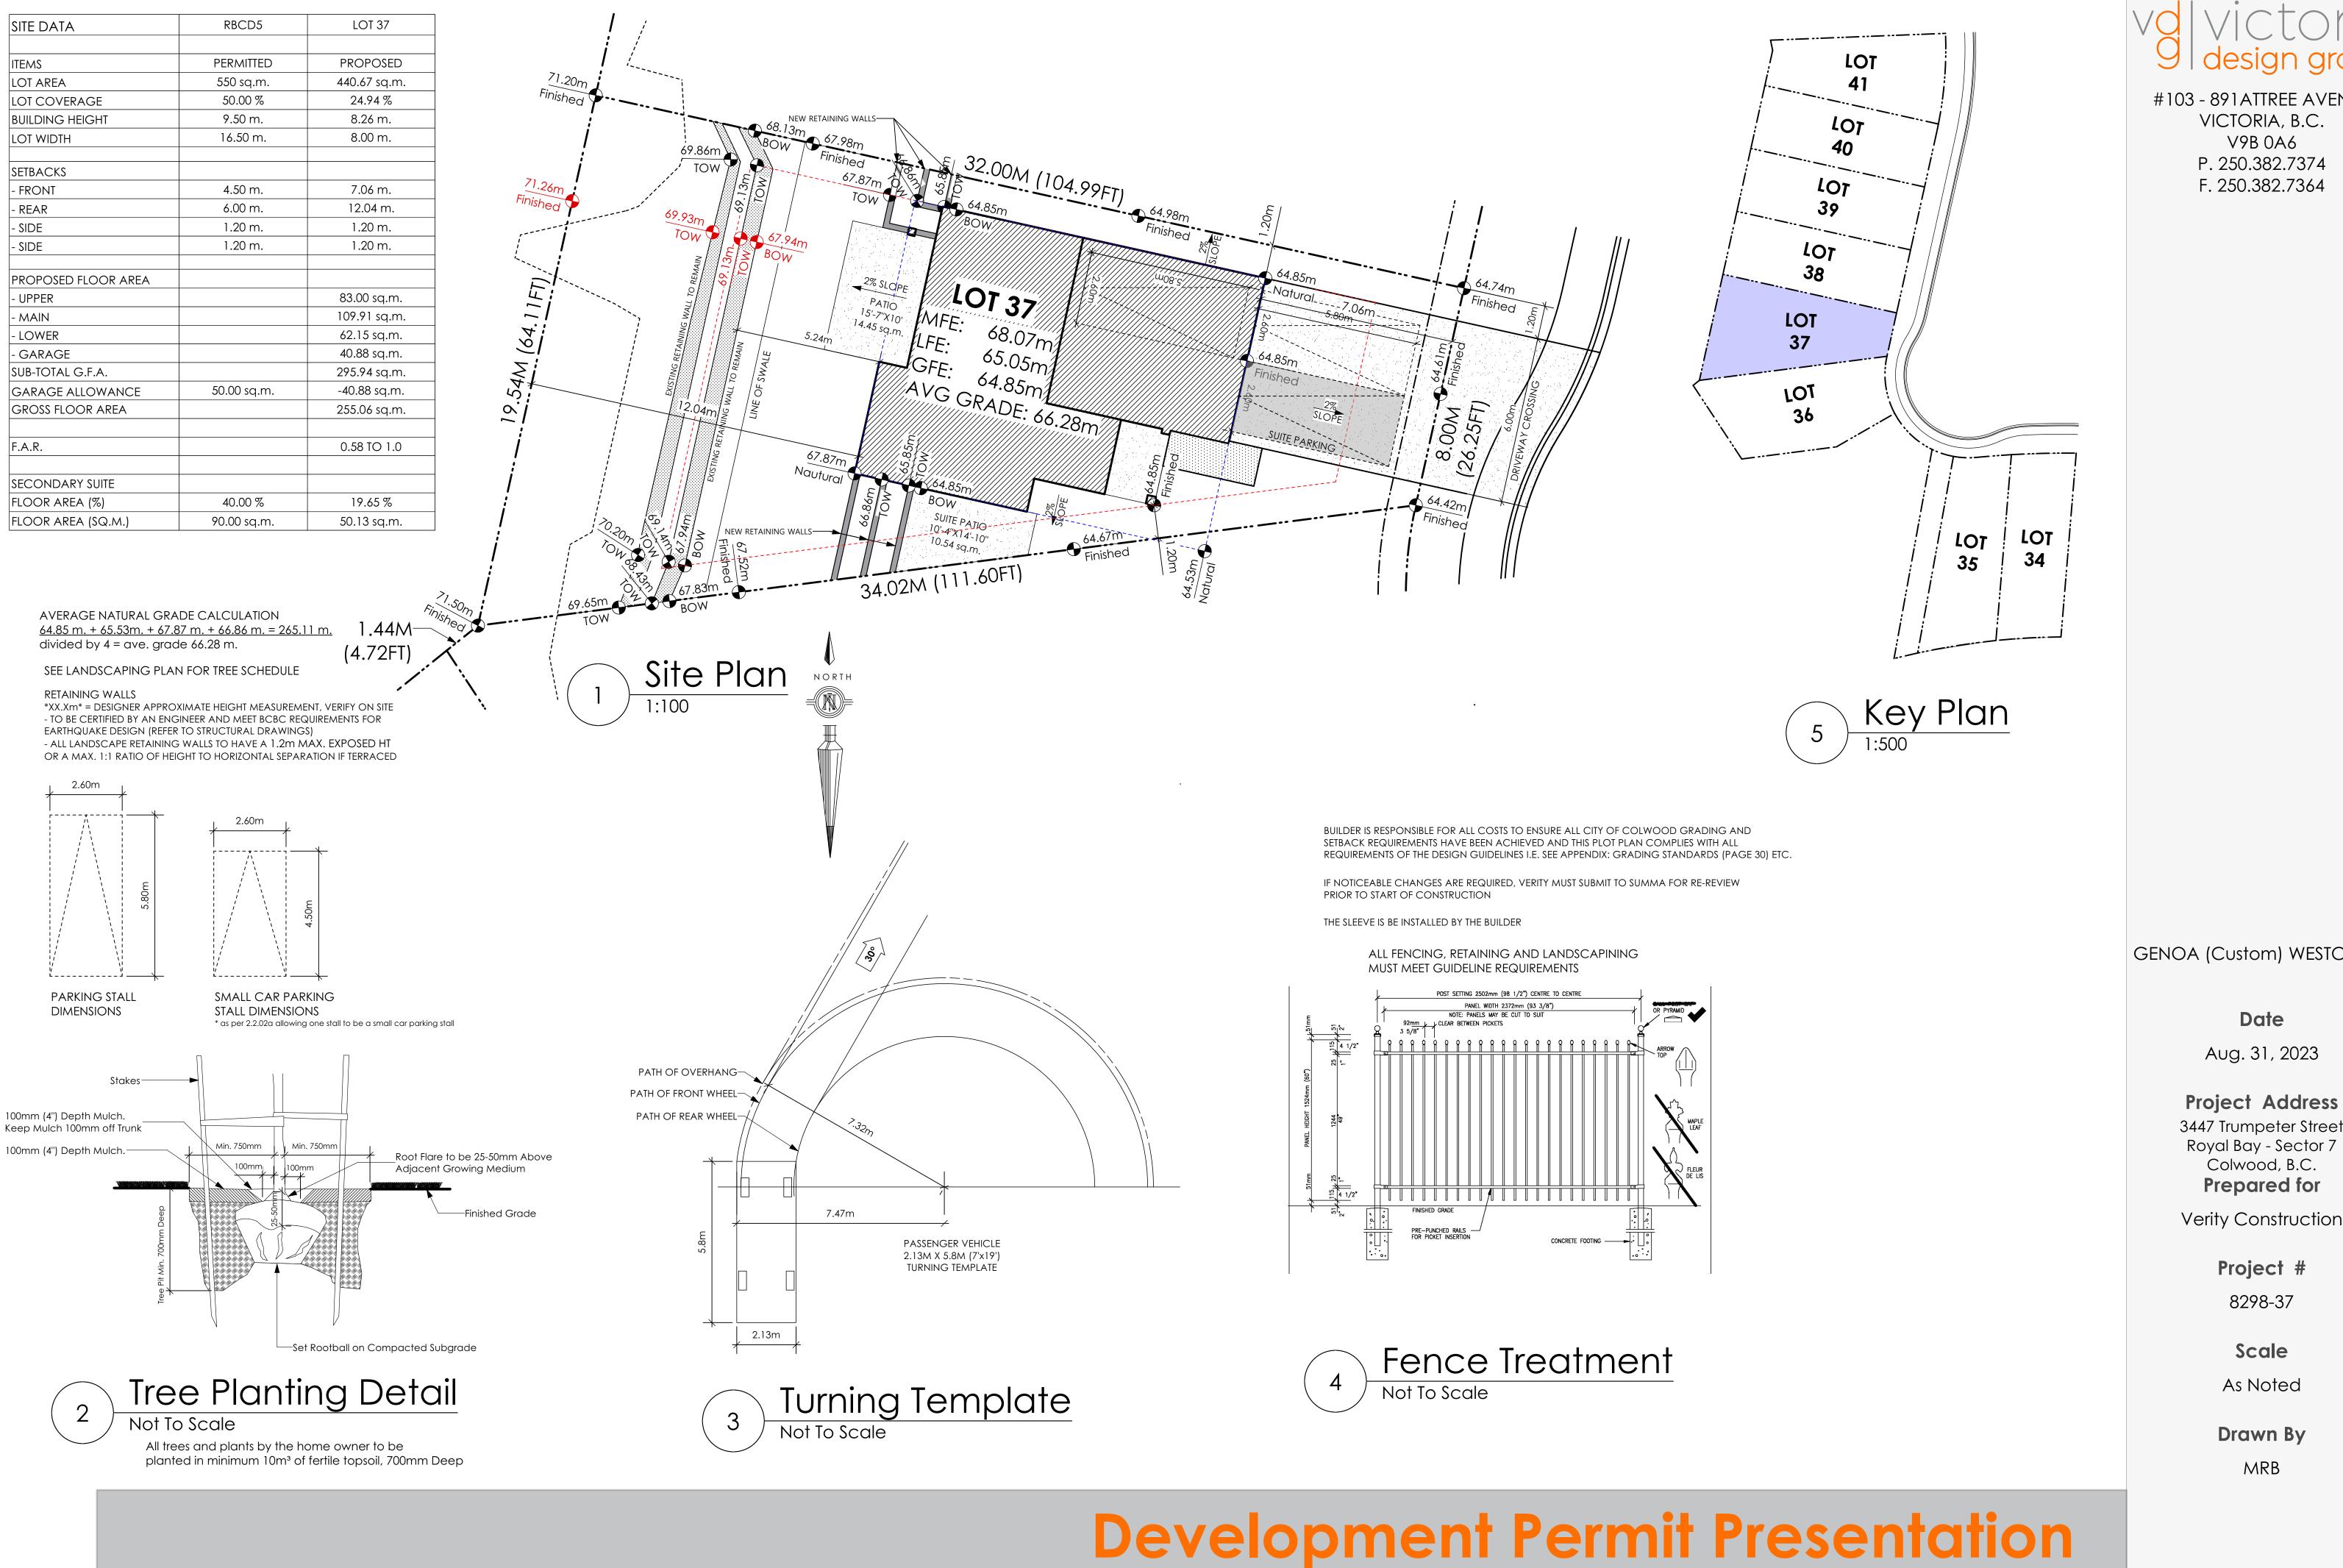



#103 - 891ATTREE AVENUE VICTORIA, B.C. V9B 0A6

GENOA (Custom) WESTCOAST

3447 Trumpeter Street Royal Bay - Sector 7 Colwood, B.C.

Verity Construction

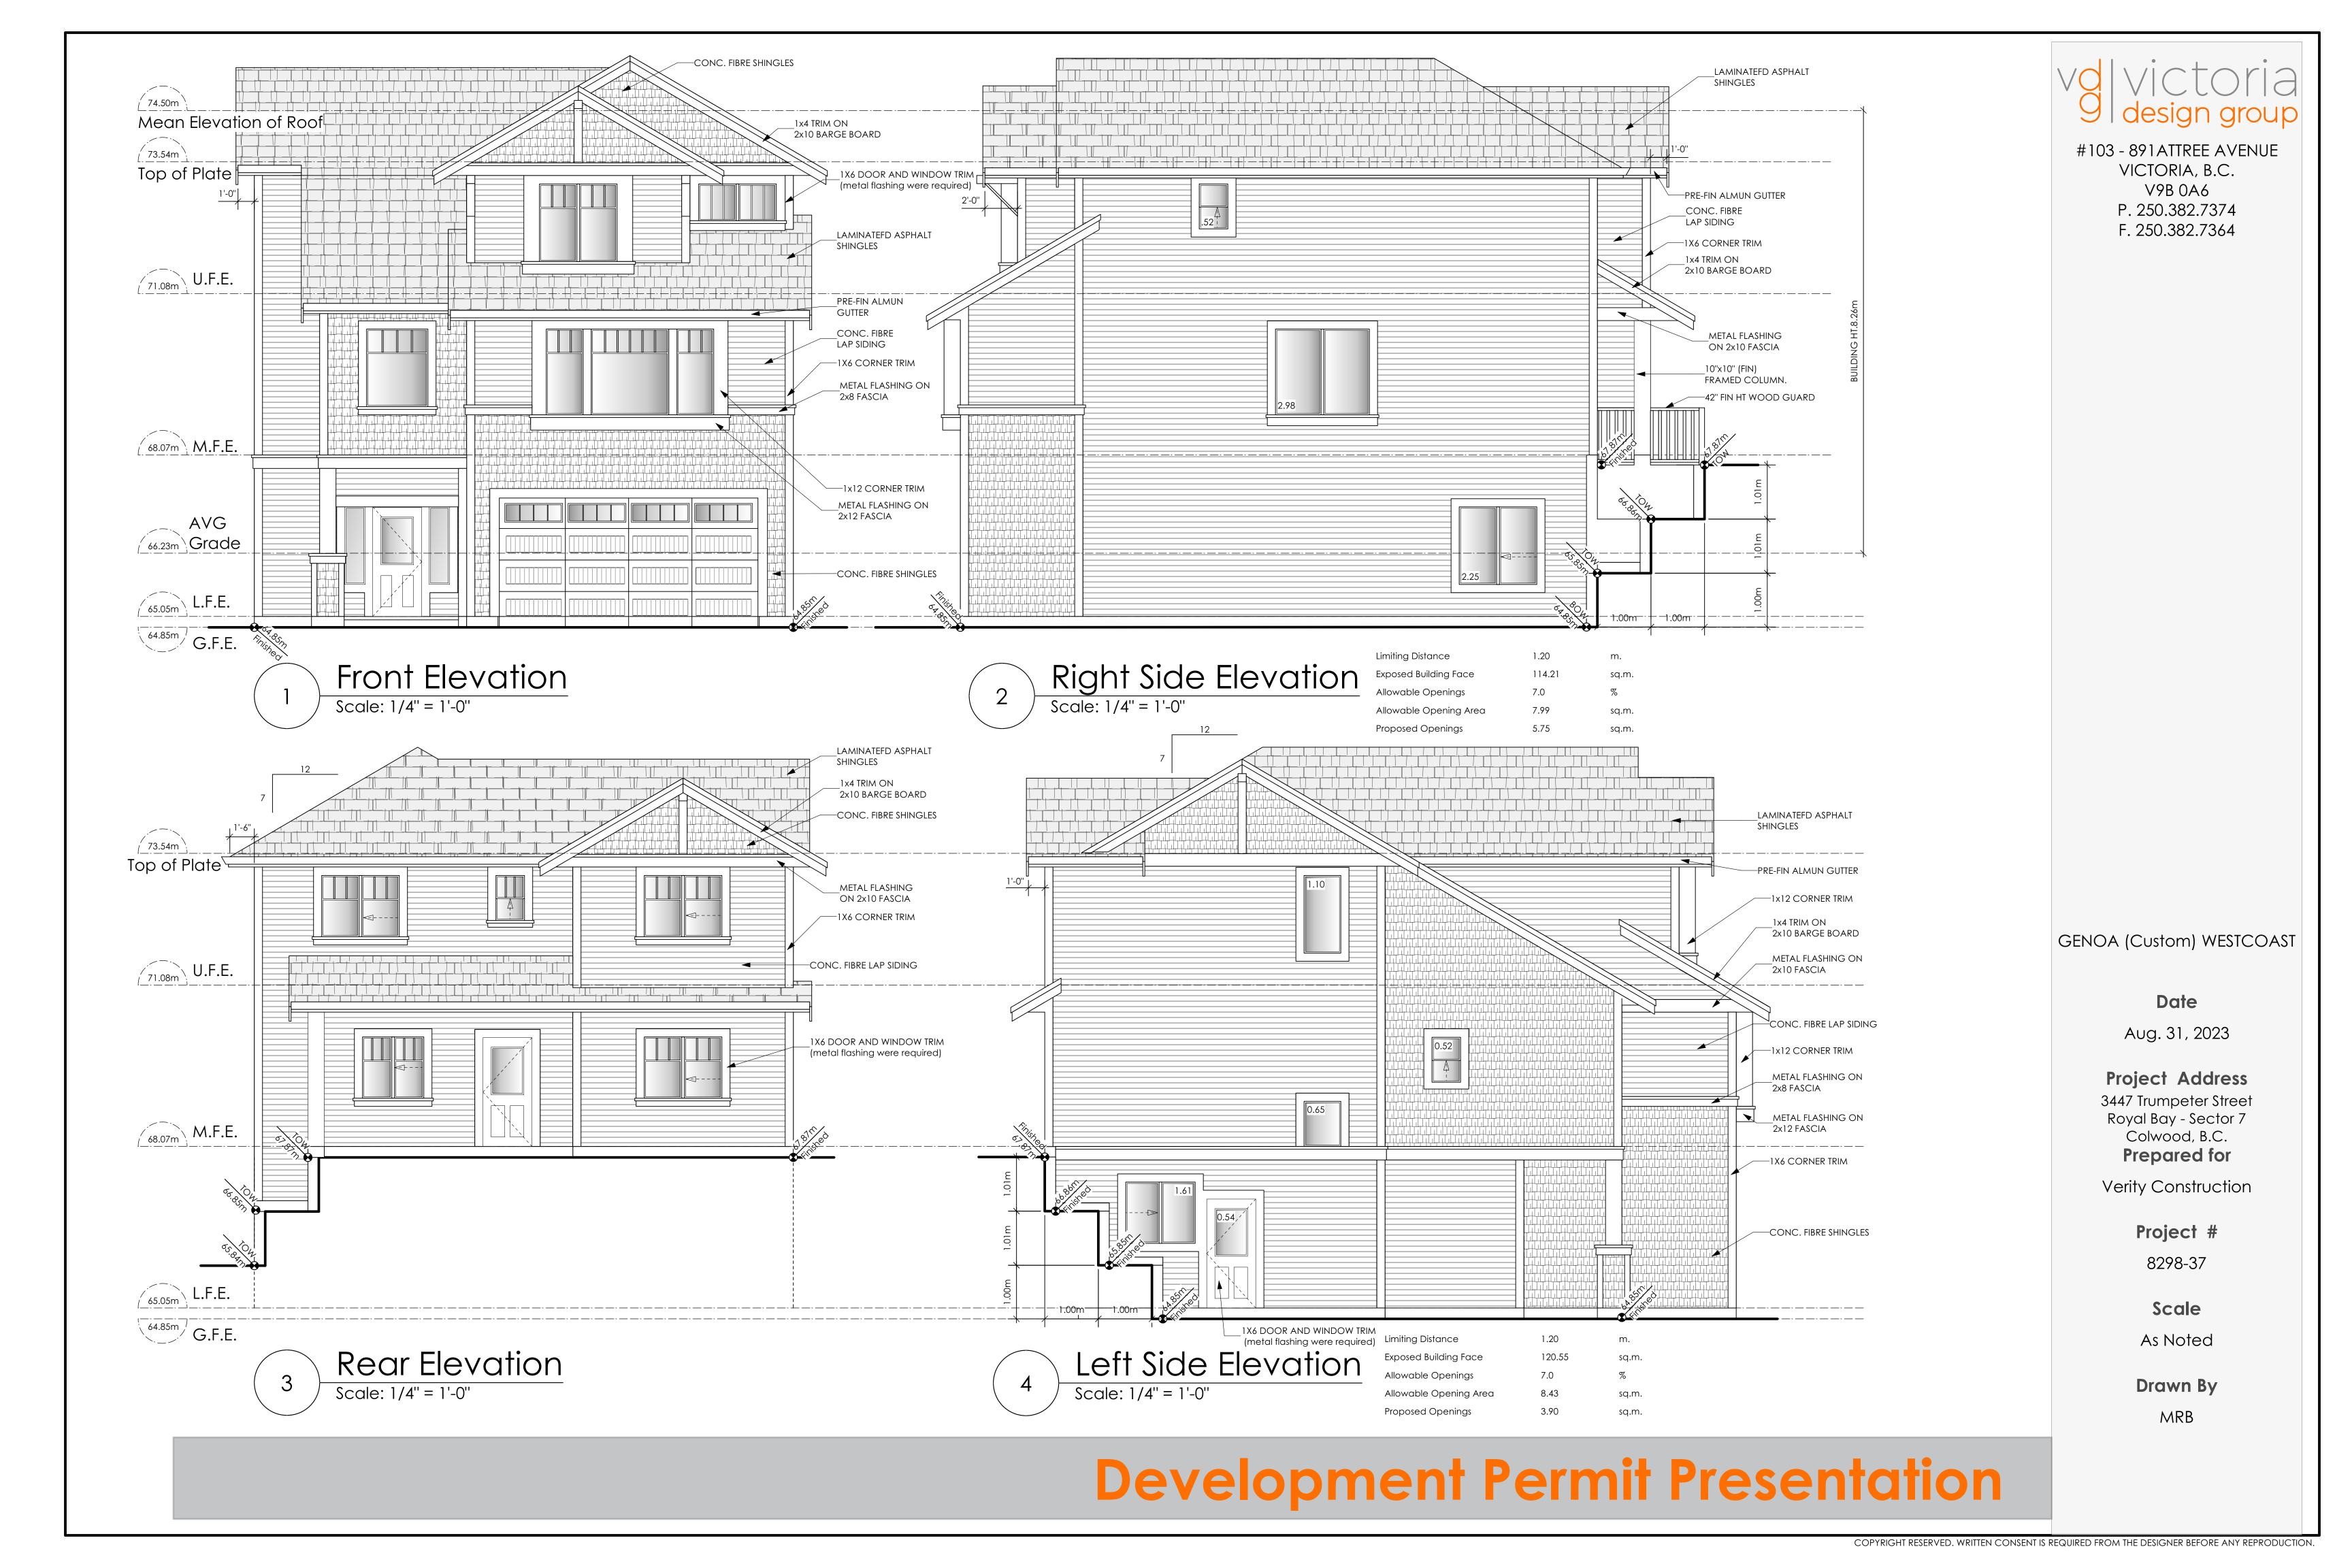

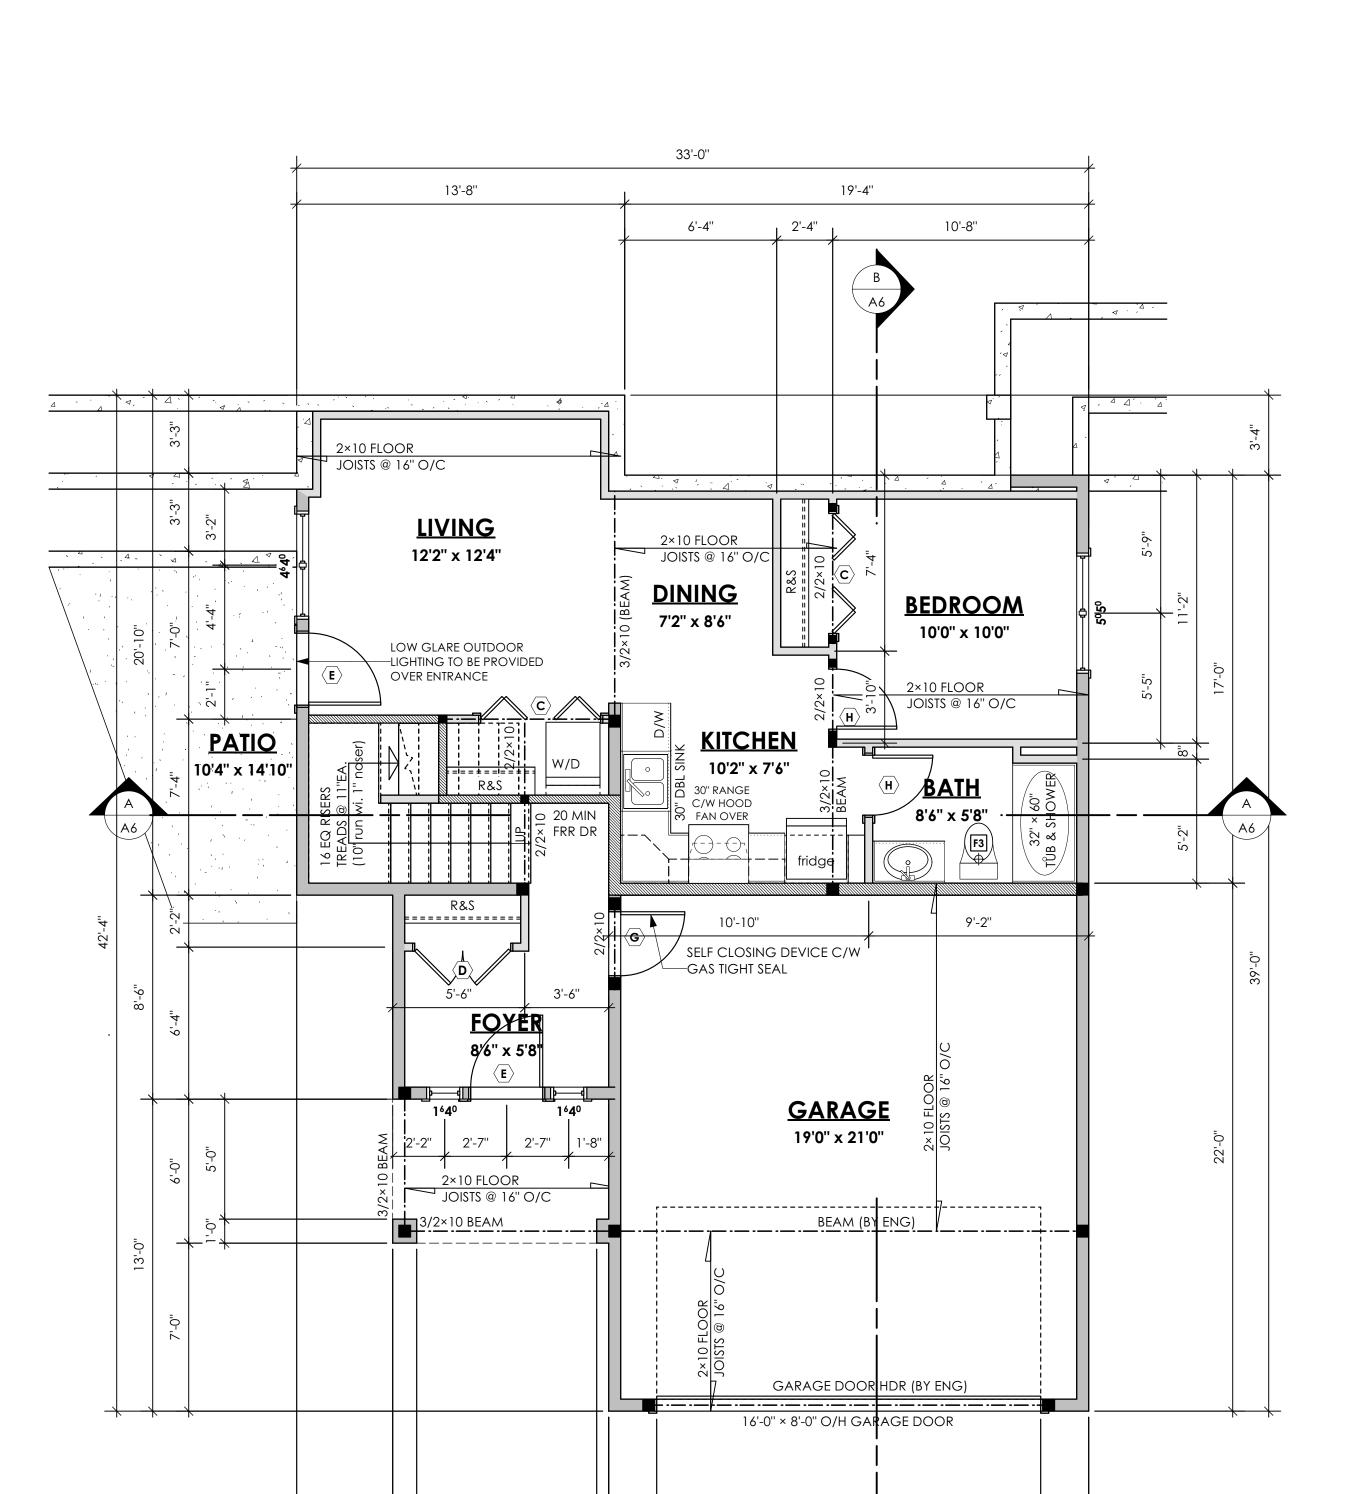



7'-6''

9'-0''

4'-0''

PRIMARY: 149.66 sq.ft. (12.02 sq.m.) <u>SUITE: 539.62 sq.ft. (50.13 sq.m.)</u> TOTAL: 689.28 sq.ft. (62.15 sq.m.) GARAGE: 440.00 sq.ft. (40.88 sq.m.) volvictoria design group

#103 - 891ATTREE AVENUE VICTORIA, B.C. V9B 0A6 P. 250.382.7374 F. 250.382.7364

GENOA (Custom) WESTCOAST

Date

Aug. 31, 2023

Project Address

3447 Trumpeter Street Royal Bay - Sector 7 Colwood, B.C. **Prepared for**

Verity Construction

Project #

8298-37

Scale

As Noted

Drawn By

MRB


Development Permit Presentation


16'-0''

20'-0"



#103 - 891 ATTREE AVENUE VICTORIA, B.C. V9B 0A6 P. 250.382.7374 F. 250.382.7364

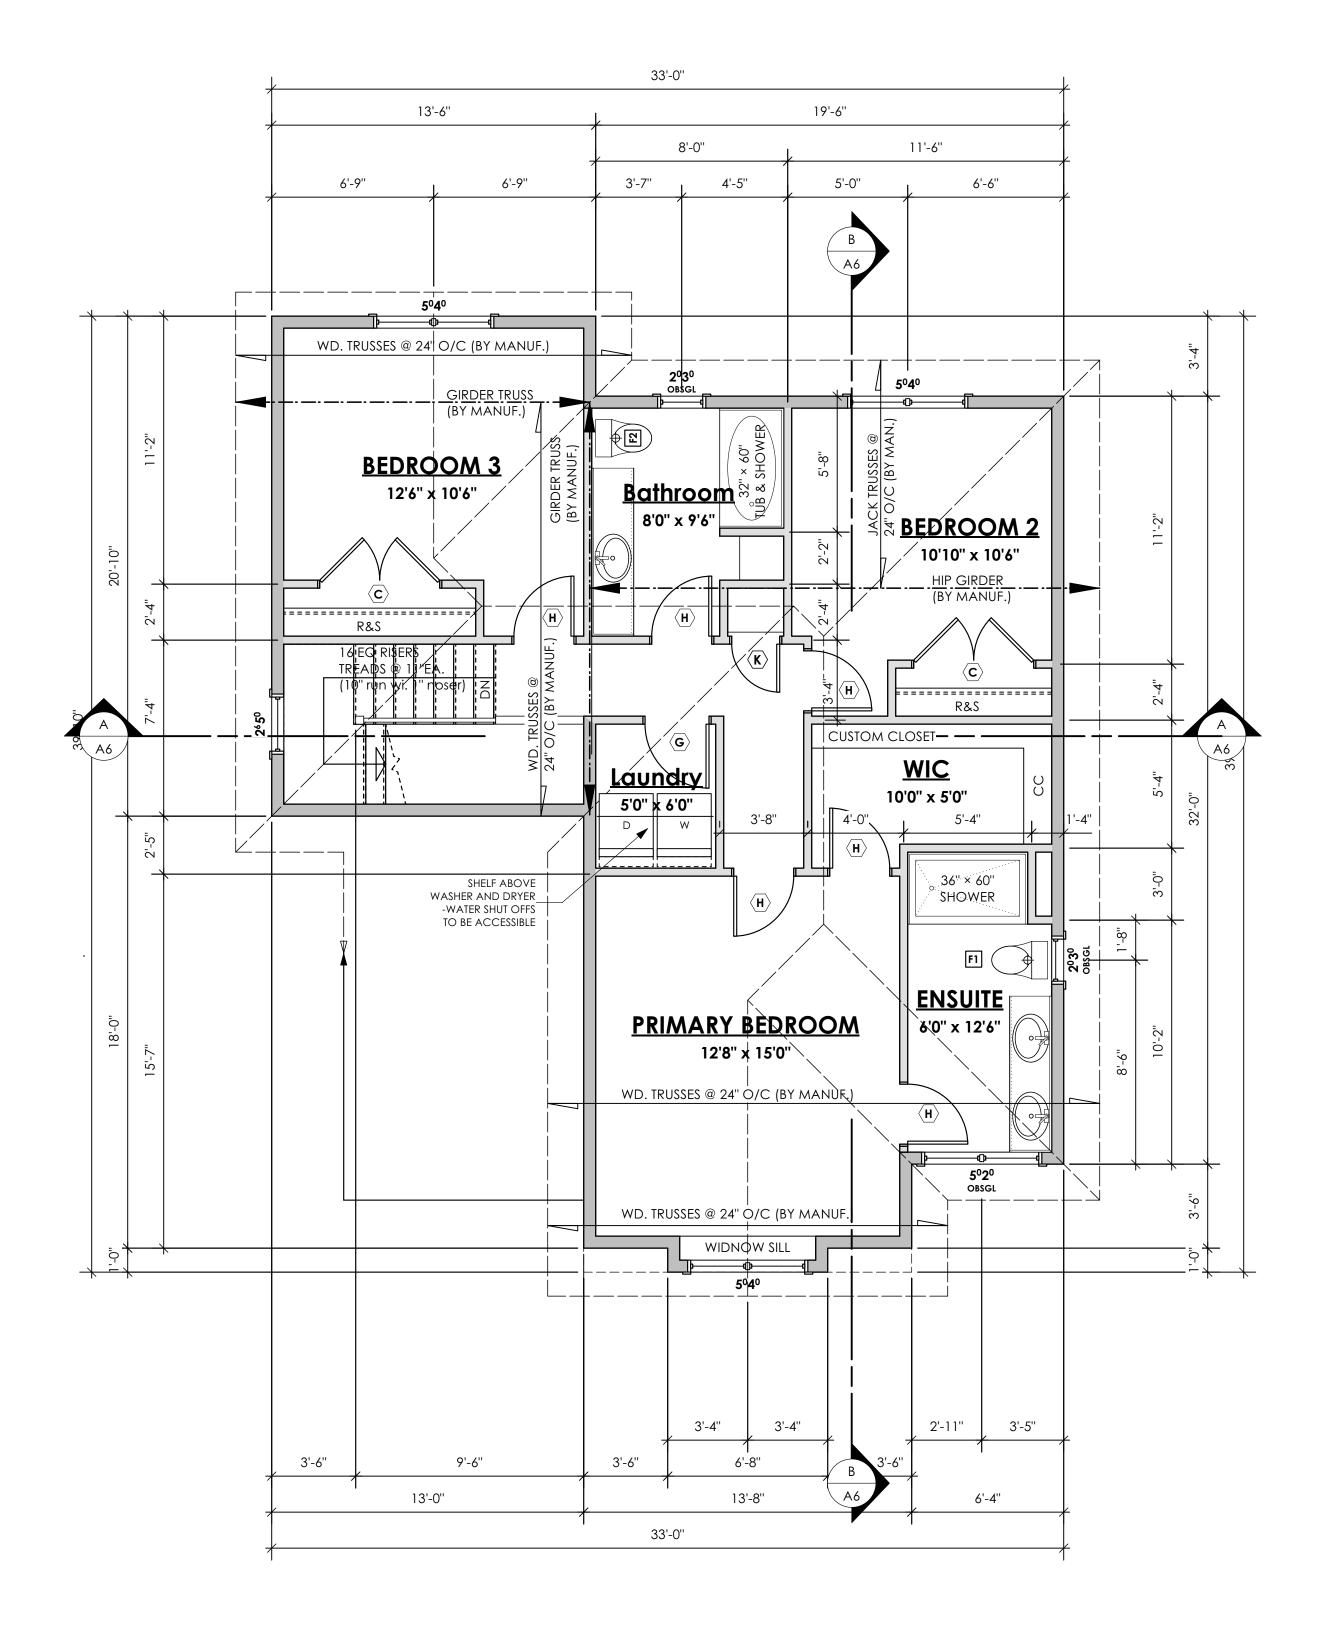

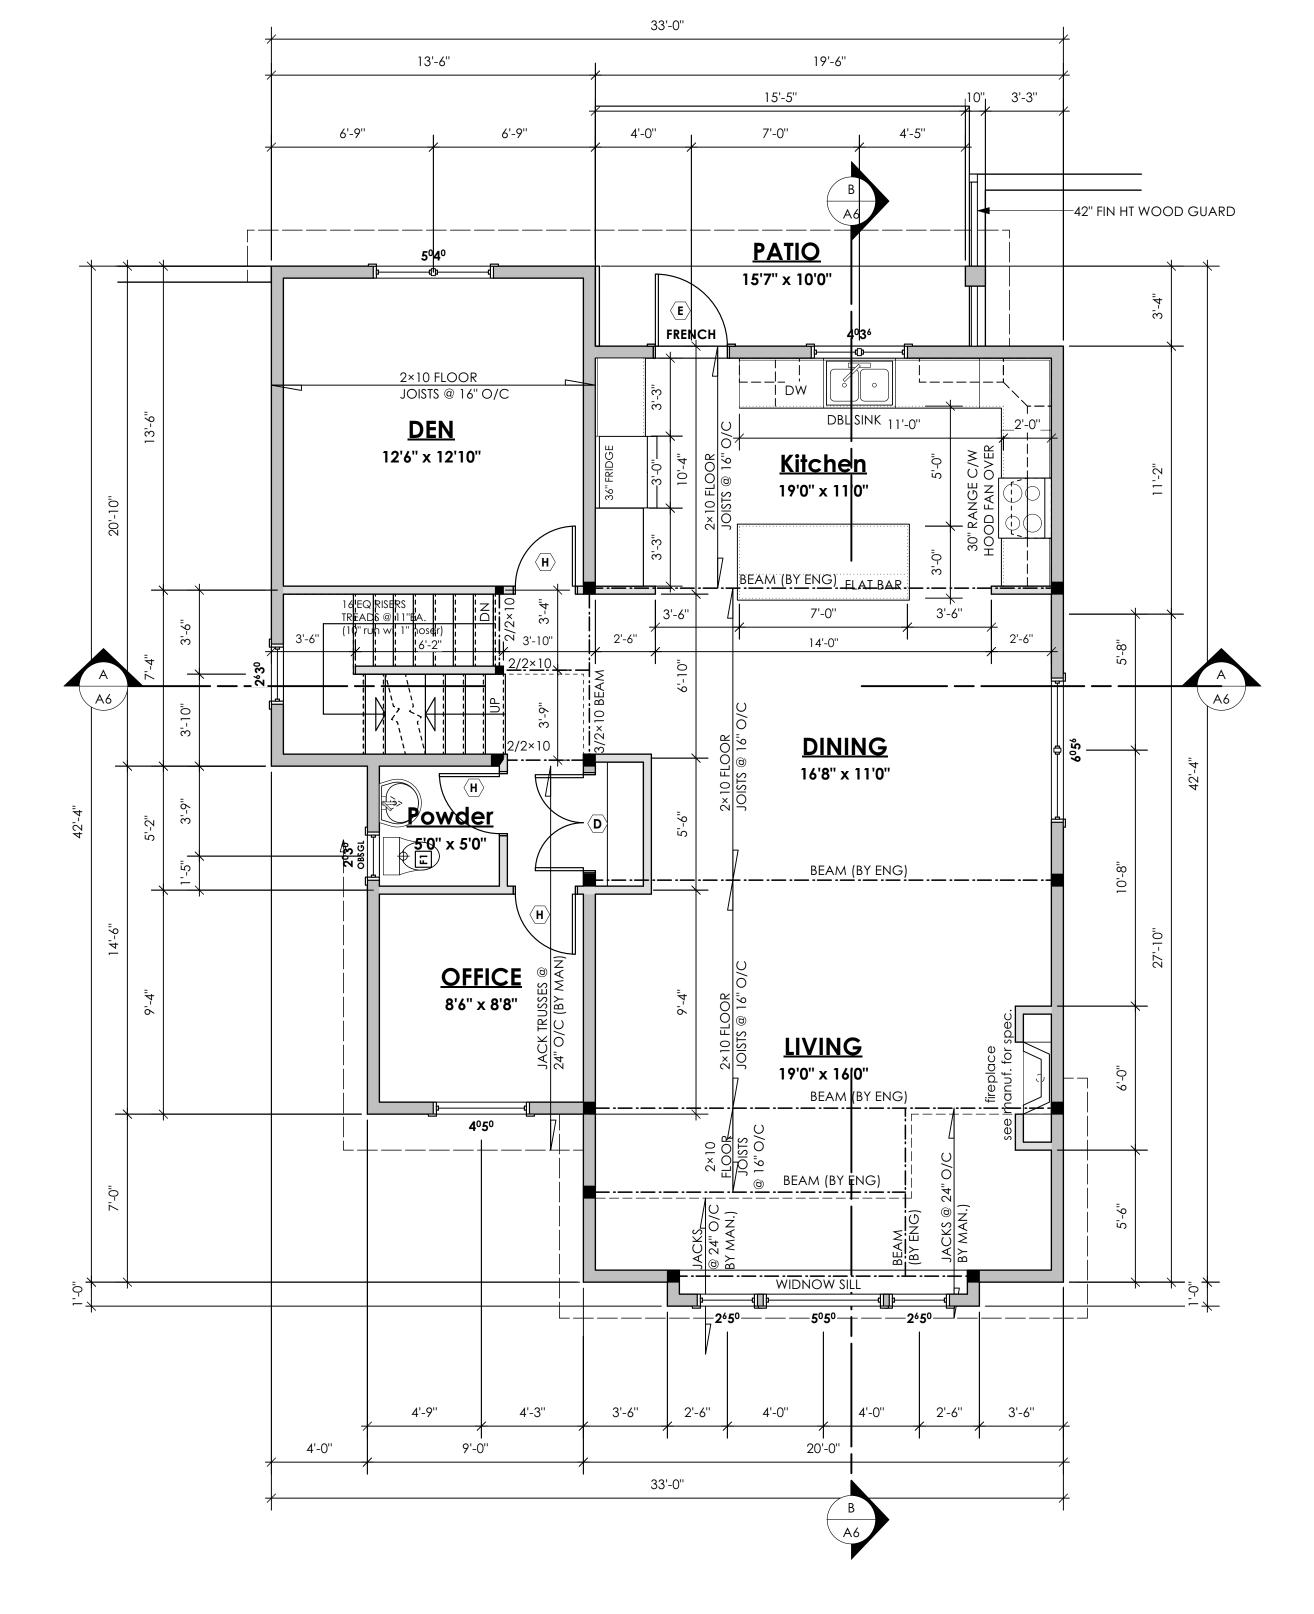



NOTE:
ALL STRUCTURE TO BE VERIFIED OR DESIGNED BY A STRUCTURAL ENGINEER.
STRUCTURAL ENGINEER TO LOCATE AND DESIGN REQUIRED EXTERIOR
AND INTERIOR WALL BRACING TO RESIST LATERAL LOADS IN COMPLIANCE
WITH B.C. BUILDING CODE 9.23.13. AND SUPPLY DETAILS IF REQUIRED

STRUCTURAL WOOD ELEMENTS WITHIN 150MM (6") FROM FINISHED GROUND LEVEL SHALL BE PRESSURE TREATED WITH A PRESERVATIVE FOR TERMITE AND DECAY PROTECTION B.C.B.C. 9.3.2.9.(3)



GENOA (Custom) WESTCOAST

Date

Aug. 31, 2023

Project Address 3447 Trumpeter Street

Royal Bay - Sector 7 Colwood, B.C. **Prepared for**

Verity Construction

Project #


8298-37

Scale

As Noted

Drawn By

MRB

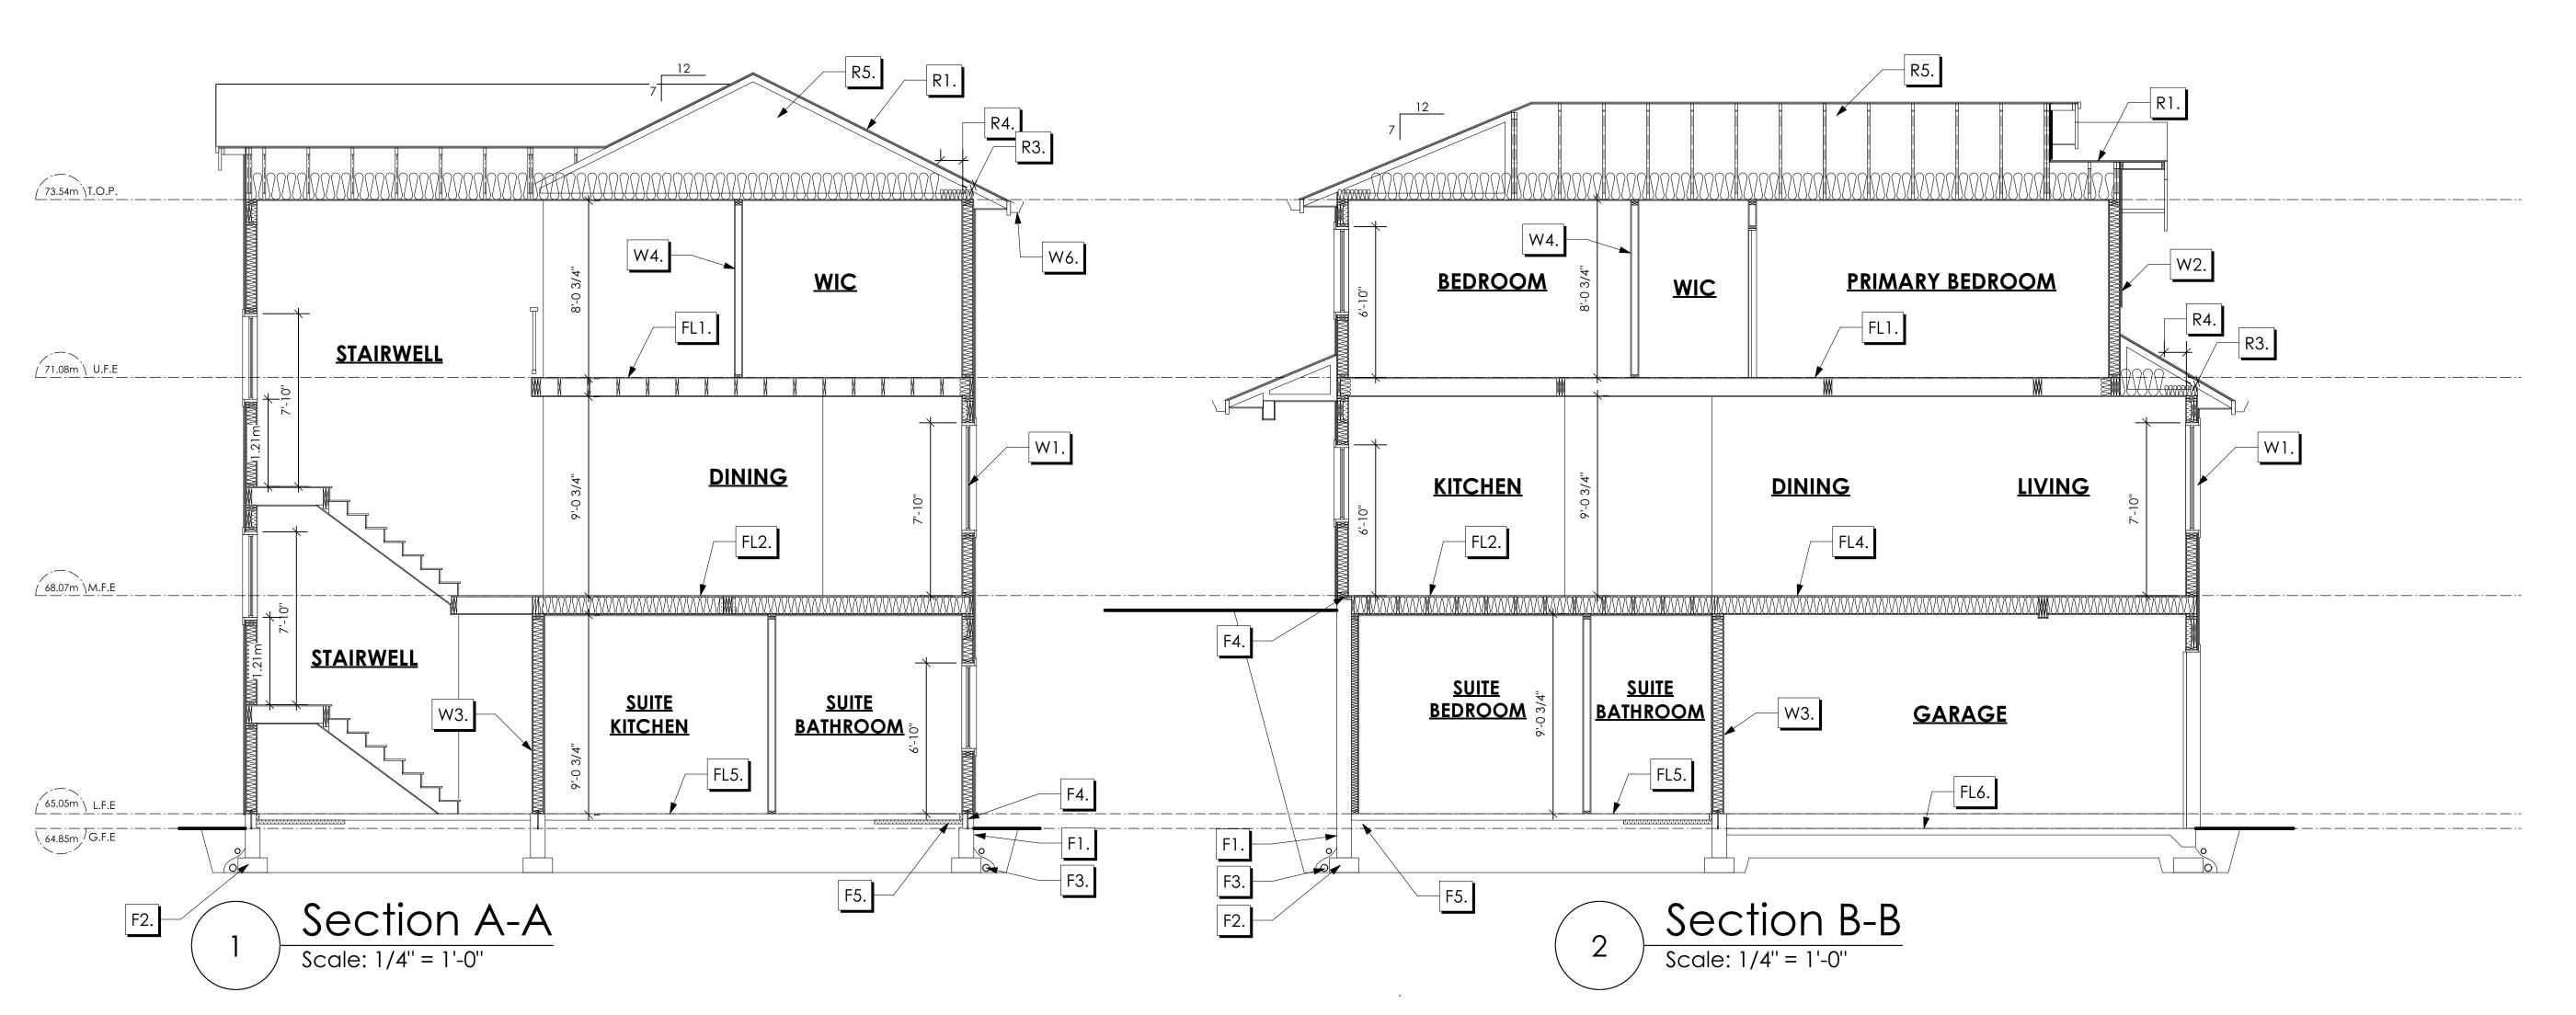

- R1. LAMINATED ASPHALT SHINGLES ON
 7/16" ORIENTED STRAND BOARD C/W "H" CLIPS
 WD TRUSSES (DESIGNED BY MANUF.)
 R-40 FIBRE GLAS BATT INSULATION OR
 14 1/2" FIBRE GLASS LOOSE FILL INSULATION
 6 MIL POLY'N V.B.
 5/8" GYPSUM BOARD
- R2. LAMINATED ASPHALT SHINGLES ON
 7/16" ORIENTED STRAND BOARD C/W "H" CLIPS
 WD TRUSSES (DESIGNED BY MANUF.)
 1/2" ORIENTED STRAND BOARD
 VENTED SOFFIT
- R3. PROVIDE 2 1/2" (63MM) CLEAR BETWEEN R-20 INSULATION AND SHEATHING.
 (MIN. R-20 @ ROOF-WALL CONNECTION FOR 4'-0" (1.2M) AROUND PERIMETER OF BUILDING. AIR VENTILATION BAFFLES TO BE INSTALLED WHERE REQUIRED IN AS PER BCBC 9.19.)
- R4. EAVE PROTECTION

 CONT. UP ROOF SLOPE FOR 12"

 PAST EXTERIOR WALL.
- R5. PROVIDE 1 SQ.FT. ATTIC VENT PER
 300 SQ.FT. OF INSULATED AREA MIN.
 25% OF REQUIRED TO BE @ TOP AND BOTTOM
 (TO COMPLY WI. B.C. BLDG. CODE 9.19.1)
- R6. PRE-FIN. FASCIA GUTTER
 2×8 FASCIA BD.
 2×4 SUB. FASCIA BD.
 VENTED SOFFIT
 (SEE CONTRACTOR)
- R7. PRE-FIN. FASCIA GUTTER

 2×8 FASCIA BD.

 2×4 SUB. FASCIA BD.

 1/2" ORIENTED STRAND BOARD

 VENTED SOFFIT

 (SEE CONTRACTOR)

- FL1. FINISHED FLOORING ON

 11/16" ORIENTED STRAND BOARD

 (FASTENED & GLUED TO FLOOR STRUCT. BELOW) ON

 2×10 FLOOR JOISTS @ 16" OR 12" O/C

 C/W 2×2 X-BRIDGING @ 7.0' O/C (MAX)

 1/2" GYPSUM BOARD
- FL2. B.C. BUILDING CODE (TABLE-9.10.3.1.B)
 RATED FLOOR ASSEMBLY F8D
 FINISHED FLOORING ON
 11/16" ORIENTED STRAND BOARD
 (FASTENED & GLUED TO FLOOR STRUCT. BELOW) ON
 2×10 FLOOR JOISTS @ 16" OR 12" O/C
 C/W 2×2 X-BRIDGING @ 7.0' O/C (MAX)
 R-31 INSULATION
 RESILIENT METAL CHANNELS @ 24" O/C
 1 LAYERS 5/8" X-TYPE GYPSUM BOARD
 30 MINUTE F.R.R., 50 S.T.C.
- FL3. FINISHED FLOORING ON

 11/16" ORIENTED STRAND BOARD

 (FASTENED & GLUED TO FLOOR STRUCT. BELOW) ON

 2×10 FLOOR JOISTS @ 16" OR 12" O/C

 C/W 2×2 X-BRIDGING @ 7.0' O/C (MAX)

 PROVIDE R-31 F/G BATT INSULATION IN

 JOIST CAVITY C/W

 BUILDING WRAP

 VENTED SOFFIT (TO OWNERS SPEC'S)

 TO ALL SUSPENDED FLOOR AREAS
- FL4. FINISHED FLOORING ON
 19/32" ORIENTED STRAND BOARD
 (NAILED & GLUED TO FLOOR STRUCT. BELOW) ON
 2×10 FLOOR JOISTS @ 16" OR 12" O/C
 C/W 2×2 X-BRIDGING @ 7.0' O/C (MAX)
 R-31 INSULATION
 5/8" X-TYPE GYPSUM BOARD
 (BETWEEN GARAGE AND LIVING SPACE)
- FL5. 3 1/2" CONCRETE SLAB
 6 MIL. POLY'N V.B.
 6" COMPACTED GRAVEL OR SAND
- FL6. 3 1/2" CONCRETE SLAB
 6 MIL. POLY'N V.B.
 6" COMPACTED GRAVEL OR SAND
 SLOPE TO DOORS 1"
 (NOT IN SECTION)

- W1. DOUBLE GLAZING
 ENERGY STAR LOW "E" RATING IN
 THERMAL BREAK FRAMES
 2/2"X10" LINTEL OVER (@ bearing walls only)
 (TYPICAL, wi. 2 1/2" XPS insulation)
 FLASHING OVER @ EXTERIOR
 (glazing in all exterior doors & within 3 ft.
 of exterior doors to be shatterproof (SP))
 WINDOW REQUIREMENTS DERIVED FROM
 CITY OF COLWOOD BUILDING BYLAW
 AND ARE TO BE USED TO SATISFY
- THE REQUIREMENTS OF
 AAMA/WDMA/CSA 101/I.S.2/A440, "NAFS":
 COLWOOD, CLASS R PG30 (220) A3,
 RATINGS MUST BE CLEARLY LABELED ON ALL
 UNITS UPON INSTALLATION FOR INSPECTION.

 W2. CONC. FIBRE BOARD ON
- 9.5MM (3/8") AIR SPACE / STRAPPING
 3/8"×2" BORATE TREATED PLYWOOD STRAPPING
 HOUSE WRAP (A.B.) (TYVEK OR EQ.)
 7/16" ORIENTED STRAND BOARD SHEATHING
 2×6 STUDS @ 16" O/C
 R-20 INSULATION
 6 MIL. POLYETHYLENE VAPOUR BARRIER
 1/2" GYPSUM BOARD
- W3. B.C. BUILDING CODE (TABLE 9.10.3.1.A)
 RATED WALL ASSEMBLY W3C
 1 LAYER 1/2" X-TYPE GYPSUM BOARD
 RESILIENT METAL CHANNELS @ 24" O/C
 2×4 STUDS @ 16" O/C OR
 2×6 STUDS @ 16" O/C (IF NOTED) C/W
 3 1/2" FIBRE GLASS SOUND BATTS
 1 LAYER 1/2" X-TYPE GYPSUM BOARD
 45 MIN. F.R.R 43 S.T.C
 (BETWEEN PRIMARY LIVING & SECONDARY SUITE)

- W4. INTERIOR PARTITION

 1/2" GYPSUM BOARD ON EACH SIDE

 OF 2×4 STUDS @ 16" O/C OR

 2×6 STUDS @ 16" O/C (IF NOTED)
- W5. 5/8" X-TYPE GYPSUM BOARD ON 2×6 STUDS @ 16" O/C C/W
 R-20 INSULATION
 6 MIL. POLY'N V.B
 1/2" GYPSUM BOARD
 (BETWEEN GARAGE & LIVING)
 (not in section)
- W6. 1/2" GYPSUM BOARD ON
 6 MIL. POLY'N V.B.
 2×4 STUDS @ 24" O/C C/W
 R-12 BATT INSULATION
 BUILDING WRAP OR
 12.7MM (1/2") AIR SPACE
 (PROVIDE REQUIRED FIRE STOPS IN WALL
 ASSEMBLIES TO COMPLY WITH

B.C. BLDG. CODE 9.10.16.)

- F1. DAMP PROOFING (WHERE REQUIRED) ON 8" THK. CONC. FOUNDATION WALL C/W 15 M BARS @ 24" O/C B/W
- F2. 16"X 8" CONC. FOOTINGS

 C/W 2 (TWO) 15M BARS CONT. 3 IN. FROM BOTT.

 ON UNDISTURBED SOIL (SOLID BEARING)
- F3. 4" PERIMETER DRAIN
 3" TIGHT PIPE FOR RWL
 DRAIN ROCK
- F4. ANCHOR BOLTS @ 4.0 FT. O/C MAX C/W SILL GASKETS
- F5. STEP DOWN TO GARAGE SLAB MAY VARY, VERIFY EXTENT ON SITE (NOT IN SECTION)

volvictoria 9 design group

#103 - 891ATTREE AVENUE VICTORIA, B.C. V9B 0A6 P. 250.382.7374 F. 250.382.7364

GENOA (Custom) WESTCOAST

Date

Aug. 31, 2023

Project Address

3447 Trumpeter Street Royal Bay - Sector 7 Colwood, B.C. **Prepared for**

Verity Construction

Project #


8298-37

Scale

As Noted


Drawn By

MRB

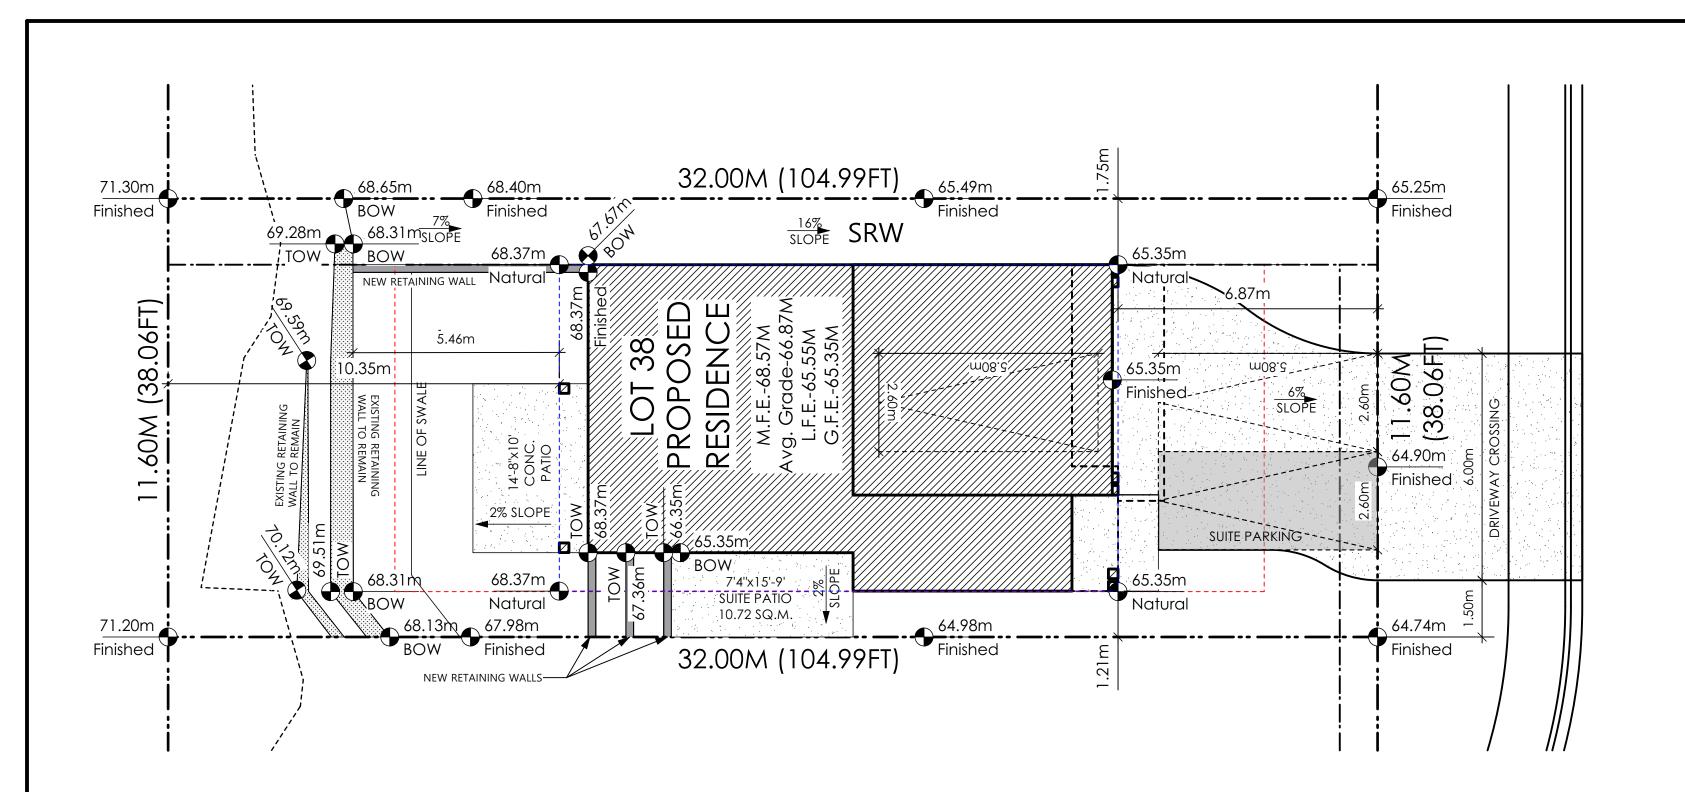



#103 - 891ATTREE AVENUE VICTORIA, B.C. V9B 0A6 P. 250.382.7374 F. 250.382.7364

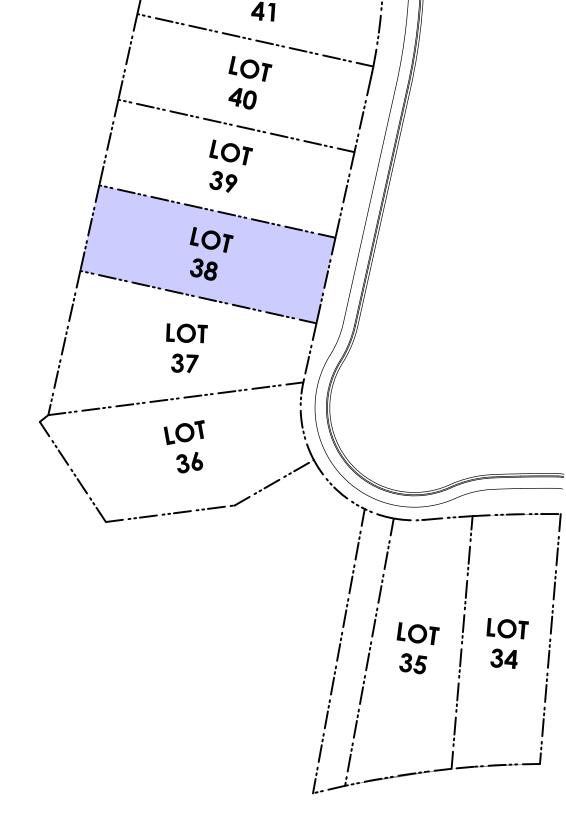

THE SLEEVES TO BE INSTALLED BY THE BUILDER RBCD5 LOT 38

BUILDER IS RESPONSIBLE FOR ALL COSTS TO ENSURE ALL CITY OF COLWOOD GRADING AND SETBACK REQUIREMENTS HAVE BEEN ACHIEVED AND THIS PLOT PLAN COMPLIES WITH ALL REQUIREMENTS OF THE DESIGN GUIDELINES I.E. SEE APPENDIX: GRADING STANDARDS (PAGE 30) ETC.

1: ENSURE A MINIMUM 2% SLOPE AWAY FROM STRUCTURE ON ALL SIDES 2: ALL RETAINING REQUIRED MUST MEET GUIDELINE REQUIREMENTS

PATH OF OVERHANG PATH OF FRONT WHEEL PATH OF REAR WHEEL-


7.47m

2.13m

PASSENGER VEHICLE 2.13M X 5.8M (7'x19') TURNING TEMPLATE

Turning Template

ALL FENCING, RETAINING AND LANDSCAPINING MUST MEET GUIDELINE REQUIREMENTS

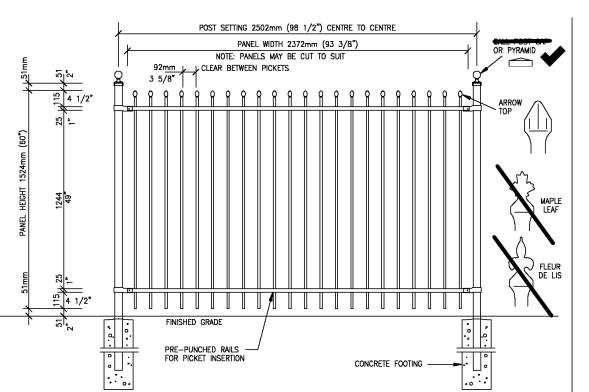

Fence Treatment

Not To Scale

(SEE LANDSCAPE PLAN FOR FENCE LOCATION)

Leeward Westcoast

Date

Aug. 31, 2023

Project Address

3449 Trumpeter Street Royal Bay - Sector 7 Colwood, B.C. Prepared for

Verity Construction

Project #

8298-38


Scale

As Noted

Drawn By

MRB

Development Permit Presentation

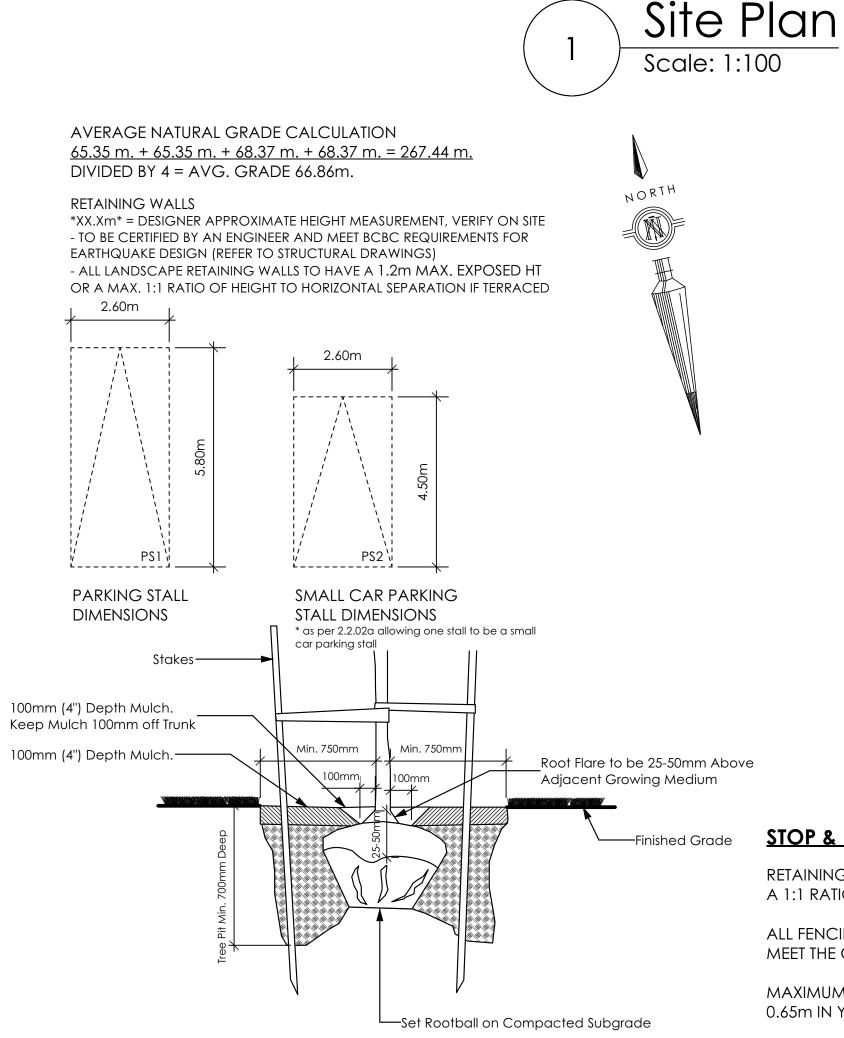

PERMITTED PROPOSED 368 371.20 sq.m. LOT AREA 50.00 % 31.43 % OT COVERAGE BUILDING HEIGHT 9.50 m. 8.63 m. 10.97 m. 11.60 m. LOT WIDTH SETBACKS FRONT 4.50 m. 6.87 m. 6.00 m. 10.35 m. 1.20 m. 1.21 m. - SIDE 1.20 m. 1.75 m. PROPOSED FLOOR AREA 89.72 sq.m. 100.36 sq.m. MAIN LOWER 68.13 sq.m. - GARAGE 41.81 sq.m. SUB-TOTAL G.F.A. 300.02 sq.m. 50.00 sq.m. -41.81 sq.m. GARAGE ALLOWANCE GROSS FLOOR AREA 258.21 sq.m. F.A.R. 0.70 TO 1.0 SECONDARY SUITE 40.00 % FLOOR AREA (%) 20.74 % FLOOR AREA (SQ.M.) 90.00 sq.m. 53.54 sq.m.

STOP & READ

RETAINING WALLS <u>MAY NOT</u> EXCEED 1.2m IN HEIGHT OR A 1:1 RATIO OF HEIGHT TO HORIZONTAL SEPARATION IF TERRACED

ALL FENCING, RETAINING AND LANDSCAPING MUST MEET THE GUIDELINE REQUIREMENTS

SITE DATA

MAXIMUM PROJECTIONS / CANTILEVERS / OVERHANGS INTO SETBACKS ARE 0.65m IN YARDS OF LESS THAN 3.0m AND 1.0m IN YARDS OF 3.0m+.


THE WIDTH OF THE DRIVEWAY ACCESS (AT PROPERTY LINE - CROSSING THE CITY BOULEVARD) MAY NOT EXCEED 7.0m IN WIDTH


CONTRACTOR TO ENSURE A MINIMUM 2% SLOPE SIDE YARD SWALING (BOTH SIDES) MAY BE REQUIRED

Tree Planting Detail Not To Scale All trees and plants by the home owner to be

planted in minimum 10m³ of fertile topsoil, 700mm Deep

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vol Victoria design group
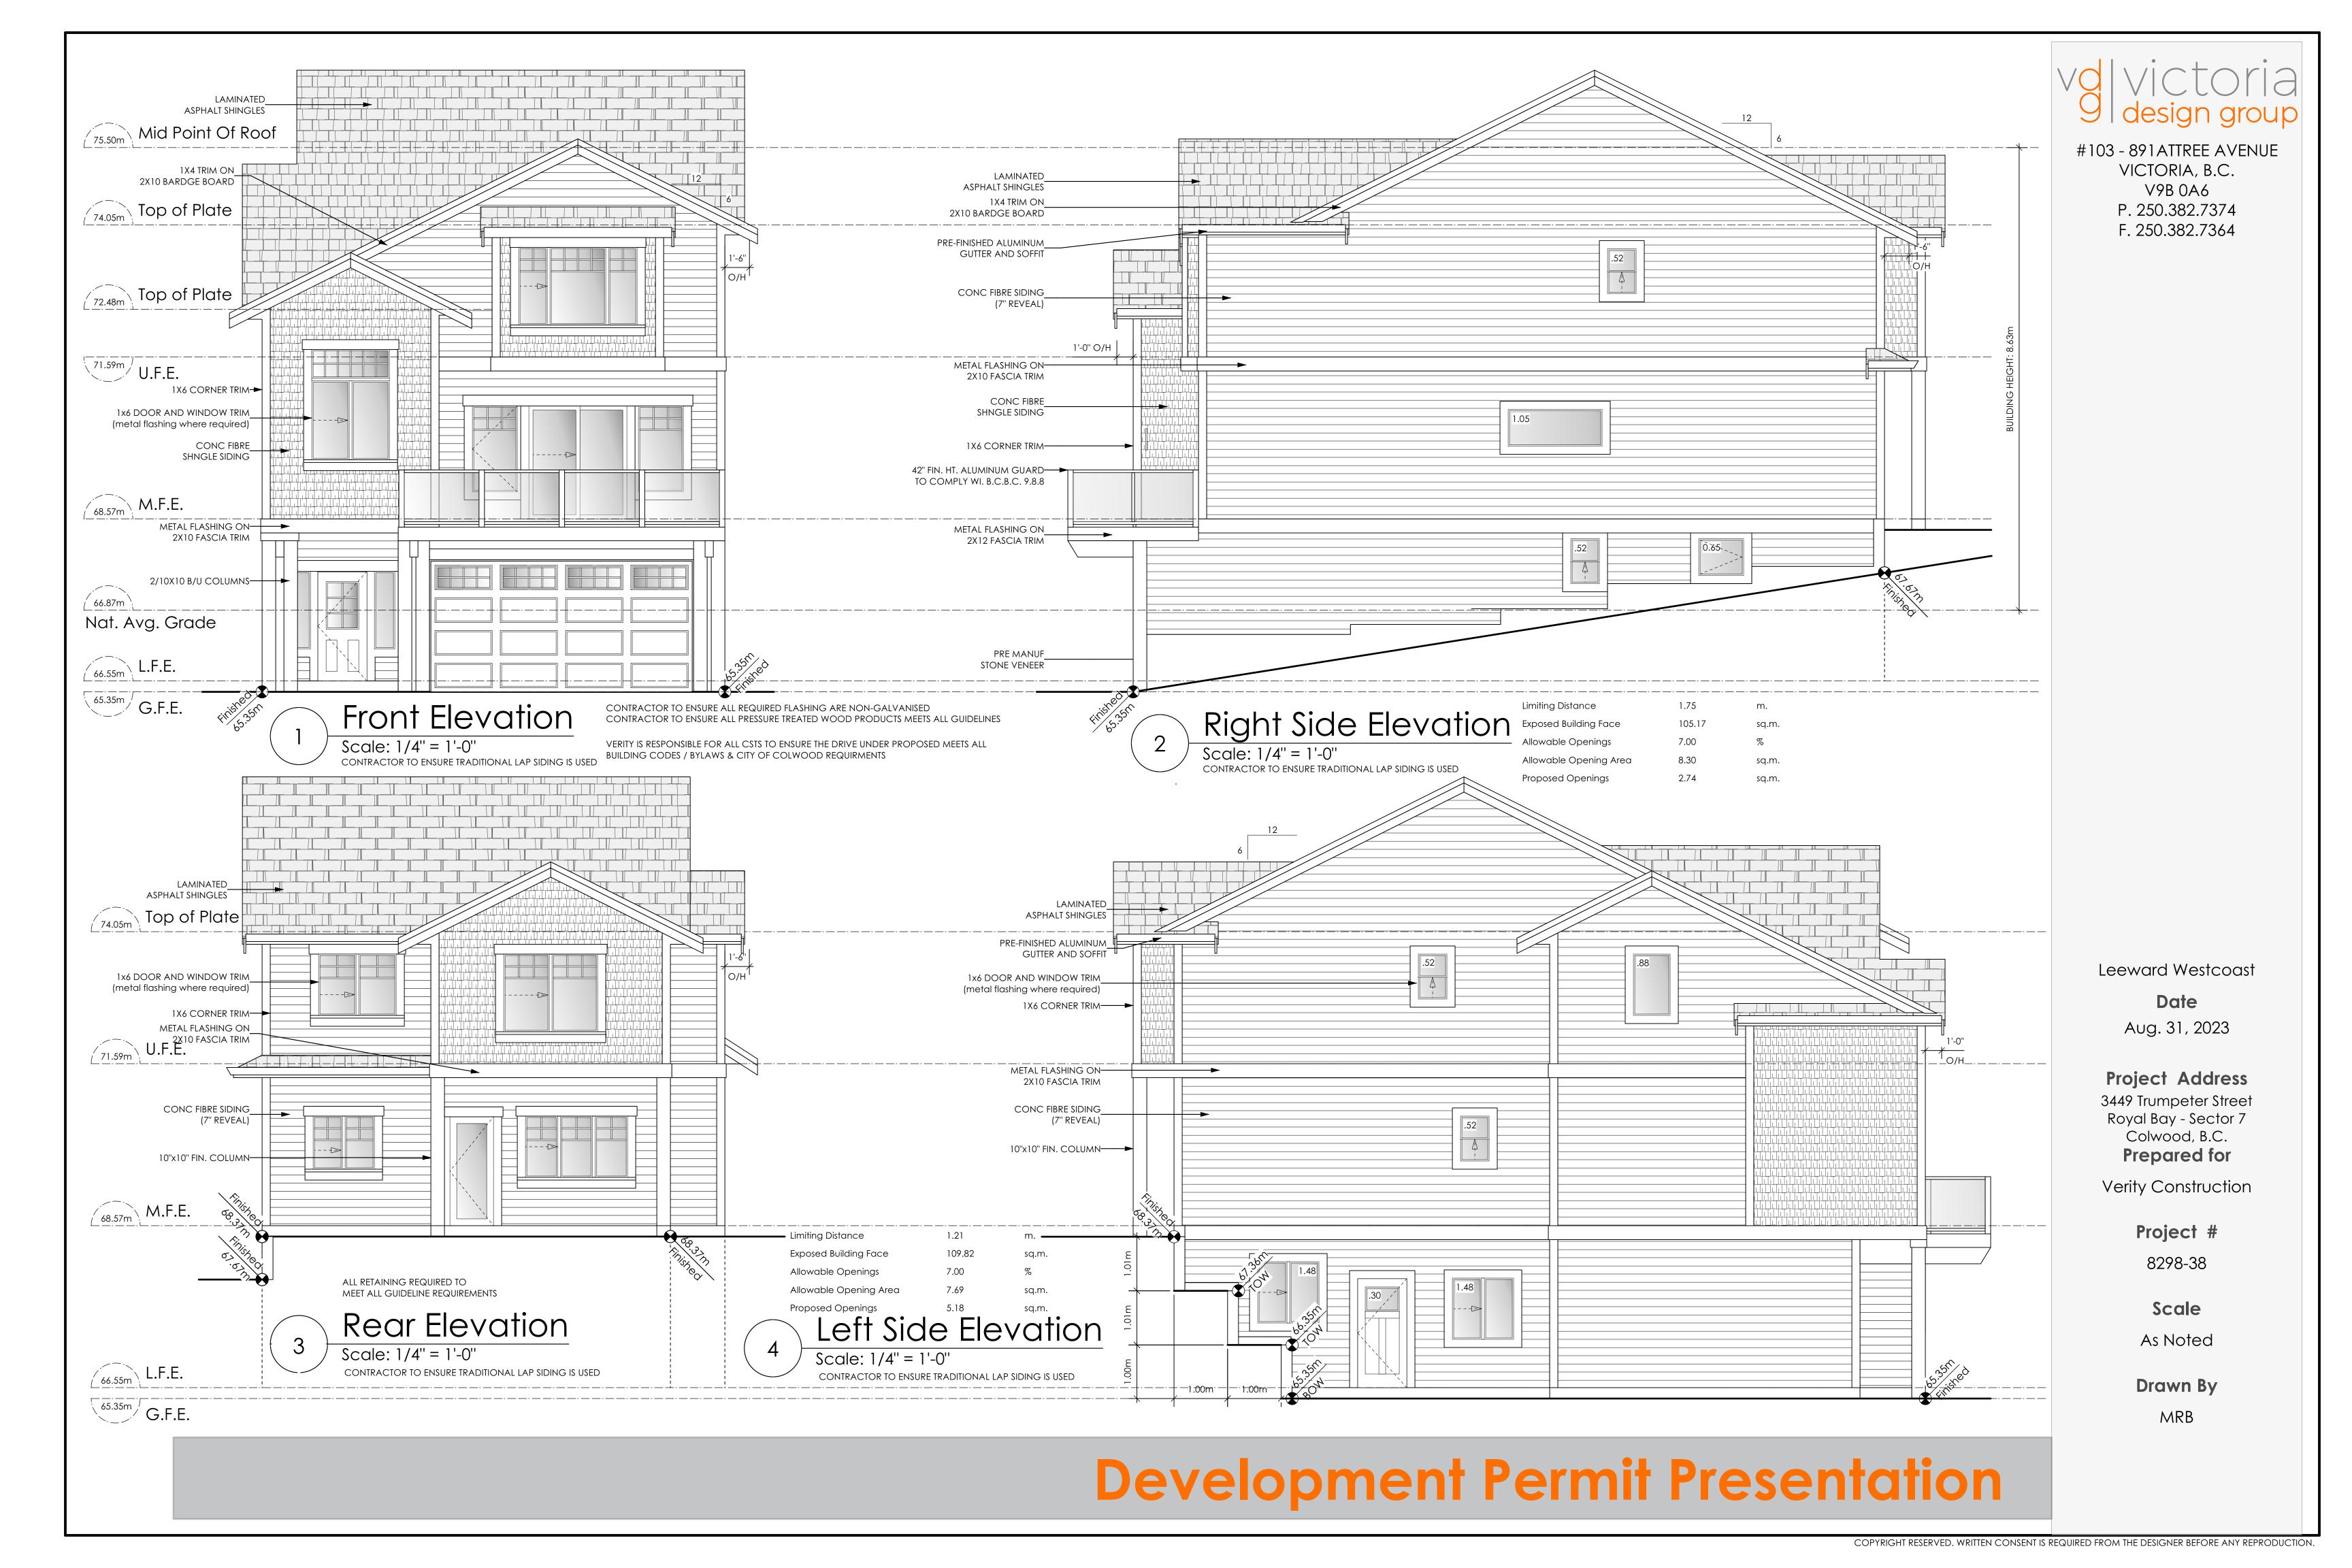
#103 - 891 ATTREE AVENUE VICTORIA, B.C. V9B 0A6 P. 250.382.7374 F. 250.382.7364

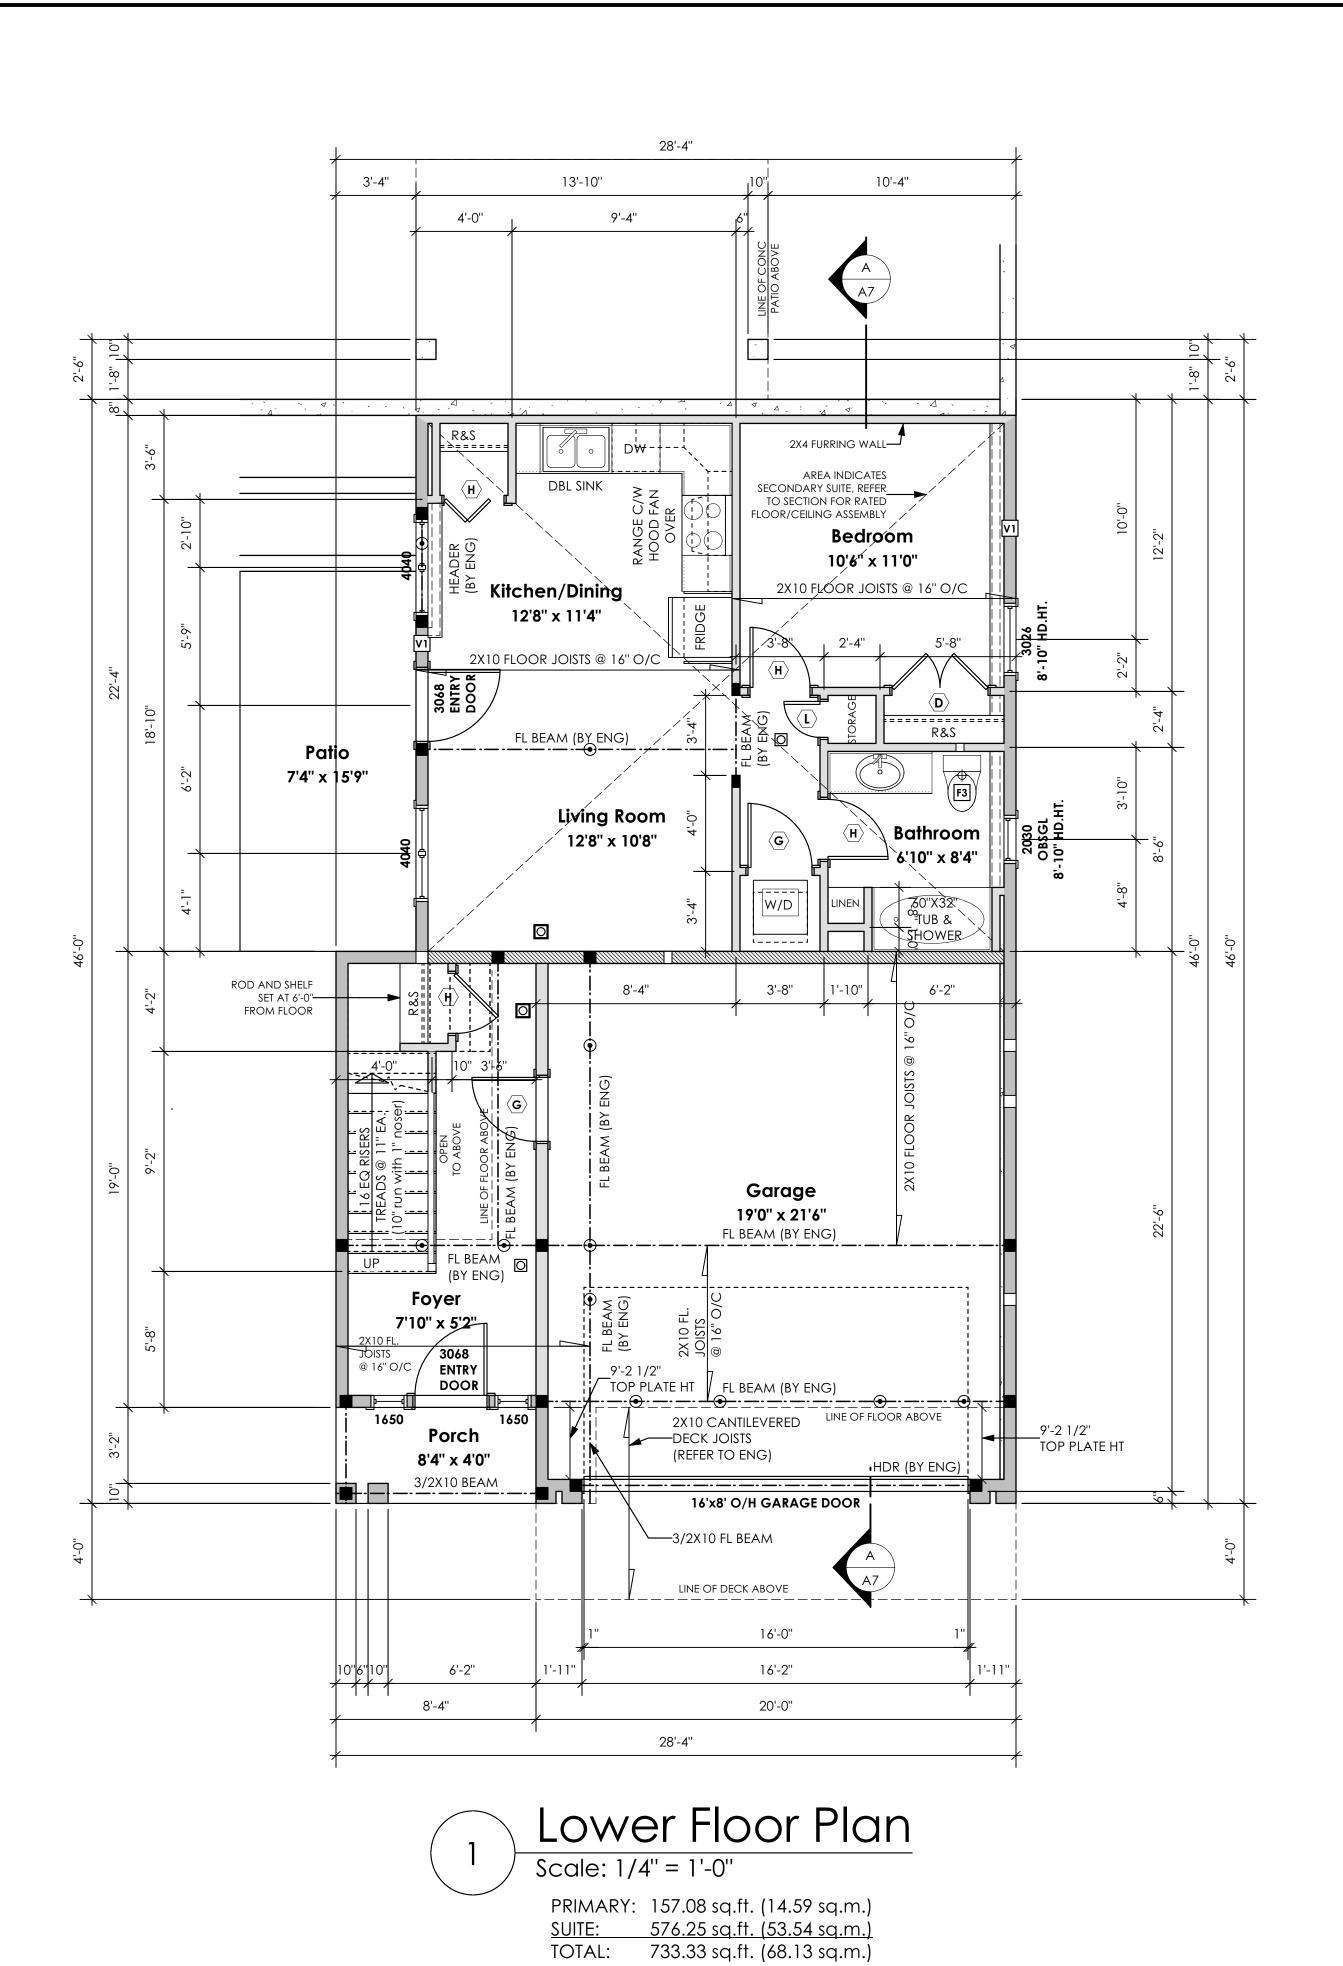Leeward Westcoast

Date Aug. 31, 2023

Project Address

3449 Trumpeter Street Royal Bay - Sector 7 Colwood, B.C. **Prepared for**

Verity Construction

Project #

8298-38

Scale

As Noted

Drawn By


MRB

Development Permit Presentation

GARAGE: 450.00 sq.ft. (41.81 sq.m.)



#103 - 891 ATTREE AVENUE VICTORIA, B.C. V9B 0A6 P. 250.382.7374 F. 250.382.7364

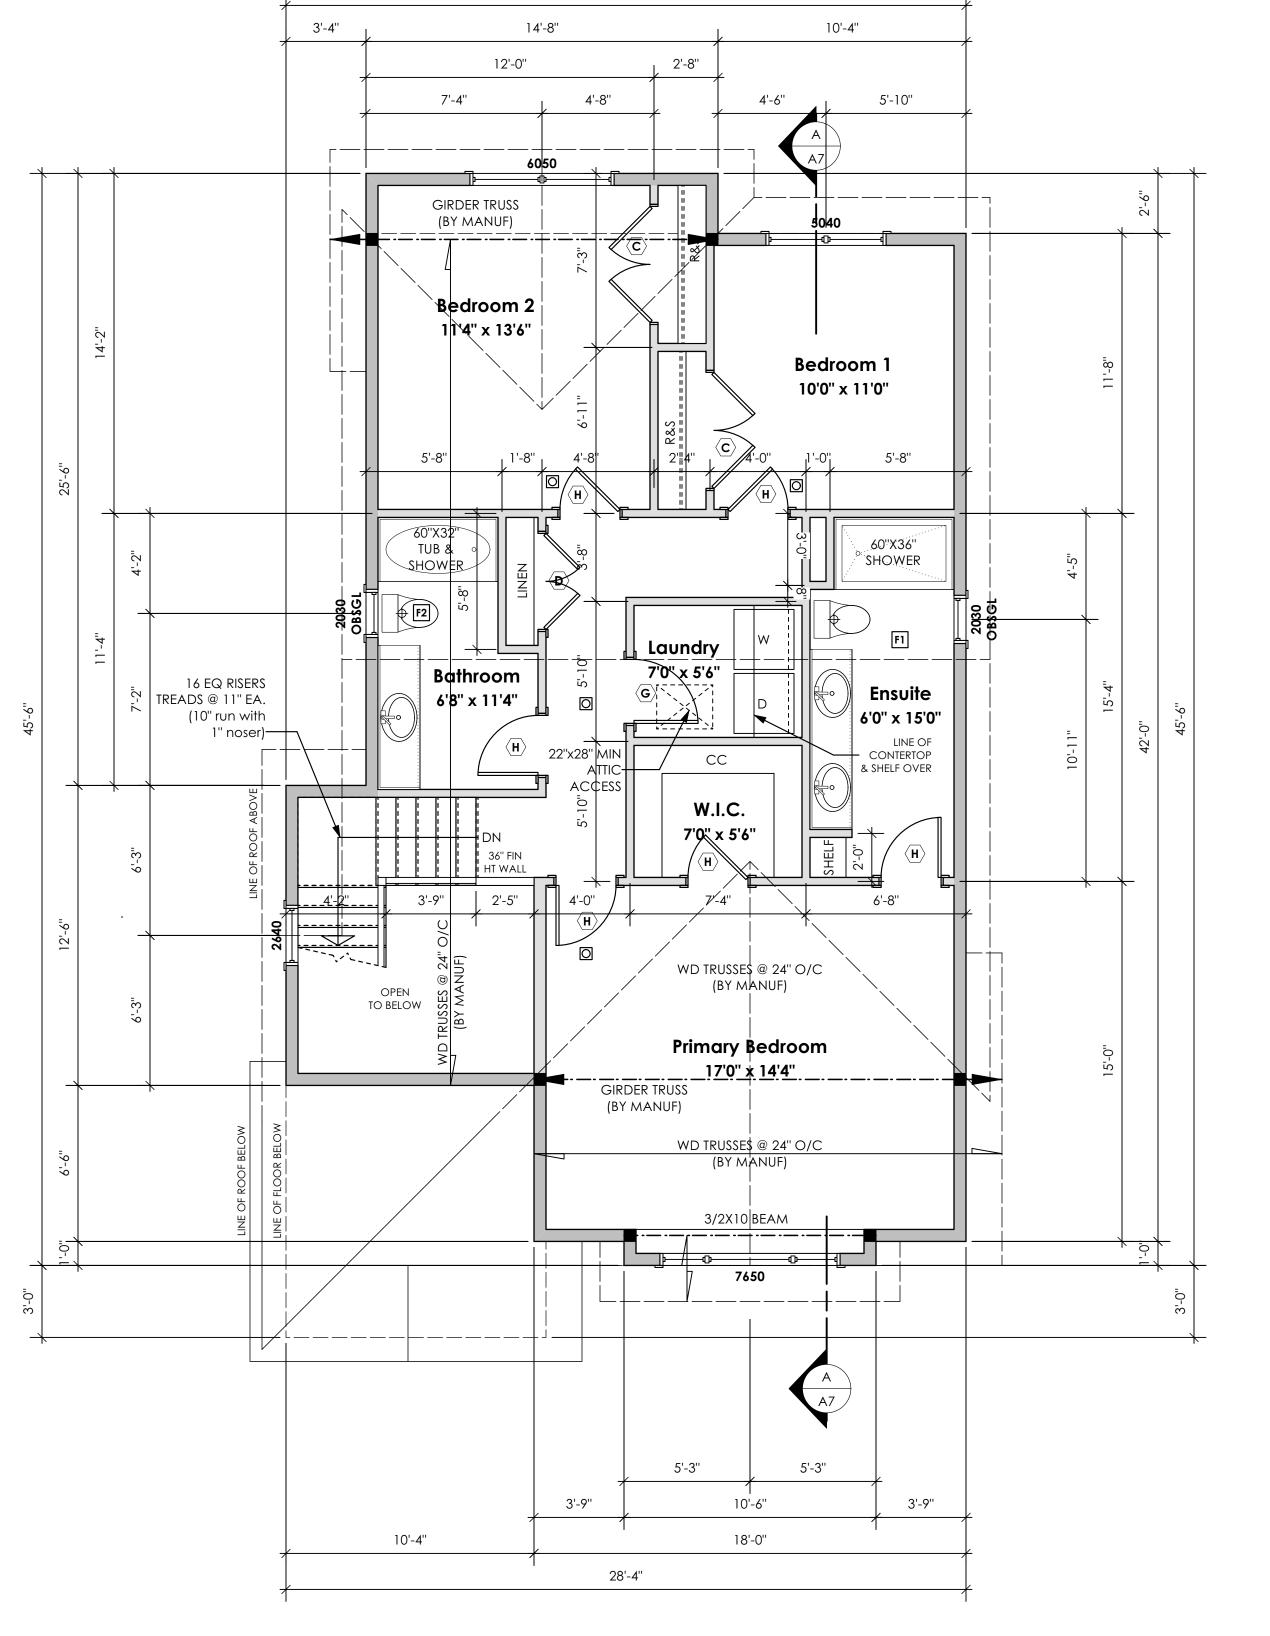

28'-4"

Main Floor Plan

Scale: 1/4" = 1'-0"

28'-4"

3'-4''

16 EQ RISERS TREADS @ 11" EA.

(10" run with 1" noser)—

TREADS @ 11" EA.

(BY MANUF)

9'10"/x 10'0"

12'-10" CEILING

WD TRUSSES @ 24" O/C (BY MANUF)

50<mark>70</mark> 10'-6" HD.HT.

10'-10"

(10" run with 1" noser) JACKS @ 24" O/C 25'-0''

13'-0"

14'8" x 10'0"

Family Room 14'0" x 13'10"

> FL BEAM (BY ENG)

FL CANTILEVERED BEAM (BY ENG)

Living Room

17'0" x 16'0"

17'6" x 8'0"

17'-6''

membrane

can/cgsb 37.54

HDR 60611 GLASS SLIDER
(BY ENG) DBL BOTTOM PLATE

10'0" x 13'10"

Dining Room

17'0" x 10'8"

PRIMARY: 1080.25 sq.ft. (100.36 sq.m.)

NOTE:
STRUCTURAL ENGINEER TO REVIEW PLAN (WHERE REQUIRED)
AND SPECIFY STRUCTURE AS DEEMED NECESSARY. IT IS
THE RESPONSIBILITY OF THE OWNER. OR CONTRACTOR TO
VERIFY ALL ENGINEERING REQUIREMENTS WITH MUNICIPAL
BUILDING DEPARTMENTS PRIOR TO STARTING WORK.

42" FIN. HT. ALUMINUM GUARD C/W OBSCURED GLAZING PANELS

TO COMPLY WI. B.C.B.C. 9.8.8

STRUCTURAL WOOD ELEMENTS WITHIN 150MM (6") FROM FINISHED GROUND LEVEL SHALL BE PRESSURE TREATED WITH A PRESERVATIVE FOR TERMITE AND DECAY PROTECTION B.C.B.C. 2012 9.3.2.9.(3)



Leeward Westcoast

Date

Aug. 31, 2023

Project Address
3449 Trumpeter Street
Royal Bay - Sector 7

Prepared for Verity Construction

Colwood, B.C.

Project #


8298-38

Scale

As Noted

Drawn By

MRB

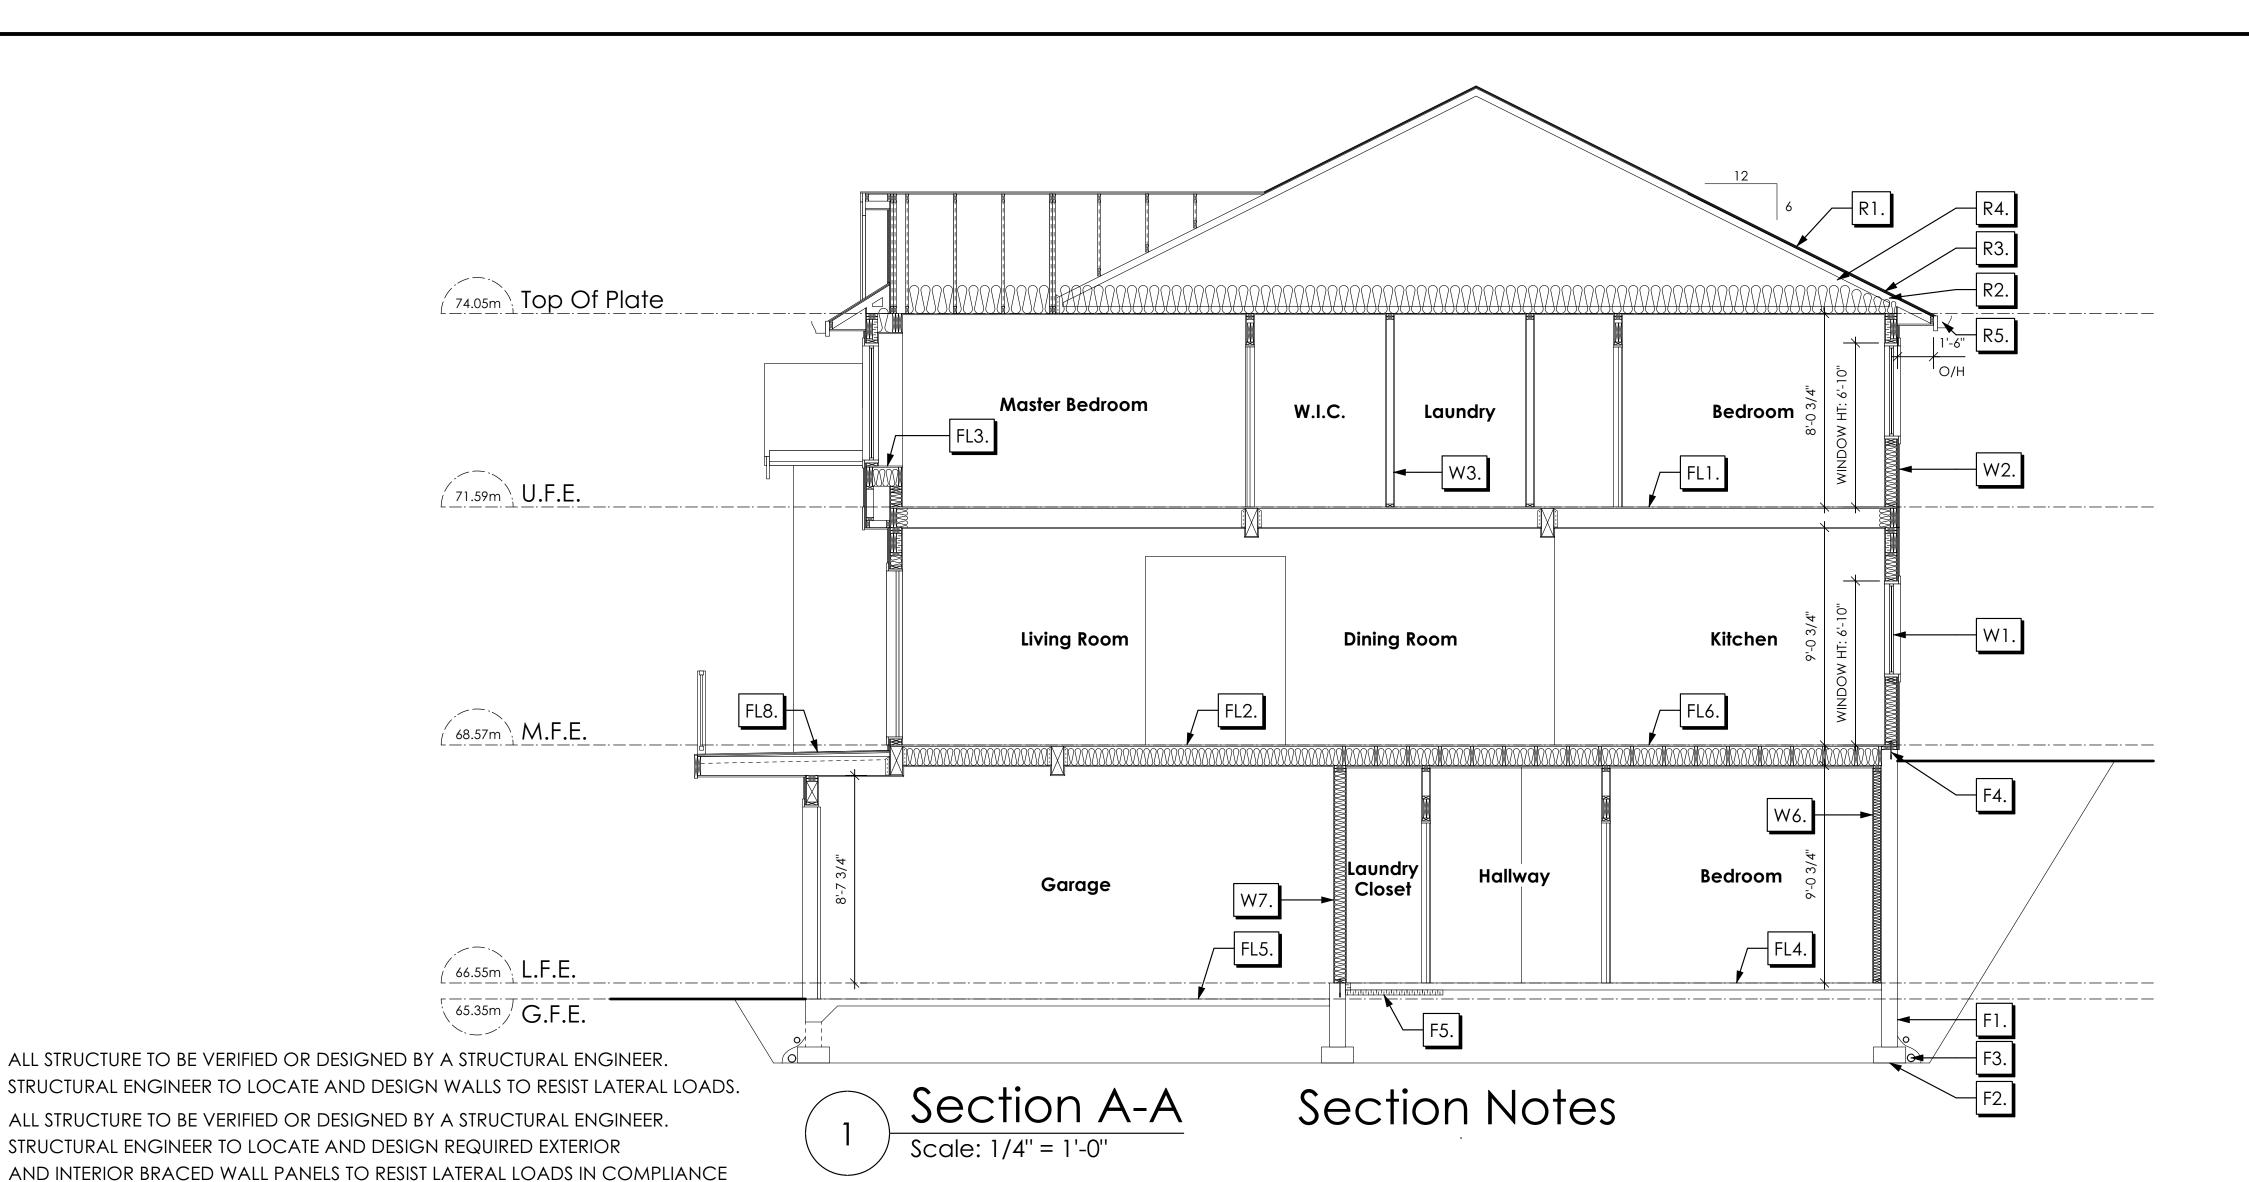

ROOFS

WITH B.C. BUILDING CODE 9.23.13.2 AND SUPPLY DETAILS IF REQUIRED

R1. LAMINATED ASPHALT SHINGLES ON
7/16" ORIENTED STRAND BOARD C/W "H" CLIPS
WD TRUSSES (DESIGNED BY MANUF.)
14 1/2" FIBRE GLASS LOOSE FILL INSULATION
(ALLOW FOR SETTLING)
6 MIL POLY'N V.B.
5/8" GYPSUM BOARD

R2. PROVIDE 2 1/2" (63MM) CLEAR BETWEEN
R-20 INSULATION AND SHEATHING.
(MIN. R-20 @ ROOF-WALL CONNECTION FOR
4'-0" (1.2M) AROUND PERIMETER OF BUILDING.
AIR VENTILATION BAFFLES TO BE INSTALLED
WHERE REQUIRED IN AS PER BCBC 9.19.)

- R3. EAVE PROTECTION

 CONT. UP ROOF SLOPE FOR 12"

 PAST EXTERIOR WALL.
- R4. PROVIDE 1 SQ.FT. ATTIC VENT PER
 300 SQ.FT. OF INSULATED AREA MIN.
 25% OF REQUIRED TO BE @ TOP AND BOTTOM
 (TO COMPLY WI. B.C. BLDG. CODE 9.19.1)
- R5. PRE-FIN. FASCIA GUTTER
 2×8 FASCIA BD.
 2×4 SUB. FASCIA BD.
 VENTED SOFFIT
 (SEE CONTRACTOR)

FLOORS

FL1. FINISHED FLOORING ON

11/16" ORIENTED STRAND BOARD

(NAILED & GLUED TO FLOOR STRUCT. BELOW) ON

2×10 FLOOR JOISTS @ 16" OR 12" O/C

C/W 2×2 X-BRIDGING @ 7.0' O/C (MAX)

1/2" GYPSUM BOARD

FL2. FINISHED FLOORING ON
11/16" ORIENTED STRAND BOARD
(NAILED & GLUED TO FLOOR STRUCT. BELOW) ON
2×10 FLOOR JOISTS @ 16" OR 12" O/C
C/W 2×2 X-BRIDGING @ 7.0' O/C (MAX)
R-31 INSULATION
5/8" X-TYPE GYPSUM BOARD
(BETWEEN GARAGE AND LIVING SPACE)

FL3. FINISHED FLOORING ON
19/32" ORIENTED STRAND BOARD
(FASTENED & GLUED TO FLOOR STRUCT. BELOW) ON
2×10 FLOOR JOISTS @ 16" OR 12" O/C
C/W 2×2 X-BRIDGING @ 7.0' O/C (MAX)
PROVIDE R-31 F/G BATT INSULATION IN
JOIST CAVITY C/W
BUILDING WRAP
VENTED SOFFIT (TO OWNERS SPEC'S)
TO ALL SUSPENDED FLOOR AREAS

FL4. 3 1/2" CONCRETE SLAB 6 MIL. POLY'N V.B. 6" COMPACTED GRAVEL OR SAND

FL5. 3 1/2" CONCRETE SLAB 6 MIL. POLY'N V.B. 6" COMPACTED GRAVEL OR SAND SLOPE TO DOORS 1" FL6. F8d RATED FLOOR ASSEMBLY
(BC BUILDING CODE TABLE 9.10.3.1.B)
FINISHED FLOORING ON
19/32" ORIENTED STRAND BOARD OR EQ.
(FASTENED & GLUED TO FLOOR STRUCT. BELOW) ON
2×10 FLOOR JOISTS @ 16" OR 12" O/C
C/W 2×2 X-BRIDGING @ 7.0' O/C (MAX)
R-31 INSULATION
RESILIENT METAL CHANNELS @ 24" O/C
1 LAYERS 5/8" X-TYPE GYPSUM BOARD
30 MINUTE F.R.R., 50 S.T.C.

FL7. DECKING MEMBRANE
(TO COMPLY WITH CAN/CGSB 37.54) ON
19/32" ORIENTED STRAND BOARD
2×10 DECK JOISTS @ 16" O/C C/W
(PROVIDE ADEQUATE MEMBRANE
"UPSTAND" @ EXT. WALL.)
(SLOPE JOISTS TO PROVIDE MIN.1:50 SLOPE)

FL8. DECKING MEMBRANE
(TO COMPLY WITH CAN/CGSB 37.54) ON
19/32" ORIENTED STRAND BOARD C/W "H" CLIPS
TAPERS TO PROVIDE MIN.1:50 SLOPE ON
2×10 DECK JOISTS @ 16" O/C C/W
(PROVIDE ADEQUATE MEMBRANE
"UPSTAND" @ EXT. WALL.)

WALLS

W1. DOUBLE GLAZING
ENERGY STAR LOW "E" RATING IN
THERMAL BREAK FRAMES
2/2"X10" LINTEL OVER (@ BEARING WALLS ONLY)
(TYPICAL, WI. 2 1/2" XPS INSULATION)
FLASHING OVER @ EXTERIOR
(GLAZING IN ALL EXTERIOR DOORS & WITHIN 3 FT.
OF EXTERIOR DOORS TO BE SHATTERPROOF (SP))
WINDOW REQUIREMENTS DERIVED FROM BCBC
TABLE C-4 AS PER BCBC 9.7.4.3. AND ARE TO BE
USED TO SATISFY THE REQUIREMENTS OF
AAMA/WDMA/CSA 101/I.S.2/A440, "NAFS":
LANGFORD, CLASS R, DP 960, PG 20, WATER RESIST. 220, A2,
RATINGS MUST BE CLEARLY LABELED ON ALL
WINDOW UNITS UPON INSTALLATION FOR INSPECTION.

W2. CONC. FIBRE BOARD ON
9.5MM (3/8") AIR SPACE / STRAPPING
3/8"×2" BORATE TREATED PLYWOOD STRAPPING
HOUSE WRAP (A.B.) (TYVEK OR EQ.)
7/16" ORIENTED STRAND BOARD SHEATHING
2×6 STUDS @ 16" O/C
R-20 INSULATION
6 MIL. POLYETHYLENE VAPOUR BARRIER
1/2" GYPSUM BOARD
(REFER TO DETAILS ON D1)

W3. INTERIOR PARTITION
1/2" GYPSUM BOARD ON EACH SIDE
OF 2×4 STUDS @ 16" O/C OR
2×6 STUDS @ 16" O/C (IF NOTED)

W4. PRE-MANUFACTURED STONE VENEER
(INSTALLED TO MANUF. SPEC)
LIME BASED MORTAR SETTING BED ON
LIME BASED MORTAR SCRATCH COAST ON
METAL LATHE INSTALLED HORIZONTALLY
OVERLAP HORIZONTAL AND VERTICAL SEAMS 1"
SEMI-RIGID BACK BOARD
(HAL-TEX RAINBOARD OR EQ.)
9.5MM (3/8") AIR SPACE / STRAPPING
3/8"×2" BORATE TREATED PLYWOOD STRAPPING
HOUSE WRAP (A.B.) (TYVEK OR EQ.)
7/16" ORIENTED STRAND BOARD SHEATHING
2×6 STUDS @ 16" (AS REQUIRED)
(NOT SHOWN IN SECTION)

W5. 5/8" X-TYPE GYPSUM BOARD ON 2×6 STUDS @ 16" O/C C/W R-20 INSULATION 6 MIL. POLY'N V.B 1/2" GYPSUM BOARD (BETWEEN GARAGE & LIVING) (NOT SHOWN IN SECTION)

W6. 1/2" GYPSUM BOARD ON
6 MIL. POLY'N V.B.
2×4 STUDS @ 24" O/C C/W
R-12 BATT INSULATION
2 PLY 30 MINUTE BUILDING PAPER OR
12.7MM (1/2") AIR SPACE
(PROVIDE REQUIRED FIRE STOPS IN WALL
ASSEMBLIES TO COMPLY WITH
B.C. BLDG. CODE 9.10.16.)
(NOT IN SECTION)

W7. B.C. BUILDING CODE (TABLE 9.10.3.1.A)
RATED WALL ASSEMBLY W3C

1 LAYER 1/2" X-TYPE GYPSUM BOARD
RESILIENT METAL CHANNELS @ 24" O/C
2×4 STUDS @ 16" O/C OR
2×6 STUDS @ 16" O/C (IF NOTED) C/W
3 1/2" FIBRE GLASS SOUND BATTS
1 LAYER 1/2" X-TYPE GYPSUM BOARD
45 MIN. F.R.R 43 S.T.C
(BETWEEN PRIMARY LIVING / GARAGE
& SECONDARY SUITE)

FOUNDATION WALLS

F1. DAMP PROOFING (WHERE REQUIRED) ON 8" THK. CONC. FOUNDATION WALL C/W 15 M BARS @ 24" O/C B/W

F2. 16"X 8" CONC. FOOTINGS

C/W 2 (TWO) 15M BARS CONT. 3 IN. FROM BOTT.

ON UNDISTURBED SOIL (SOLID BEARING)

F3. 4" PERIMETER DRAIN
3" TIGHT PIPE FOR RWL
DRAIN ROCK

F4. ANCHOR BOLTS @ 4.0 FT. O/C MAX C/W SILL GASKETS

5. UNDER SLAB INSULATION
2 1/2" (RSI 2.15) EXTRUDED POLYSTYRENE
RIGID INSULATION 4'-0" (1.2M)
CONT. AROUND PERIMETER UNDER
SLAB INSTALLED HORIZONTALLY
(VERIFY WITH MUNICIPALITY DEPTH OF FROST LINE)
(NOT IN SECTION)

Leeward Westcoast

Date

#103 - 891ATTREE AVENUE

VICTORIA, B.C.

V9B 0A6

P. 250.382.7374

F. 250.382.7364

Aug. 31, 2023

Project Address
3449 Trumpeter Street
Royal Bay - Sector 7
Colwood, B.C.
Prepared for

Verity Construction

Project #


8298-38

Scale

As Noted

Drawn By

MRB

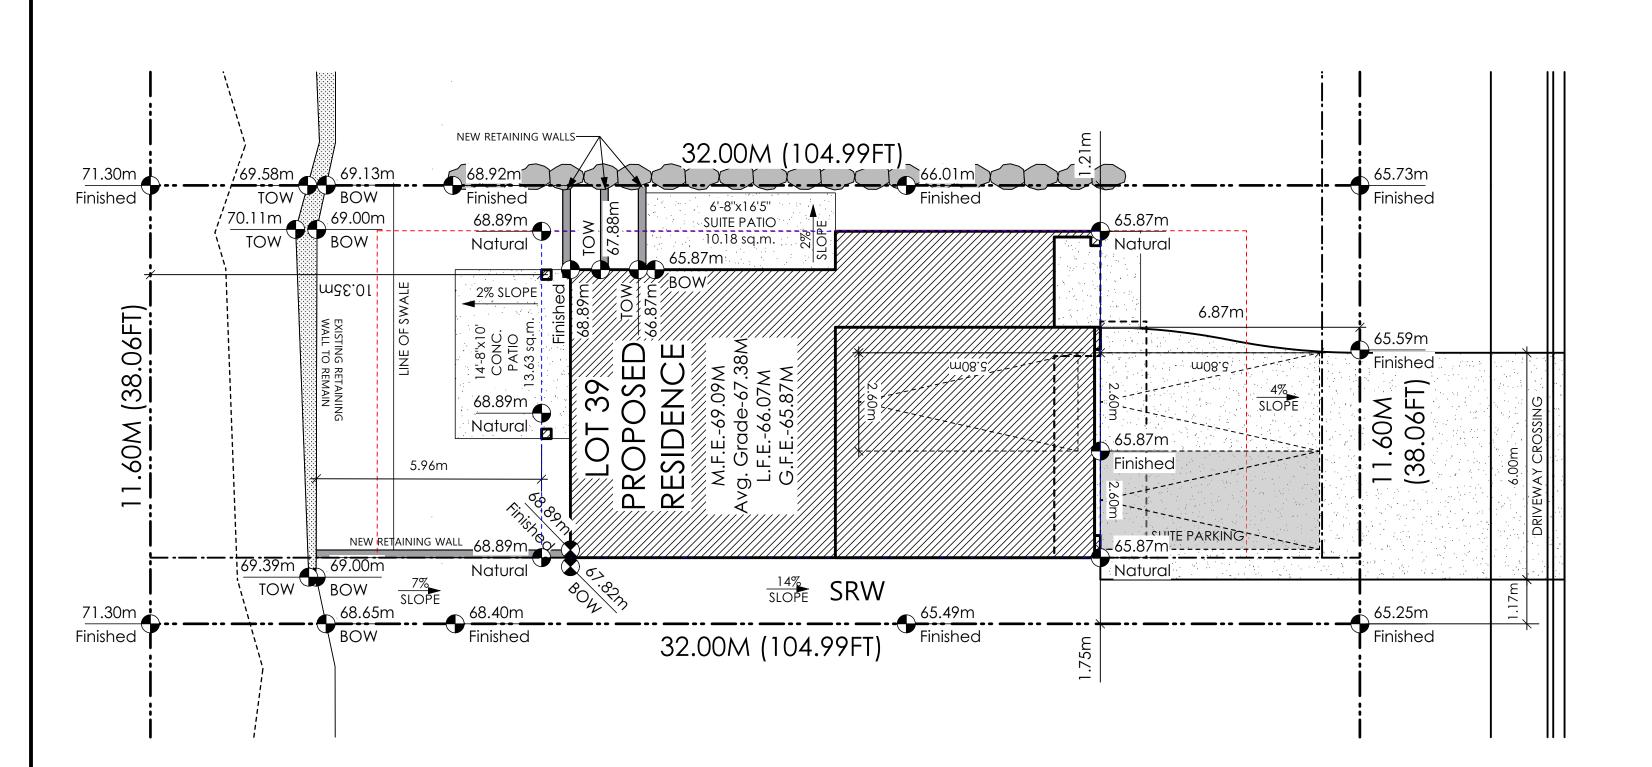



V9B 0A6 P. 250.382.7374 F. 250.382.7364

107 LOT LOT

Site Plan Scale: 1:100

AVERAGE NATURAL GRADE CALCULATION 65.87 m. + 65.87 m. + 68.89 m. + 68.89 m. = 262.52 m. DIVIDED BY 4 = AVG. GRADE 67.38m. *XX.Xm* = DESIGNER APPROXIMATE HEIGHT MEASUREMENT, VERIFY ON SITE - TO BE CERTIFIED BY AN ENGINEER AND MEET BCBC REQUIREMENTS FOR - ALL LANDSCAPE RETAINING WALLS TO HAVE A 1.2m MAX. EXPOSED HT 2.60m 2.60m

PARKING STALL SMALL CAR PARKING DIMENSIONS STALL DIMENSIONS * as per 2.2.02a allowing one stall to be a small 100mm (4") Depth Mulch. Keep Mulch 100mm off Trunk 100mm (4") Depth Mulch.— Root Flare to be 25-50mm Above Adjacent Growing Medium

> Tree Planting Detail Not To Scale All trees and plants by the home owner to be

> > planted in minimum 10m³ of fertile topsoil, 700mm Deep

Set Rootball on Compacted Subgrade

CONTRACTOR TO ENSURE A MINIMUM 2% SLOPE

SITE DATA RBCD5 LOT 39 PERMITTED PROPOSED 368 371.20 sq.m. LOT AREA 50.00 % 31.43 % OT COVERAGE 9.50 m. 8.29 m. 10.97 m. 11.60 m. LOT WIDTH SETBACKS FRONT 4.50 m. 6.87 m. 6.00 m. 10.35 m. 1.20 m. 1.21 m. - SIDE 1.20 m. 1.75 m. 86.31 sq.m. 100.36 sq.m. MAIN LOWER 68.13 sq.m. - GARAGE 41.81 sq.m. 296.61 sq.m. 50.00 sq.m. -41.81 sq.m. 254.80 sq.m. 0.69 TO 1.0 40.00 % 21.01 % FLOOR AREA (SQ.M.) 90.00 sq.m. 53.54 sq.m.

THE SLEEVES TO BE INSTALLED BY THE BUILDER

GRADING STANDARDS (PAGE 30) ETC.

7.47m

2.13m

PASSENGER VEHICLE 2.13M X 5.8M (7'x19') TURNING TEMPLATE

Turning Template

BUILDER IS RESPONSIBLE FOR ALL COSTS TO ENSURE ALL CITY

BEEN ACHIEVED AND THIS PLOT PLAN COMPLIES WITH ALL

OF COLWOOD GRADING AND SETBACK REQUIREMENTS HAVE

REQUIREMENTS OF THE DESIGN GUIDELINES I.E. SEE APPENDIX:

1: ENSURE A MINIMUM 2% SLOPE AWAY FROM STRUCTURE ON ALL SIDES

2: ALL RETAINING REQUIRED MUST MEET GUIDELINE REQUIREMENTS

BUILDING HEIGHT PROPOSED FLOOR AREA SUB-TOTAL G.F.A. GARAGE ALLOWANCE GROSS FLOOR AREA F.A.R. SECONDARY SUITE FLOOR AREA (%)

PATH OF OVERHANG

PATH OF FRONT WHEEL

PATH OF REAR WHEEL-

STOP & READ

RETAINING WALLS <u>MAY NOT</u> EXCEED 1.2m IN HEIGHT OR A 1:1 RATIO OF HEIGHT TO HORIZONTAL SEPARATION IF TERRACED


ALL FENCING, RETAINING AND LANDSCAPING MUST MEET THE GUIDELINE REQUIREMENTS

MAXIMUM PROJECTIONS / CANTILEVERS / OVERHANGS INTO SETBACKS ARE 0.65m IN YARDS OF LESS THAN 3.0m AND 1.0m IN YARDS OF 3.0m+.

THE WIDTH OF THE DRIVEWAY ACCESS (AT PROPERTY LINE - CROSSING THE CITY BOULEVARD) MAY NOT EXCEED 7.0m IN WIDTH

SIDE YARD SWALING (BOTH SIDES) MAY BE REQUIRED

ALL FENCING, RETAINING AND LANDSCAPINING MUST MEET GUIDELINE REQUIREMENTS

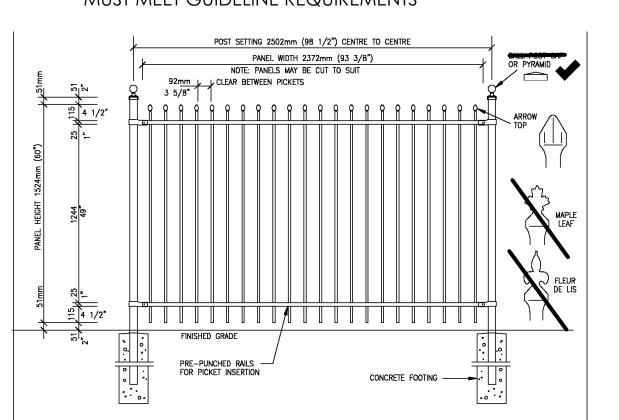

Fence Treatment

Not To Scale

(SEE LANDSCAPE PLAN FOR FENCE LOCATION)

Leeward Traditional

Date

Aug. 31, 2023

Project Address

3451 Trumpeter Street Royal Bay - Sector 7 Colwood, B.C. Prepared for

Verity Construction

Project #


8298-39


Scale

As Noted

Drawn By

MRB

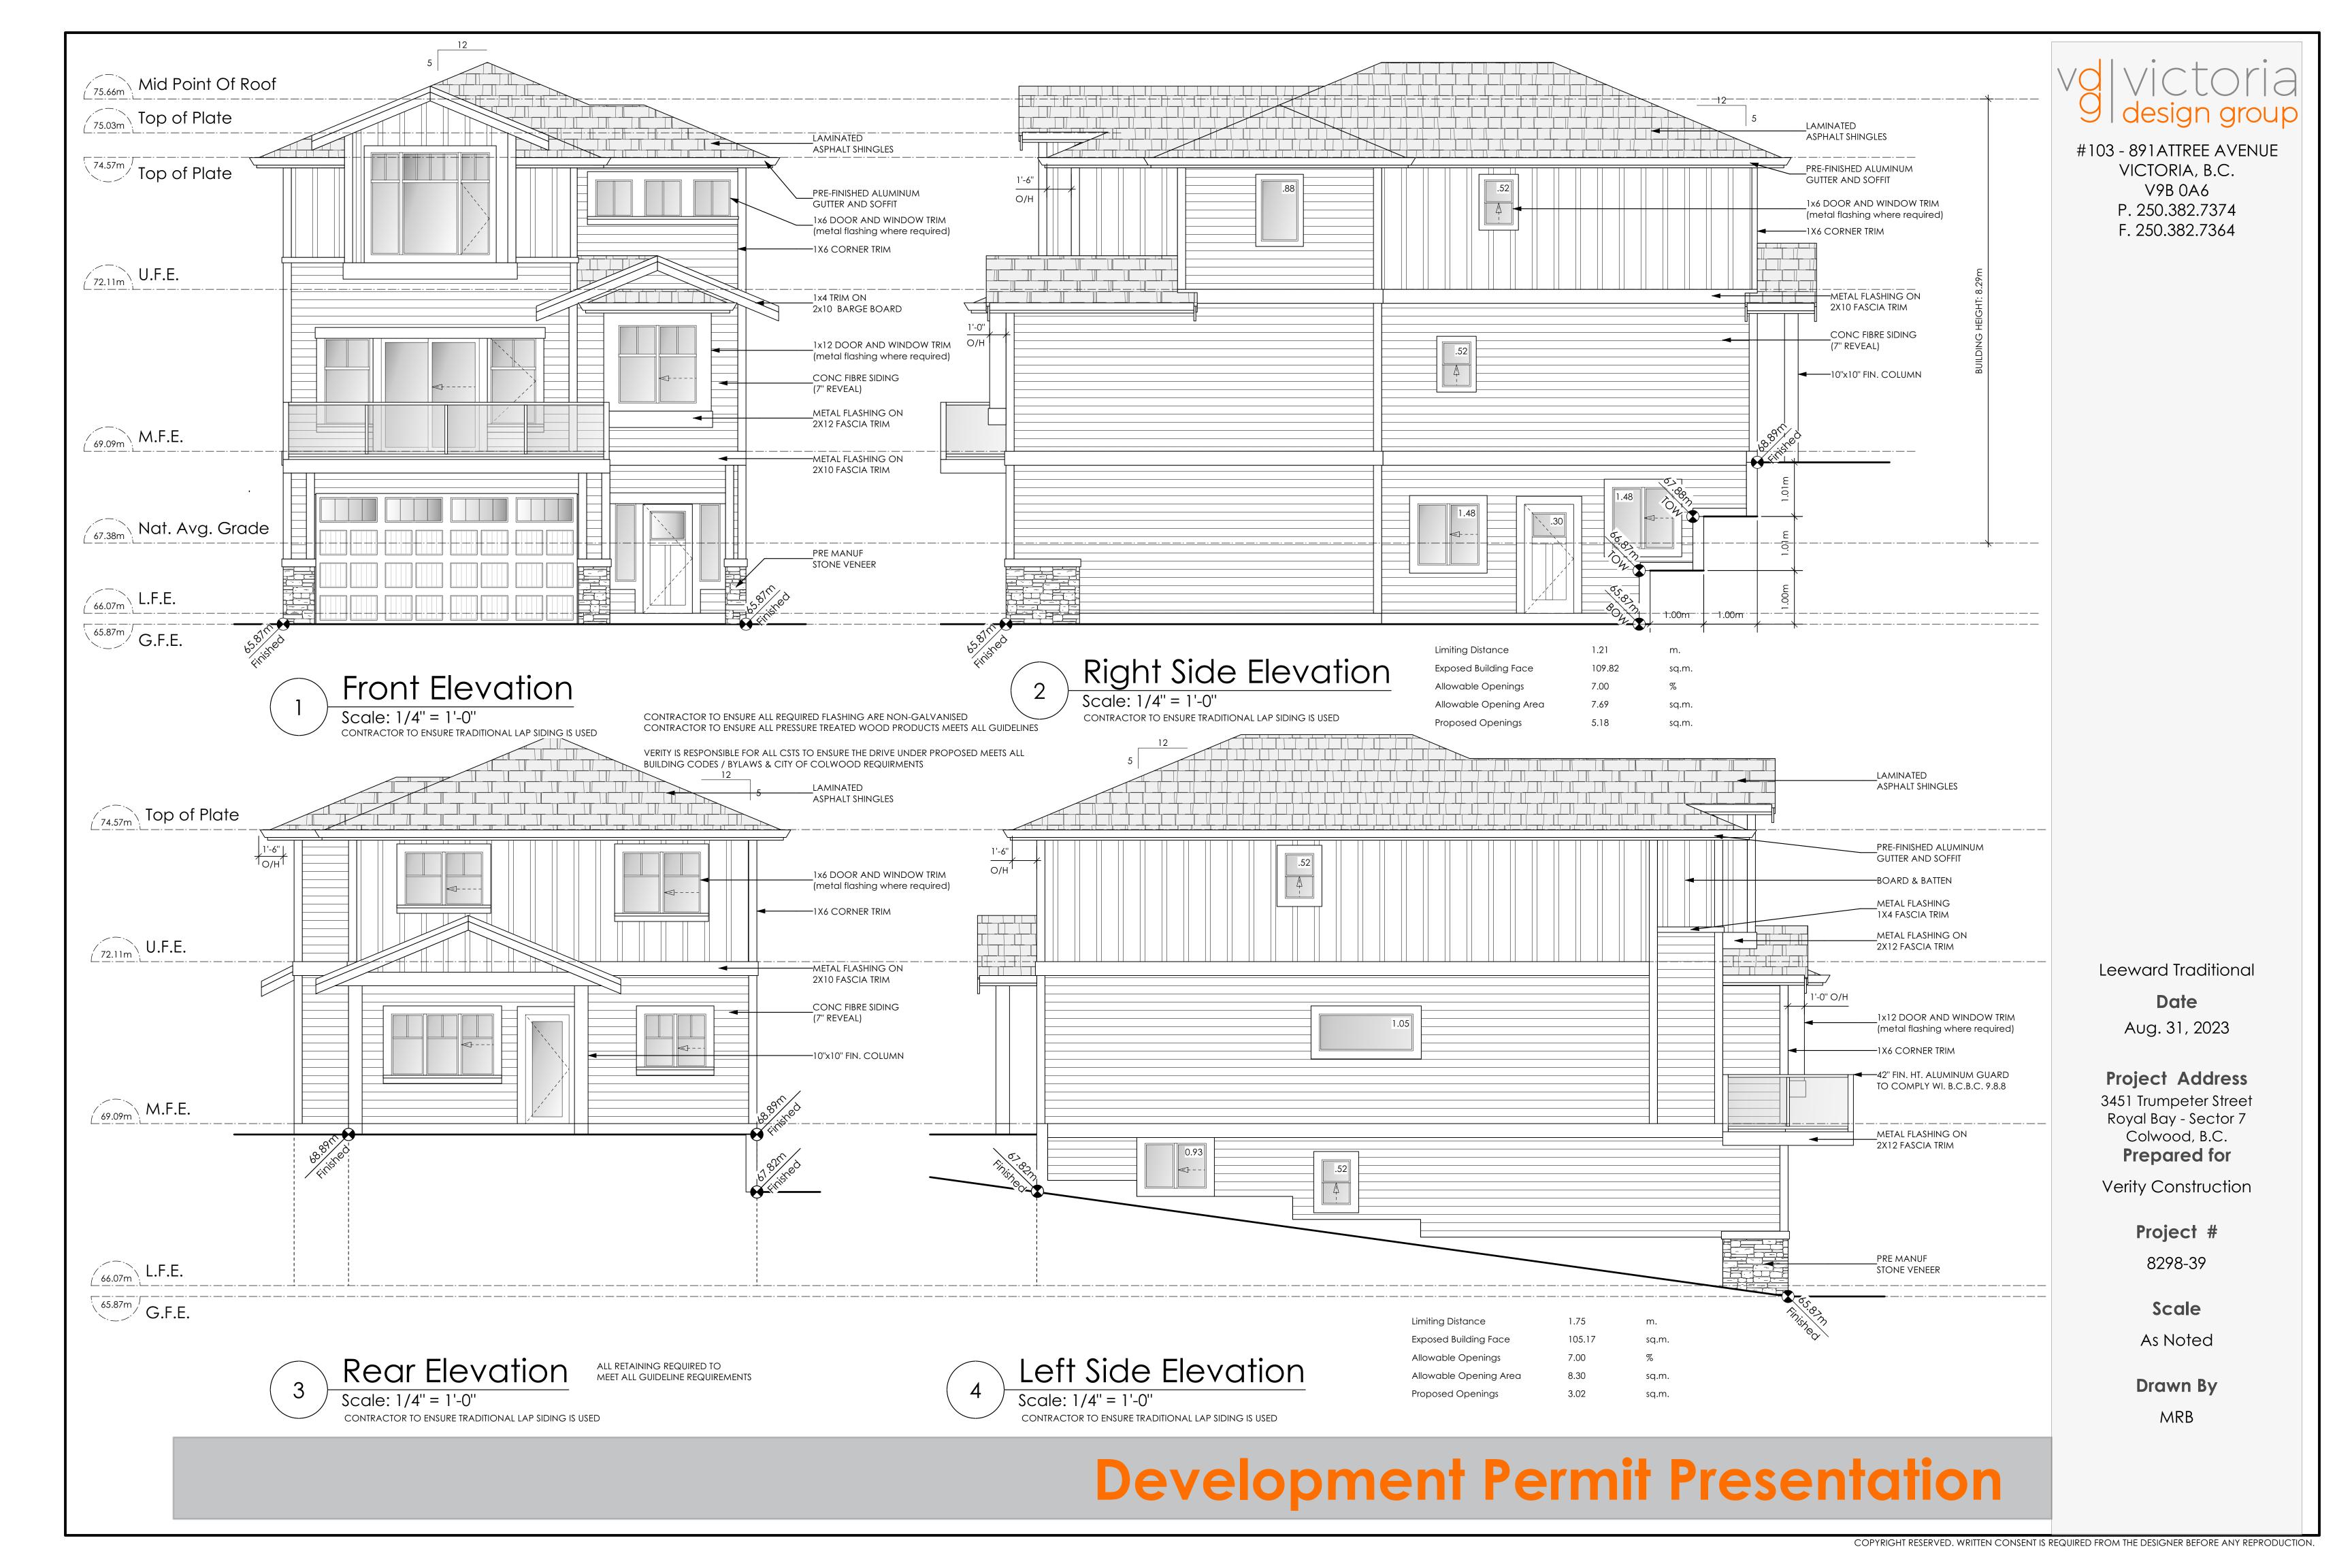

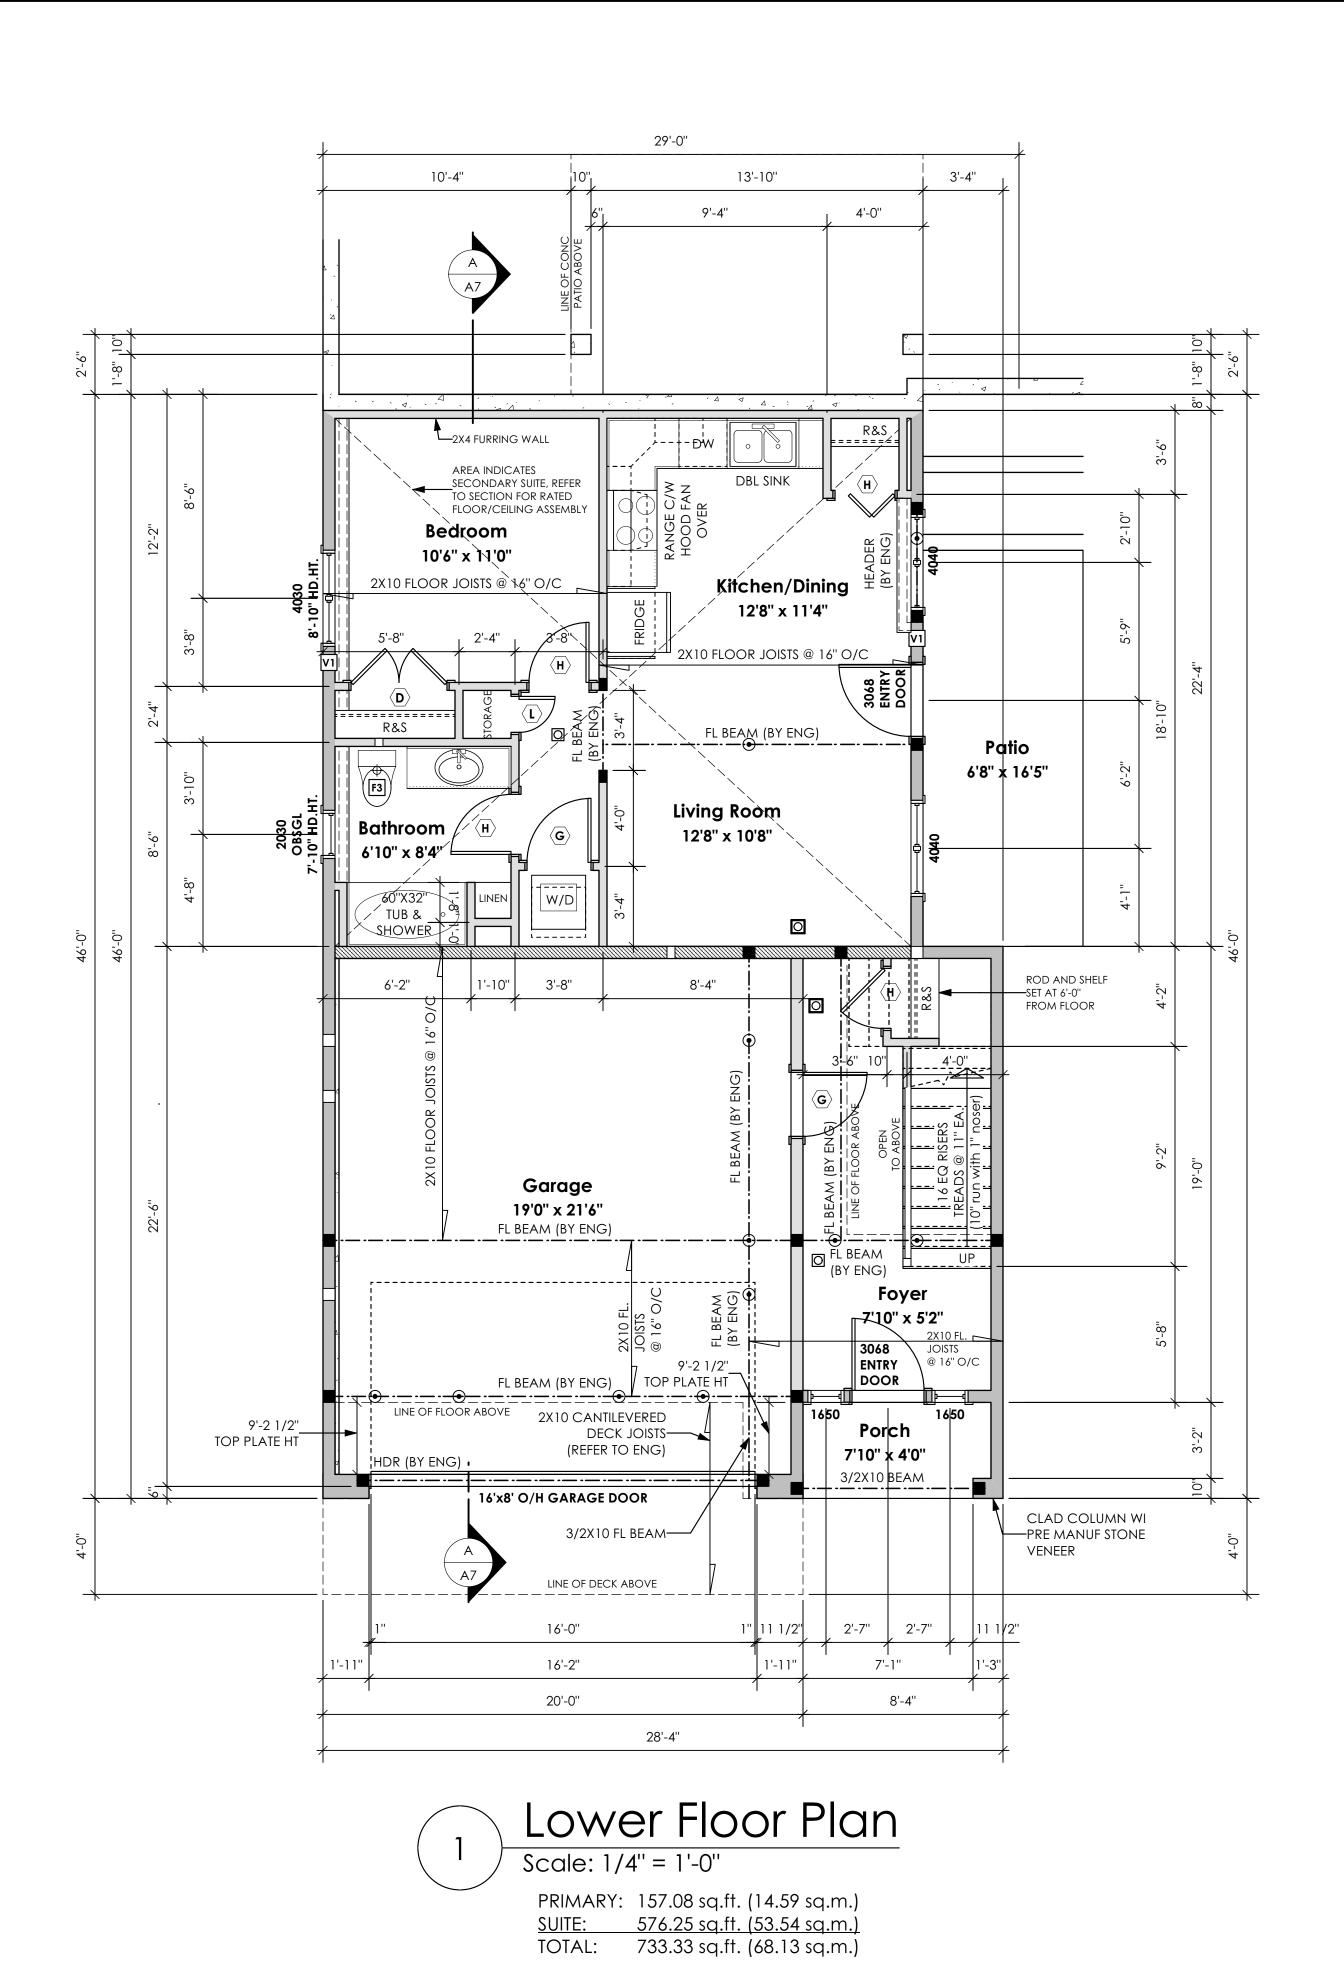

volvictoria 9 design group

> #103 - 891 ATTREE AVENUE VICTORIA, B.C. V9B 0A6 P. 250.382.7374 F. 250.382.7364

Leeward Traditional

Date

Aug. 31, 2023

Project Address3451 Trumpeter Street
Royal Bay - Sector 7

Prepared for Verity Construction

Colwood, B.C.

Project # 8298-39

Scale

As Noted

Drawn By


MRB

Development Permit Presentation

GARAGE: 450.00 sq.ft. (41.81 sq.m.)



#103 - 891 ATTREE AVENUE VICTORIA, B.C. V9B 0A6 P. 250.382.7374 F. 250.382.7364

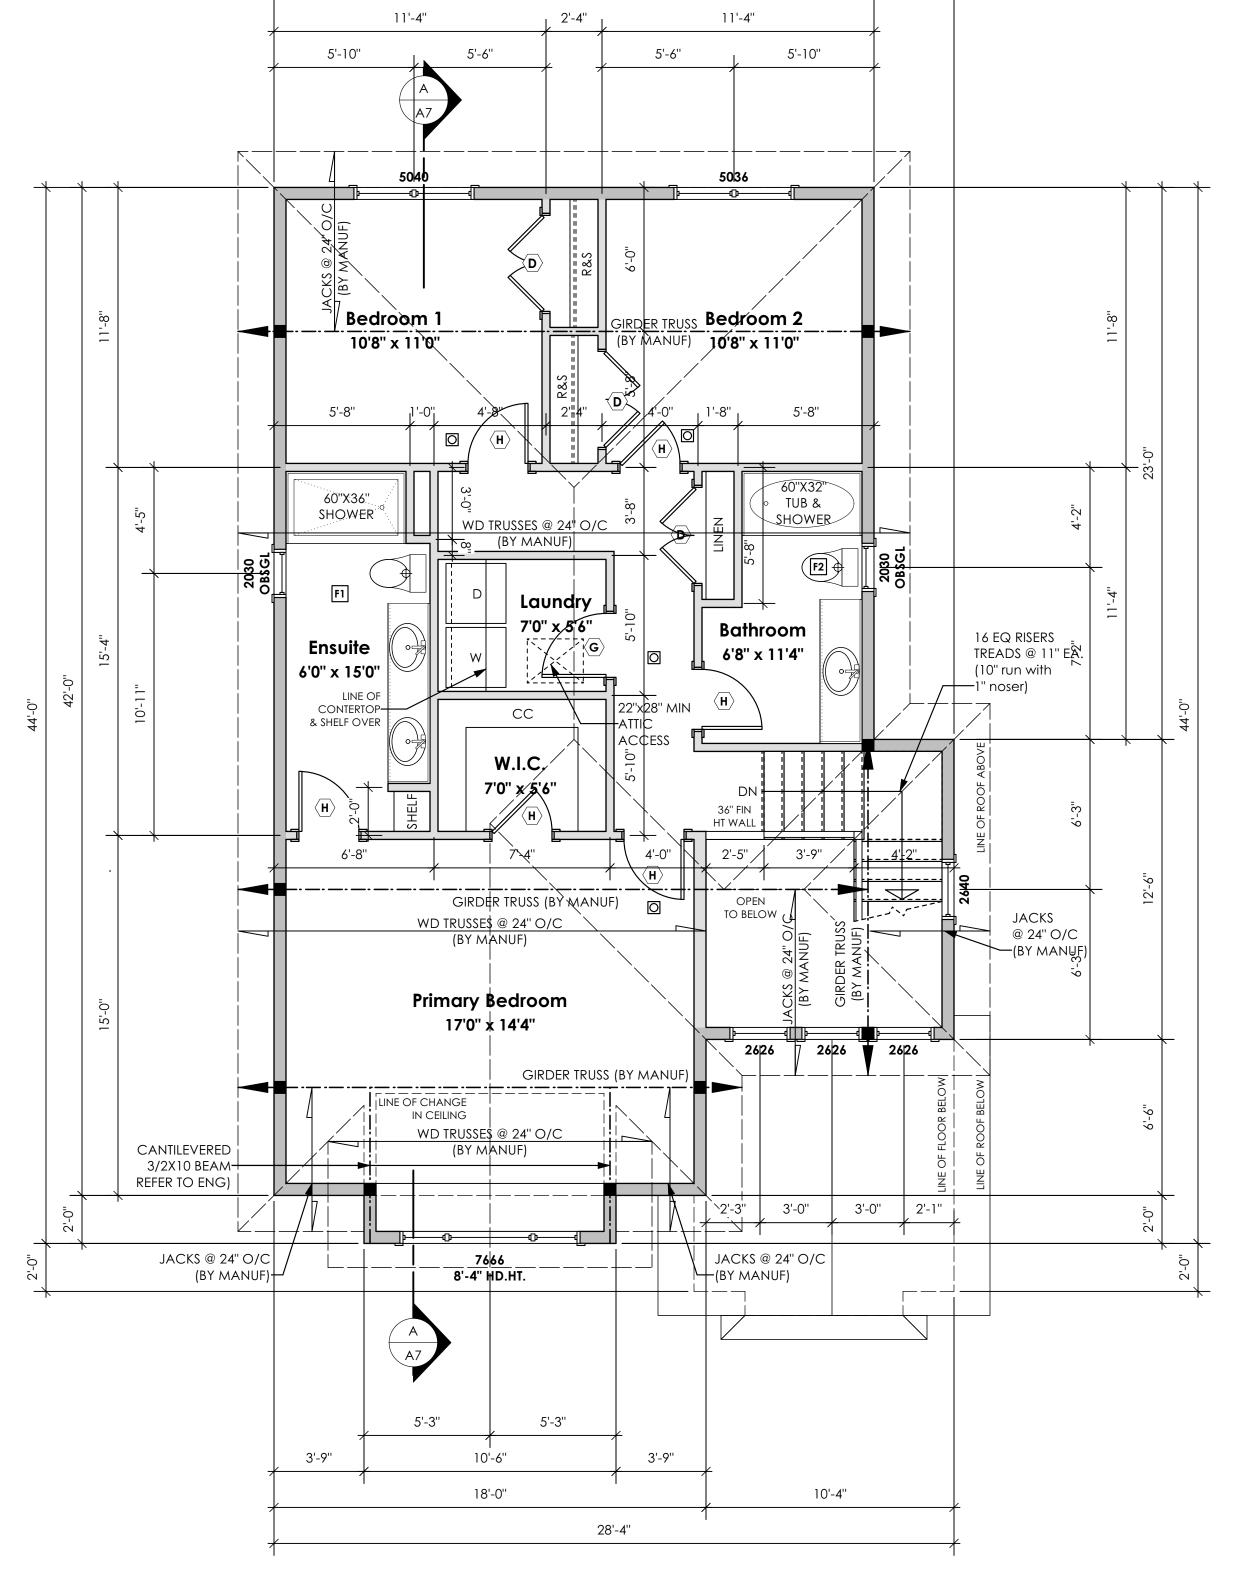

28'-4"

25'-0"

Main Floor Plan

Scale: 1/4" = 1'-0"

28'-4"

3'-5"

PRIMARY: 1080.25 sq.ft. (100.36 sq.m.)

13'-0''

7'-6''

OPEN
TO ABOVE

14'0" x 10'0"

Family Room 14'0" x 13'10"

7'-6''

(BY ENG)

FL CANTILEVERED BEAM (BY ENG)

Living Room

17'0" x 16'0"

17'6" x 8'0"

60611 GLASS SLIDER HDR
DBL BOTTOM PLATE (BY ENG)

5'-0''

Kitchen

Dining Room

17'0" x 10'8"

HDR (BY ENG)

membrane

42" FIN. HT. ALUMINUM GUARD C/W OBSCURED GLAZING PANELS

TO COMPLY WI. B.C.B.C. 9.8.8——

can/cgsb 37.54

NOTE:
STRUCTURAL ENGINEER TO REVIEW PLAN (WHERE REQUIRED)
AND SPECIFY STRUCTURE AS DEEMED NECESSARY. IT IS
THE RESPONSIBILITY OF THE OWNER. OR CONTRACTOR TO
VERIFY ALL ENGINEERING REQUIREMENTS WITH MUNICIPAL
BUILDING DEPARTMENTS PRIOR TO STARTING WORK.

16 EQ RISERS

TREADS @ 11" EA.

–(10" run with 1" noser)

TREADS @ 11" EA.

-(10" run with 1" noser)

4'-2''

WD TRUSSES @ 24" O/C (BY MANUF)

5050 7'-10" HD.HT.

3'-3 1/2" 3'-3 1/2"

10'-10"

9'10" x 10'0"

STRUCTURAL WOOD ELEMENTS WITHIN 150MM (6") FROM FINISHED GROUND LEVEL SHALL BE PRESSURE TREATED WITH A PRESERVATIVE FOR TERMITE AND DECAY PROTECTION B.C.B.C. 2012 9.3.2.9.(3)

2 Upper Floor Plan
Scale: 1/4" = 1'-0"
PRIMARY: 929.06 sq.ft. (86.31 sq.m.)

Leeward Traditional

Date

Aug. 31, 2023

Project Address

3451 Trumpeter Street Royal Bay - Sector 7 Colwood, B.C. **Prepared for**

Verity Construction

Project #


8298-39

Scale

As Noted

Drawn By

MRB

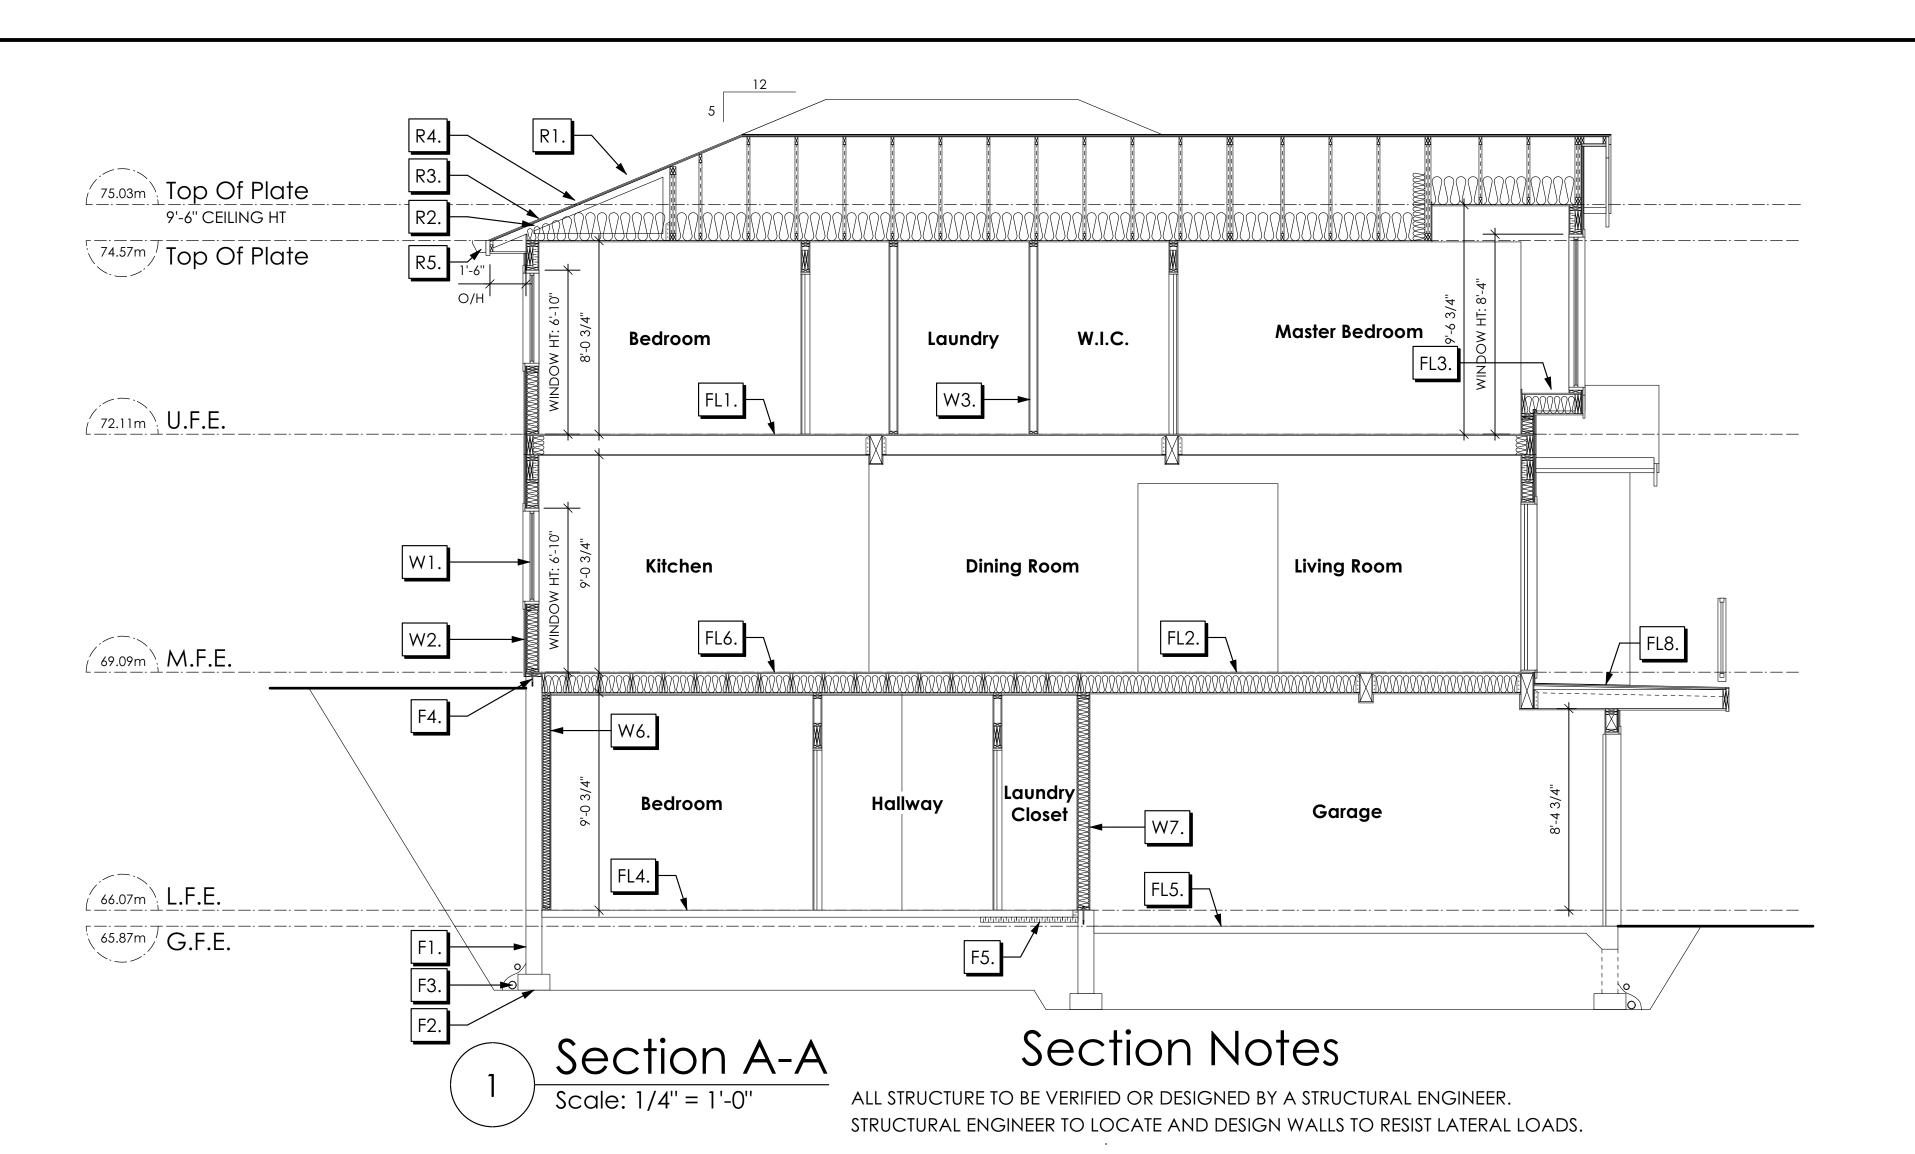

ROOFS

- R1. LAMINATED ASPHALT SHINGLES ON
 7/16" ORIENTED STRAND BOARD C/W "H" CLIPS
 WD TRUSSES (DESIGNED BY MANUF.)
 14 1/2" FIBRE GLASS LOOSE FILL INSULATION
 (ALLOW FOR SETTLING)
 6 MIL POLY'N V.B.
 5/8" GYPSUM BOARD
- R2. PROVIDE 2 1/2" (63MM) CLEAR BETWEEN
 R-20 INSULATION AND SHEATHING.
 (MIN. R-20 @ ROOF-WALL CONNECTION FOR
 4'-0" (1.2M) AROUND PERIMETER OF BUILDING.
 AIR VENTILATION BAFFLES TO BE INSTALLED
 WHERE REQUIRED IN AS PER BCBC 9.19.)
- R3. EAVE PROTECTION

 CONT. UP ROOF SLOPE FOR 12"

 PAST EXTERIOR WALL.
- R4. PROVIDE 1 SQ.FT. ATTIC VENT PER
 300 SQ.FT. OF INSULATED AREA MIN.
 25% OF REQUIRED TO BE @ TOP AND BOTTOM
 (TO COMPLY WI. B.C. BLDG. CODE 9.19.1)
- R5. PRE-FIN. FASCIA GUTTER
 2×8 FASCIA BD.
 2×4 SUB. FASCIA BD.
 VENTED SOFFIT
 (SEE CONTRACTOR)

FLOORS

- FL1. FINISHED FLOORING ON
 11/16" ORIENTED STRAND BOARD
 (NAILED & GLUED TO FLOOR STRUCT. BELOW) ON
 2×10 FLOOR JOISTS @ 16" OR 12" O/C
 C/W 2×2 X-BRIDGING @ 7.0' O/C (MAX)
 1/2" GYPSUM BOARD
- FL2. FINISHED FLOORING ON
 11/16" ORIENTED STRAND BOARD
 (NAILED & GLUED TO FLOOR STRUCT. BELOW) ON
 2×10 FLOOR JOISTS @ 16" OR 12" O/C
 C/W 2×2 X-BRIDGING @ 7.0' O/C (MAX)
 R-31 INSULATION
 5/8" X-TYPE GYPSUM BOARD
 (BETWEEN GARAGE AND LIVING SPACE)
- 19/32" ORIENTED STRAND BOARD
 (FASTENED & GLUED TO FLOOR STRUCT. BELOW) ON
 2×10 FLOOR JOISTS @ 16" OR 12" O/C
 C/W 2×2 X-BRIDGING @ 7.0' O/C (MAX)
 PROVIDE R-31 F/G BATT INSULATION IN
 JOIST CAVITY C/W
 BUILDING WRAP
 VENTED SOFFIT (TO OWNERS SPEC'S)
 TO ALL SUSPENDED FLOOR AREAS
- FL4. 3 1/2" CONCRETE SLAB
 6 MIL. POLY'N V.B.
 6" COMPACTED GRAVEL OR SAND

FL3. FINISHED FLOORING ON

- FL5. 3 1/2" CONCRETE SLAB 6 MIL. POLY'N V.B. 6" COMPACTED GRAVEL OR SAND SLOPE TO DOORS 1"
- FL6. F8d RATED FLOOR ASSEMBLY
 (BC BUILDING CODE TABLE 9.10.3.1.B)
 FINISHED FLOORING ON
 19/32" ORIENTED STRAND BOARD OR EQ.
 (FASTENED & GLUED TO FLOOR STRUCT. BELOW) ON
 2×10 FLOOR JOISTS @ 16" OR 12" O/C
 C/W 2×2 X-BRIDGING @ 7.0' O/C (MAX)
 R-31 INSULATION
 RESILIENT METAL CHANNELS @ 24" O/C
 1 LAYERS 5/8" X-TYPE GYPSUM BOARD
 30 MINUTE F.R.R., 50 S.T.C.

- .7. DECKING MEMBRANE
 (TO COMPLY WITH CAN/CGSB 37.54) ON
 19/32" ORIENTED STRAND BOARD
 2×10 DECK JOISTS @ 16" O/C C/W
 (PROVIDE ADEQUATE MEMBRANE
 "UPSTAND" @ EXT. WALL.)
 (SLOPE JOISTS TO PROVIDE MIN.1:50 SLOPE)
 (NOT IN SECTION)
- L8. DECKING MEMBRANE
 (TO COMPLY WITH CAN/CGSB 37.54) ON
 19/32" ORIENTED STRAND BOARD C/W "H" CLIPS
 TAPERS TO PROVIDE MIN.1:50 SLOPE ON
 2×10 DECK JOISTS @ 16" O/C C/W
 (PROVIDE ADEQUATE MEMBRANE
 "UPSTAND" @ EXT. WALL.)
 - W2. CONC. FIBRE BOARD ON
 9.5MM (3/8") AIR SPACE / STRAPPING
 3/8"×2" BORATE TREATED PLYWOOD STRAPPING
 HOUSE WRAP (A.B.) (TYVEK OR EQ.)
 7/16" ORIENTED STRAND BOARD SHEATHING
 2×6 STUDS @ 16" O/C
 R-20 INSULATION
 6 MIL. POLYETHYLENE VAPOUR BARRIER
 1/2" GYPSUM BOARD

ALL STRUCTURE TO BE VERIFIED OR DESIGNED BY A STRUCTURAL ENGINEER.

WITH B.C. BUILDING CODE 2012 9.23.13.2 AND SUPPLY DETAILS IF REQUIRED

AND INTERIOR BRACED WALL PANELS TO RESIST LATERAL LOADS IN COMPLIANCE

STRUCTURAL ENGINEER TO LOCATE AND DESIGN REQUIRED EXTERIOR

WALLS

2/2"X10" LINTEL OVER (@ BEARING WALLS ONLY)

(GLAZING IN ALL EXTERIOR DOORS & WITHIN 3 FT.

OF EXTERIOR DOORS TO BE SHATTERPROOF (SP))

WINDOW REQUIREMENTS DERIVED FROM BCBC

TABLE C-4 AS PER BCBC 9.7.4.3. AND ARE TO BE

LANGFORD, CLASS R. DP 960, PG 20, WATER RESIST, 220, A2,

WINDOW UNITS UPON INSTALLATION FOR INSPECTION.

USED TO SATISFY THE REQUIREMENTS OF

AAMA/WDMA/CSA 101/I.S.2/A440, "NAFS":

RATINGS MUST BE CLEARLY LABELED ON ALL

ENERGY STAR LOW "E" RATING IN

(TYPICAL, WI. 2 1/2" XPS INSULATION)

THERMAL BREAK FRAMES

FLASHING OVER @ EXTERIOR

W1. DOUBLE GLAZING

W3. INTERIOR PARTITION
1/2" GYPSUM BOARD ON EACH SIDE
OF 2×4 STUDS @ 16" O/C OR
2×6 STUDS @ 16" O/C (IF NOTED)

(REFER TO DETAILS ON D1)

W4. PRE-MANUFACTURED STONE VENEER
(INSTALLED TO MANUF. SPEC)
LIME BASED MORTAR SETTING BED ON
LIME BASED MORTAR SCRATCH COAST ON
METAL LATHE INSTALLED HORIZONTALLY
OVERLAP HORIZONTAL AND VERTICAL SEAMS 1"
SEMI-RIGID BACK BOARD
(HAL-TEX RAINBOARD OR EQ.)
9.5MM (3/8") AIR SPACE / STRAPPING
3/8"×2" BORATE TREATED PLYWOOD STRAPPING
HOUSE WRAP (A.B.) (TYVEK OR EQ.)
7/16" ORIENTED STRAND BOARD SHEATHING
2×6 STUDS @ 16" (AS REQUIRED)
(NOT SHOWN IN SECTION)

- W5. 5/8" X-TYPE GYPSUM BOARD ON 2×6 STUDS @ 16" O/C C/W R-20 INSULATION 6 MIL. POLY'N V.B 1/2" GYPSUM BOARD (BETWEEN GARAGE & LIVING) (NOT SHOWN IN SECTION)
- W6. 1/2" GYPSUM BOARD ON
 6 MIL. POLY'N V.B.
 2×4 STUDS @ 24" O/C C/W
 R-12 BATT INSULATION
 2 PLY 30 MINUTE BUILDING PAPER OR
 12.7MM (1/2") AIR SPACE
 (PROVIDE REQUIRED FIRE STOPS IN WALL
 ASSEMBLIES TO COMPLY WITH
 B.C. BLDG. CODE 9.10.16.)
- W7. B.C. BUILDING CODE (TABLE 9.10.3.1.A)
 RATED WALL ASSEMBLY W3C
 1 LAYER 1/2" X-TYPE GYPSUM BOARD
 RESILIENT METAL CHANNELS @ 24" O/C
 2×4 STUDS @ 16" O/C OR
 2×6 STUDS @ 16" O/C (IF NOTED) C/W
 3 1/2" FIBRE GLASS SOUND BATTS
 1 LAYER 1/2" X-TYPE GYPSUM BOARD
 45 MIN. F.R.R 43 S.T.C
 (BETWEEN PRIMARY LIVING / GARAGE
 & SECONDARY SUITE)

FOUNDATION WALLS

- F1. DAMP PROOFING (WHERE REQUIRED) ON 8" THK. CONC. FOUNDATION WALL C/W 15 M BARS @ 24" O/C B/W
- F2. 16"X 8" CONC. FOOTINGS

 C/W 2 (TWO) 15M BARS CONT. 3 IN. FROM BOTT.

 ON UNDISTURBED SOIL (SOLID BEARING)
- F3. 4" PERIMETER DRAIN
 3" TIGHT PIPE FOR RWL
 DRAIN ROCK
- F4. ANCHOR BOLTS @ 4.0 FT. O/C MAX C/W SILL GASKETS
- F5. UNDER SLAB INSULATION
 2 1/2" (RSI 2.15) EXTRUDED POLYSTYRENE
 RIGID INSULATION 4'-0" (1.2M)
 CONT. AROUND PERIMETER UNDER
 SLAB INSTALLED HORIZONTALLY
 (VERIFY WITH MUNICIPALITY DEPTH OF FROST LINE)
 (NOT IN SECTION)

Victoria design group

#103 - 891 ATTREE AVENUE VICTORIA, B.C. V9B 0A6 P. 250.382.7374 F. 250.382.7364

Leeward Traditional

Date

Aug. 31, 2023

Project Address
3451 Trumpeter Street
Royal Bay - Sector 7
Colwood, B.C.
Prepared for

Verity Construction

Project #


8298-39

Scale

As Noted

Drawn By

MRB

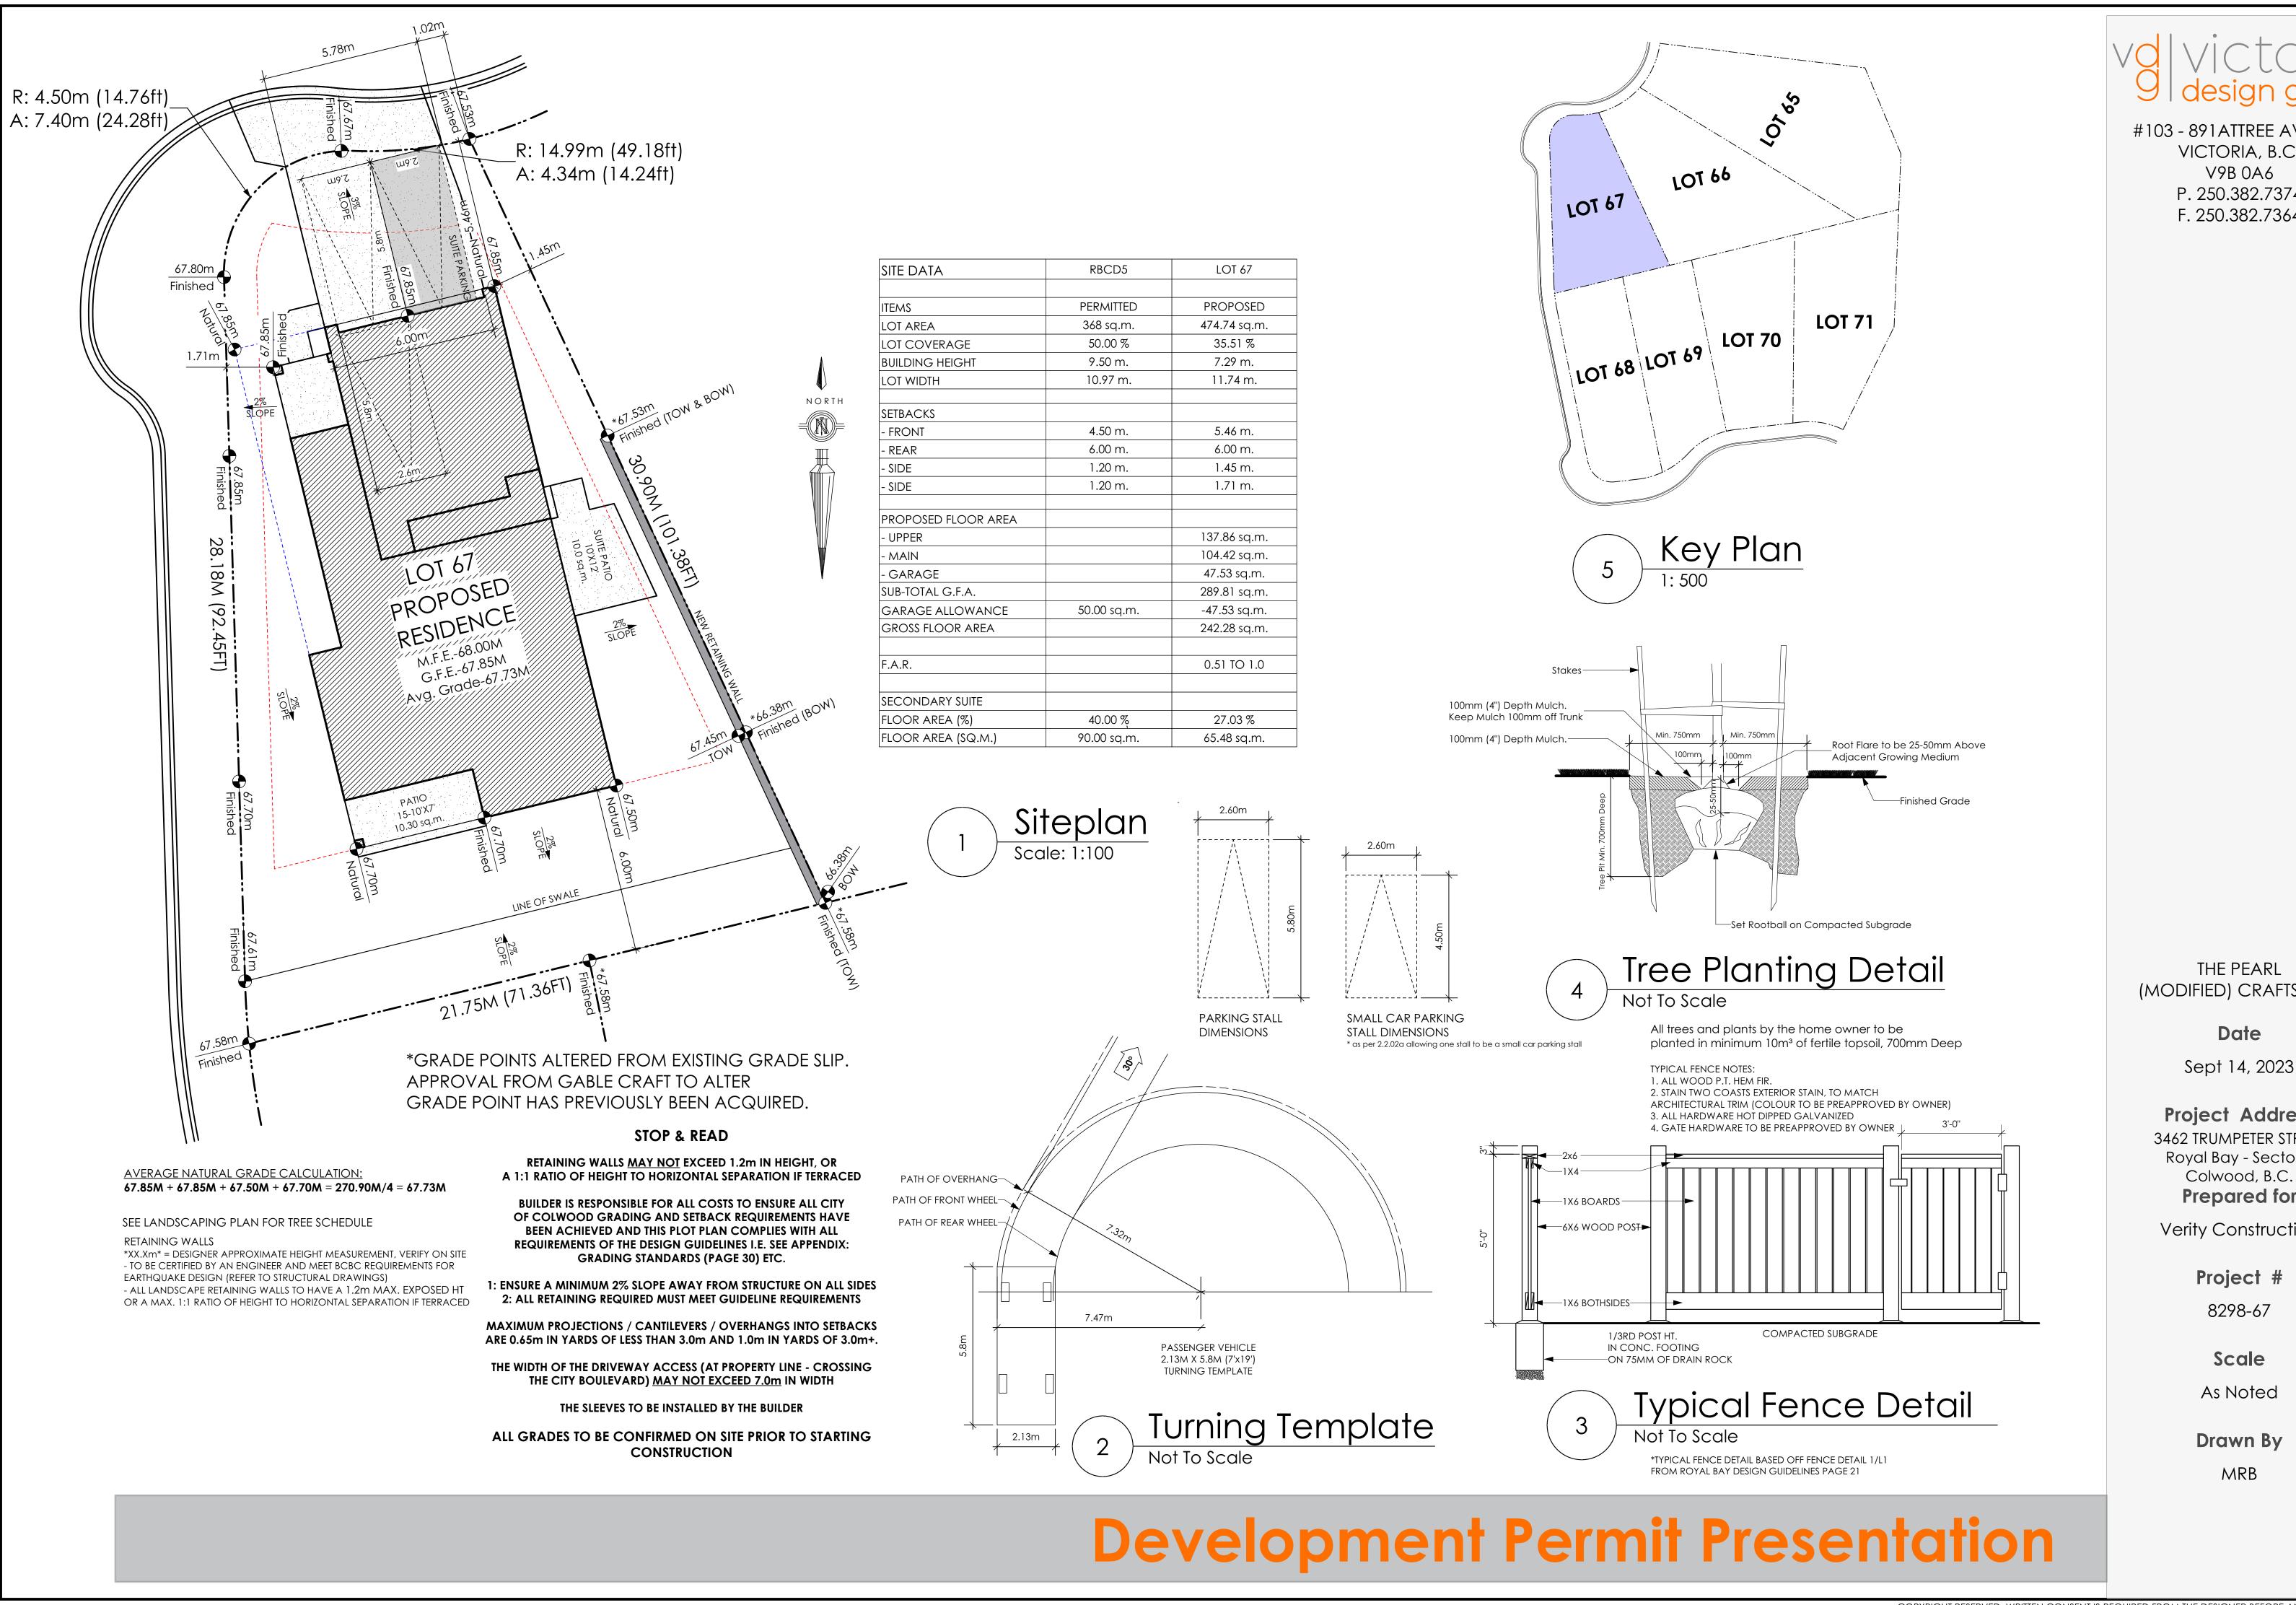

#103 - 891ATTREE AVENUE


VICTORIA, B.C. V9B 0A6 P. 250.382.7374 F. 250.382.7364


THE PEARL (MODIFIED) CRAFTSMAN


Project Address

3462 TRUMPETER STREET Royal Bay - Sector 7 Colwood, B.C. Prepared for

Verity Construction

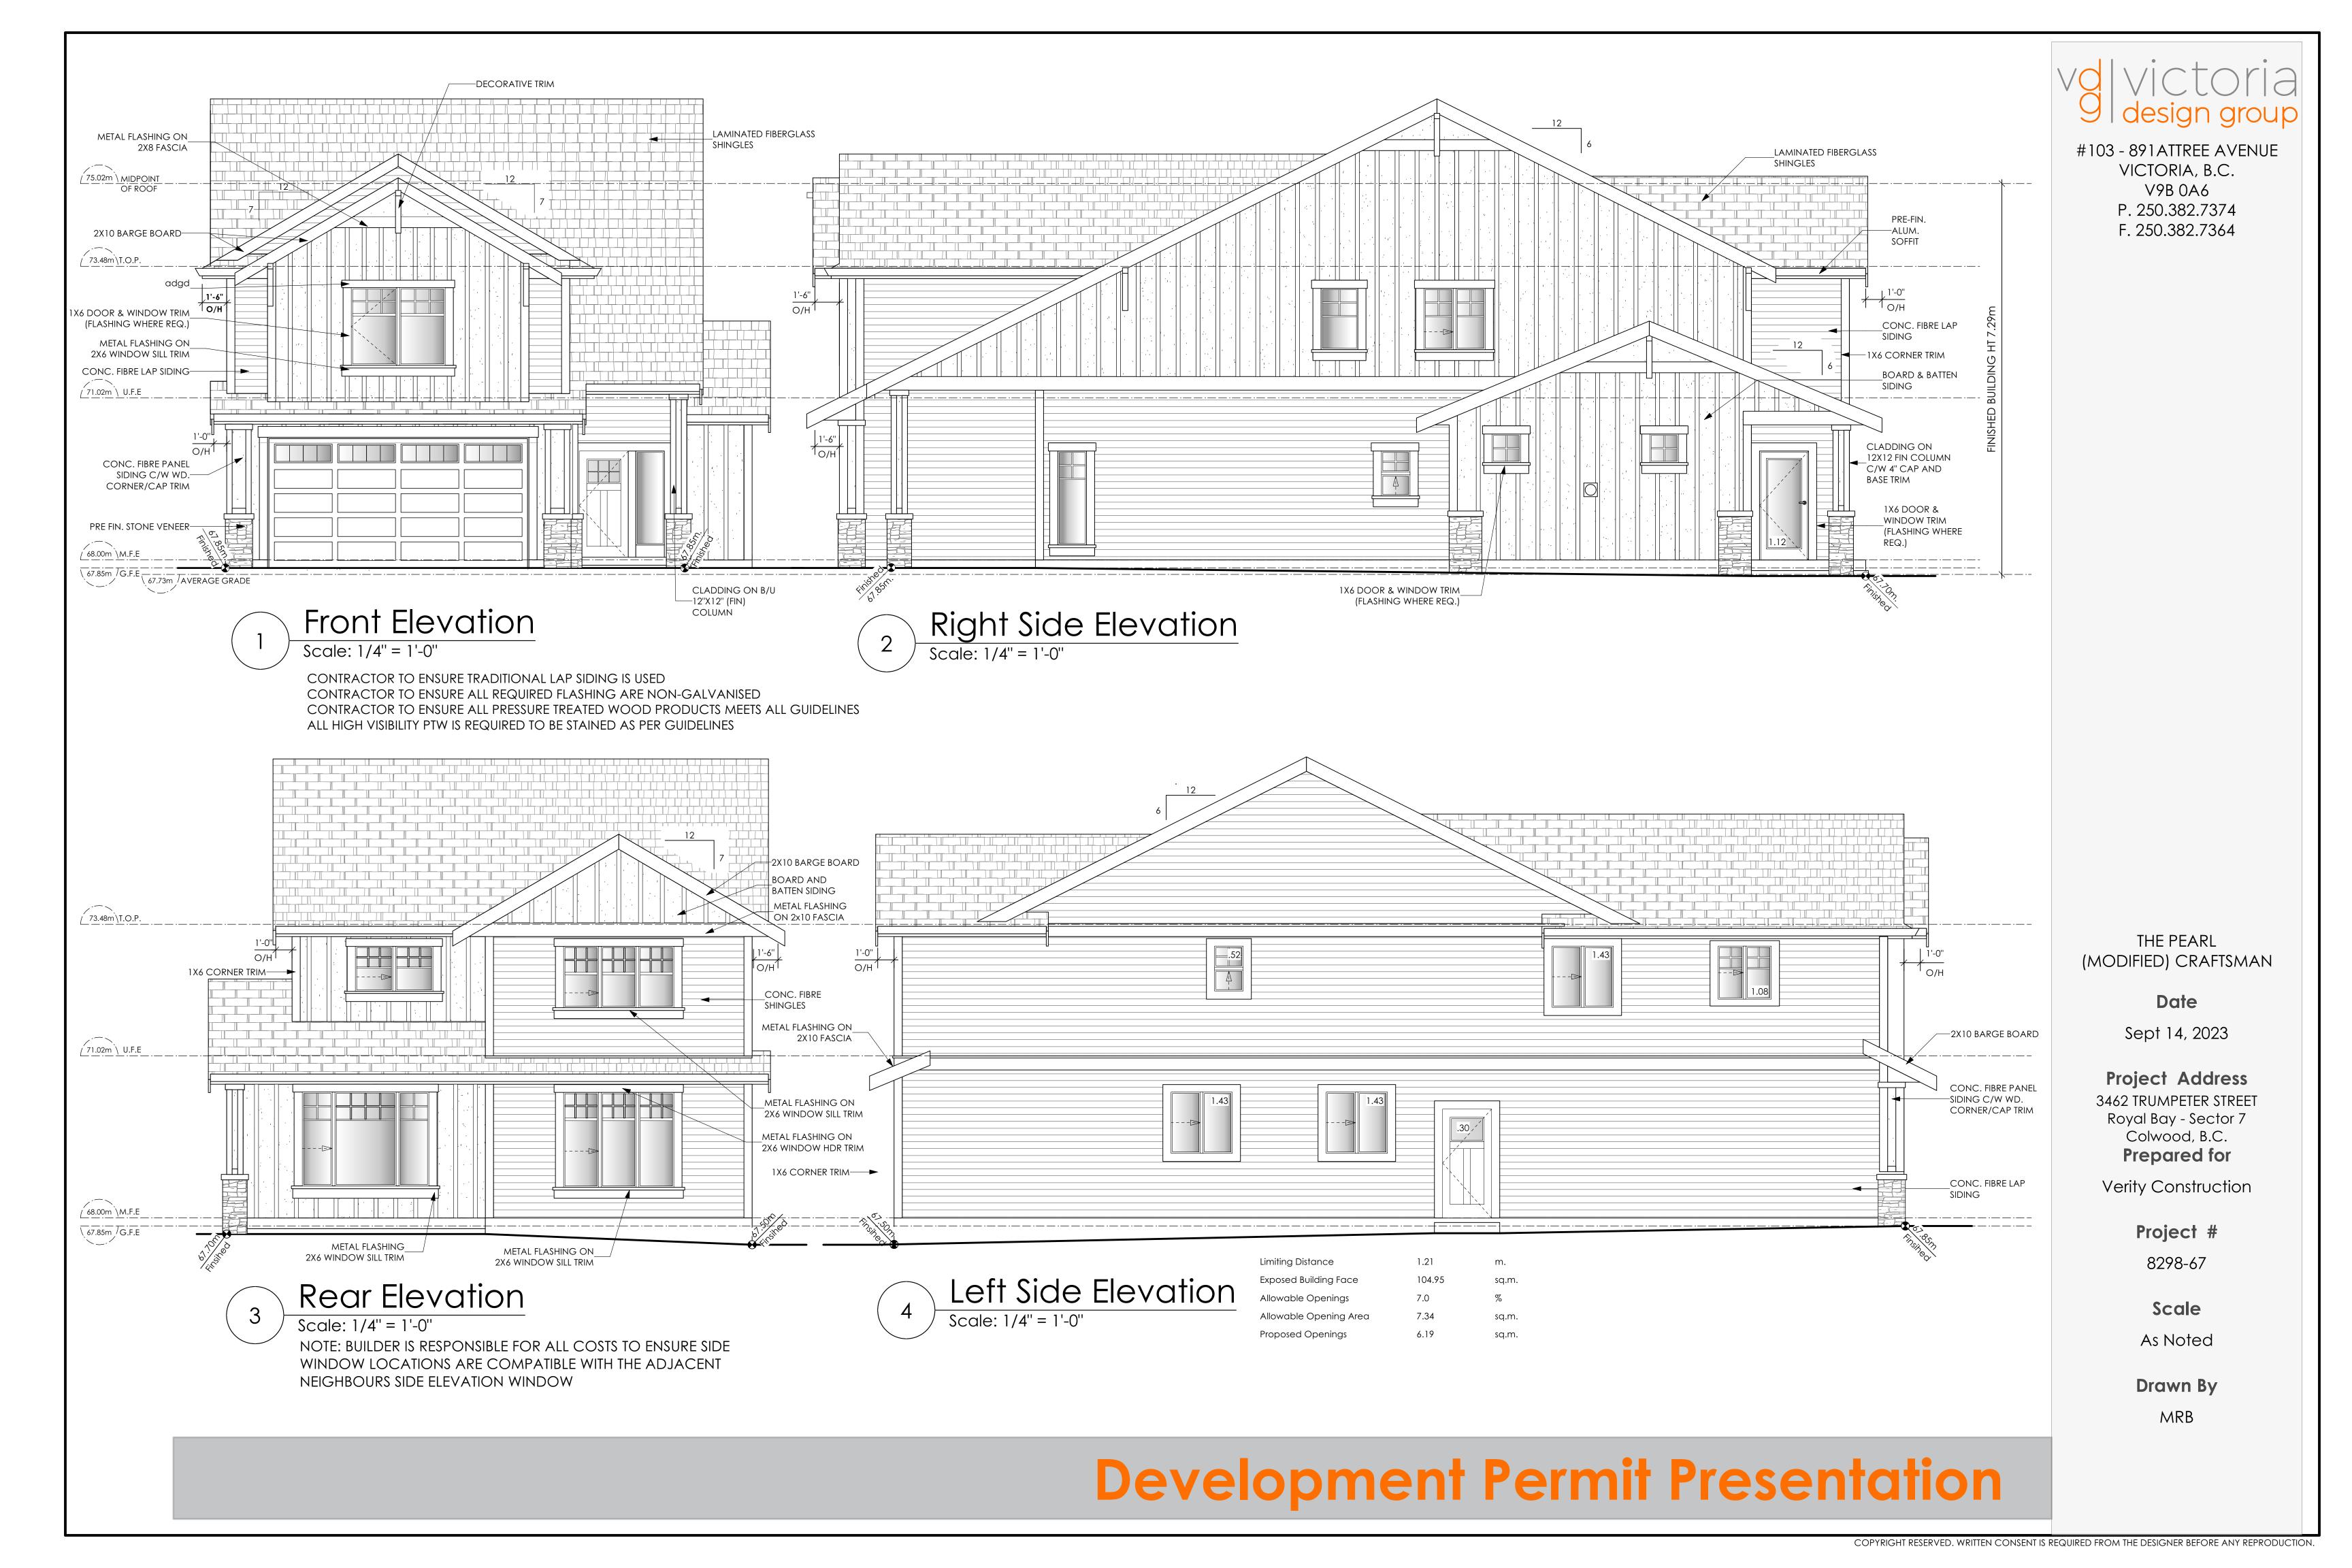

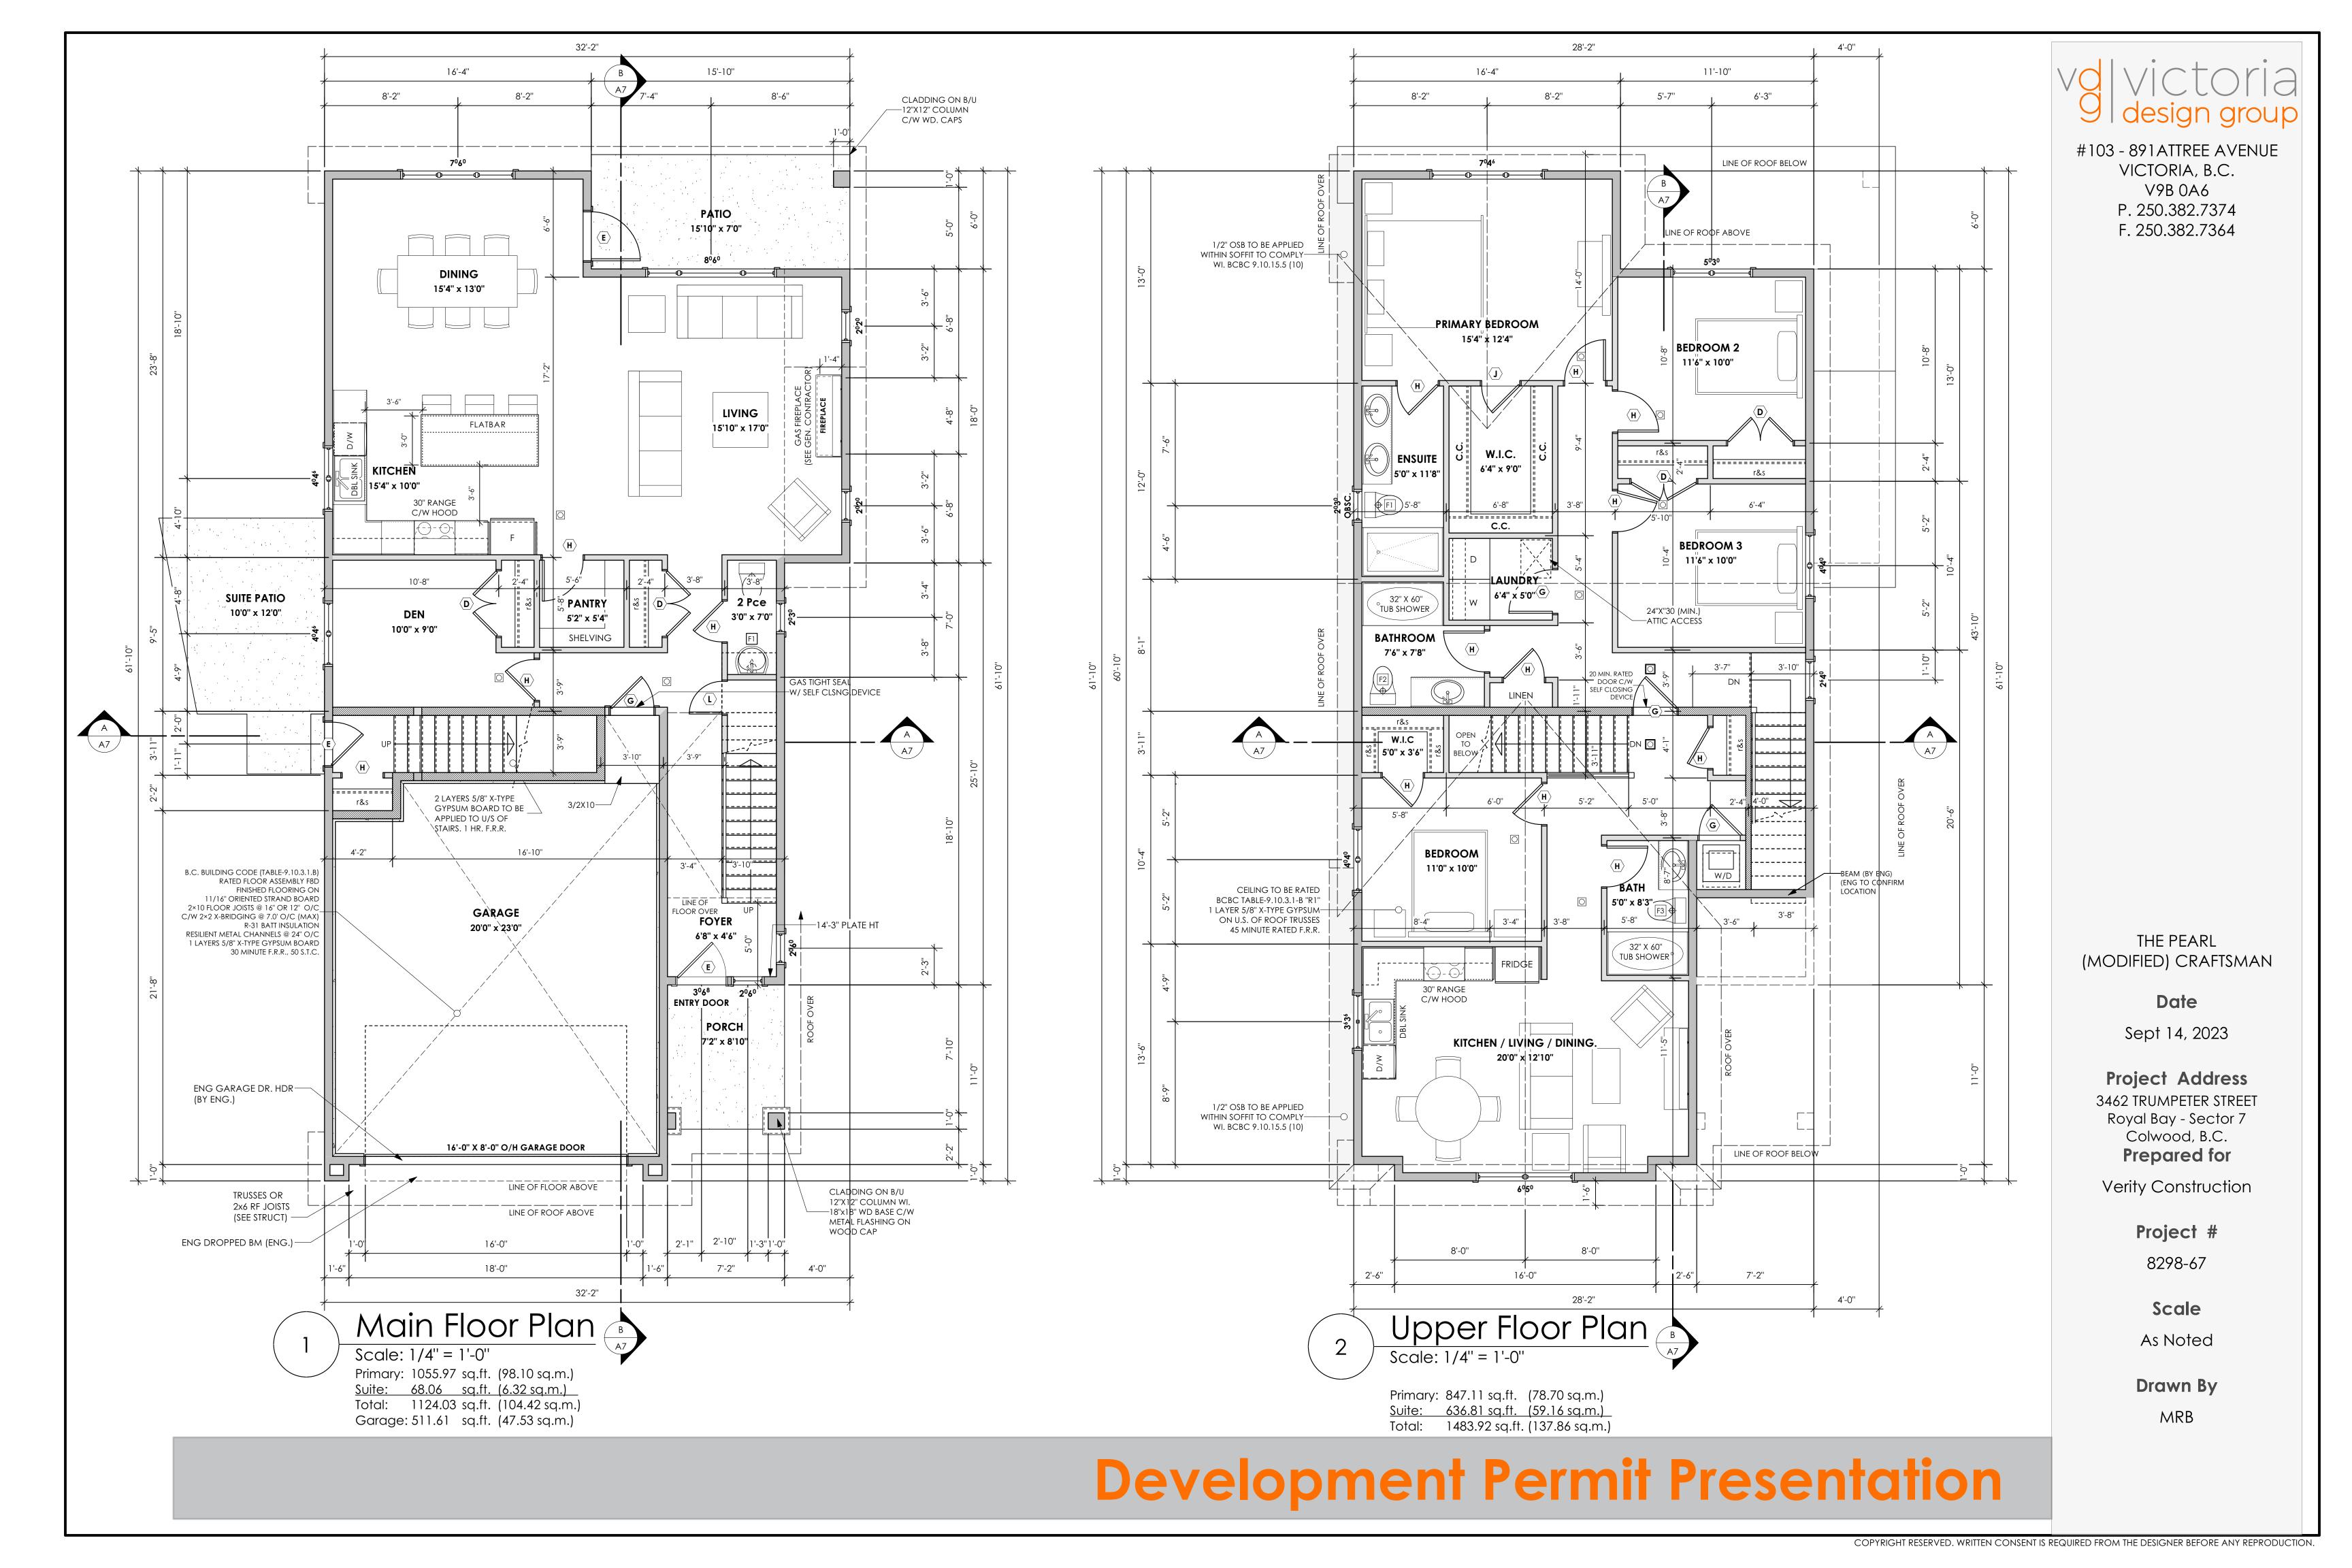

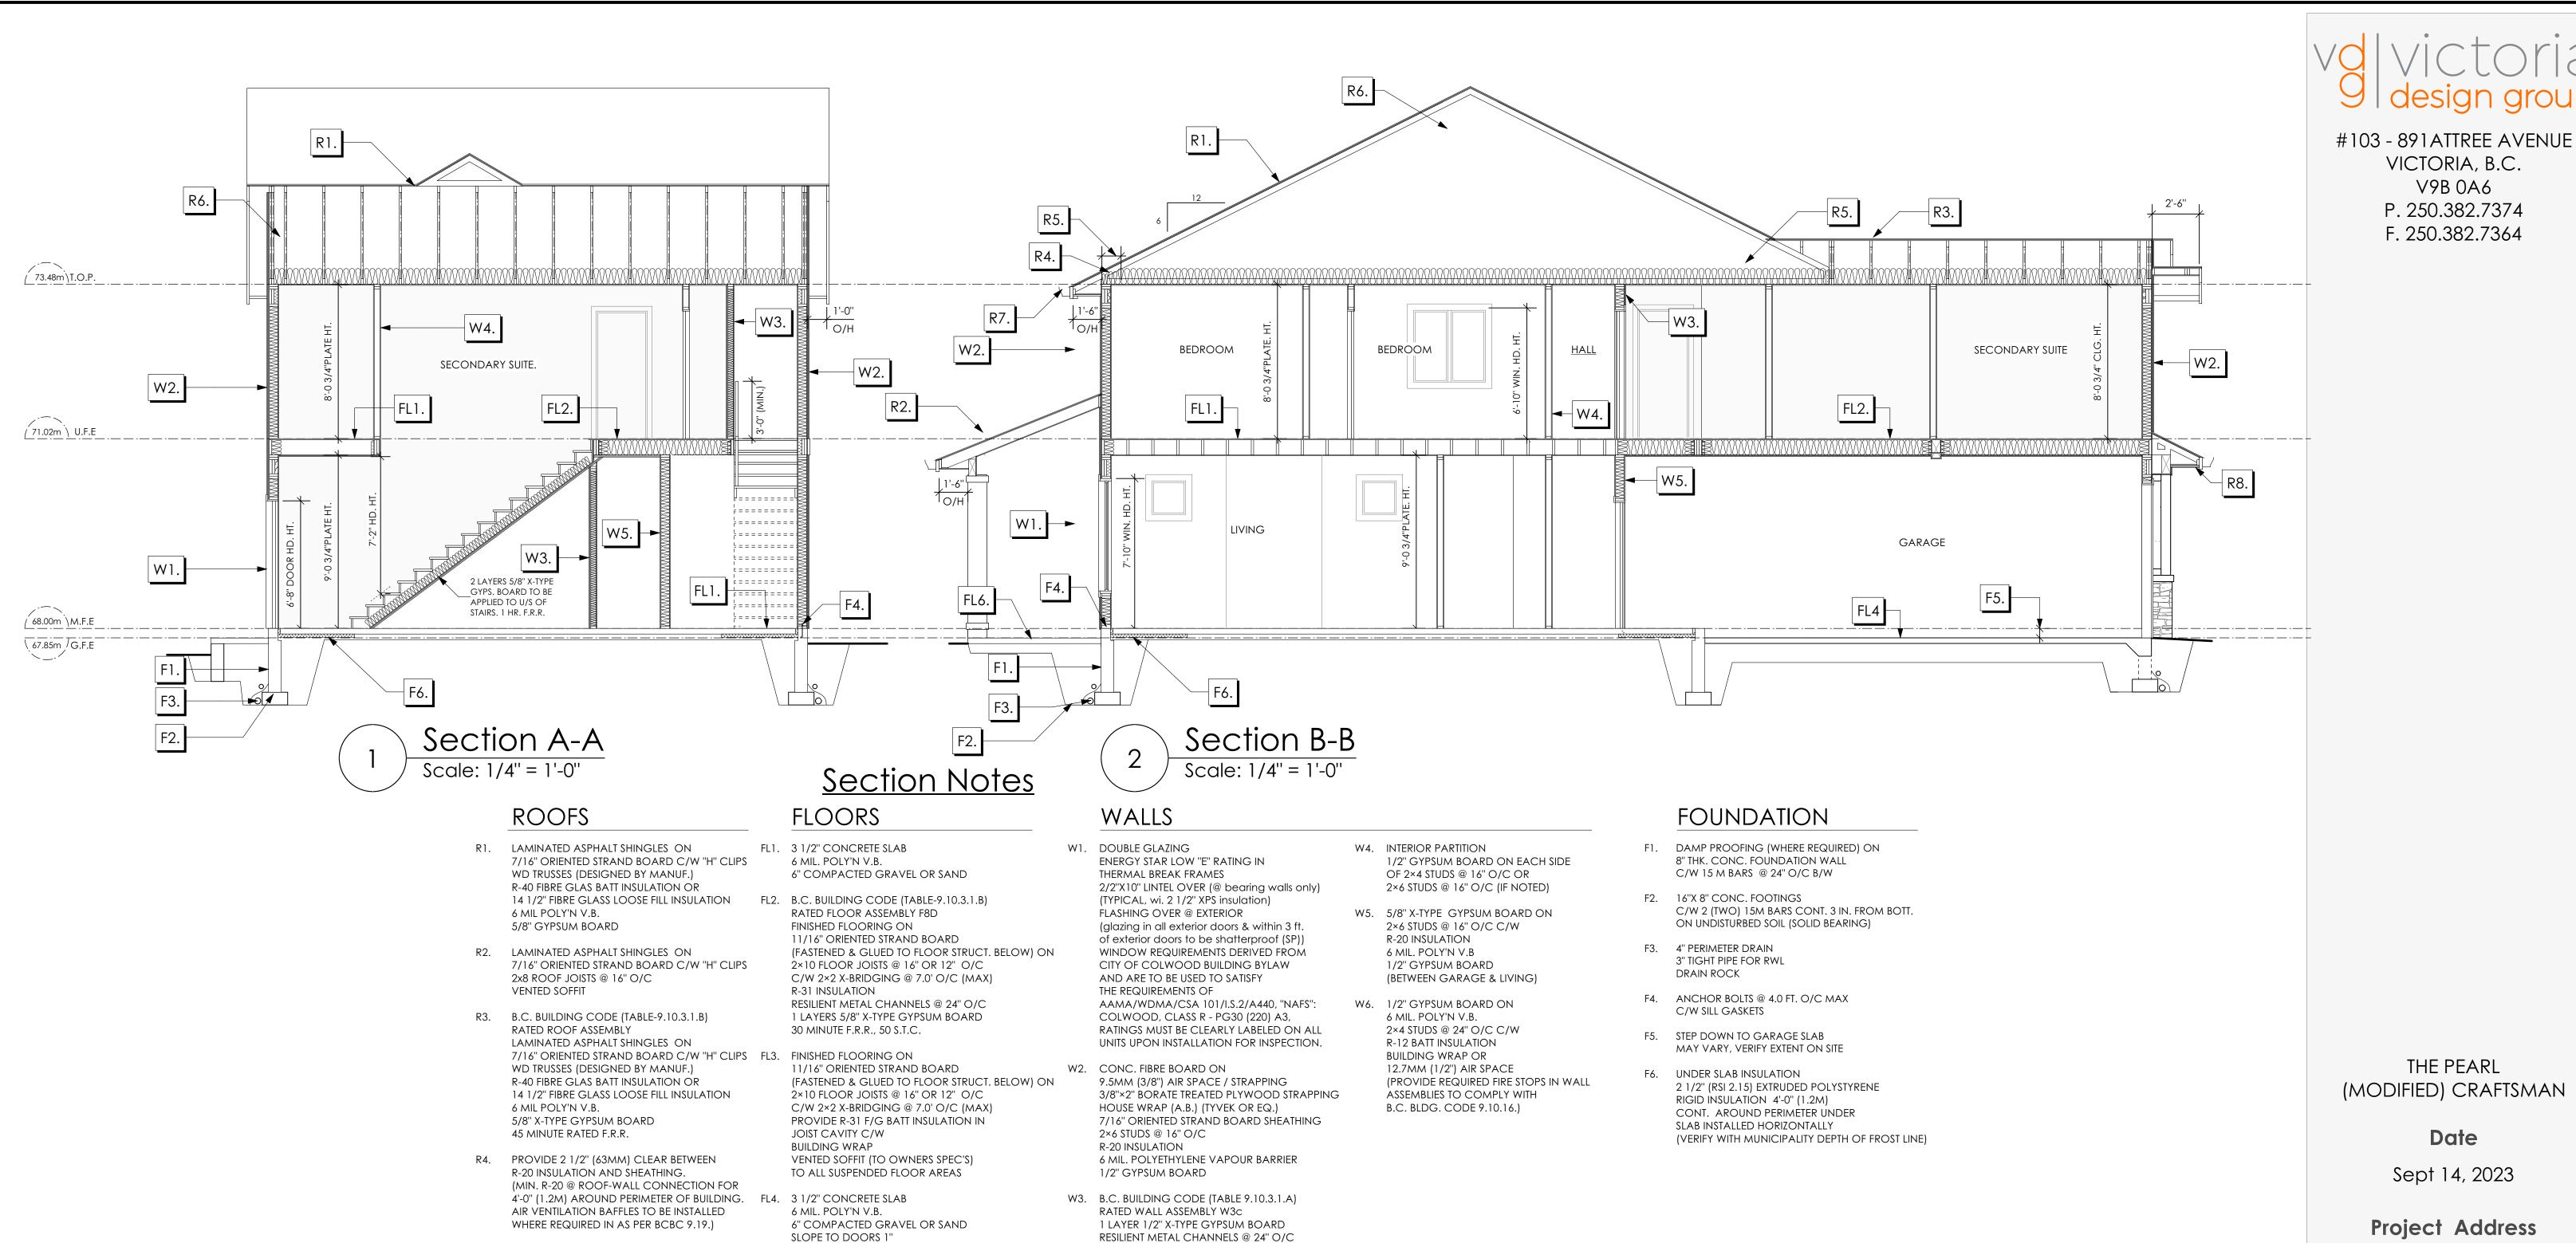

2×4 STUDS @ 16" O/C OR

45 MIN. F.R.R 43 S.T.C

2×6 STUDS @ 16" O/C (IF NOTED) C/W

(BETWEEN PRIMARY LIVING & SECONDARY SUITE)

3 1/2" FIBRE GLASS SOUND BATTS 1 LAYER 1/2" X-TYPE GYPSUM BOARD

EAVE PROTECTION

R7. PRE-FIN. FASCIA GUTTER 2×8 FASCIA BD. 2×4 SUB. FASCIA BD.

> VENTED SOFFIT (SEE CONTRACTOR)

R8. PRE-FIN. FASCIA GUTTER 2×8 FASCIA BD. 2×4 SUB. FASCIA BD.

> VENTED SOFFIT (SEE CONTRACTOR)

PAST EXTERIOR WALL.

CONT. UP ROOF SLOPE FOR 12"

PROVIDE 1 SQ.FT. ATTIC VENT PER

1/2" ORIENTED STRAND BOARD

300 SQ.FT. OF INSULATED AREA MIN.

25% OF REQUIRED TO BE @ TOP AND BOTTOM (TO COMPLY WI. B.C. BLDG. CODE 9.19.1)

THE PEARL

VICTORIA, B.C.

V9B 0A6

P. 250.382.7374

F. 250.382.7364

Date

Sept 14, 2023

Project Address 3462 TRUMPETER STREET Royal Bay - Sector 7 Colwood, B.C. Prepared for

Verity Construction


Project #

8298-67

Scale

As Noted

Drawn By MRB

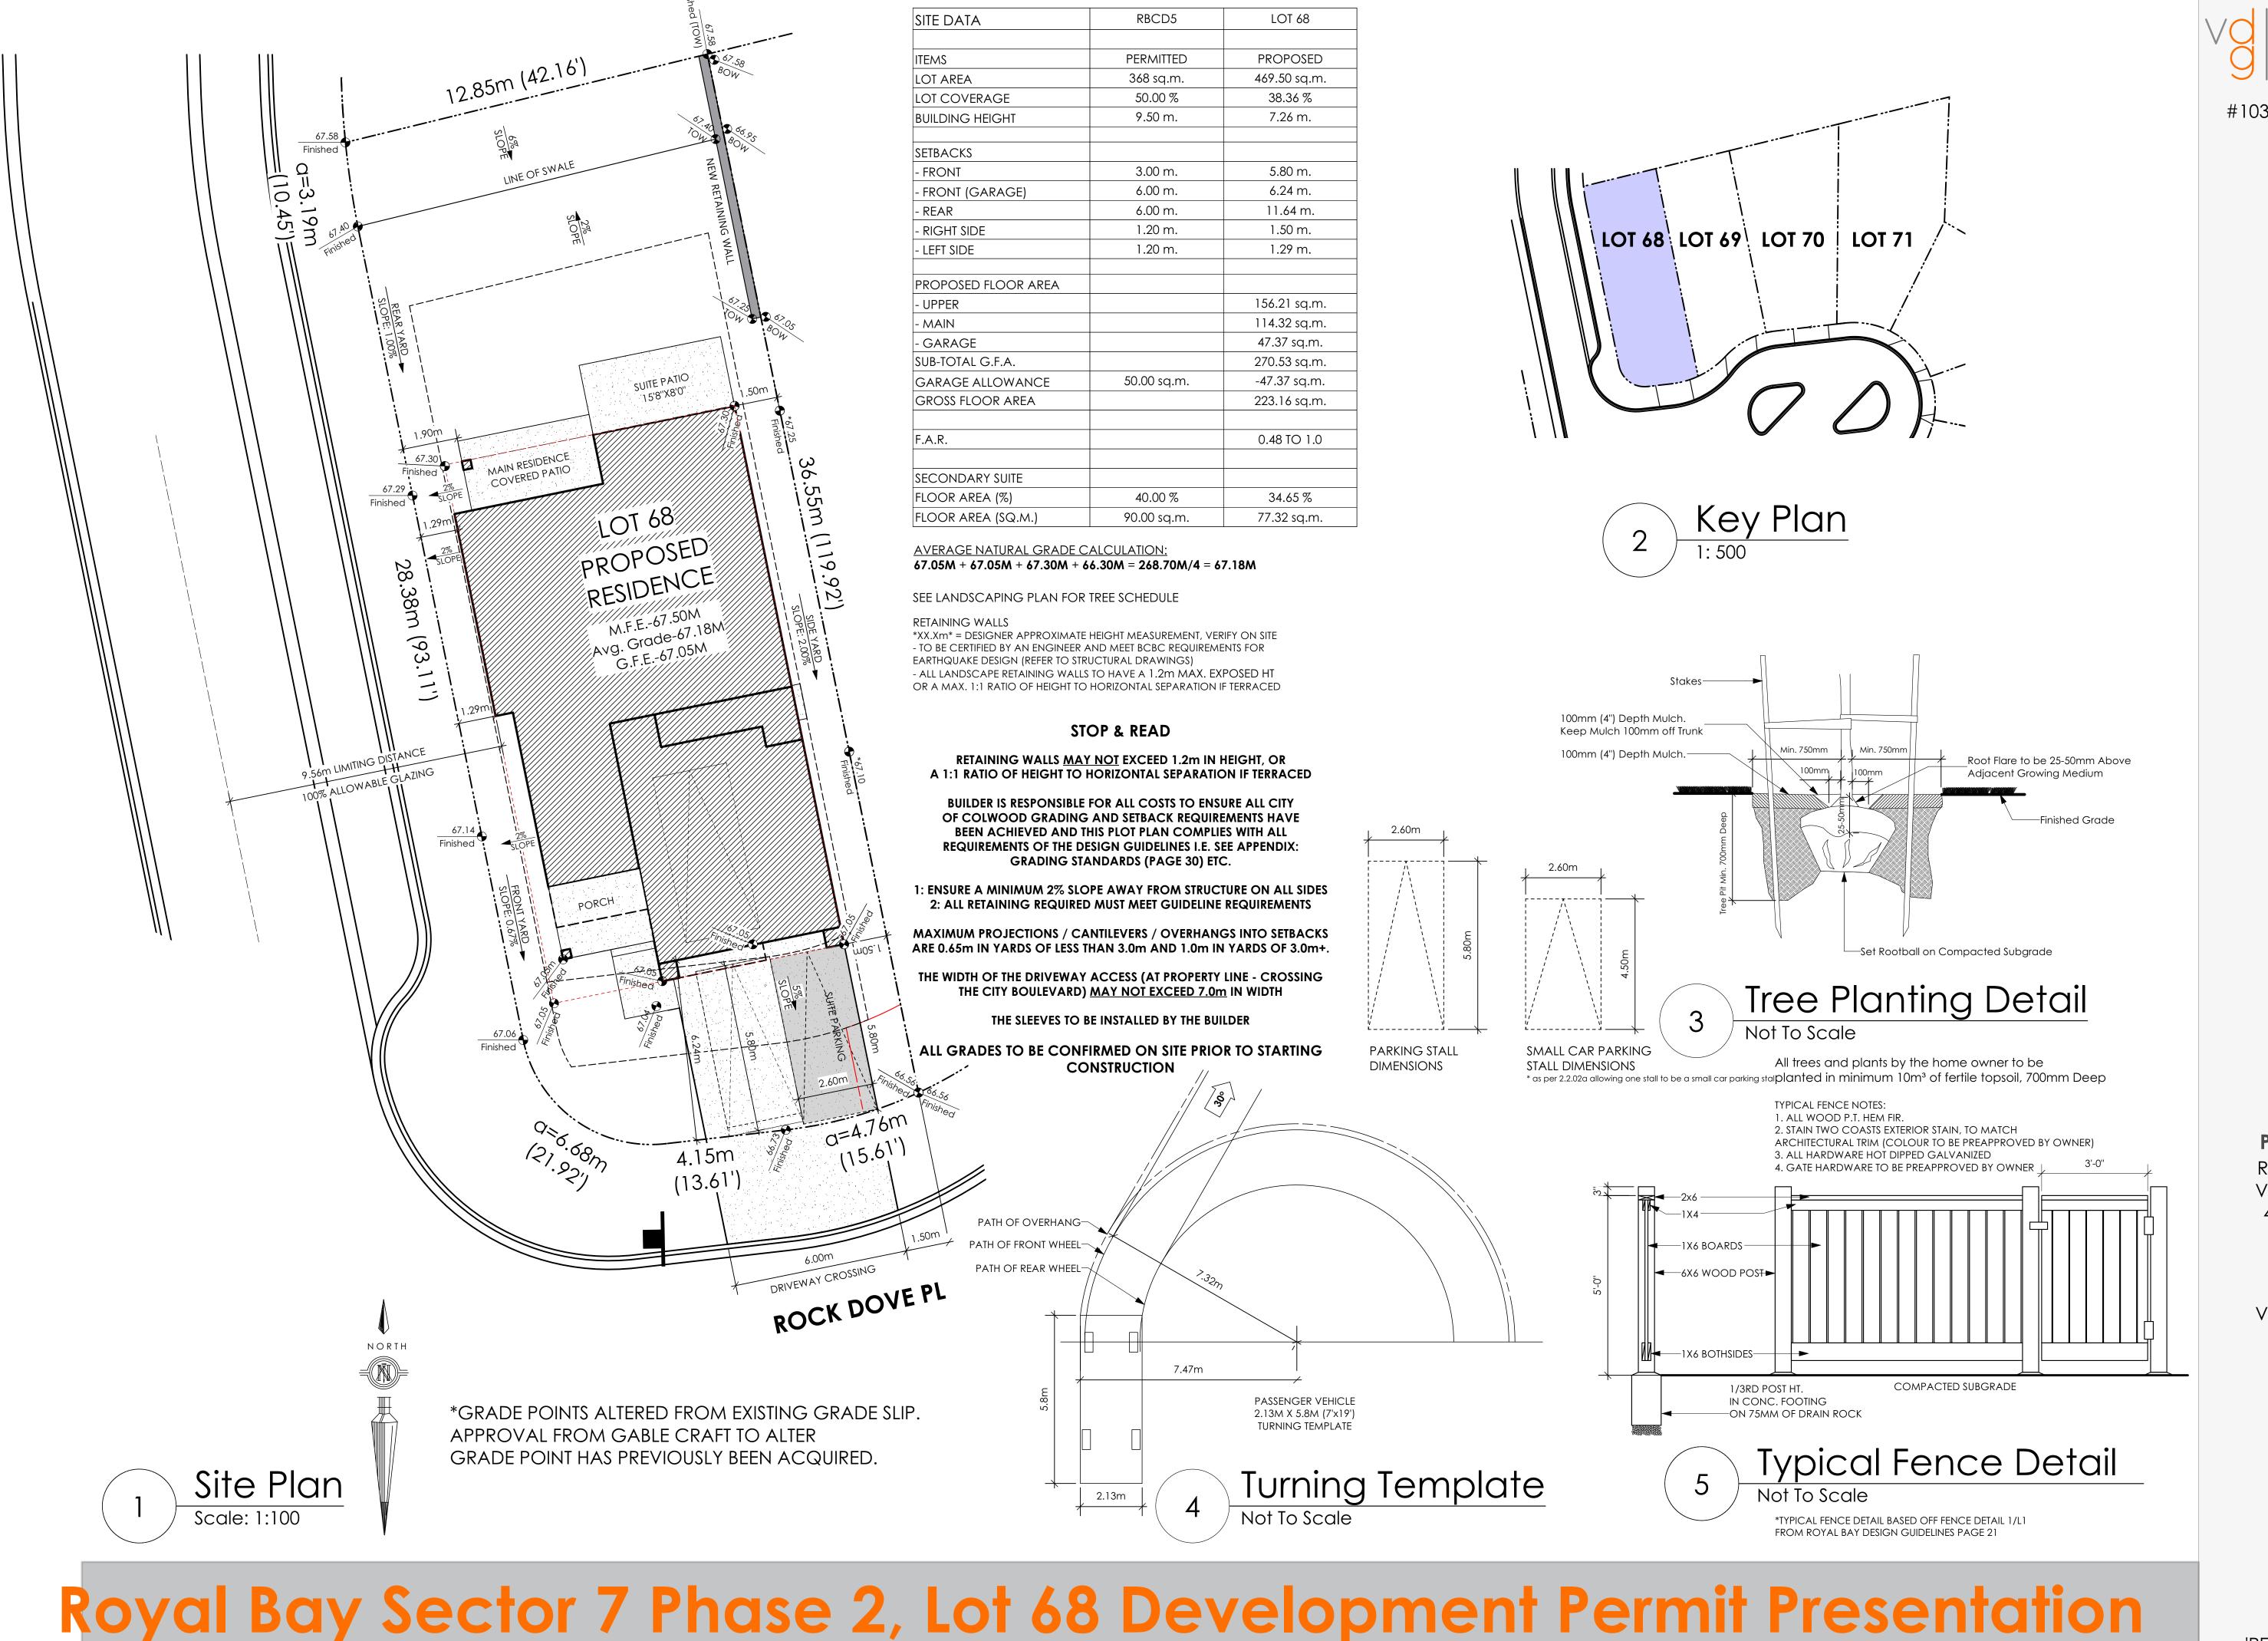

volvictoria 9 design group

#103 - 891ATTREE AVENUE VICTORIA, B.C. V9B 0A6 P. 250.382.7374 F. 250.382.7364

Date

Sept 14, 2023


Project Address
Royal Bay Sector 7
Verity Construction
420 Rock Dove Pl
Lot 68
Langford, B.C.
Prepared for
Verity Construction


Project # 8298-68


ScaleNot to Scale

Drawn By
JTE

'PEARL II' CRAFTSMAN

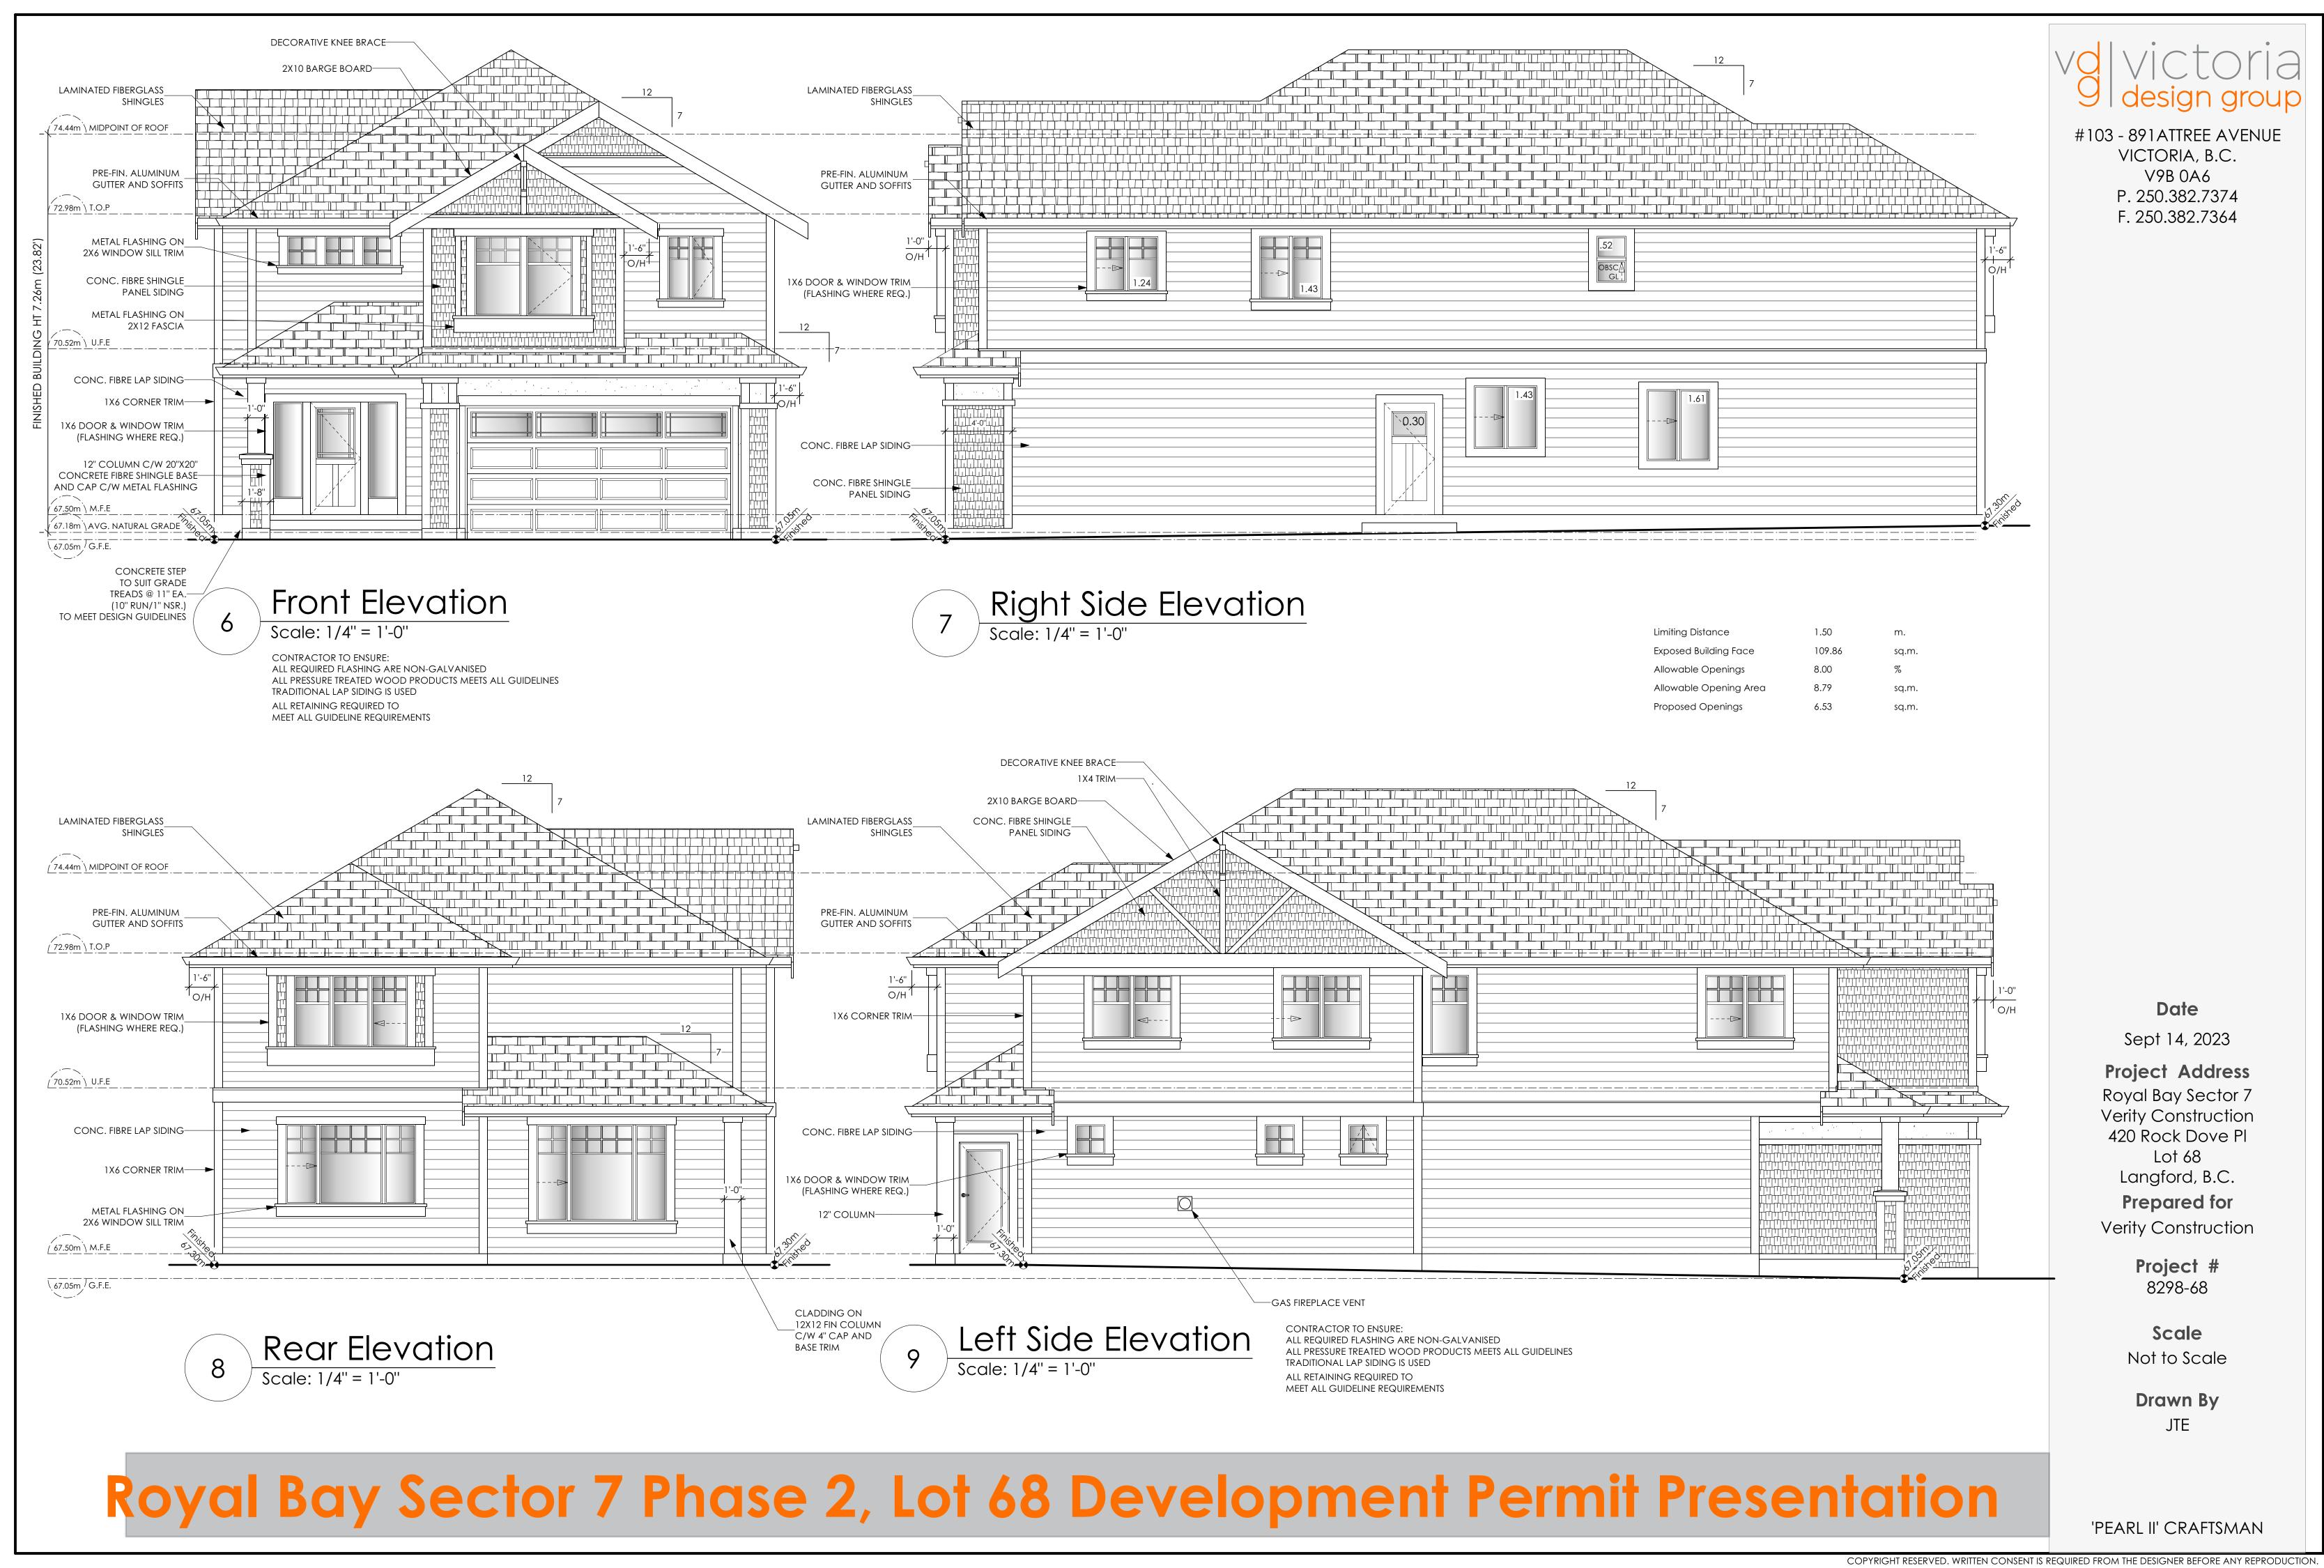

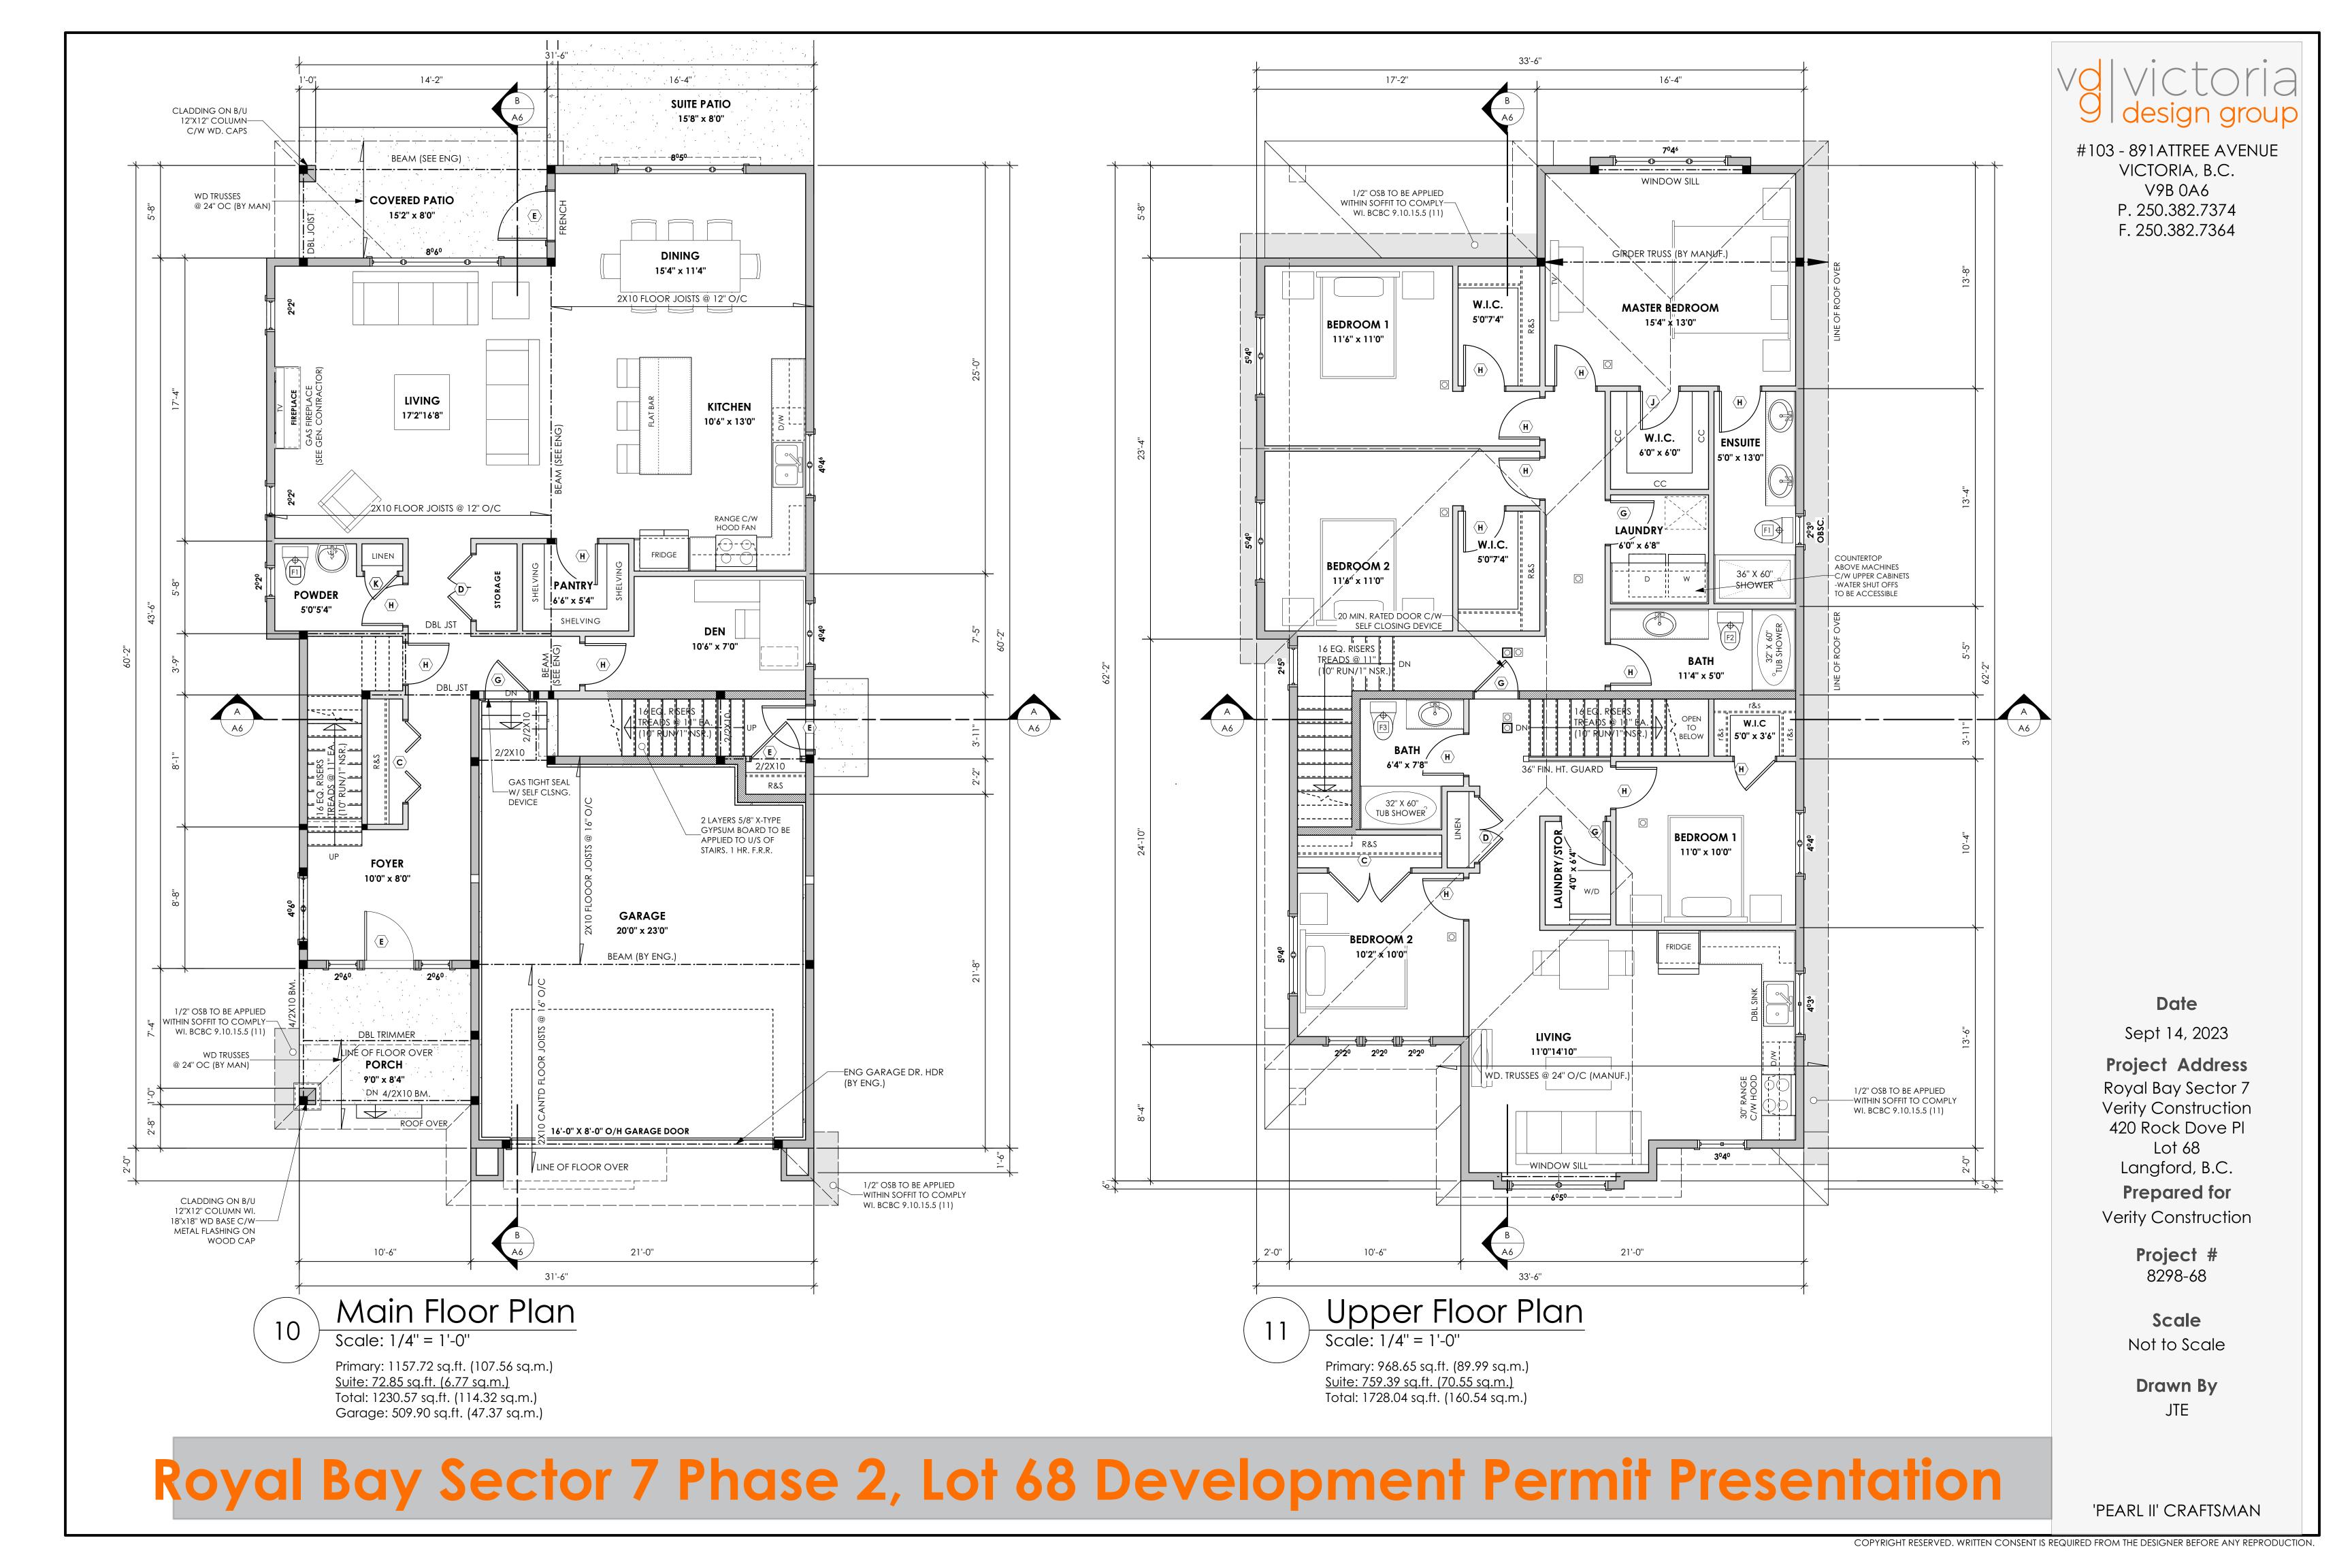

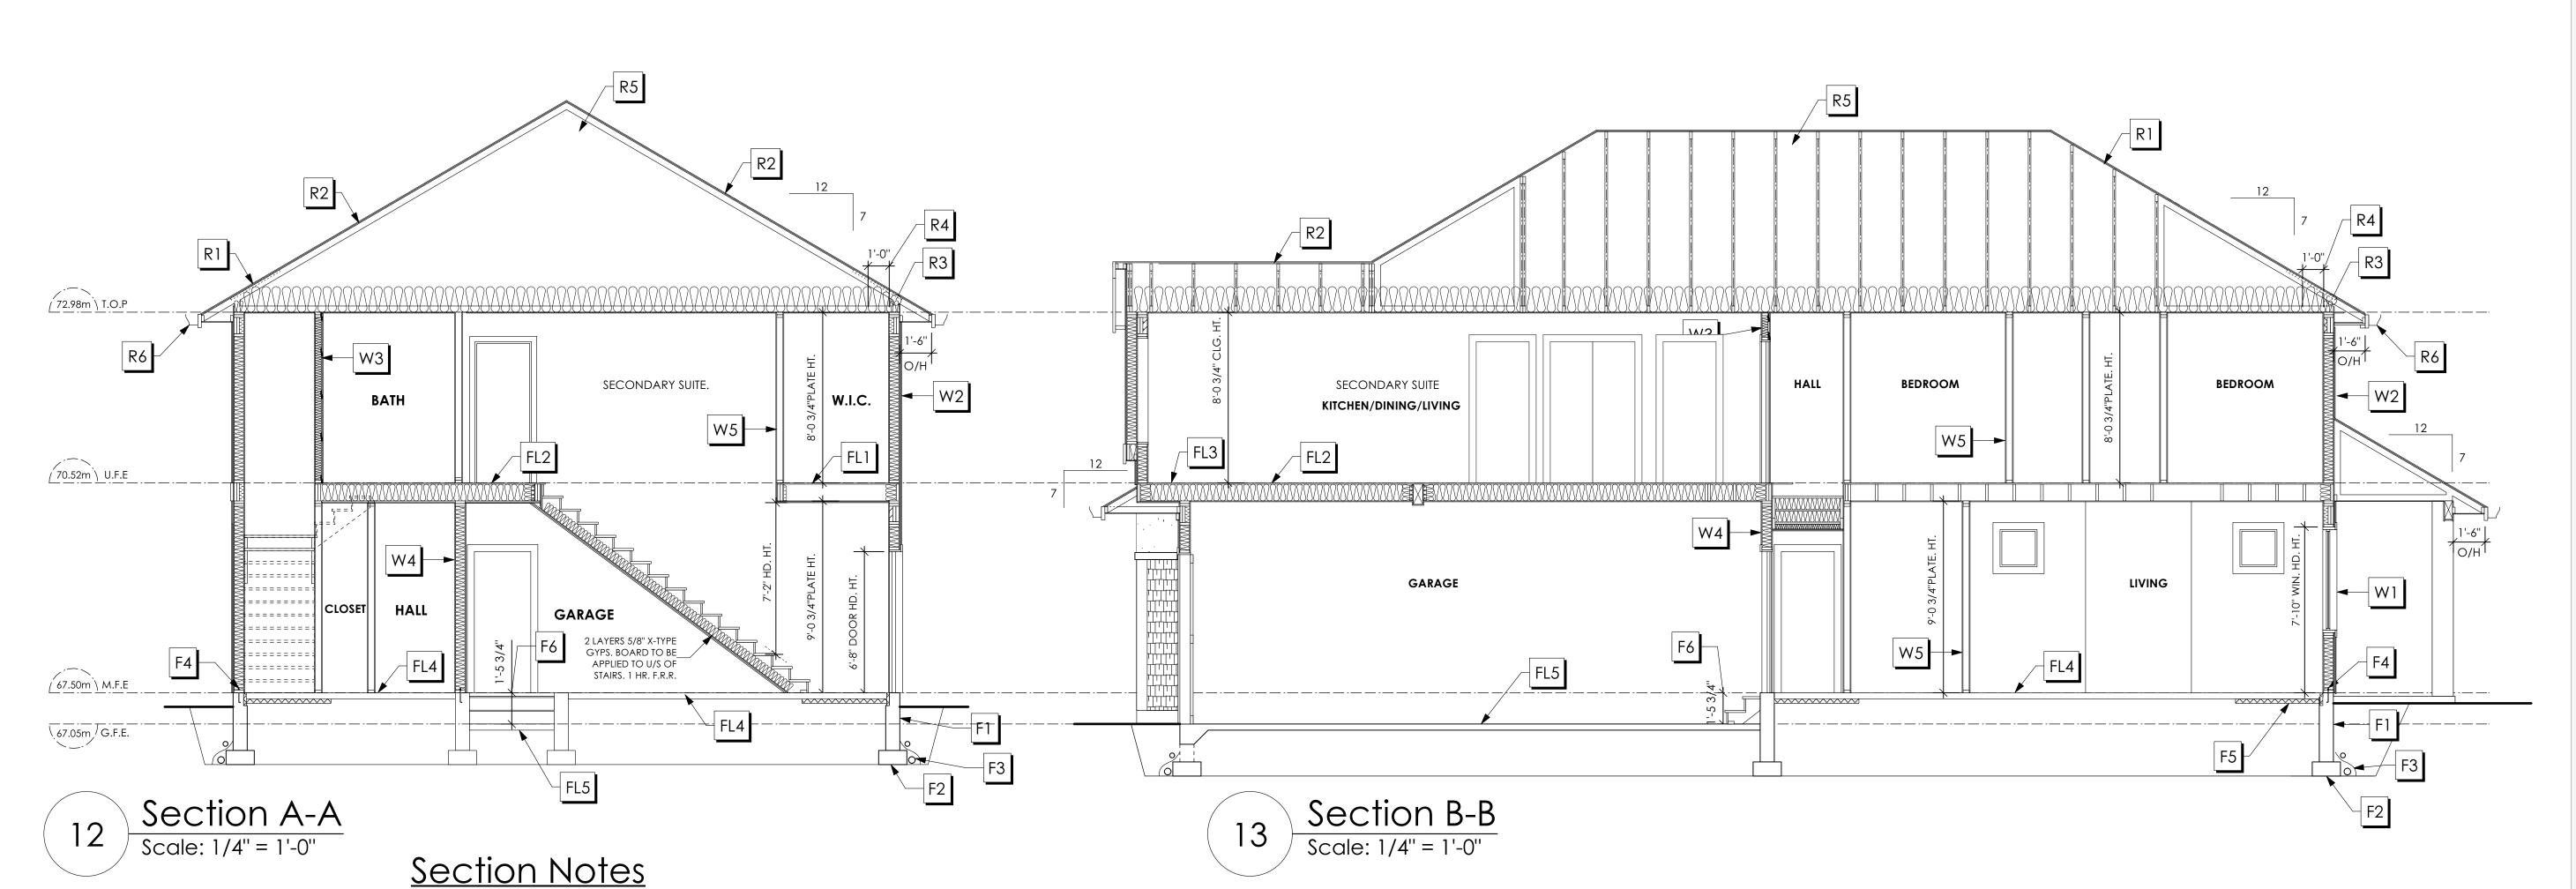

FLOORS

FL1. FINISHED FLOORING ON 19/32" ORIENTED STRAND BOARD (FASTENED & GLUED TO FLOOR STRUCT. BELOW) ON 2×10 FLOOR JOISTS @ 16" OR 12" O/C C/W 2×2 X-BRIDGING @ 7.0' O/C (MAX)

1/2" GYPSUM BOARD

FL2. B.C. BUILDING CODE (TABLE-9.10.3.1.B) RATED FLOOR ASSEMBLY F8D 30 MINUTE F.R.R., 50 S.T.C. FINISHED FLOORING ON 19/32" ORIENTED STRAND BOARD (FASTENED & GLUED TO FLOOR STRUCT. BELOW) ON 2×10 FLOOR JOISTS @ 16" OR 12" O/C C/W 2×2 X-BRIDGING @ 7.0' O/C (MAX) R-31 INSULATION RESILIENT METAL CHANNELS @ 24" O/C

1 LAYER 5/8" X-TYPE GYPSUM BOARD

- FL3. FINISHED FLOORING ON 19/32" ORIENTED STRAND BOARD (FASTENED & GLUED TO FLOOR STRUCT. BELOW) ON 2×10 FLOOR JOISTS @ 16" OR 12" O/C C/W 2×2 X-BRIDGING @ 7.0' O/C (MAX) PROVIDE R-31 F/G BATT INSULATION IN JOIST CAVITY C/W BUILDING WRAP VENTED SOFFIT (TO OWNERS SPEC'S)
- FL4. 3 1/2" CONCRETE SLAB 6 MIL. POLY'N V.B. 6" COMPACTED GRAVEL OR SAND

TO ALL SUSPENDED FLOOR AREAS

FL5. 3 1/2" CONCRETE SLAB 6 MIL. POLY'N V.B. 6" COMPACTED GRAVEL OR SAND SLOPE TO DOORS 1"

ROOFS

- R1. LAMINATED ASPHALT SHINGLES ON 7/16" ORIENTED STRAND BOARD C/W "H" CLIPS WD TRUSSES (DESIGNED BY MANUF.) R-40 FIBRE GLAS BATT INSULATION OR 14 1/2" FIBRE GLASS LOOSE FILL INSULATION 6 MIL POLY'N V.B. 5/8" GYPSUM BOARD
- R2. B.C. BUILDING CODE (TABLE-9.10.3.1.B) RATED ROOF ASSEMBLY R1 45 MINUTE RATED F.R.R. LAMINATED ASPHALT SHINGLES ON 7/16" ORIENTED STRAND BOARD C/W "H" CLIPS WD TRUSSES (DESIGNED BY MANUF.) R-40 FIBRE GLAS BATT INSULATION OR 14 1/2" FIBRE GLASS LOOSE FILL INSULATION 6 MIL POLY'N V.B. 5/8" X-TYPE GYPSUM BOARD
- R3. PROVIDE 2 1/2" (63MM) CLEAR BETWEEN R-20 INSULATION AND SHEATHING. (MIN. R-20 @ ROOF-WALL CONNECTION FOR 4'-0" (1.2M) AROUND PERIMETER OF BUILDING. AIR VENTILATION BAFFLES TO BE INSTALLED WHERE REQUIRED IN AS PER BCBC 9.19.)
- R4. EAVE PROTECTION CONT. UP ROOF SLOPE FOR 12" PAST EXTERIOR WALL.
- R5. PROVIDE 1 SQ.FT. ATTIC VENT PER 300 SQ.FT. OF INSULATED AREA MIN. 25% OF REQUIRED TO BE @ TOP AND BOTTOM (TO COMPLY WI. B.C. BLDG. CODE 9.19.1)
- R6. PRE-FIN. FASCIA GUTTER 2×8 FASCIA BD. 2×4 SUB. FASCIA BD. VENTED SOFFIT (SEE CONTRACTOR)
- R7. PRE-FIN. FASCIA GUTTER 2×8 FASCIA BD. 2×4 SUB. FASCIA BD. 1/2" ORIENTED STRAND BOARD VENTED SOFFIT (SEE CONTRACTOR)

Date

8298-68

Scale Not to Scale

JTE

'PEARL II' CRAFTSMAN

FOUNDATION

- F1. DAMP PROOFING (WHERE REQUIRED) ON 8" THK. CONC. FOUNDATION WALL C/W 15 M BARS @ 24" O/C B/W
- F2. 16"X 8" CONC. FOOTINGS C/W 2 (TWO) 15M BARS CONT. 3 IN. FROM BOTT. ON UNDISTURBED SOIL (SOLID BEARING)
- F3. 4" PERIMETER DRAIN 3" TIGHT PIPE FOR RWL DRAIN ROCK
- F4. ANCHOR BOLTS @ 4.0 FT. O/C MAX C/W SILL GASKETS
- F5. UNDER SLAB INSULATION 2 1/2" (RSI 2.15) EXTRUDED POLYSTYRENE RIGID INSULATION 4'-0" (1.2M) CONT. AROUND PERIMETER UNDER SLAB INSTALLED HORIZONTALLY (VERIFY WITH MUNICIPALITY DEPTH OF FROST LINE)
- STEP DOWN TO GARAGE SLAB MAY VARY, VERIFY EXTENT ON SITE

W1. DOUBLE GLAZING ENERGY STAR LOW "E" RATING IN THERMAL BREAK FRAMES 2/2"X10" LINTEL OVER (@ BEARING WALLS ONLY) (TYPICAL, WI. 2 1/2" XPS INSULATION) FLASHING OVER @ EXTERIOR (GLAZING IN ALL EXTERIOR DOORS & WITHIN 3 FT. OF EXTERIOR DOORS TO BE SHATTERPROOF (SP)) WINDOW REQUIREMENTS DERIVED FROM BCBC TABLE C-5 AS PER BCBC 9.7.4.3. AND ARE TO BE USED TO SATISFY THE REQUIREMENTS OF AAMA/WDMA/CSA 101/I.S.2/A440, "NAFS": COLWOOD, CLASS R, DP 1440, PG 30, WATER RESIST. 220, A2, RATINGS MUST BE CLEARLY LABELED ON ALL

WINDOW UNITS UPON INSTALLATION FOR INSPECTION.

W2. CONC. FIBRE BOARD ON 9.5MM (3/8") AIR SPACE / STRAPPING 3/8"×2" BORATE TREATED PLYWOOD STRAPPING HOUSE WRAP (A.B.) (TYVEK OR EQ.) 7/16" ORIENTED STRAND BOARD SHEATHING 2×6 STUDS @ 16" O/C R-20 INSULATION 6 MIL. POLYETHYLENE VAPOUR BARRIER

WALLS

- W3. B.C. BUILDING CODE (TABLE 9.10.3.1.A) RATED WALL ASSEMBLY W3c 1 LAYER 1/2" X-TYPE GYPSUM BOARD ON EACH SIDE OF 2×4 STUDS @ 16" O/C OR 2×6 STUDS @ 16" O/C (IF NOTED) RESILIENT METAL CHANNELS ON ONE SIDE @ 400mm OR 600mm O.C. C/W 3 1/2" FIBRE GLASS SOUND BATTS FRICTION FITTED AND SOLID FILLED 45 MIN. F.R.R., 43 S.T.C. (BETWEEN PRIMARY LIVING & SECONDARY SUITE)
- W4. 5/8" X-TYPE GYPSUM BOARD ON 2×6 STUDS @ 16" O/C C/W R-20 INSULATION 6 MIL. POLY'N V.B 1/2" GYPSUM BOARD (BETWEEN GARAGE & LIVING)

1/2" GYPSUM BOARD

W5. INTERIOR PARTITION 1/2" GYPSUM BOARD ON EACH SIDE OF 2×4 STUDS @ 16" O/C OR 2×6 STUDS @ 16" O/C (IF NOTED)

Sept 14, 2023

#103 - 891ATTREE AVENUE

VICTORIA, B.C.

V9B 0A6

P. 250.382.7374


F. 250.382.7364

Project Address Royal Bay Sector 7 Verity Construction 420 Rock Dove Pl Lot 68 Langford, B.C. Prepared for Verity Construction

Project #

Drawn By

Royal Bay Sector 7 Phase 2, Lot 68 Development Permit Presentation

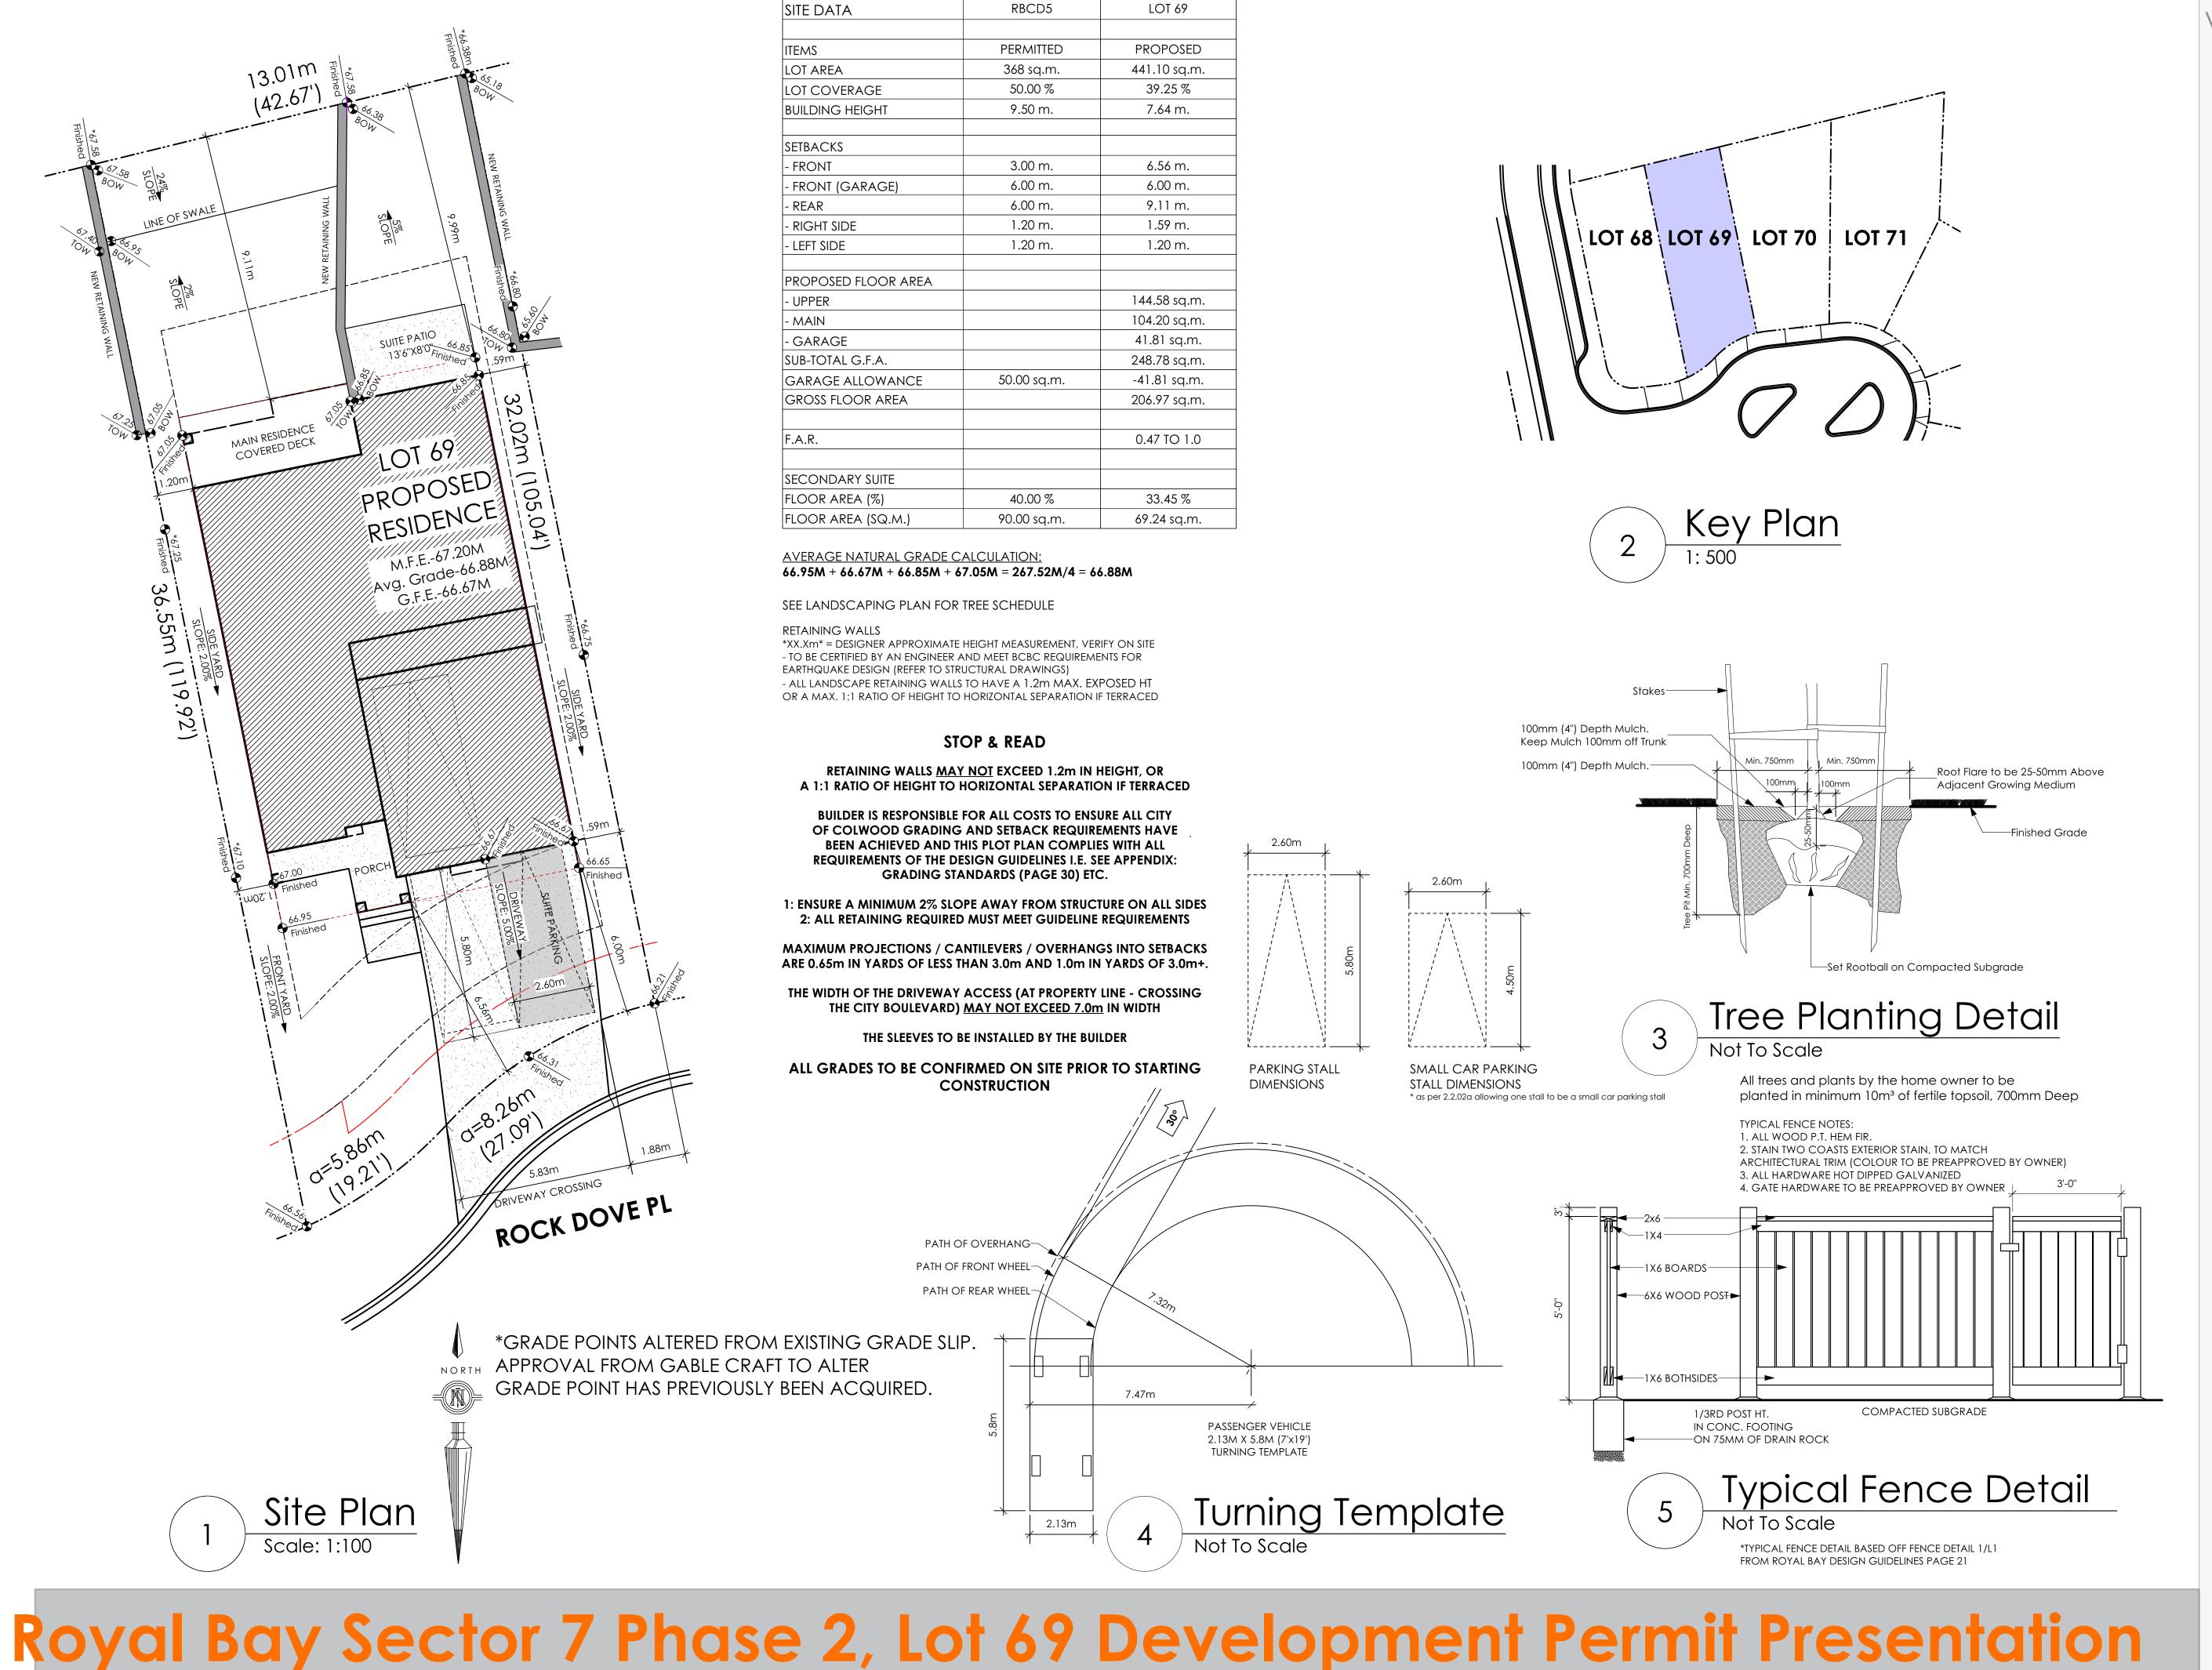

volvictoria 9 design group

#103 - 891ATTREE AVENUE VICTORIA, B.C. V9B 0A6 P. 250.382.7374 F. 250.382.7364

Date

Sept 29, 2023


Project Address
Royal Bay Sector 7
Verity Construction
416 Rock Dove Pl
Lot 69
Langford, B.C.
Prepared for
Verity Construction


Project # 8298-69


ScaleNot to Scale

Drawn By
JTE

'KEEL' CRAFTSMAN

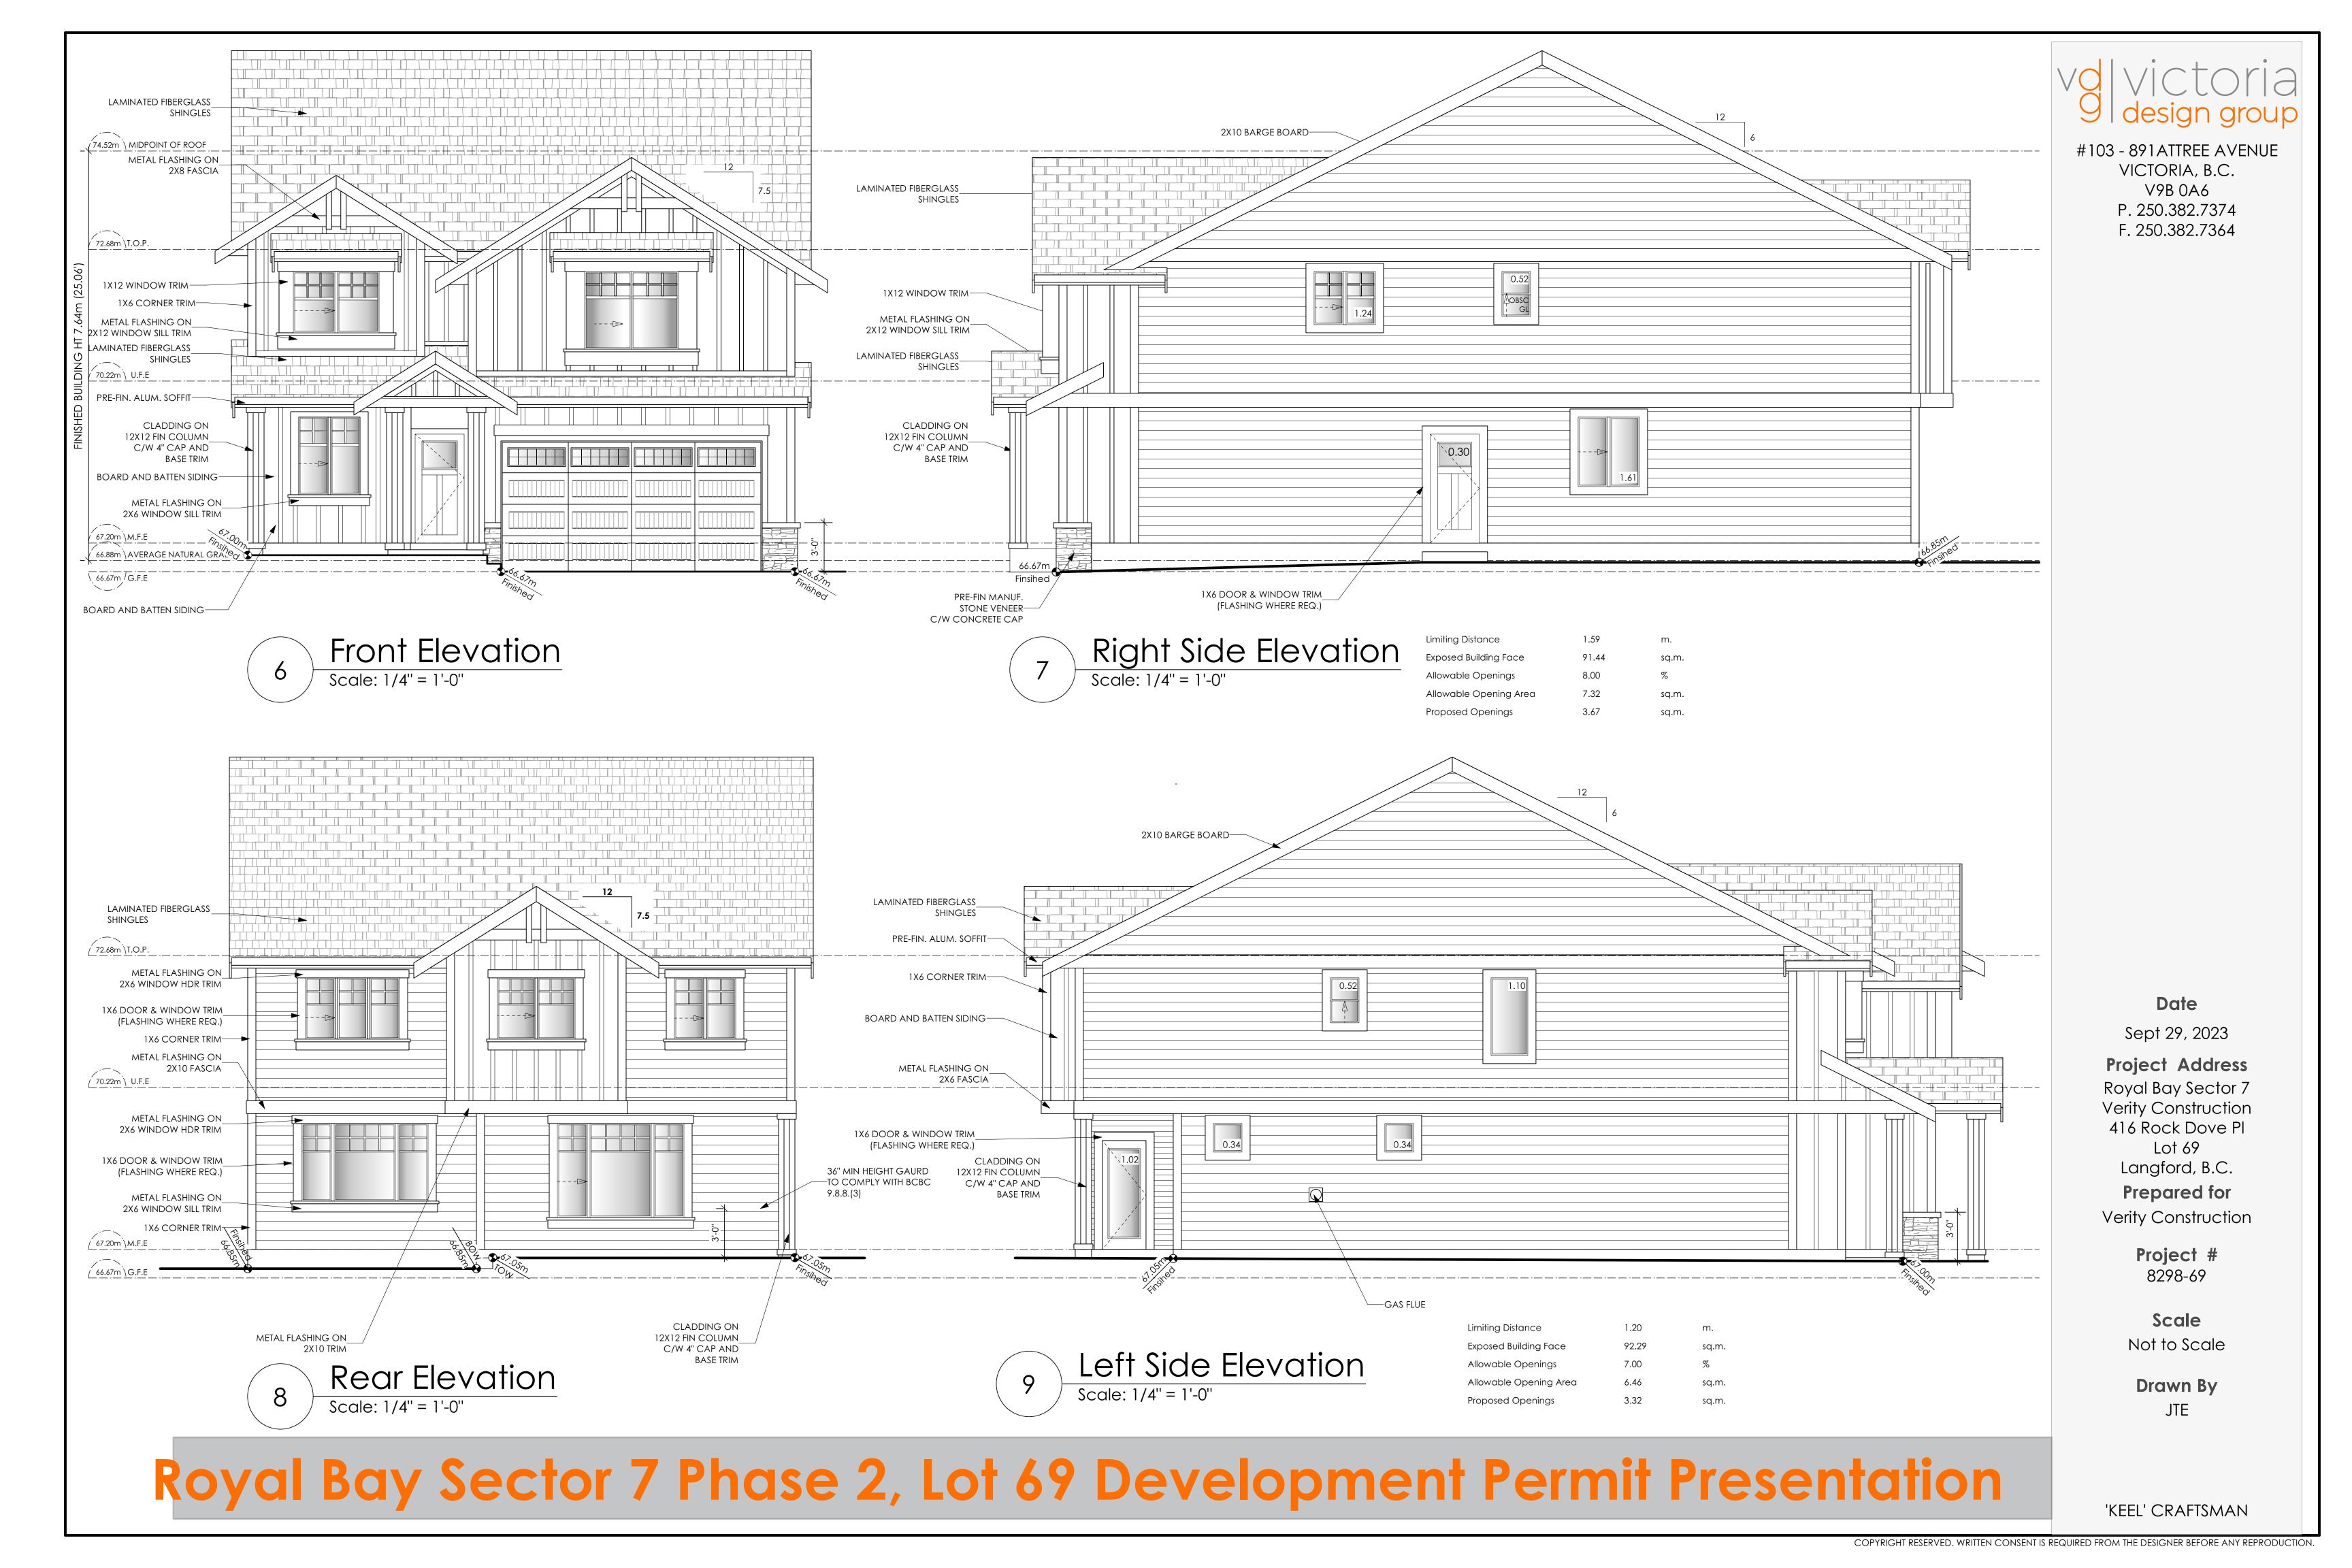

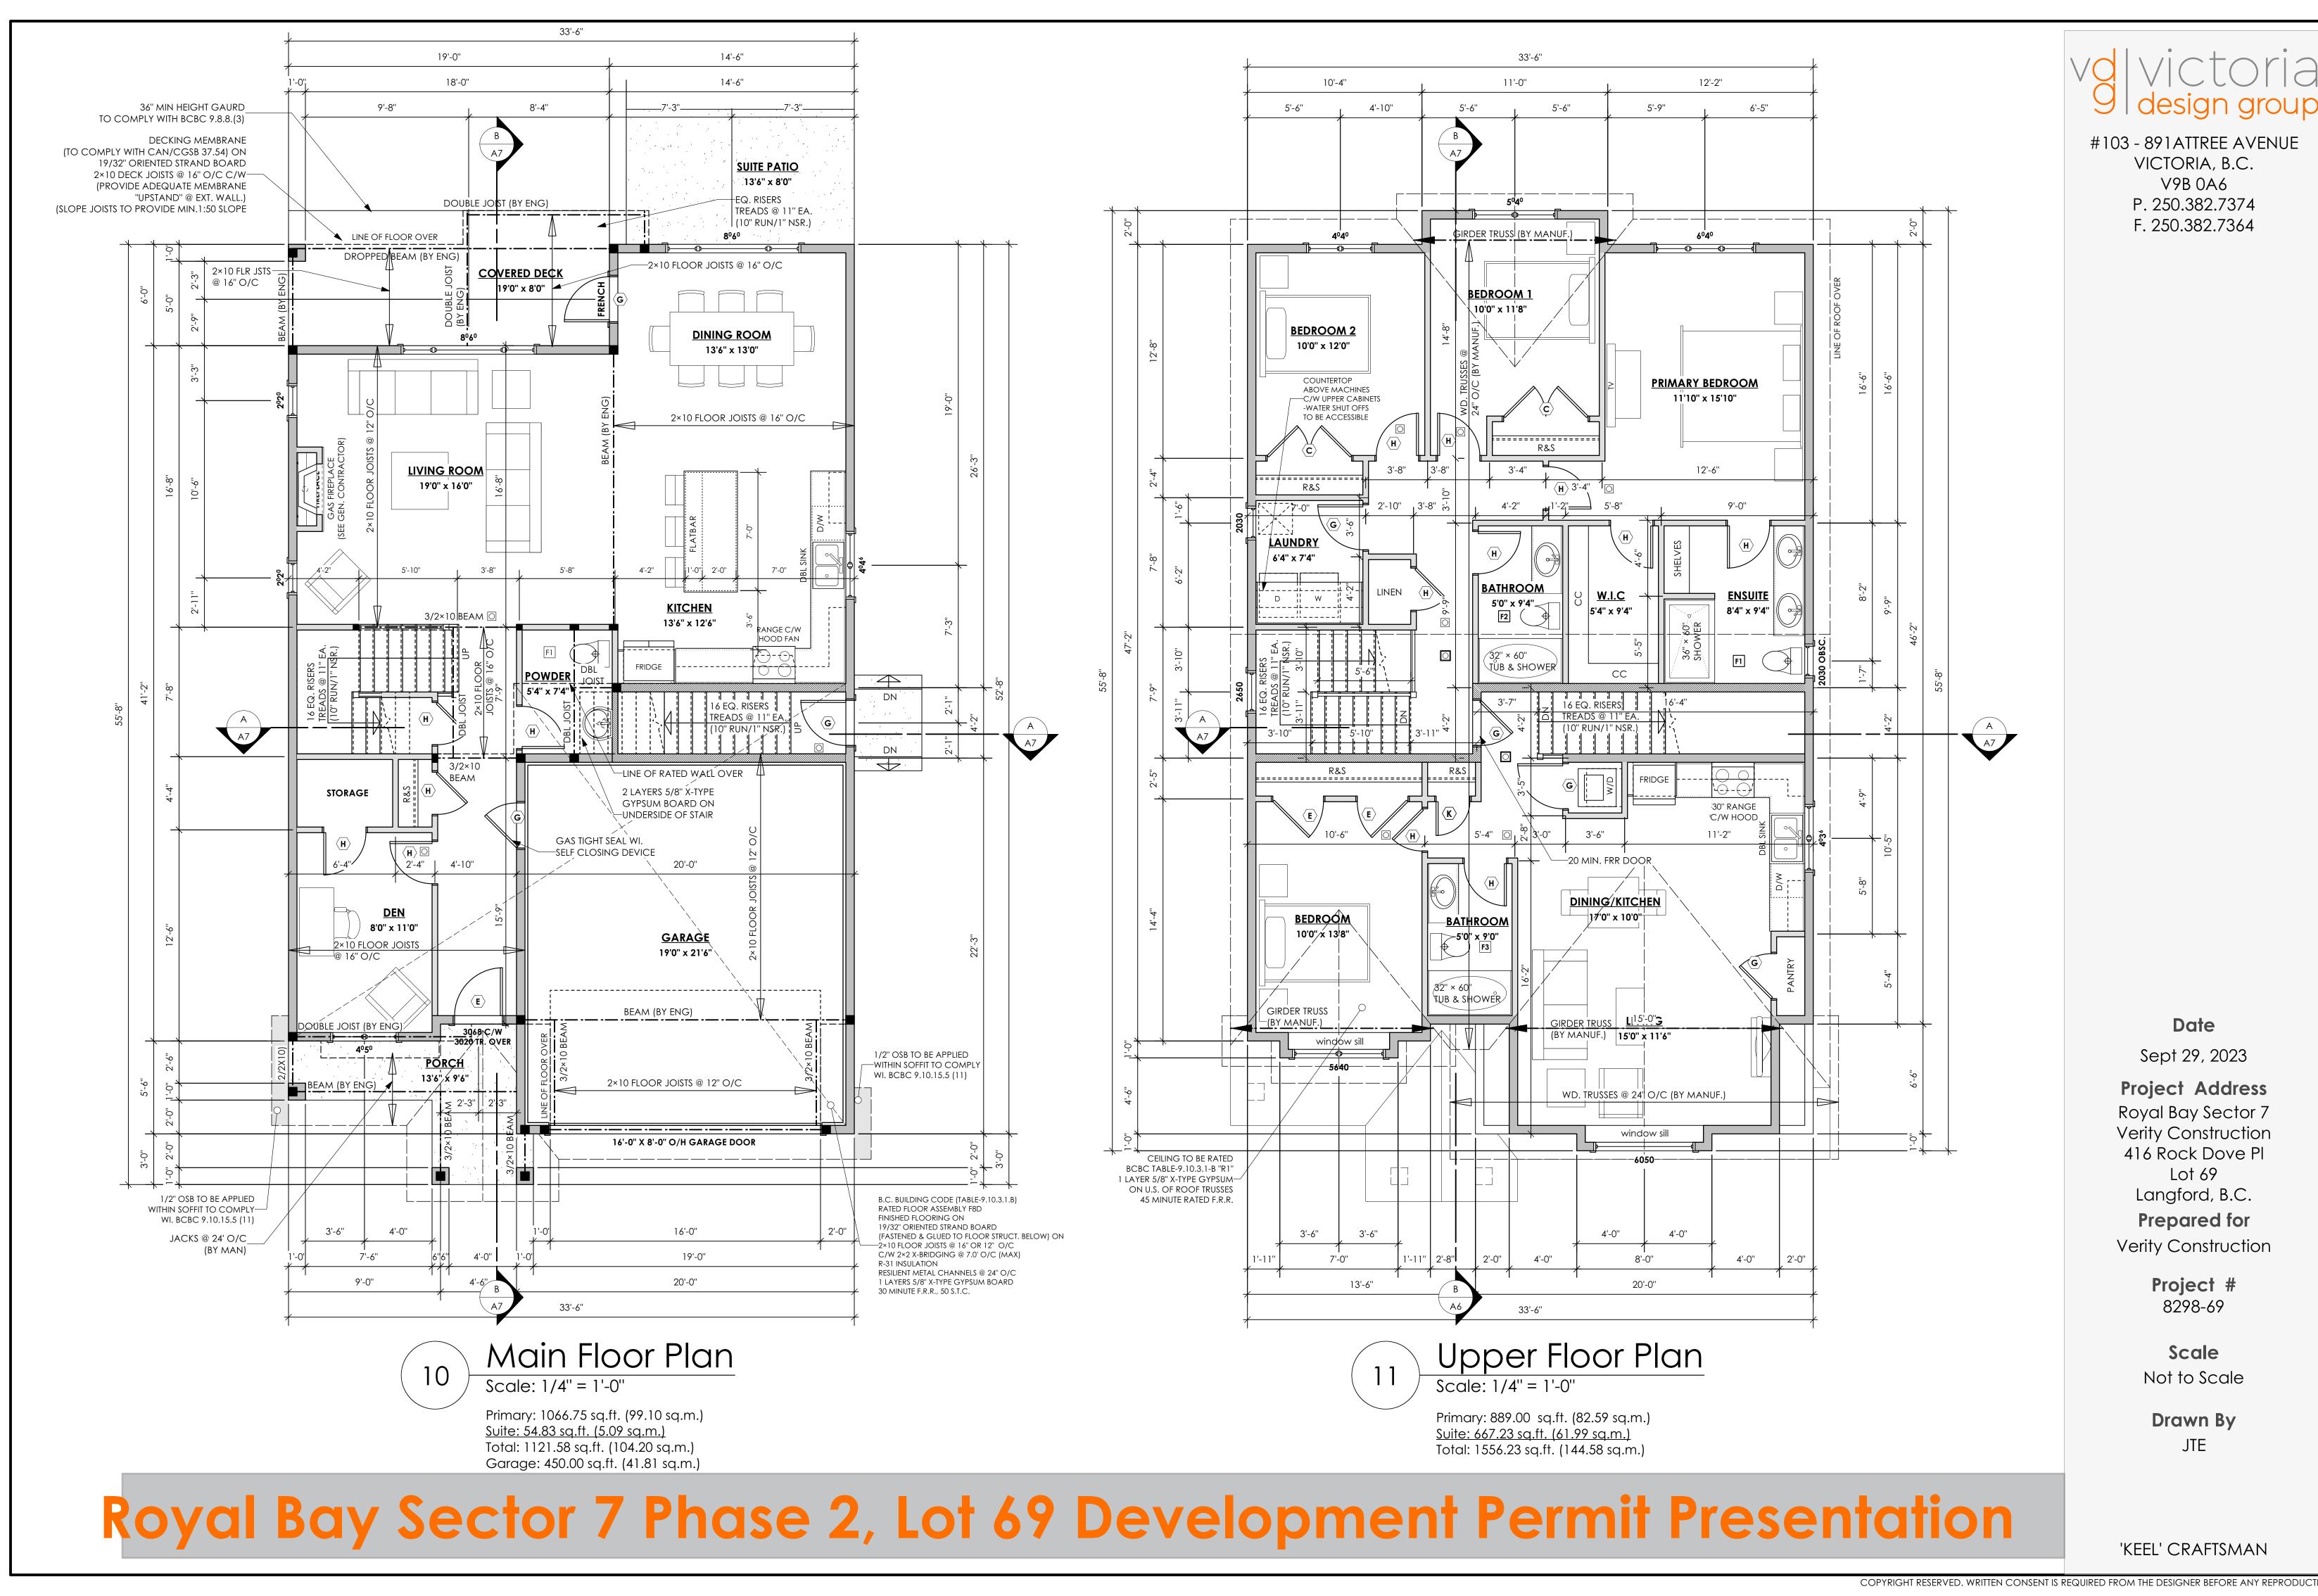

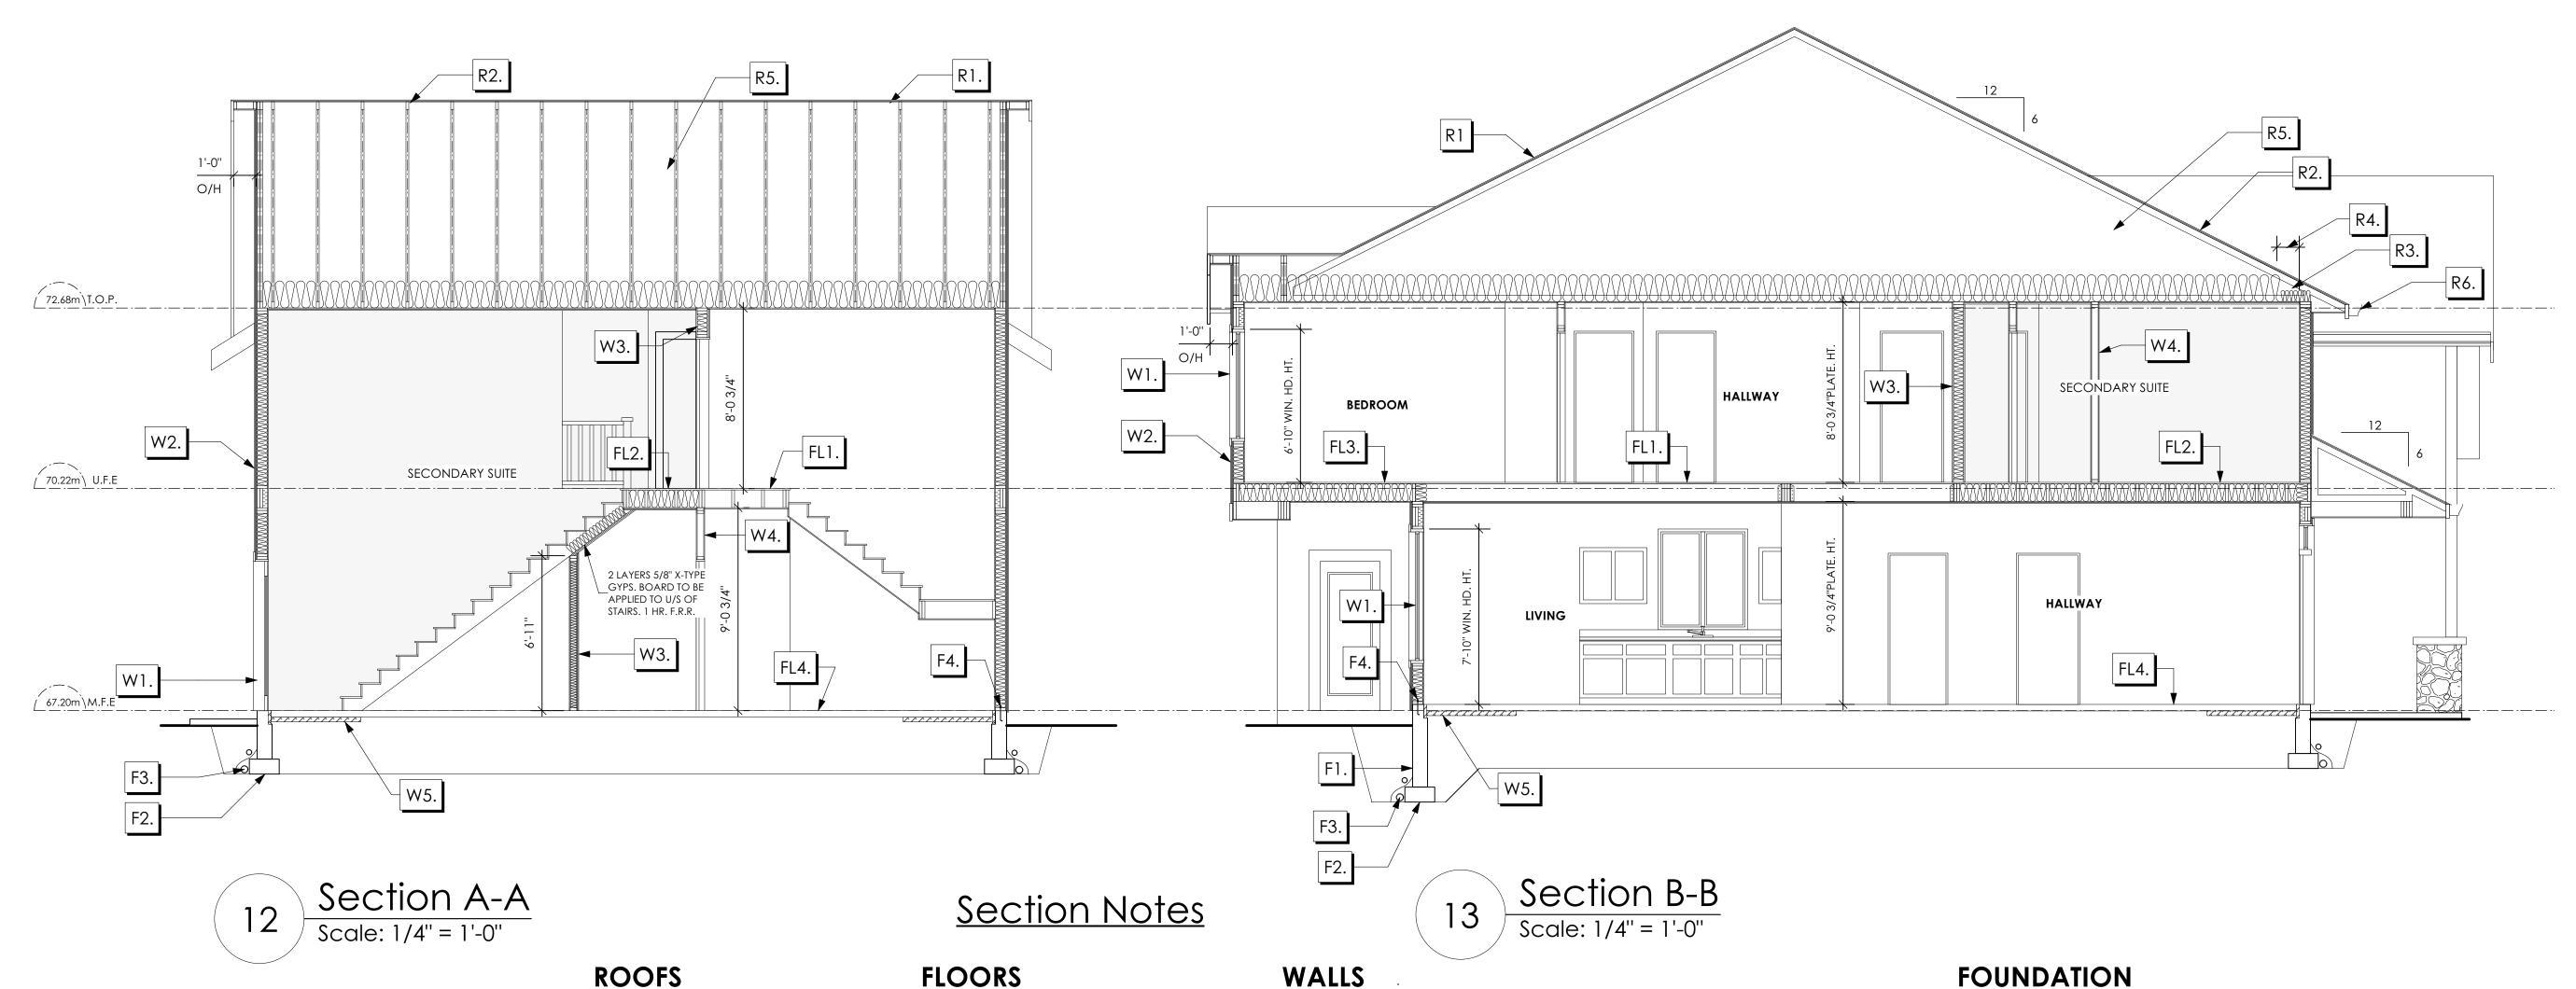

- R1. LAMINATED ASPHALT SHINGLES ON 7/16" ORIENTED STRAND BOARD C/W "H" CLIPS WD TRUSSES (DESIGNED BY MANUF.) R-40 FIBRE GLAS BATT INSULATION OR 14 1/2" FIBRE GLASS LOOSE FILL INSULATION 6 MIL POLY'N V.B. 5/8" GYPSUM BOARD
- R2. B.C. BUILDING CODE (TABLE-9.10.3.1.B) RATED ROOF ASSEMBLY R1 LAMINATED ASPHALT SHINGLES ON 7/16" ORIENTED STRAND BOARD C/W "H" CLIPS WD TRUSSES (DESIGNED BY MANUF.) R-40 FIBRE GLAS BATT INSULATION OR 14 1/2" FIBRE GLASS LOOSE FILL INSULATION 6 MIL POLY'N V.B. 5/8" X-TYPE GYPSUM BOARD 45 MINUTE RATED F.R.R.
- R3. PROVIDE 2 1/2" (63MM) CLEAR BETWEEN R-20 INSULATION AND SHEATHING. (MIN. R-20 @ ROOF-WALL CONNECTION FOR 4'-0" (1.2M) AROUND PERIMETER OF BUILDING. AIR VENTILATION BAFFLES TO BE INSTALLED WHERE REQUIRED IN AS PER BCBC 9.19.)
- R4. EAVE PROTECTION CONT. UP ROOF SLOPE FOR 12" PAST EXTERIOR WALL.
- R5. PROVIDE 1 SQ.FT. ATTIC VENT PER 300 SQ.FT. OF INSULATED AREA MIN. 25% OF REQUIRED TO BE @ TOP AND BOTTOM (TO COMPLY WI. B.C. BLDG. CODE 9.19.1)
- R6. PRE-FIN. FASCIA GUTTER 2×8 FASCIA BD. 2×4 SUB. FASCIA BD. **VENTED SOFFIT** (SEE CONTRACTOR)
- R7. PRE-FIN. FASCIA GUTTER 2×8 FASCIA BD. 2×4 SUB. FASCIA BD. 1/2" ORIENTED STRAND BOARD **VENTED SOFFIT** (SEE CONTRACTOR)

- FL1. FINISHED FLOORING ON 19/32" ORIENTED STRAND BOARD (FASTENED & GLUED TO FLOOR STRUCT. BELOW) ON 2×10 FLOOR JOISTS @ 16" OR 12" O/C C/W 2×2 X-BRIDGING @ 7.0' O/C (MAX) 1/2" GYPSUM BOARD
- FL2. B.C. BUILDING CODE (TABLE-9.10.3.1.B) RATED FLOOR ASSEMBLY F8D FINISHED FLOORING ON 19/32" ORIENTED STRAND BOARD (FASTENED & GLUED TO FLOOR STRUCT. BELOW) ON 2×10 FLOOR JOISTS @ 16" OR 12" O/C C/W 2×2 X-BRIDGING @ 7.0' O/C (MAX) R-31 INSULATION RESILIENT METAL CHANNELS @ 24" O/C 1 LAYERS 5/8" X-TYPE GYPSUM BOARD 30 MINUTE F.R.R., 50 S.T.C.
- FL3. FINISHED FLOORING ON 19/32" ORIENTED STRAND BOARD (FASTENED & GLUED TO FLOOR STRUCT. BELOW) ON 2×10 FLOOR JOISTS @ 16" OR 12" O/C C/W 2×2 X-BRIDGING @ 7.0' O/C (MAX) PROVIDE R-31 F/G BATT INSULATION IN JOIST CAVITY C/W BUILDING WRAP VENTED SOFFIT (TO OWNERS SPEC'S) TO ALL SUSPENDED FLOOR AREAS
- 3 1/2" CONCRETE SLAB 6 MIL. POLY'N V.B. 6" COMPACTED GRAVEL OR SAND FL5. 3 1/2" CONCRETE SLAB 6 MIL. POLY'N V.B.

FL4. FINISHED FLOORING

- 6" COMPACTED GRAVEL OR SAND SLOPE TO DOORS 1" (NOT IN SECTION) FL6. DECKING MEMBRANE
- (TO COMPLY WITH CAN/CGSB 37.54) ON 19/32" ORIENTED STRAND BOARD 2×10 DECK JOISTS @ 16" O/C C/W (PROVIDE ADEQUATE MEMBRANE "UPSTAND" @ EXT. WALL.) (SLOPE JOISTS TO PROVIDE MIN. 1:50 SLOPE)

FOR INSPECTION.

W1. DOUBLE GLAZING ENERGY STAR LOW "E" RATING IN THERMAL BREAK FRAMES 2/2"X10" LINTEL OVER (@ BEARING WALLS ONLY) (TYPICAL, WI. 2 1/2" XPS INSULATION) FLASHING OVER @ EXTERIOR (GLAZING IN ALL EXTERIOR DOORS & WITHIN 3 FT. OF EXTERIOR DOORS TO BE SHATTERPROOF (SP)) WINDOW REQUIREMENTS DERIVED FROM BCBC TABLE C-5 AS PER BCBC 9.7.4.3. AND ARE TO BE USED TO SATISFY THE REQUIREMENTS OF AAMA/WDMA/CSA 101/I.S.2/A440, "NAFS": COLWOOD, CLASS R, DP 1440, PG 30, WATER RESIST, 220, A2, RATINGS MUST BE CLEARLY LABELED ON ALL WINDOW UNITS UPON INSTALLATION

W4. INTERIOR PARTITION

1/2" GYPSUM BOARD ON EACH SIDE

OF 2×4 STUDS @ 16" O/C OR

W5. 5/8" X-TYPE GYPSUM BOARD ON

2×6 STUDS @ 16" O/C C/W

(BETWEEN GARAGE & LIVING)

(NOT SHOWN IN SECTION)

R-20 INSULATION

6 MIL. POLY'N V.B

1/2" GYPSUM BOARD

2×6 STUDS @ 16" O/C (IF NOTED)

- W2. CONC. FIBRE BOARD ON 9.5MM (3/8") AIR SPACE / STRAPPING 3/8"×2" BORATE TREATED PLYWOOD STRAPPING HOUSE WRAP (A.B.) (TYVEK OR EQ.) 7/16" ORIENTED STRAND BOARD SHEATHING 2×6 STUDS @ 16" O/C R-20 INSULATION 6 MIL. POLYETHYLENE VAPOUR BARRIER 1/2" GYPSUM BOARD
- W3. B.C. BUILDING CODE (TABLE 9.10.3.1.A) RATED WALL ASSEMBLY W3c 1 LAYER 1/2" X-TYPE GYPSUM BOARD ON EACH SIDE OF 2×4 STUDS @ 16" O/C OR 2×6 STUDS @ 16" O/C (IF NOTED) RESILIENT METAL CHANNELS ON ONE SIDE @ 400mm OR 600mm O.C. C/W 3 1/2" FIBRE GLASS SOUND BATTS FRICTION FITTED AND SOLID FILLED 45 MIN. F.R.R., 43 S.T.C. (BETWEEN PRIMARY LIVING & SECONDARY SUITE)

- F1. DAMP PROOFING (WHERE REQUIRED) ON C/W 15 M BARS @ 24" O/C B/W
- F2. 16"X 8" CONC. FOOTINGS C/W 2 (TWO) 15M BARS CONT. 3 IN. FROM BOTT. ON UNDISTURBED SOIL (SOLID BEARING)
- F3. 4" PERIMETER DRAIN 3" TIGHT PIPE FOR RWL DRAIN ROCK
- F4. ANCHOR BOLTS @ 4.0 FT. O/C MAX C/W SILL GASKETS
- F5. UNDER SLAB INSULATION 2 1/2" (RSI 2.15) EXTRUDED POLYSTYRENE RIGID INSULATION 4'-0" (1.2M) CONT. AROUND PERIMETER UNDER SLAB INSTALLED HORIZONTALLY (VERIFY WITH MUNICIPALITY DEPTH OF FROST LINE)
- STEP DOWN TO GARAGE SLAB MAY VARY, VERIFY EXTENT ON SITE (NOT IN SECTION)

Sept 29, 2023

Date

#103 - 891ATTREE AVENUE

VICTORIA, B.C.

V9B 0A6

P. 250.382.7374

F. 250.382.7364

Project Address Royal Bay Sector 7 Verity Construction 416 Rock Dove Pl Lot 69 Langford, B.C. Prepared for Verity Construction


> Project # 8298-69

Scale Not to Scale

Drawn By JTE

Royal Bay Sector 7 Phase 2, Lot 69 Development Permit Presentation

'KEEL' CRAFTSMAN

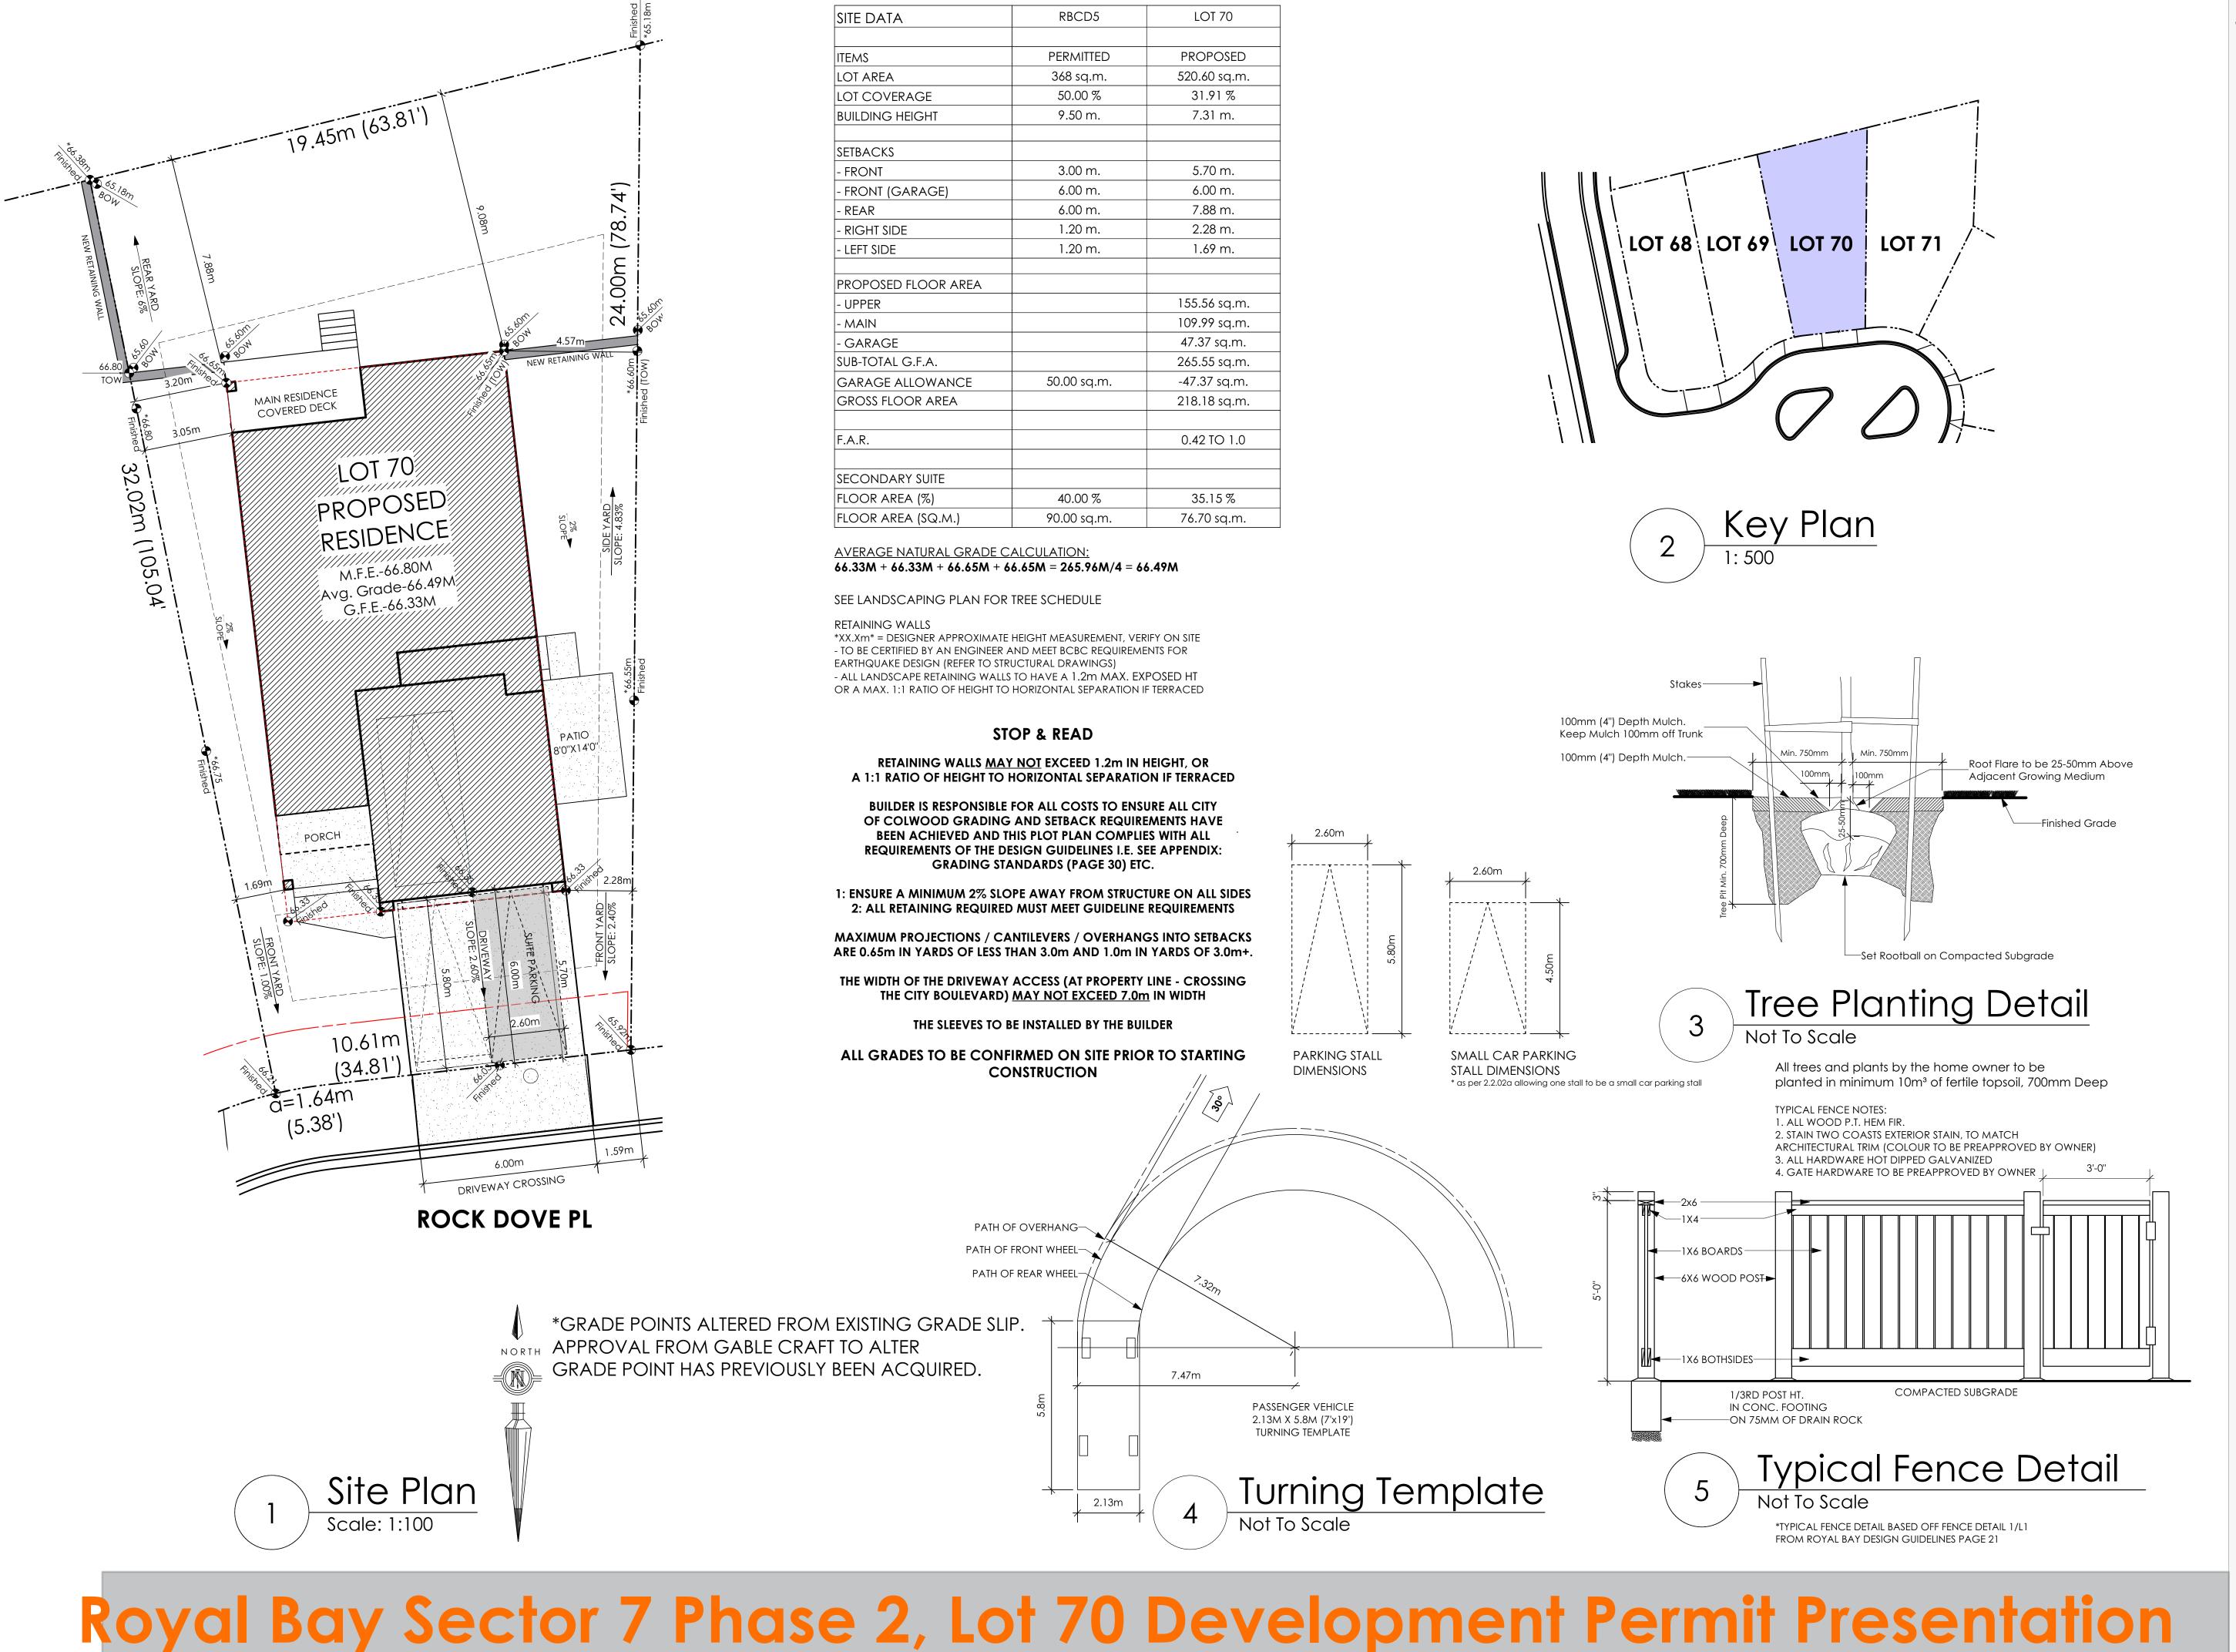

volvictoria 9 design group

#103 - 891ATTREE AVENUE VICTORIA, B.C. V9B 0A6 P. 250.382.7374 F. 250.382.7364

Date

Sept 14, 2023


Project Address
Royal Bay Sector 7
Verity Construction
412 Rock Dove Pl
Lot 70
Langford, B.C.
Prepared for
Verity Construction


Project # 8298-70


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Drawn By
JTE

'PEARL II' WESTCOAST



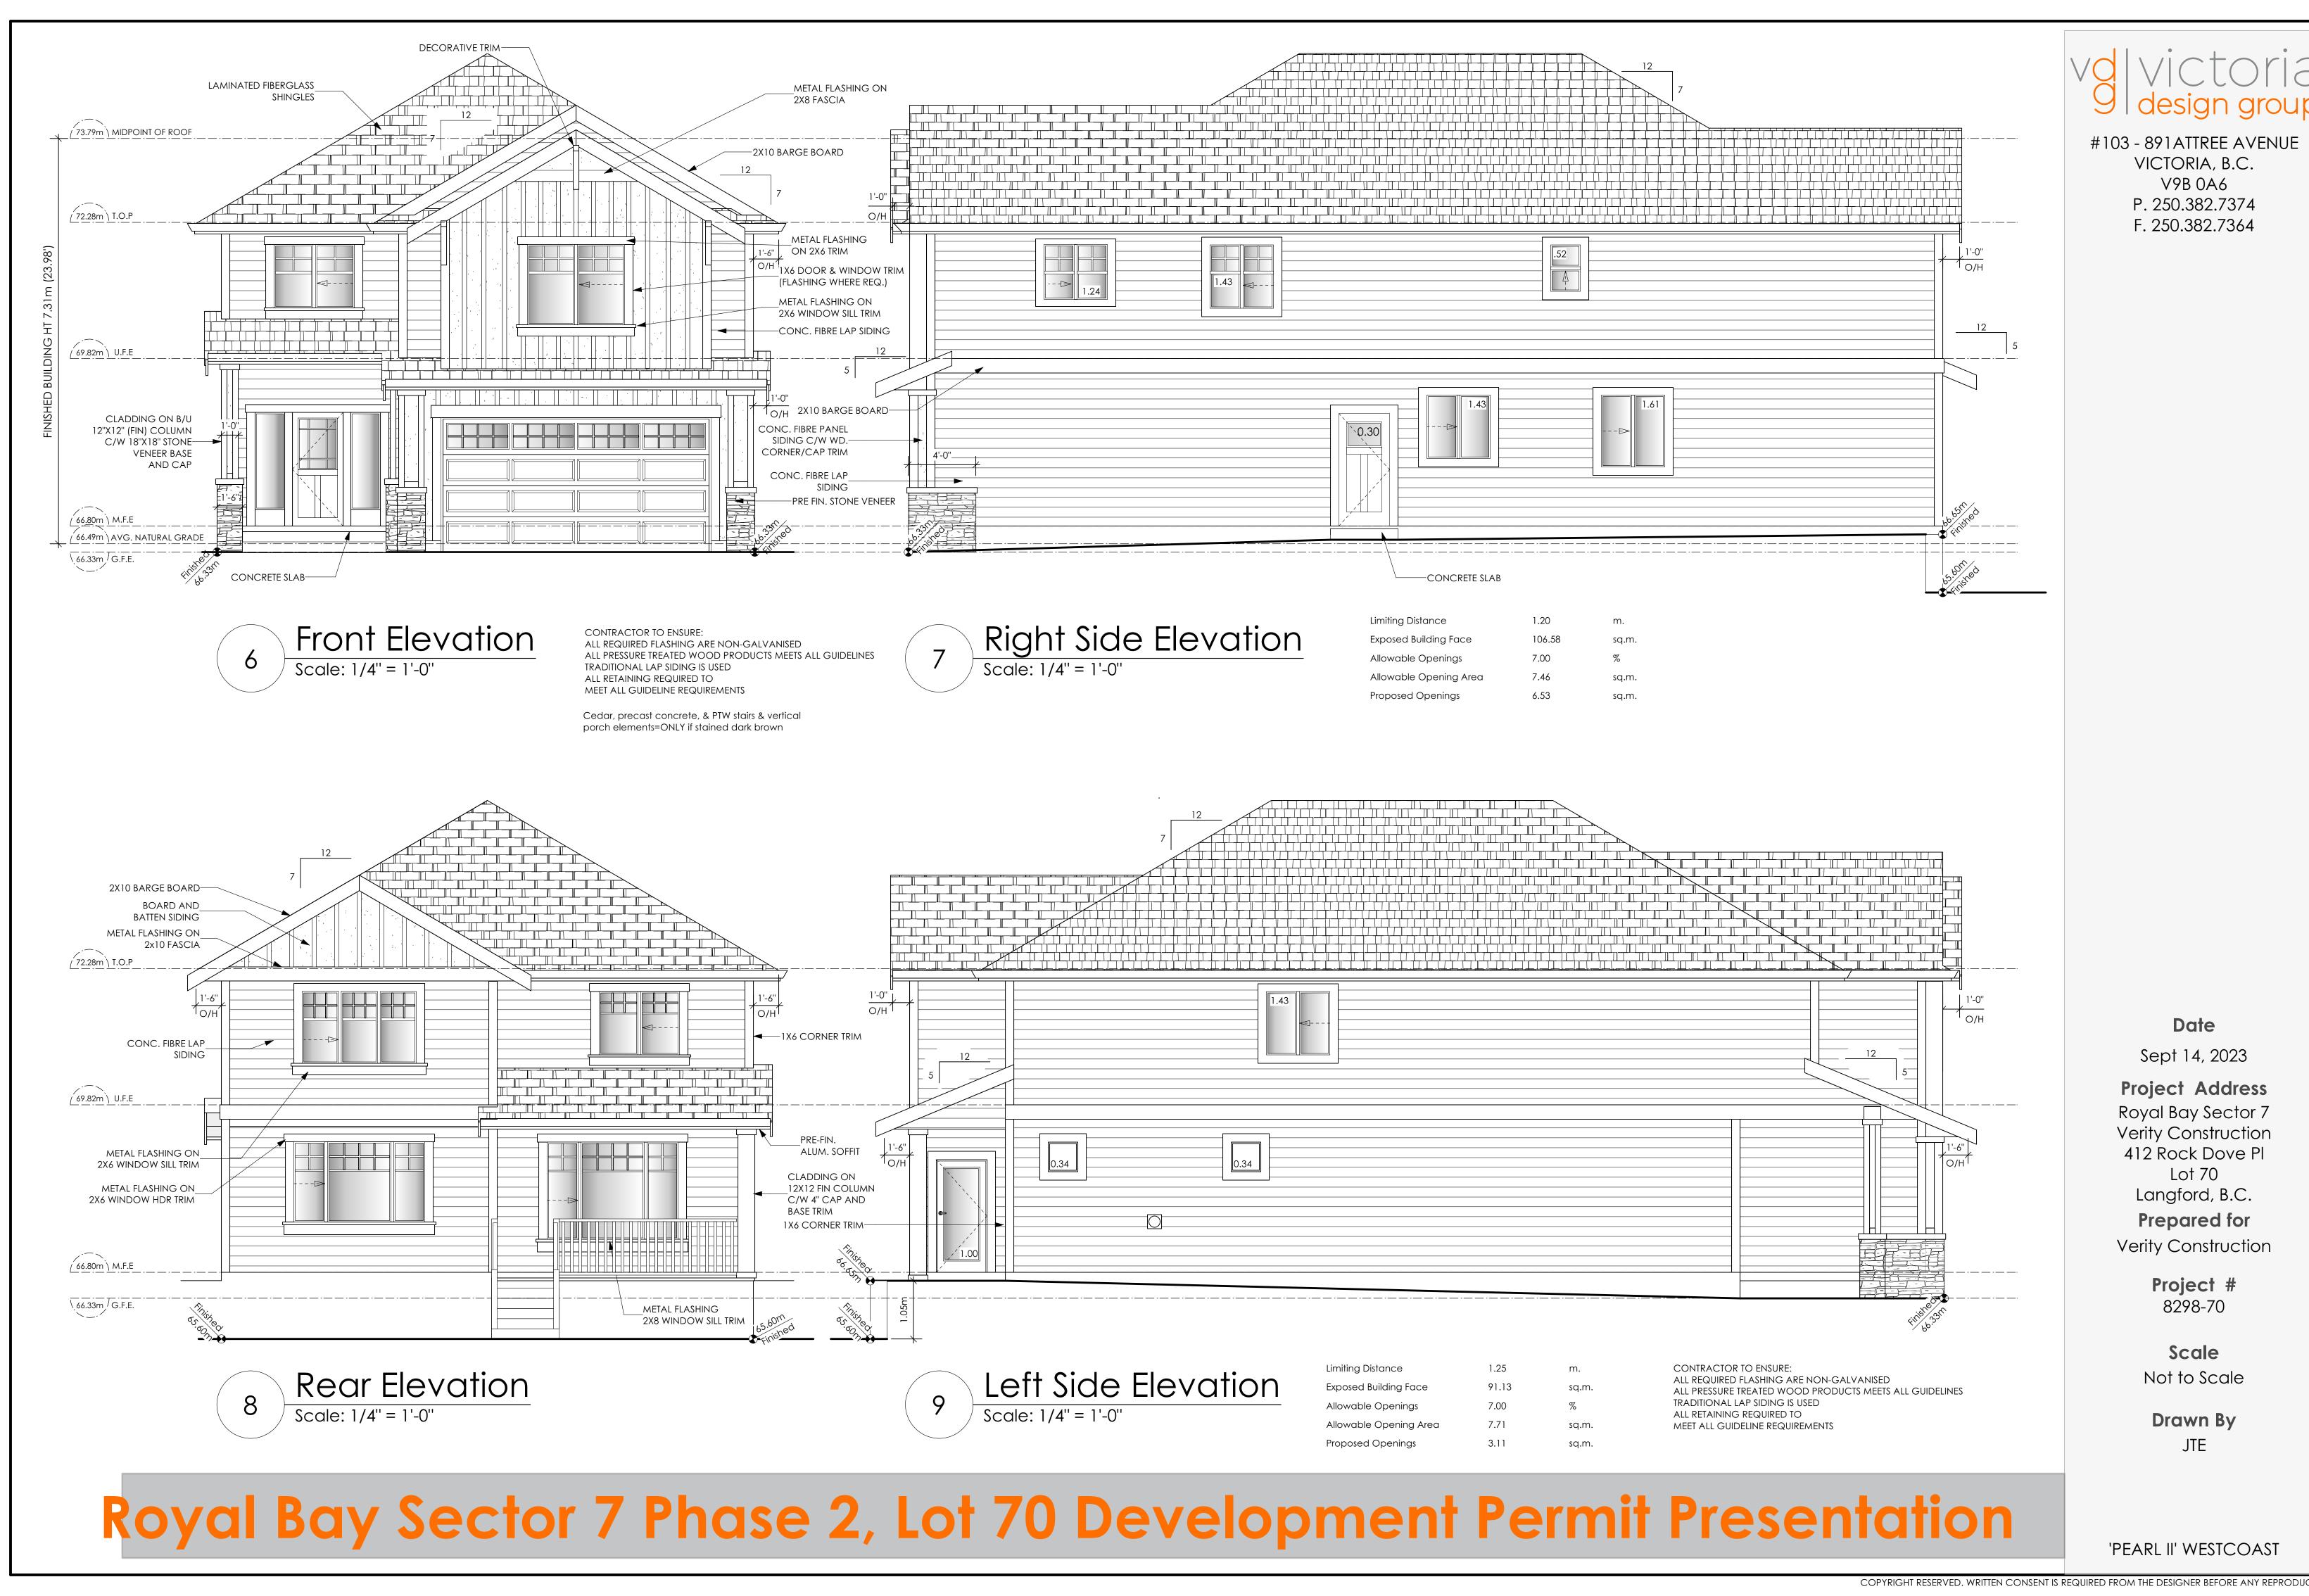

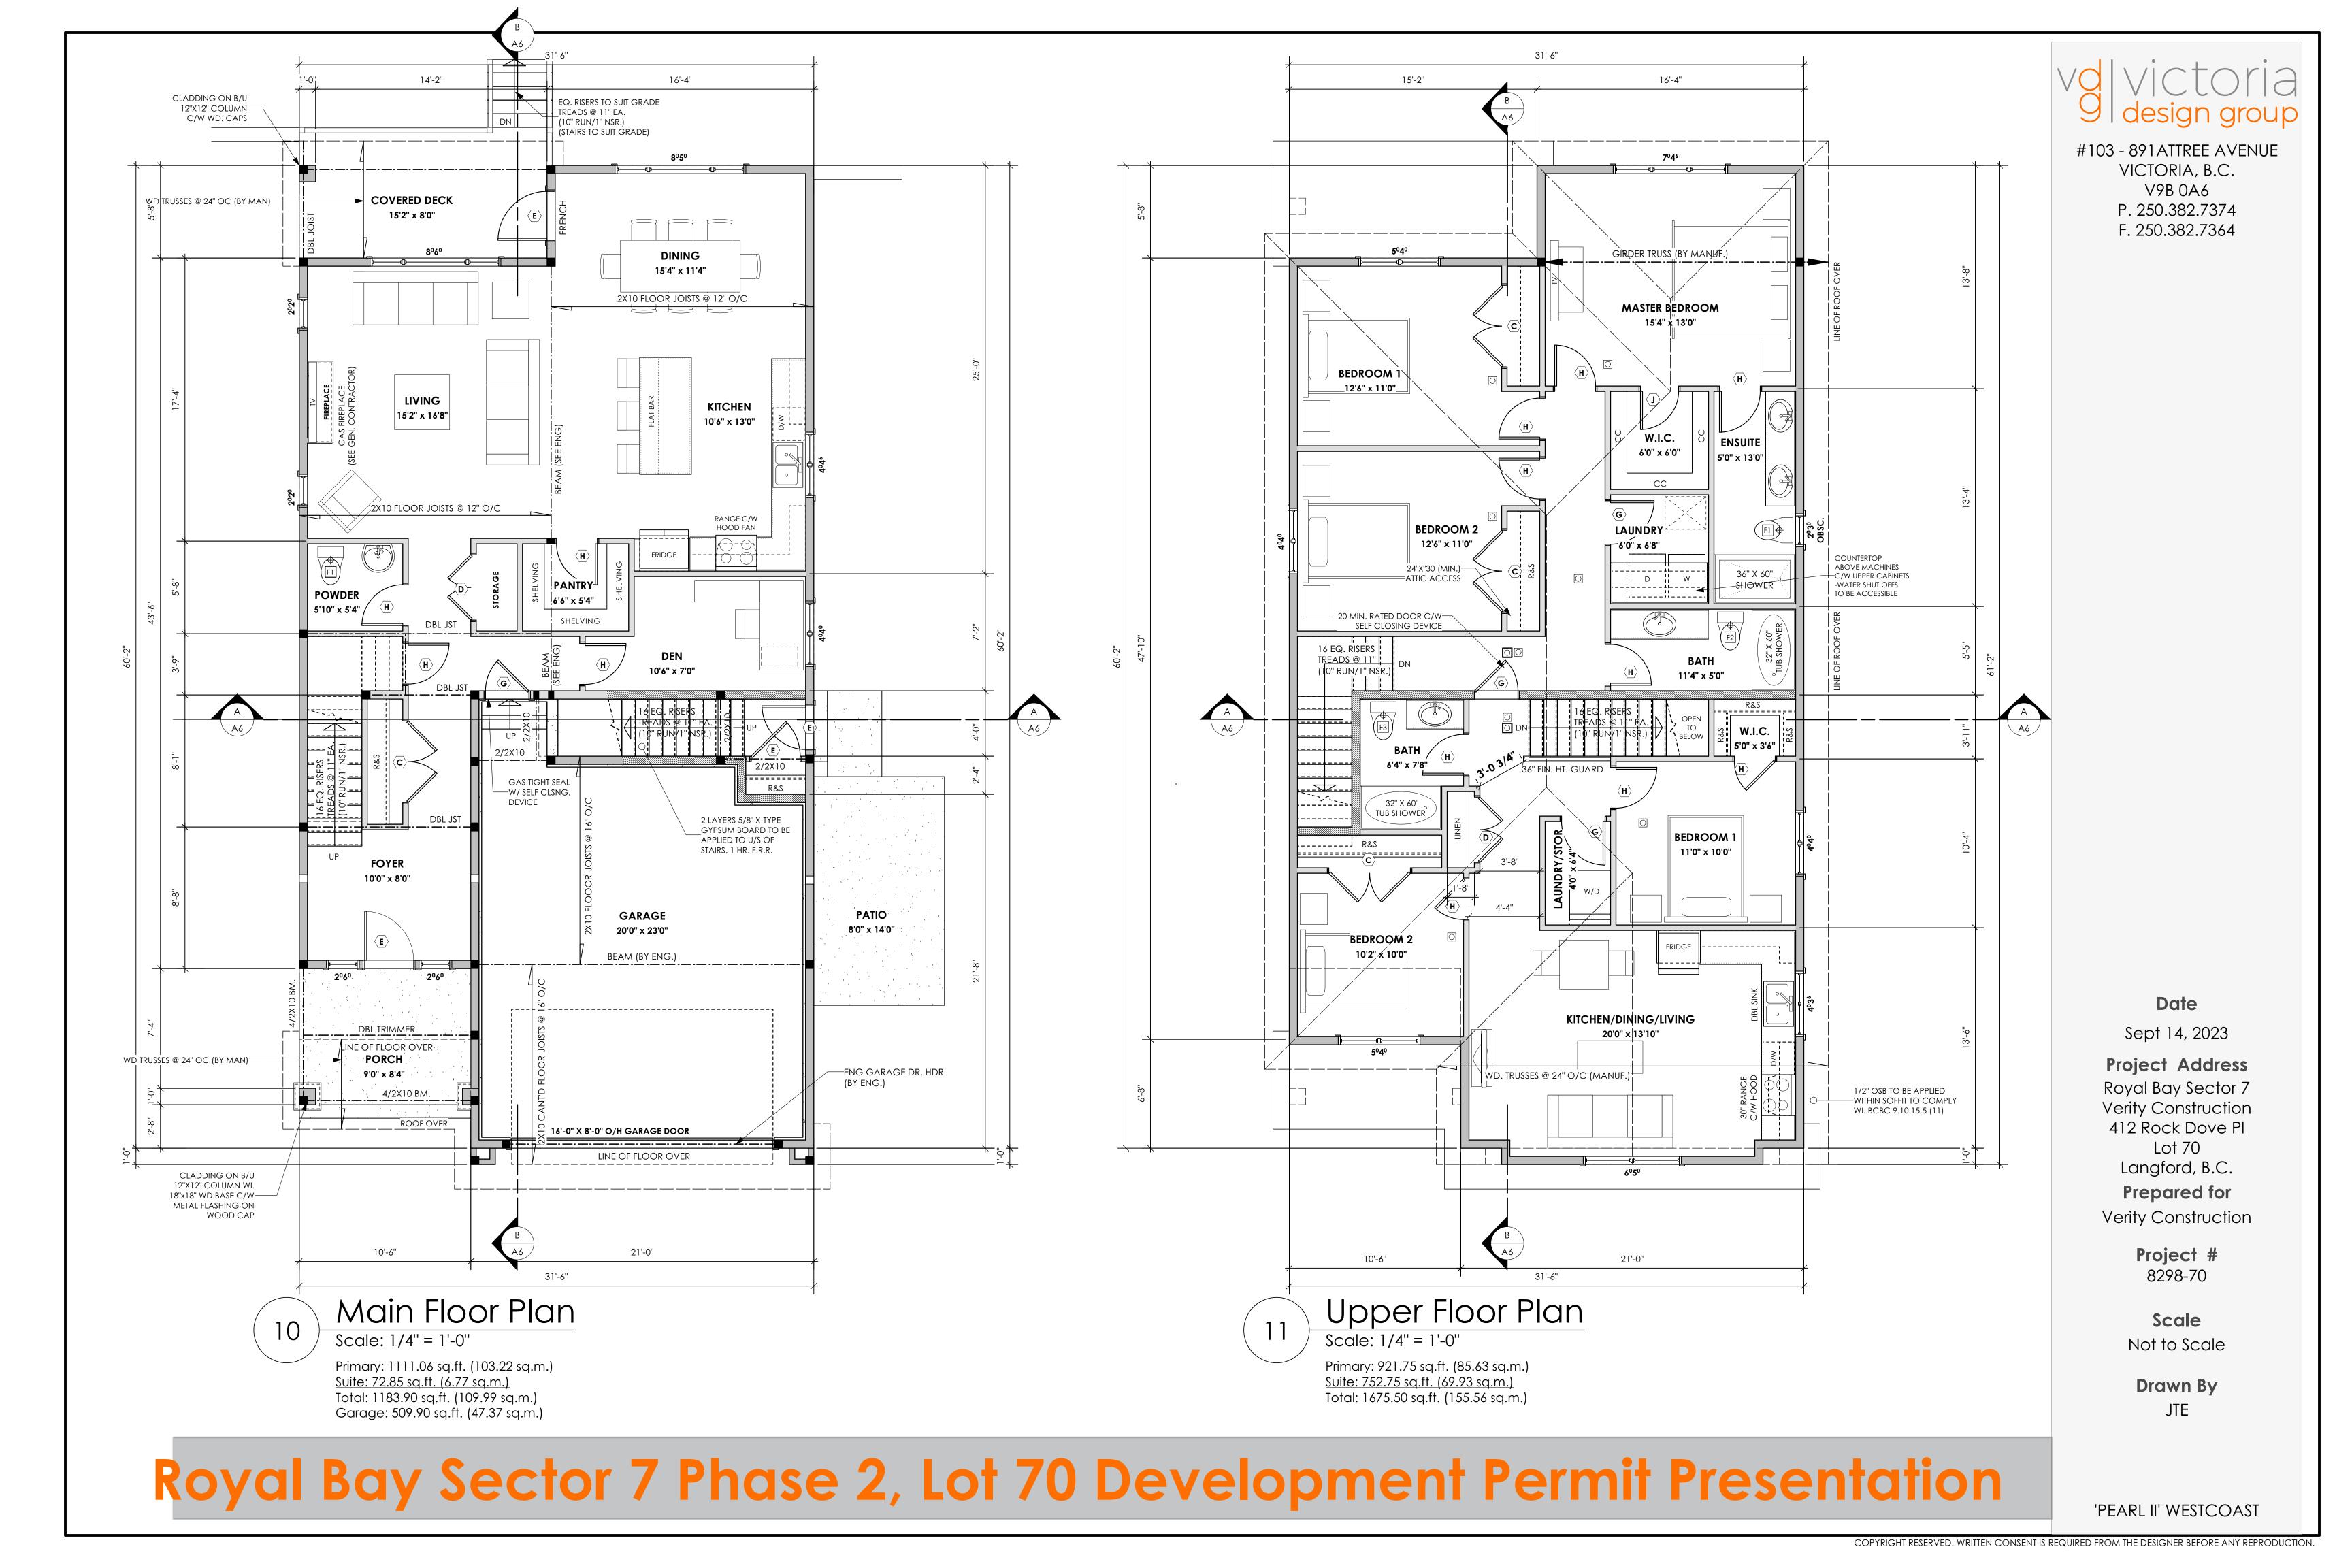

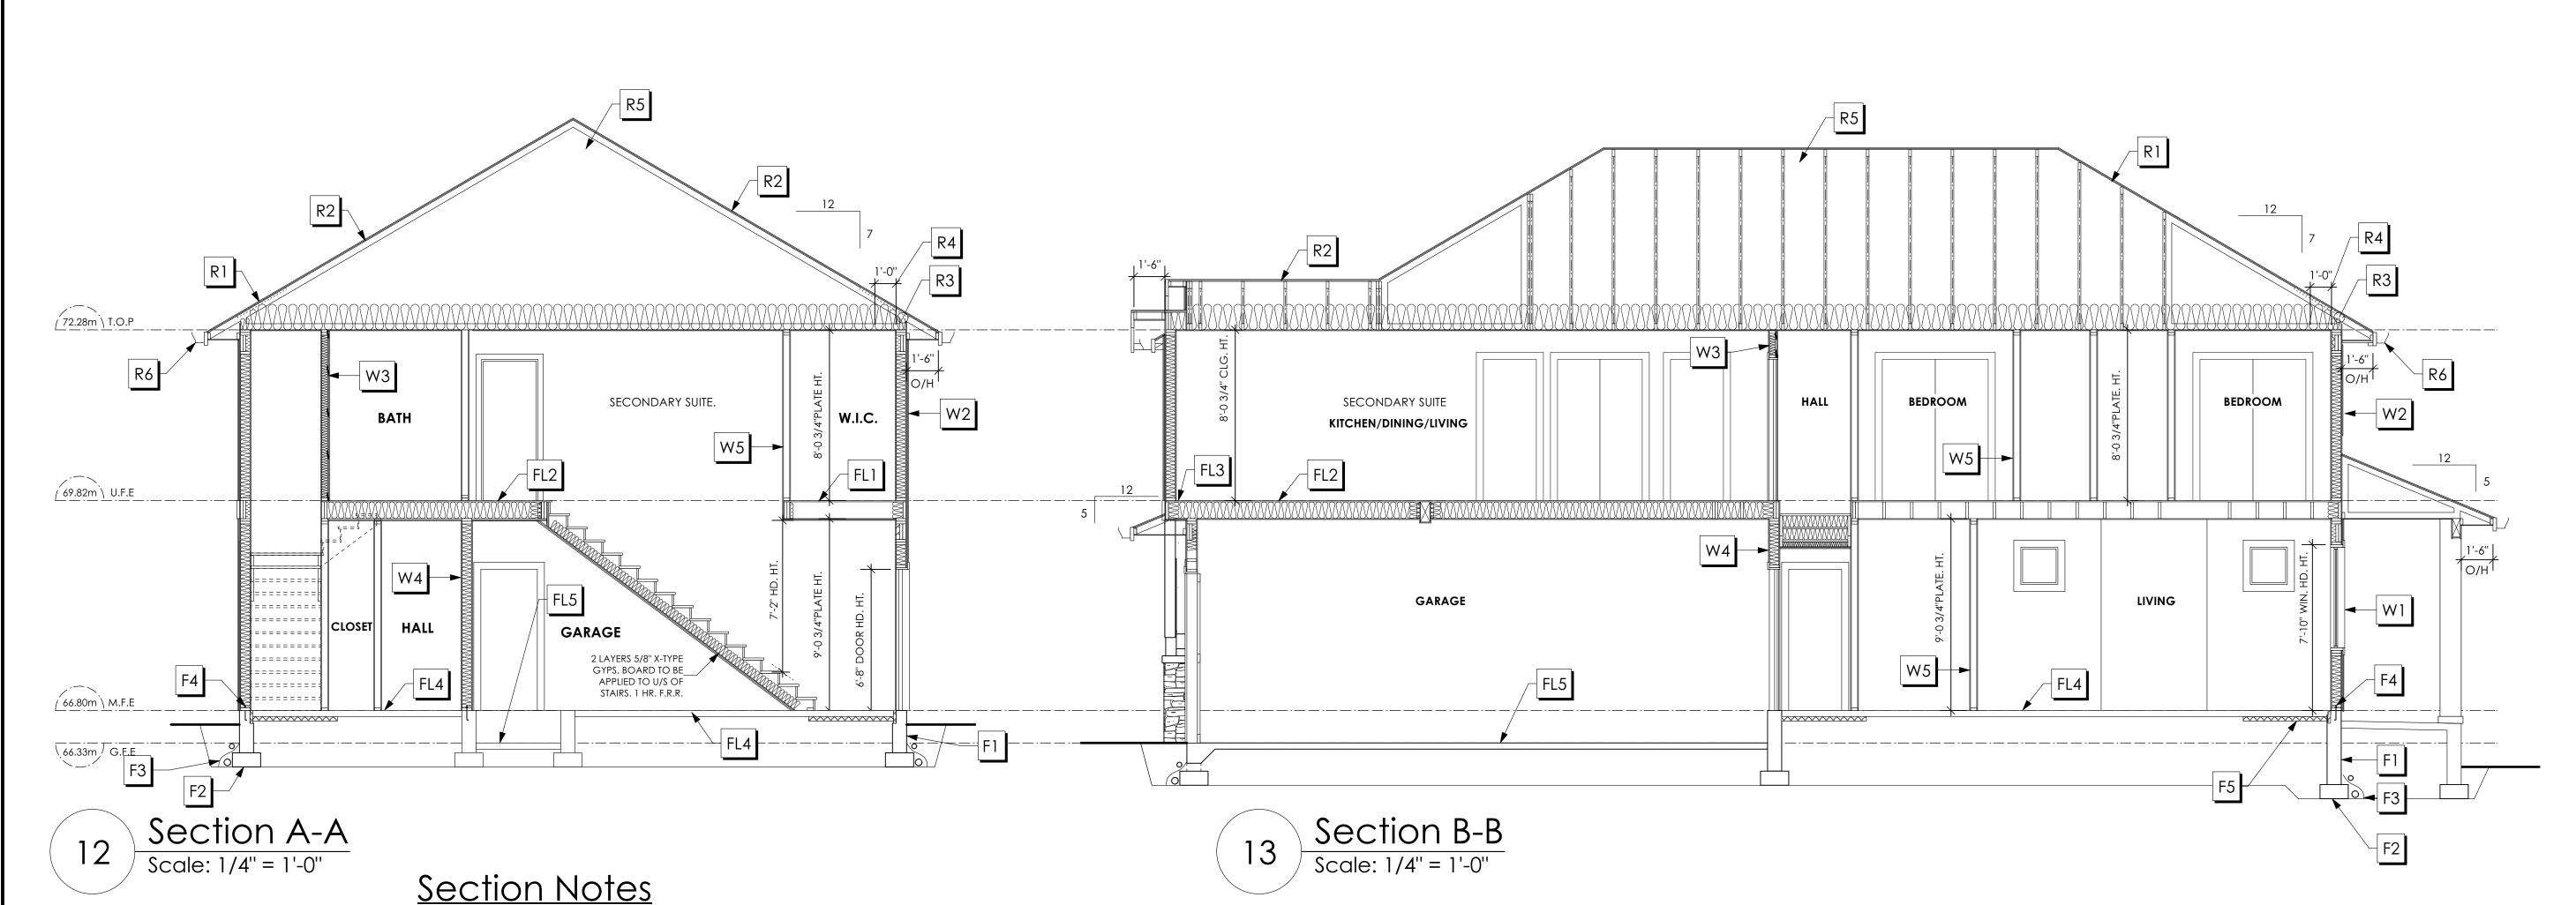FOUNDATION

- F1. DAMP PROOFING (WHERE REQUIRED) ON 8" THK. CONC. FOUNDATION WALL C/W 15 M BARS @ 24" O/C B/W
- F2. 16"X 8" CONC. FOOTINGS

 C/W 2 (TWO) 15M BARS CONT. 3 IN. FROM BOTT.

 ON UNDISTURBED SOIL (SOLID BEARING)
- F3. 4" PERIMETER DRAIN
 3" TIGHT PIPE FOR RWL
 DRAIN ROCK
- F4. ANCHOR BOLTS @ 4.0 FT. O/C MAX C/W SILL GASKETS
- F5. UNDER SLAB INSULATION
 2 1/2" (RSI 2.15) EXTRUDED POLYSTYRENE
 RIGID INSULATION 4'-0" (1.2M)
 CONT. AROUND PERIMETER UNDER
 SLAB INSTALLED HORIZONTALLY
 (VERIFY WITH MUNICIPALITY DEPTH OF FROST LINE)
- F6. STEP DOWN TO GARAGE SLAB
 MAY VARY, VERIFY EXTENT ON SITE

WALLS

- W1. DOUBLE GLAZING
 ENERGY STAR LOW "E" RATING IN
 THERMAL BREAK FRAMES
 2/2"X10" LINTEL OVER (@ BEARING WALLS ONLY)
 (TYPICAL, WI. 2 1/2" XPS INSULATION)
 FLASHING OVER @ EXTERIOR
 (GLAZING IN ALL EXTERIOR DOORS & WITHIN 3 FT.
 OF EXTERIOR DOORS TO BE SHATTERPROOF (SP))
 WINDOW REQUIREMENTS DERIVED FROM BCBC
 TABLE C-5 AS PER BCBC 9.7.4.3. AND ARE TO BE
 USED TO SATISFY THE REQUIREMENTS OF
 AAMA/WDMA/CSA 101/I.S.2/A440, "NAFS":
 COLWOOD, CLASS R, DP 1440, PG 30, WATER RESIST. 220, A2,
 RATINGS MUST BE CLEARLY LABELED ON ALL
 WINDOW UNITS UPON INSTALLATION FOR INSPECTION.
- W2. CONC. FIBRE BOARD ON
 9.5MM (3/8") AIR SPACE / STRAPPING
 3/8"×2" BORATE TREATED PLYWOOD STRAPPING
 HOUSE WRAP (A.B.) (TYVEK OR EQ.)
 7/16" ORIENTED STRAND BOARD SHEATHING
 2×6 STUDS @ 16" O/C
 R-20 INSULATION
 6 MIL. POLYETHYLENE VAPOUR BARRIER
 1/2" GYPSUM BOARD
- W3. B.C. BUILDING CODE (TABLE 9.10.3.1.A)
 RATED WALL ASSEMBLY W3C

 1 LAYER 1/2" X-TYPE GYPSUM BOARD ON
 EACH SIDE OF 2×4 STUDS @ 16" O/C OR
 2×6 STUDS @ 16" O/C (IF NOTED)
 RESILIENT METAL CHANNELS ON ONE SIDE
 @ 400mm OR 600mm O.C. C/W
 3 1/2" FIBRE GLASS SOUND BATTS
 FRICTION FITTED AND SOLID FILLED
 45 MIN. F.R.R., 43 S.T.C.
 (BETWEEN PRIMARY LIVING & SECONDARY SUITE)
- W4. 5/8" X-TYPE GYPSUM BOARD ON 2×6 STUDS @ 16" O/C C/W R-20 INSULATION 6 MIL. POLY'N V.B 1/2" GYPSUM BOARD (BETWEEN GARAGE & LIVING)
- W5. INTERIOR PARTITION
 1/2" GYPSUM BOARD ON EACH SIDE
 OF 2×4 STUDS @ 16" O/C OR
 2×6 STUDS @ 16" O/C (IF NOTED)

FLOORS

- FL1. FINISHED FLOORING ON
 19/32" ORIENTED STRAND BOARD
 (FASTENED & GLUED TO FLOOR STRUCT. BELOW) ON
 2×10 FLOOR JOISTS @ 16" OR 12" O/C
 C/W 2×2 X-BRIDGING @ 7.0' O/C (MAX)
 1/2" GYPSUM BOARD
- FL2. B.C. BUILDING CODE (TABLE-9.10.3.1.B)
 RATED FLOOR ASSEMBLY F8D
 30 MINUTE F.R.R., 50 S.T.C.
 FINISHED FLOORING ON
 19/32" ORIENTED STRAND BOARD
 (FASTENED & GLUED TO FLOOR STRUCT. BELOW) ON
 2×10 FLOOR JOISTS @ 16" OR 12" O/C
 C/W 2×2 X-BRIDGING @ 7.0' O/C (MAX)
 R-31 INSULATION
 RESILIENT METAL CHANNELS @ 24" O/C
 1 LAYER 5/8" X-TYPE GYPSUM BOARD
- FL3. FINISHED FLOORING ON

 19/32" ORIENTED STRAND BOARD

 (FASTENED & GLUED TO FLOOR STRUCT. BELOW) ON

 2×10 FLOOR JOISTS @ 16" OR 12" O/C

 C/W 2×2 X-BRIDGING @ 7.0' O/C (MAX)

 PROVIDE R-31 F/G BATT INSULATION IN

 JOIST CAVITY C/W

 BUILDING WRAP

 VENTED SOFFIT (TO OWNERS SPEC'S)

 TO ALL SUSPENDED FLOOR AREAS
- FL4. 3 1/2" CONCRETE SLAB 6 MIL. POLY'N V.B. 6" COMPACTED GRAVEL OR SAND
- FL5. 3 1/2" CONCRETE SLAB
 6 MIL. POLY'N V.B.
 6" COMPACTED GRAVEL OR SAND
 SLOPE TO DOORS 1"
- FL6. DECKING MEMBRANE
 (TO COMPLY WITH CAN/CGSB 37.54) ON
 19/32" ORIENTED STRAND BOARD
 2×10 DECK JOISTS @ 16" O/C C/W
 (PROVIDE ADEQUATE MEMBRANE
 "UPSTAND" @ EXT. WALL.)
 (SLOPE JOISTS TO PROVIDE MIN.1:50 SLOPE)

ROOFS

- R1. LAMINATED ASPHALT SHINGLES ON
 7/16" ORIENTED STRAND BOARD C/W "H" CLIPS
 WD TRUSSES (DESIGNED BY MANUF.)
 R-40 FIBRE GLAS BATT INSULATION OR
 14 1/2" FIBRE GLASS LOOSE FILL INSULATION
 6 MIL POLY'N V.B.
 5/8" GYPSUM BOARD
- R2. B.C. BUILDING CODE (TABLE-9.10.3.1.B)
 RATED ROOF ASSEMBLY R1
 45 MINUTE RATED F.R.R.
 LAMINATED ASPHALT SHINGLES ON
 7/16" ORIENTED STRAND BOARD C/W "H" CLIPS
 WD TRUSSES (DESIGNED BY MANUF.)
 R-40 FIBRE GLAS BATT INSULATION OR
 14 1/2" FIBRE GLASS LOOSE FILL INSULATION
 6 MIL POLY'N V.B.
 5/8" X-TYPE GYPSUM BOARD
- R3. PROVIDE 2 1/2" (63MM) CLEAR BETWEEN R-20 INSULATION AND SHEATHING. (MIN. R-20 @ ROOF-WALL CONNECTION FOR 4'-0" (1.2M) AROUND PERIMETER OF BUILDING. AIR VENTILATION BAFFLES TO BE INSTALLED WHERE REQUIRED IN AS PER BCBC 9.19.)
- R4. EAVE PROTECTION

 CONT. UP ROOF SLOPE FOR 12"

 PAST EXTERIOR WALL.
- R5. PROVIDE 1 SQ.FT. ATTIC VENT PER
 300 SQ.FT. OF INSULATED AREA MIN.
 25% OF REQUIRED TO BE @ TOP AND BOTTOM
 (TO COMPLY WI. B.C. BLDG. CODE 9.19.1)
- R6. PRE-FIN. FASCIA GUTTER
 2×8 FASCIA BD.
 2×4 SUB. FASCIA BD.
 VENTED SOFFIT
 (SEE CONTRACTOR)
- R7. PRE-FIN. FASCIA GUTTER
 2×8 FASCIA BD.
 2×4 SUB. FASCIA BD.
 1/2" ORIENTED STRAND BOARD
 VENTED SOFFIT
 (SEE CONTRACTOR)

volvictoria 9 design group

#103 - 891 ATTREE AVENUE VICTORIA, B.C. V9B 0A6 P. 250.382.7374 F. 250.382.7364

Date

Sept 14, 2023

Project Address
Royal Bay Sector 7
Verity Construction
412 Rock Dove Pl
Lot 70
Langford, B.C.
Prepared for
Verity Construction

Project # 8298-70

ScaleNot to Scale


Drawn By
JTE

'PEARL II' WESTCOAST

Royal Bay Sector 7 Phase 2, Lot 70 Development Permit Presentation


ALL FENCING, RETAINING AND LANDSCAPING MUST MEET THE GUIDELINE REQUIREMENTS


ALL RETAINING WALLS ARE TO BE STAND ALONE STRUCTURES (THEY MUST TERMINATE AT PROPERTY LINE) AND MUST NOT CONNECT TO RETAINING WALLS LOCATED ON ADJACENT PRIVATE PROPERTIES

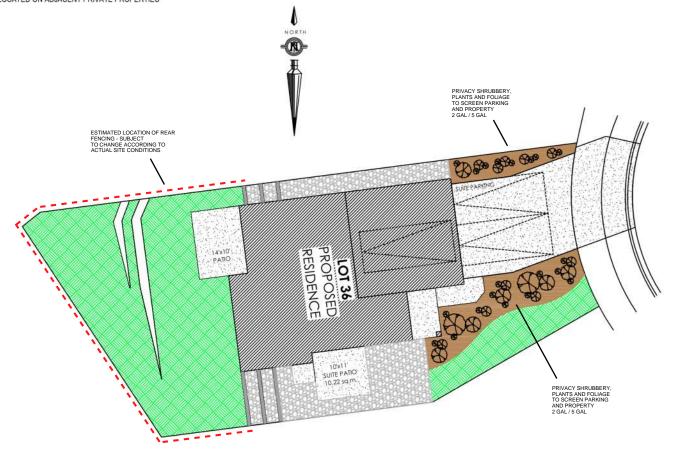

*NOTE: In the interest of maintaining high standards, the developer reserves the right to modify plans, specifications and design without prior notice. Drawings contained within are artist renderings only. Sizes and dimensions are approximate and may vary with actual plan and survey. Exterior style may change pending municipal approval. Retaining wall location and types may vary and are subject to municipal, engineering or developer discretion. Subject to change without notice. Furniture as shown on plans are for layout purposes only and are not included in the sale.

Mary 1	ITEM	AREA (sf)	%
66	GARDEN BED	387	12%
	GRAVEL	489	15%
	CONCRETE	845	25%
	SOD	1,591	48%
	TOTAL	3,312	100%

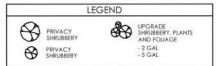

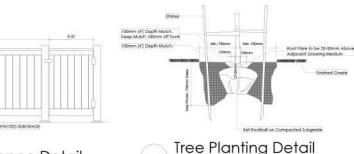

KEY PLAN

NOT TO SCALE

LOT 41

101

LOT 39 LOT 38

LOT

10T LOT 35 34

All trees and plants by the home owner to be

Typical Fence Detail

Not To Scale

**The Activities and Defence Detail

Not To Scale

ADDITIONAL NOTES:

LOCATION INDICATED BY

PROPERTY TO BE IRRIGATED
6" PIPE FOR DRIVEWAY SLEEVES TO
BE INSTALLED FOR CITY IRRIGATION
LINES

LANDSCAPE PLAI
NOT TO SCALE

	MM/DD/YY	ISSUED/REVISED	
01	06/15/23	FOR APPROVAL	
02	09/15/23	SITE PLAN REVISION	
			ı

PROJECT

DATE

LANDSCAPING PLAN LOT 36, 3445 TRUMPETER ST. ROYAL BAY, SECTOR 7 CITY OF COLWOOD




QUALITY CONSTRUCTION. TRUSTED SERVICE.

106 - 1039 Langford Parkway Victoria, B.C. V9B 0A6 P: 250.474.1039 www.verityconstruction.ca

Schedule 2

ALL FENCING, RETAINING AND LANDSCAPING MUST MEET THE **GUIDELINE REQUIREMENTS**

ALL RETAINING WALLS ARE TO BE STAND ALONE STRUCTURES (THEY MUST TERMINATE AT PROPERTY LINE) AND MUST NOT CONNECT TO RETAINING WALLS LOCATED ON ADJACENT PRIVATE PROPERTIES

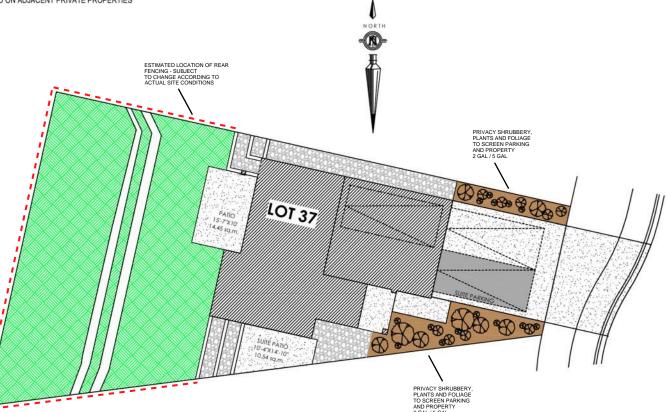


DATE


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	ITEM	AREA (sf)	%
88	GARDEN BED	298	9%
	GRAVEL	326	10%
1	CONCRETE	827	24%
	SOD	1,920	57%
	TOTAL	3,371	100%


	LE	GEND	
88	PRIVACY SHRUBBERY PRIVACY SHRUBBERY		UPGRADE SHRUBBERY, PLANTS AND FOLIAGE - 2 GAL

KEY PLAN NOT TO SCALE



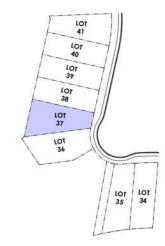

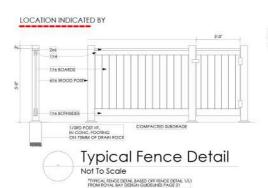ADDITIONAL NOTES: PROPERTY TO BE IRRIGATED 6" PIPE FOR DRIVEWAY SLEEVES TO BE INSTALLED FOR CITY IRRIGATION LINES

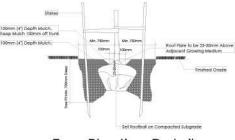

Tree Planting Detail All trees and plants by the home owner to be




	MM/DD/YY	ISSUED/REVISED	DATE
01	06/15/23	FOR APPROVAL	PROJECT
i i	1		1

LANDSCAPING PLAN LOT 37, 3447 TRUMPETER ST. **ROYAL BAY, SECTOR 7** CITY OF COLWOOD



QUALITY CONSTRUCTION. TRUSTED SERVICE.

106 - 1039 Langford Parkway Victoria, B.C. V9B 0A6

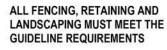

ALL RETAINING WALLS ARE TO BE STAND ALONE STRUCTURES (THEY MUST TERMINATE AT PROPERTY LINE) AND MUST NOT CONNECT TO RETAINING WALLS LOCATED ON ADJACENT PRIVATE PROPERTIES

NORTH

ESTIMATED LOCATION OF REAR FENCING - SUBJECT TO CHANGE ACCORDING TO

LOT 38 PROPOSED RESIDENCE

> 7'4'x15'-9 SUITE PATIO :10.72 SQ.M.

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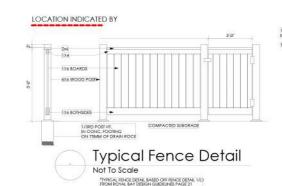
PRIVACY SHRUBBERY, PLANTS AND FOLIAGE TO SCREEN PARKING AND PROPERTY 2 GAL / 5 GAL

PRIVACY SHRUBBERY PLANTS AND FOLIAGE TO SCREEN PARKING 2 GAL / 5 GAL


*NOTE: In the interest of maintaining high standards, the developer reserves the right to modify plans, specifications and design without prior notice. Drawings contained within are artist renderings only. Sizes and dimensions are approximate and may vary with actual plan and survey. Exterior style may change pending municipal approval. Retaining wall location and types may vary and are subject to municipal, engineering or developer discretion. Subject to change without notice. Furniture as shown on plans are for layout purposes only and are not included in the sale.

	ITEM	AREA (sf)	%
88	GARDEN BED	323	12%
	GRAVEL	383	14%
	CONCRETE	798	29%
	SOD	1,211	45%
	TOTAL	2,715	100%

LEGEND UPGRADE SHRUBBERY, PLANTS PRIVACY SHRUBBERY AND FOLIAGE PRIVACY SHRUBBERY - 2 GAL - 5 GAL





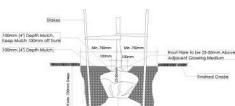

LOT LOT 35

Tree Planting Detail All trees and plants by the home owner to be

ADDITIONAL NOTES:

PROPERTY TO BE IRRIGATED 6" PIPE FOR DRIVEWAY SLEEVES TO BE INSTALLED FOR CITY IRRIGATION LINES

LANDSCAPE PLAN
NOT TO SCALE

	MM/DD/YY	1220ED/KEAI2ED
01	06/15/23	FOR APPROVAL
i i	i i	

MANAIDDIVV

DATE **PROJECT**

> LANDSCAPING PLAN LOT 38, 3449 TRUMPETER ST. **ROYAL BAY, SECTOR 7** CITY OF COLWOOD



KEY PLAN

NOT TO SCALE


LOT 41

LOT

LOT LOT 37 10T

QUALITY CONSTRUCTION. TRUSTED SERVICE.

106 - 1039 Langford Parkway Victoria, B.C. V9B 0A6

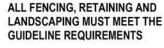

ALL RETAINING WALLS ARE TO BE STAND ALONE STRUCTURES (THEY MUST TERMINATE AT PROPERTY LINE) AND MUST NOT CONNECT TO RETAINING WALLS LOCATED ON ADJACENT PRIVATE PROPERTIES

ESTIMATED LOCATION OF REAR FENCING - SUBJECT TO CHANGE ACCORDING TO

ACTUAL SITE CONDITIONS

PRIVACY SHRUBBERY PLANTS AND FOLIAGE TO SCREEN PARKING AND PROPERTY 2 GAL / 5 GAL

6'-8"x16'5" SUITE PATIO 10.18 sq.m.

LOT 39


PROPOSED RESIDENCE


> PRIVACY SHRUBBERY, PLANTS AND FOLIAGE TO SCREEN PARKING AND PROPERTY 2 GAL / 5 GAL

*NOTE: In the interest of maintaining high standards, the developer reserves the right to modify plans, specifications and design without prior notice. Drawings contained within are artist renderings only. Sizes and dimensions are approximate and may vary with actual plan and survey. Exterior style may change pending municipal approval. Retaining wall location and types may vary and are subject to municipal, engineering or developer discretion. Subject to change without notice. Furniture as shown on plans are for layout purposes only and are not included in the sale.


	ITEM	AREA (sf)	%
66	GARDEN BED	256	9%
3024	GRAVEL	413	15%
	CONCRETE	795	29%
	SOD	1,288	47%
	TOTAL	2,752	100%

LEGEND UPGRADE SHRUBBERY, PLANTS PRIVACY SHRUBBERY AND FOLIAGE - 2 GAL - 5 GAL PRIVACY SHRUBBERY

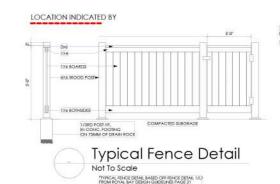

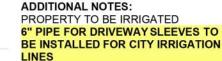

KEY PLAN NOT TO SCALE

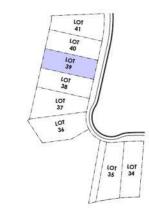



All trees and plants by the home owner to be



	MM/DD/YY	ISSUED/REVISED	DATE
01	06/16/23	FOR APPROVAL	PROJECT

LANDSCAPING PLAN LOT 39, 3451 TRUMPETER ST. **ROYAL BAY, SECTOR 7** CITY OF COLWOOD




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106 - 1039 Langford Parkway Victoria, B.C. V9B 0A6

ALL FENCING, RETAINING AND LANDSCAPING MUST MEET THE GUIDELINE REQUIREMENTS

ALL RETAINING WALLS ARE TO BE STAND ALONE STRUCTURES (THEY MUST TERMINATE AT PROPERTY LINE) AND MUST NOT CONNECT TO RETAINING WALLS LOCATED ON ADJACENT PRIVATE PROPERTIES

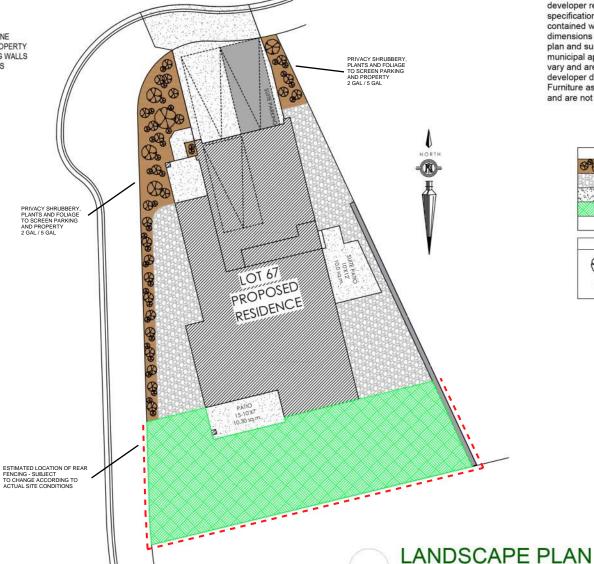


*NOTE: In the interest of maintaining high standards, the developer reserves the right to modify plans, specifications and design without prior notice. Drawings contained within are artist renderings only. Sizes and dimensions are approximate and may vary with actual plan and survey. Exterior style may change pending municipal approval. Retaining wall location and types may vary and are subject to municipal, engineering or developer discretion. Subject to change without notice. Furniture as shown on plans are for layout purposes only and are not included in the sale.

1000	ITEM	AREA (sf)	%
398	GARDEN BED	435	13%
	GRAVEL	876	26%
	CONCRETE	721	21%
	SOD	1,375	40%
	TOTAL	3,407	100%




KEY PLAN NOT TO SCALE



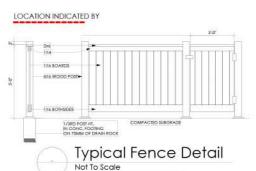

*TYPICAL FENCE DETAIL BASED OFF FENCE DETAIL 1/L1 FROM ROYAL BAY DESIGN GUIDELINES PAGE 21

ADDITIONAL NOTES:
PROPERTY TO BE IRRIGATED
6" PIPE FOR DRIVEWAY SLEEVES TO
BE INSTALLED FOR CITY IRRIGATION
LINES

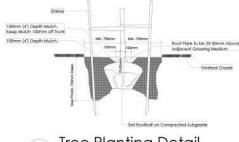

Tree Planting Detail

Not To Scale

All trees and plants by the home owner to be planted in minimum 10m² of tertile topsoit, 700mm Deep

	MM/DD/YY	ISSUED/REVISED
01	06/16/23	FOR APPROVAL
02	07/06/23	SITE PLAN REVISION
03	09/18/23	SITE PLAN REVISION

DATE PROJECT


> LANDSCAPING PLAN LOT 67, 3462 TRUMPETER ST. ROYAL BAY, SECTOR 7 CITY OF COLWOOD

NOT TO SCALE



QUALITY CONSTRUCTION. TRUSTED SERVICE.

106 - 1039 Langford Parkway Victoria, B.C. V9B 0A6

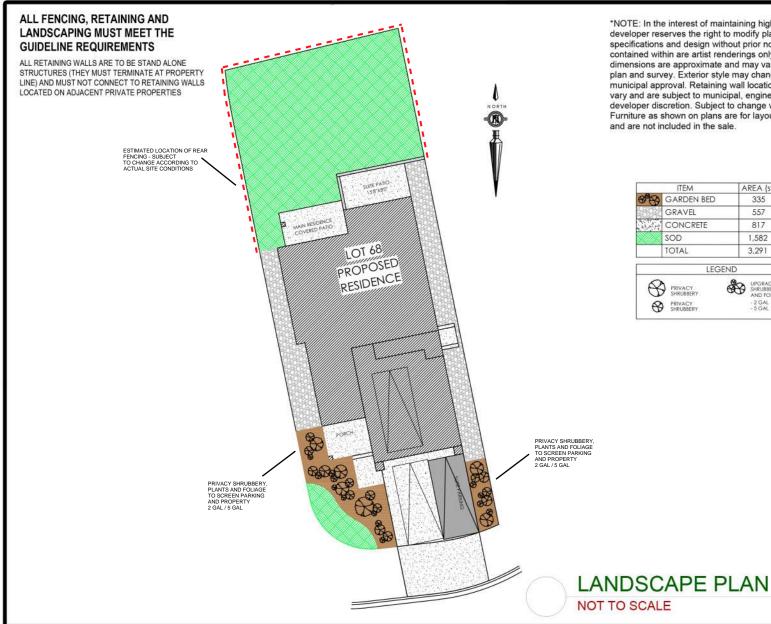



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101	ITEM	AREA (sf)	%
88	GARDEN BED	335	10%
	GRAVEL	557	17%
	CONCRETE	817	25%
	SOD	1,582	48%
	TOTAL	3,291	100%

LEGEND UPGRADE SHRUBBERY, PLANTS AND FOLIAGE PRIVACY SHRUBBERY PRIVACY SHRUBBERY

KEY PLAN NOT TO SCALE



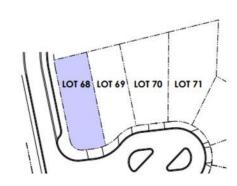

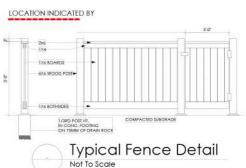"TYPICAL FENCE DETAIL BASED OFF FENCE DETAIL 1/L1 FROM ROYAL BAY DESIGN GUIDELINES PAGE 21

Roof Flare to be 25-30mm Above Adjacent Growing Medium Tree Planting Detail Not To Scale

All trees and plants by the home owner to be

ADDITIONAL NOTES:


ADDITIONAL NOTES:
PROPERTY TO BE IRRIGATED
6" PIPE FOR DRIVEWAY SLEEVES TO
BE INSTALLED FOR CITY IRRIGATION
LINES

	MM/DD/YY	ISSUED/REVISED	DAIE
01	04/11/23	FOR APPROVAL	PROJECT
			LANDSCAPING PLAN
			LOT 68, 420 ROCK DOVE PL.
			ROYAL BAY, SECTOR 7
			CITY OF COLWOOD



QUALITY CONSTRUCTION. TRUSTED SERVICE.

106 - 1039 Langford Parkway Victoria, B.C. V9B 0A6

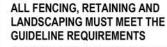

ALL RETAINING WALLS ARE TO BE STAND ALONE STRUCTURES (THEY MUST TERMINATE AT PROPERTY LINE) AND MUST NOT CONNECT TO RETAINING WALLS LOCATED ON ADJACENT PRIVATE PROPERTIES

ESTIMATED LOCATION OF REAR FENCING - SUBJECT TO CHANGE ACCORDING TO ACTUAL SITE CONDITIONS

> PRIVACY SHRUBBERY PLANTS AND FOLIAGE TO SCREEN PARKING AND PROPERTY

NORTH SUITE PATIO

> LOT 69 PROPOSED RESIDENCE


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*NOTE: In the interest of maintaining high standards, the

	ITEM	AREA (sf)	%
68	GARDEN BED	393	13%
	GRAVEL	428	15%
	CONCRETE	681	23%
	SOD	1,460	49%
	TOTAL	2,962	100%




KEY PLAN NOT TO SCALE



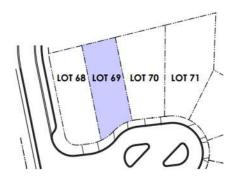

NOT TO SCALE

PRIVACY SHRUBBERY PLANTS AND FOLIAGE TO SCREEN PARKING

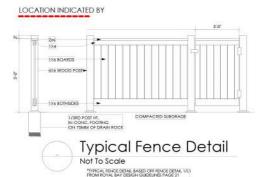

Roof Flare to be 25-50mm Above Adjacent Growing Medium Tree Planting Detail

All trees and plants by the home owner to be

ADDITIONAL NOTES:

D BE IRRIGATED RIVEWAY SLEEVES TO

	ADDITIONAL IN
	PROPERTY TO
LANDSCAPE PLAN	6" PIPE FOR DI
LANDOUAL LI LAN	RE INSTALLED

BE INSTALLED FOR CITY IRRIGATION LINES

	MM/DD/YY	ISSUED/REVISED
01	04/14/23	FOR APPROVAL
02	06/20/23	SITE PLAN REVISION
03	09/08/23	SITE PLAN REVISION

PROJECT


DATE

LANDSCAPING PLAN LOT 69, 416 ROCK DOVE PL. **ROYAL BAY, SECTOR 7** CITY OF COLWOOD



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*NOTE: In the interest of maintaining high standards, the developer reserves the right to modify plans, specifications and design without prior notice. Drawings contained within are artist renderings only. Sizes and dimensions are approximate and may vary with actual plan and survey. Exterior style may change pending municipal approval. Retaining wall location and types may vary and are subject to municipal, engineering or developer discretion. Subject to change without notice. Furniture as shown on plans are for layout purposes only and are not included in the sale.


ITEM		AREA (sf)	%
16	GARDEN BED	399	11%
	GRAVEL	980	26%
	CONCRETE	659	17%
	SOD	1,722	46%
	TOTAL	3,760	100%

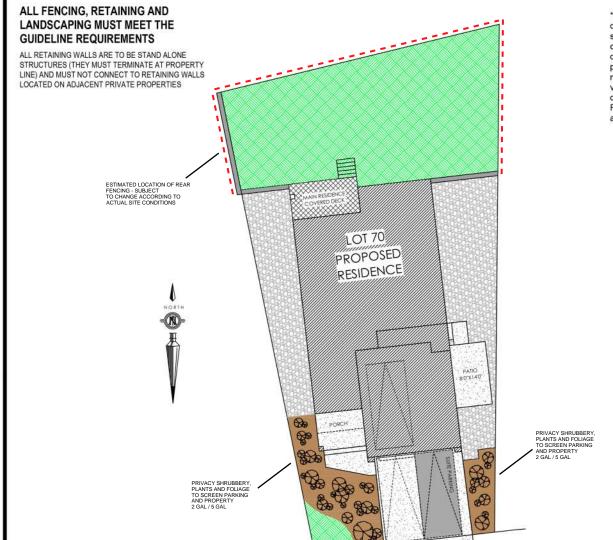


LANDSCAPE PLAN

NOT TO SCALE

KEY PLAN NOT TO SCALE

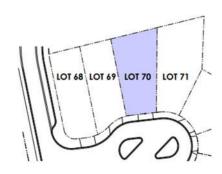

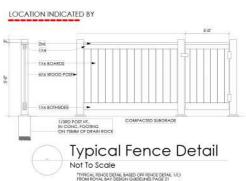

ADDITIONAL NOTES:

PROPERTY TO BE IRRIGATED
6" PIPE FOR DRIVEWAY SLEEVES TO
BE INSTALLED FOR CITY IRRIGATION
LINES

	MM/DD/YY	ISSUED/REVISED
01	03/17/23	FOR APPROVAL
02	06/20/23	SITE PLAN REVISION
03	09/18/23	SITE PLAN REVISION
	Î	

PROJECT

DATE

LANDSCAPING PLAN LOT 70, 412 ROCK DOVE PL. ROYAL BAY, SECTOR 7 CITY OF COLWOOD



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106 - 1039 Langford Parkway Victoria, B.C. V9B 0A6 P: 250.474.1039 www.verityconstruction.ca

Roof Flare to be 25-50mm Above Adjacent Growing Medium

Tree Planting Detail

All trees and plants by the home owner to be