

CITY OF COLWOOD 3300 Wishart Road | Colwood | BC V9C 1R1 | 250 294-8153 planning@colwood.ca | www.colwood.ca

File: DP000015 - Single Family Dwellings at 409, 417 Rock Dove Pl and 3442, 3426 Trumpeter St

DEVELOPMENT PERMIT DP000015

THIS PERMIT, issued March 14, 2024, is,

ISSUED BY: CITY OF COLWOOD, a municipality incorporated under the *Local Government Act*, 3300 Wishart Road, Victoria, BC, V9C 1R1

(the "City")

PURSUANT TO: Section 490 of the Local Government Act , RSBC 2015, Chapter 1

ISSUED TO: VERITY CONSTRUCTION LTD. 106-1039 LANGFORD PKY LANGFORD BC V9B 0A5

(the "Permittee")

1. This Form and Character (Intensive Residential) Development Permit applies to those lands within the City of Colwood described below, and any and all buildings, structures, and other development thereon:

LOT 75, 77, 80 & 81 SECTION 38, ESQUIMALT LAND DISTRICT, PLAN EPP117070 409 & 417 ROCK DOVE PLACE 3426 & 3442 TRUMPETER STREET

(the "Lands")

- 2. This Development Permit regulates the development and alterations of the Land, and supplements the "Colwood Land Use Bylaw, 1989" (Bylaw No. 151), to ensure the Form and Character considerations for the development of four single-family homes with secondary suites and associated site improvements are consistent with the design guidelines for areas designated as "Intensive Residential" in the City of Colwood Official Community Plan (Bylaw No. 1700).
- 3. This Development Permit is **NOT** a Building Permit or a subdivision approval.
- 4. This Development Permit is issued subject to compliance with all of the bylaws of the City of Colwood that apply to the development of the Lands, except as specifically supplemented by this Permit.

DEVELOPMENT PERMIT Single Family Dwellings at 409, 417 Rock Dove Pl and 3442, 3426 Trumpeter St PAGE 2 OF 3

- 5. The Director of Development Services or their delegate may approve minor variations to the schedules attached to and forming part of this Development Permit, provided that such minor variations are consistent with the overall intent of the original plans and do not alter the form and character of the development authorized by those plans.
- 6. If the Permittee does not substantially start the construction permitted by this Permit within 24 months of the date of this Permit, the Permit shall lapse and be of no further force and effect.
- 7. The development is to be constructed in accordance with the following plans and specifications, which are attached to and form as part of this permit:

Schedule 1	Site Plans, Elevations, Floor Plans, and Cross Sections prepared by Victoria Design Group for Lot 75 dated October 21, 2023, Lot 77 dated November 17, 2023, Lot 80 dated November 9, 2023, and Lot 81 dated August 9, 2023.
Cabadula 2	

- Schedule 2Landscape Plans prepared by Verity Construction for Lot 75 dated October5, 2023, Lot 77 dated October 6, 2023, Lot 80 dated November 3, 2023, andLot 81 dated July 18, 2023.
- 8. This Development Permit authorizes the development of four single-family homes with secondary suites along with any associated site works. The Lands shall not be altered, nor any buildings or structures constructed, except in accordance with the following conditions:

GENERAL

8.1. This Permit shall not be construed as relieving the Permittee from compliance with any of the requirements contained within the Section 219 covenant registered as CA9829109.

FORM AND CHARACTER CONDITIONS

Building Features

- 8.2. The form and character of the buildings to be constructed on the Lands shall conform to the Architectural Drawings prepared by Victoria Design Group (Schedule 1).
- 8.3. Any future additions of telecommunications antennas or equipment to the exterior of the buildings and/or structures included in this Permit shall be architecturally integrated into the buildings and/or structures they are mounted on or screened from views so as not to be visually obtrusive, to the satisfaction of the Director of Development Services or their delegate.
- 8.4. All mechanical roof elements, including mechanical equipment, elevator housings, and vents shall be visually screened with sloped roofs or parapets, or other forms of solid screening to the satisfaction of the Director of Development Services or their delegate.
- 8.5. No future construction/installation of unenclosed or enclosed outdoor storage areas or recycling/refuse collection shall be undertaken without the issuance of a further Development Permit or amendment to this Permit.

Landscaping

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8.6. The design and construction of the proposed landscaping shall be in substantial compliance with the Landscape Plans prepared by Verity Construction (Schedule 2).


ISSUED ON THIS 13 DAY OF MARCH, 2024.

10

JOHN ROSENBERG, A.Sc.T. DIRECTOR OF ENGINEERING AND DEVELOPMENT SERVICES

SCHEDULE 1

SITE DATA	RBCD5	LOT 75
ITEMS	PERMITTED	PROPOSED
LOT AREA	550 sq.m.	482.30 sq.m.
LOT COVERAGE	50.00 %	30.77 %
BUILDING HEIGHT	9.50 m.	8.70 m.
LOT WIDTH	16.50 m.	12.94 m.
Setbacks		
- FRONT	4.50 m.	7.42 m.
- FRONT (GARAGE)	6.00 m.	7.42 m.
- REAR	6.00 m.	6.12 m.
- SIDE	1.20 m.	1.44 m.
- SIDE	1.20 m.	1.22 m.
PROPOSED FLOOR AREA		
- UPPER		106.27 sq.m.
- MAIN		81.69 sq.m.
- LOWER		81.99 sq.m.
- GARAGE		44.97 sq.m.
SUB-TOTAL G.F.A.		314.92 sq.m.
GARAGE ALLOWANCE	50.00 sq.m.	-44.97 sq.m.
GROSS FLOOR AREA		269.95 sq.m.
F.A.R.		0.56 TO 1.0
SECONDARY SUITE		
FLOOR AREA (%)	40.00 %	23.50 %
FLOOR AREA (SQ.M.)	90.00 sq.m.	63.43 sq.m.

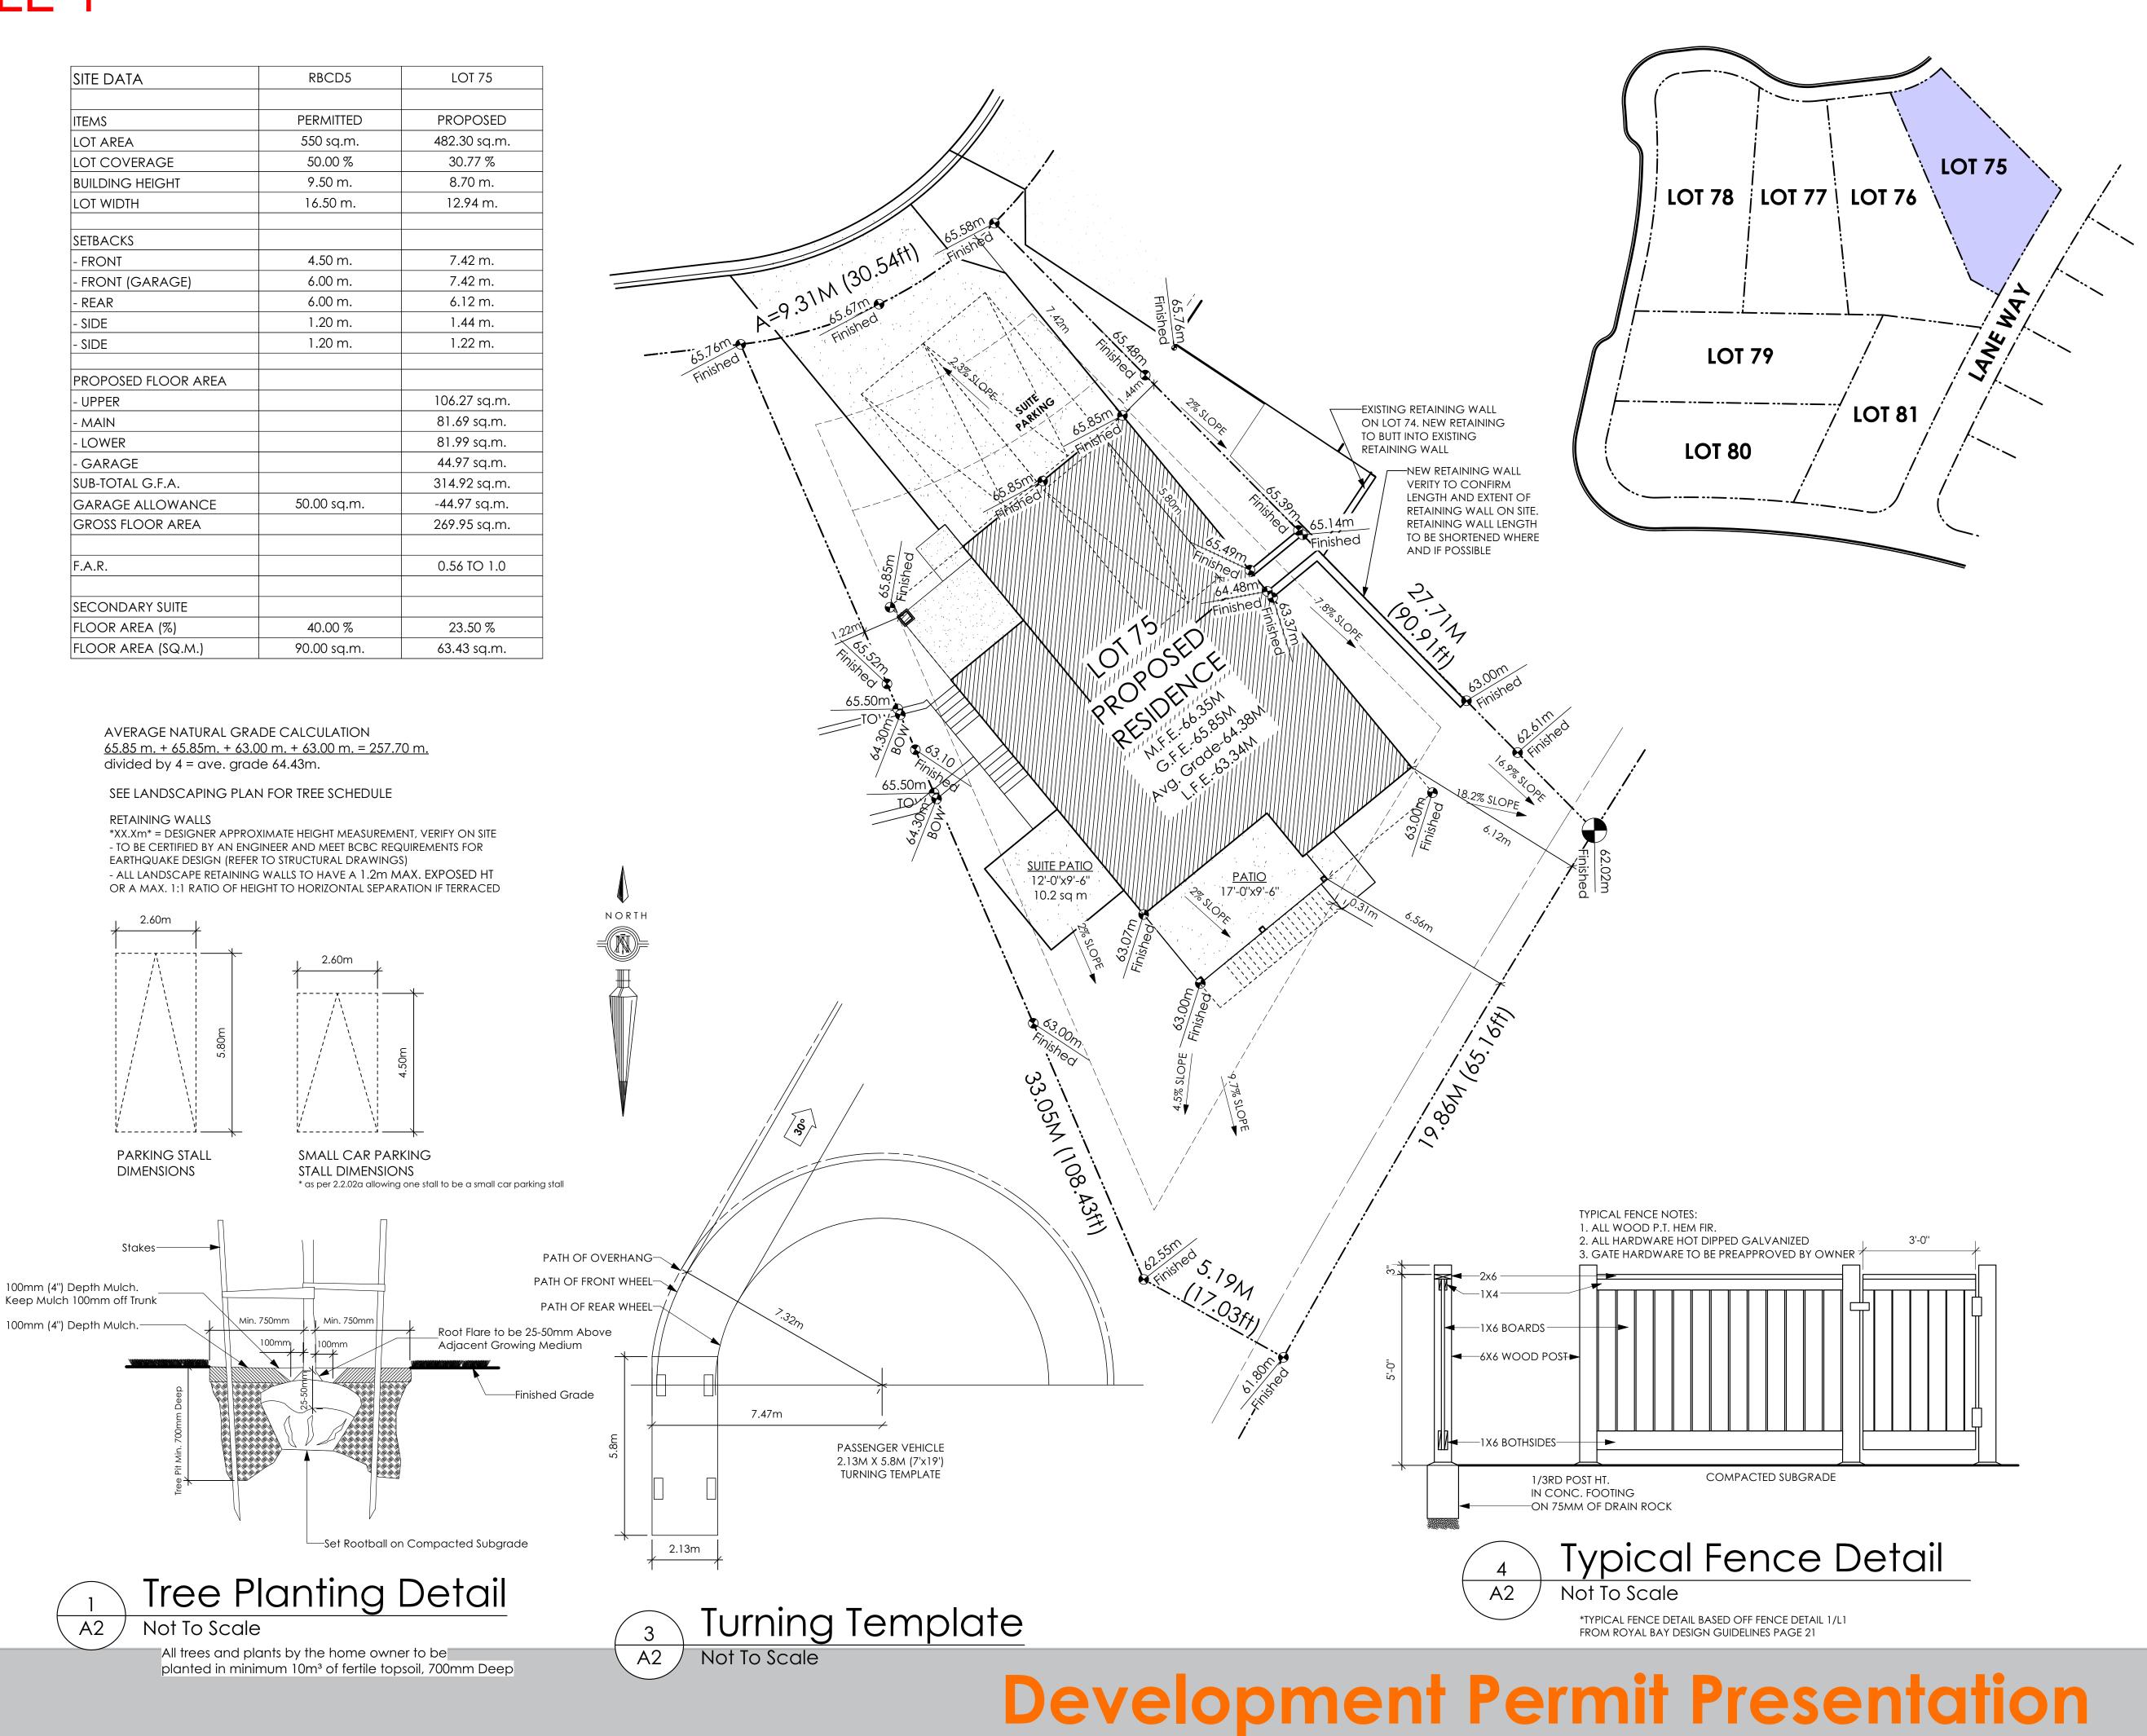



#103 - 891ATTREE AVENUE VICTORIA, B.C. V9B 0A6 P. 250.382.7374 F. 250.382.7364

RIDGE TRADITIONAL

Date Oct 31, 2023


Project Address 409 Rock Dove Place Royal Bay - Sector 7 Colwood, B.C. Prepared for

Verity Construction

Project # 8298-75

Scale As Noted

Drawn By MDK

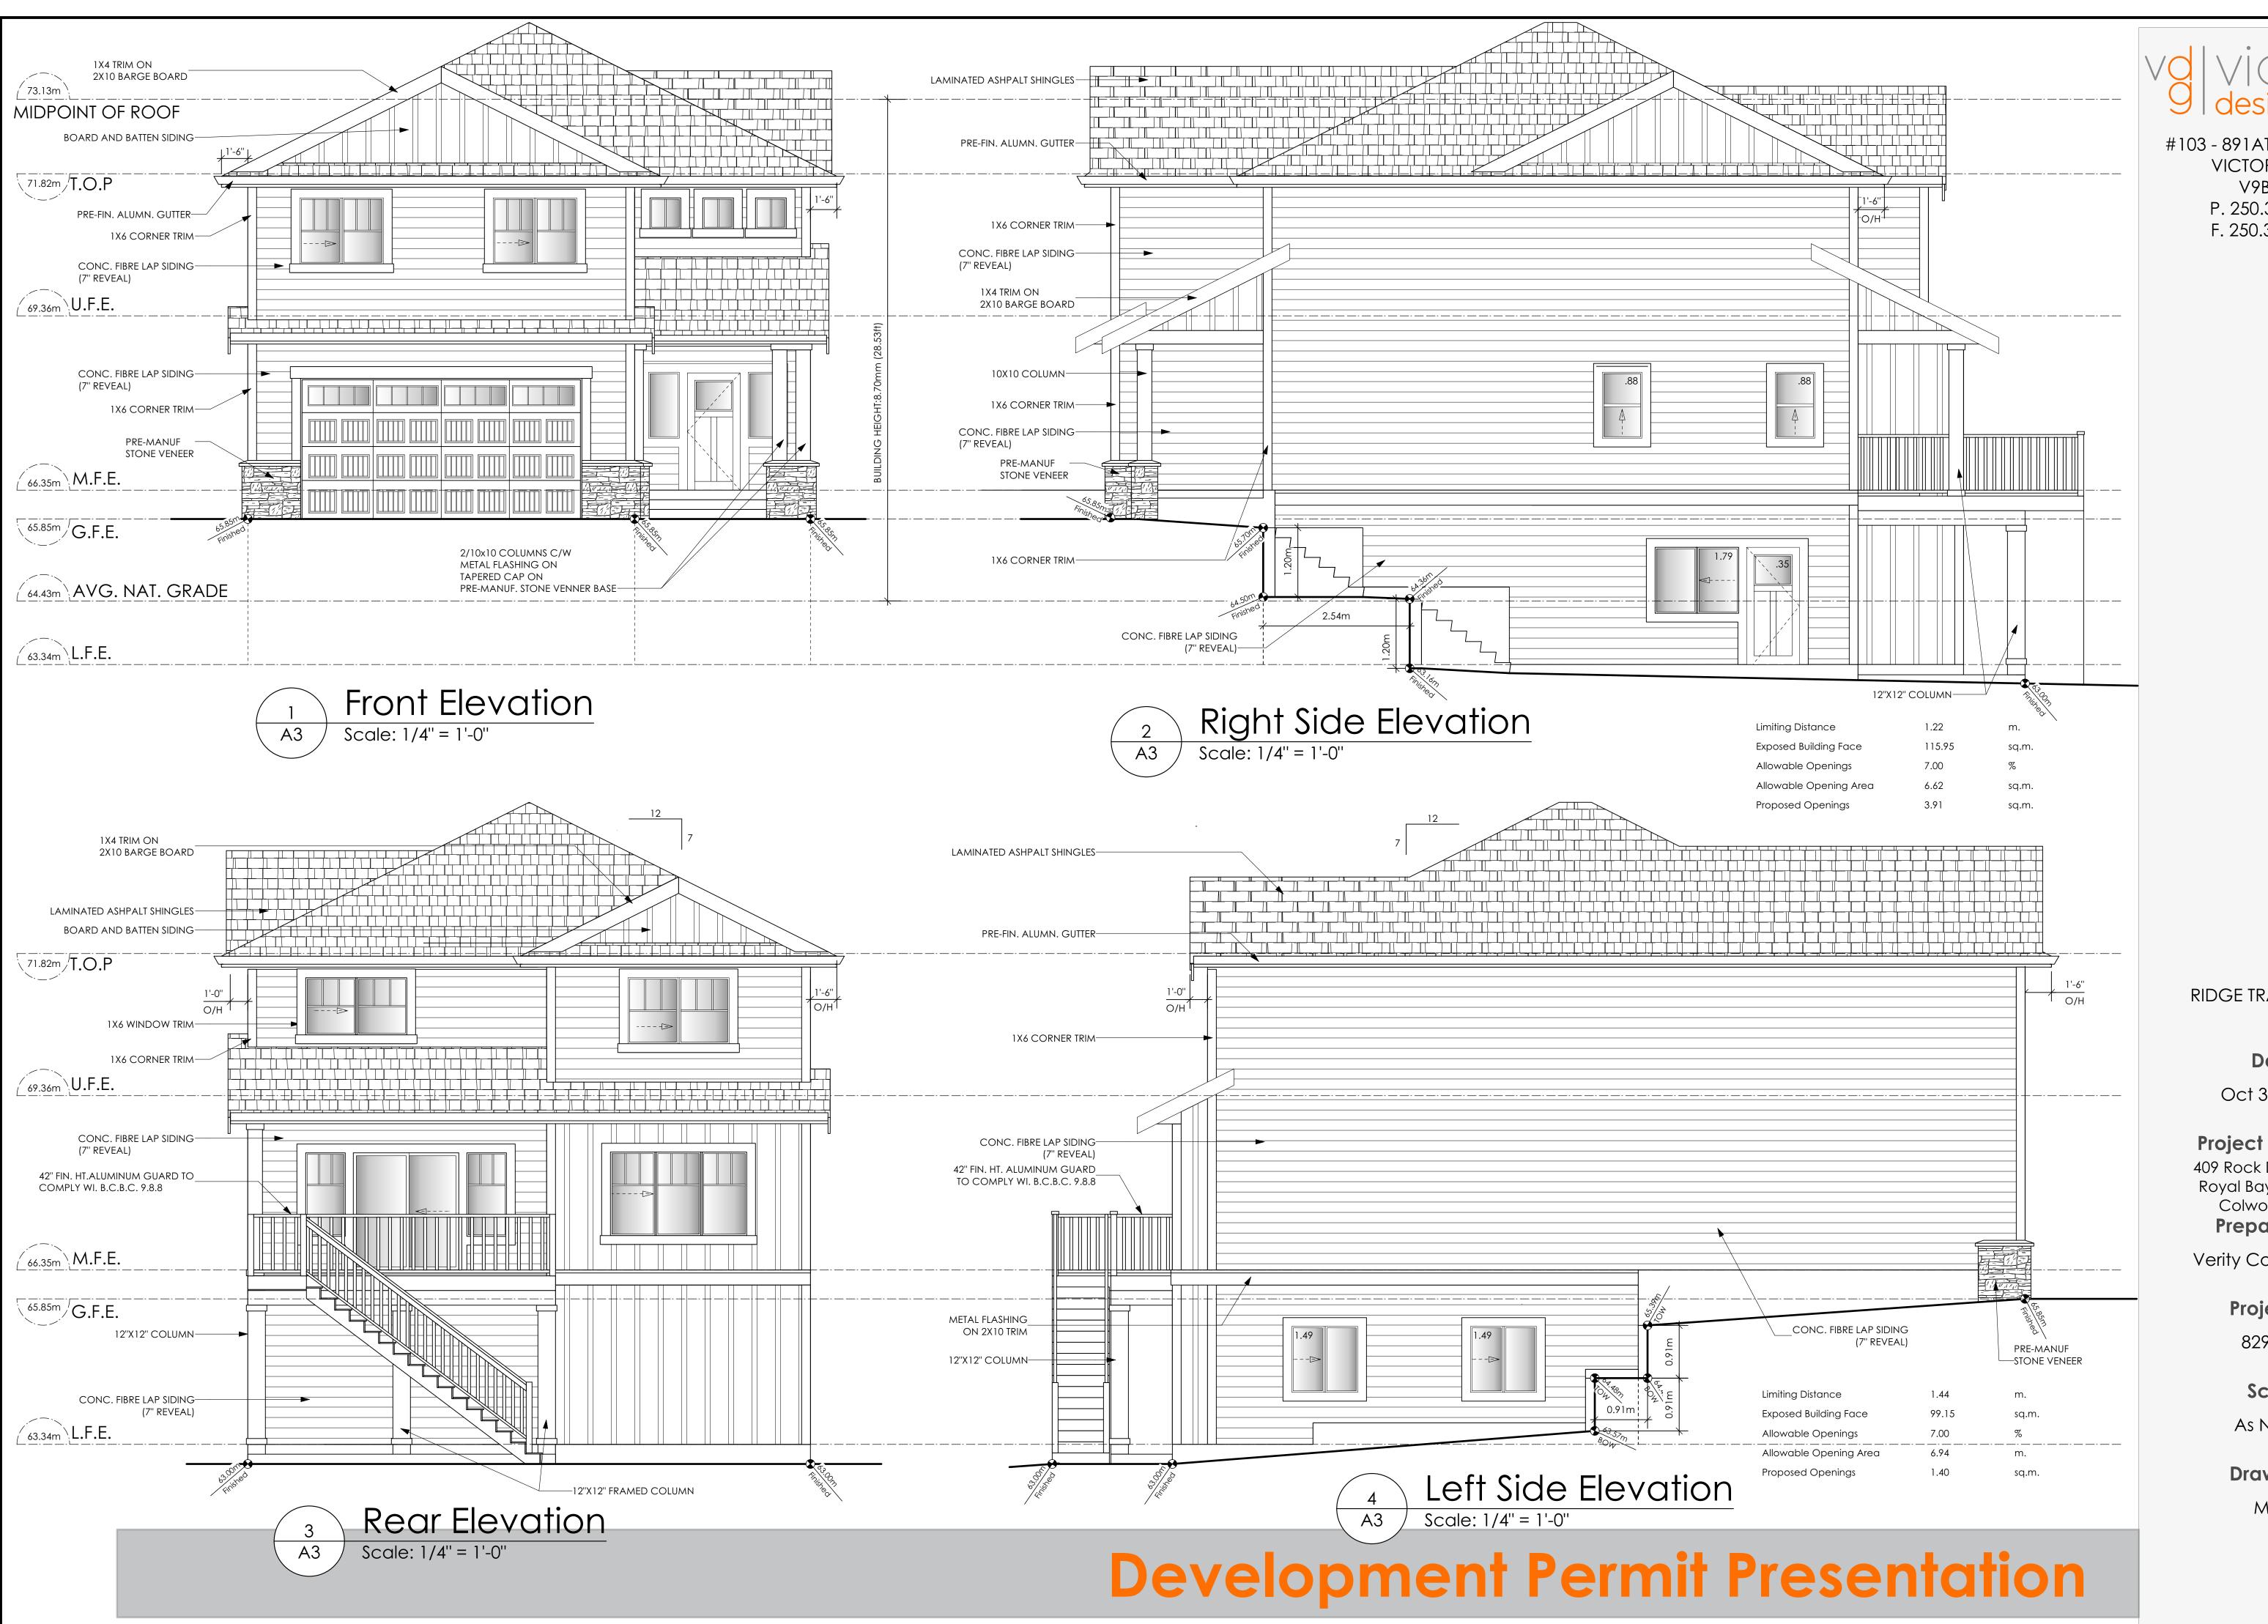

dictoria design group

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RIDGE TRADITIONAL

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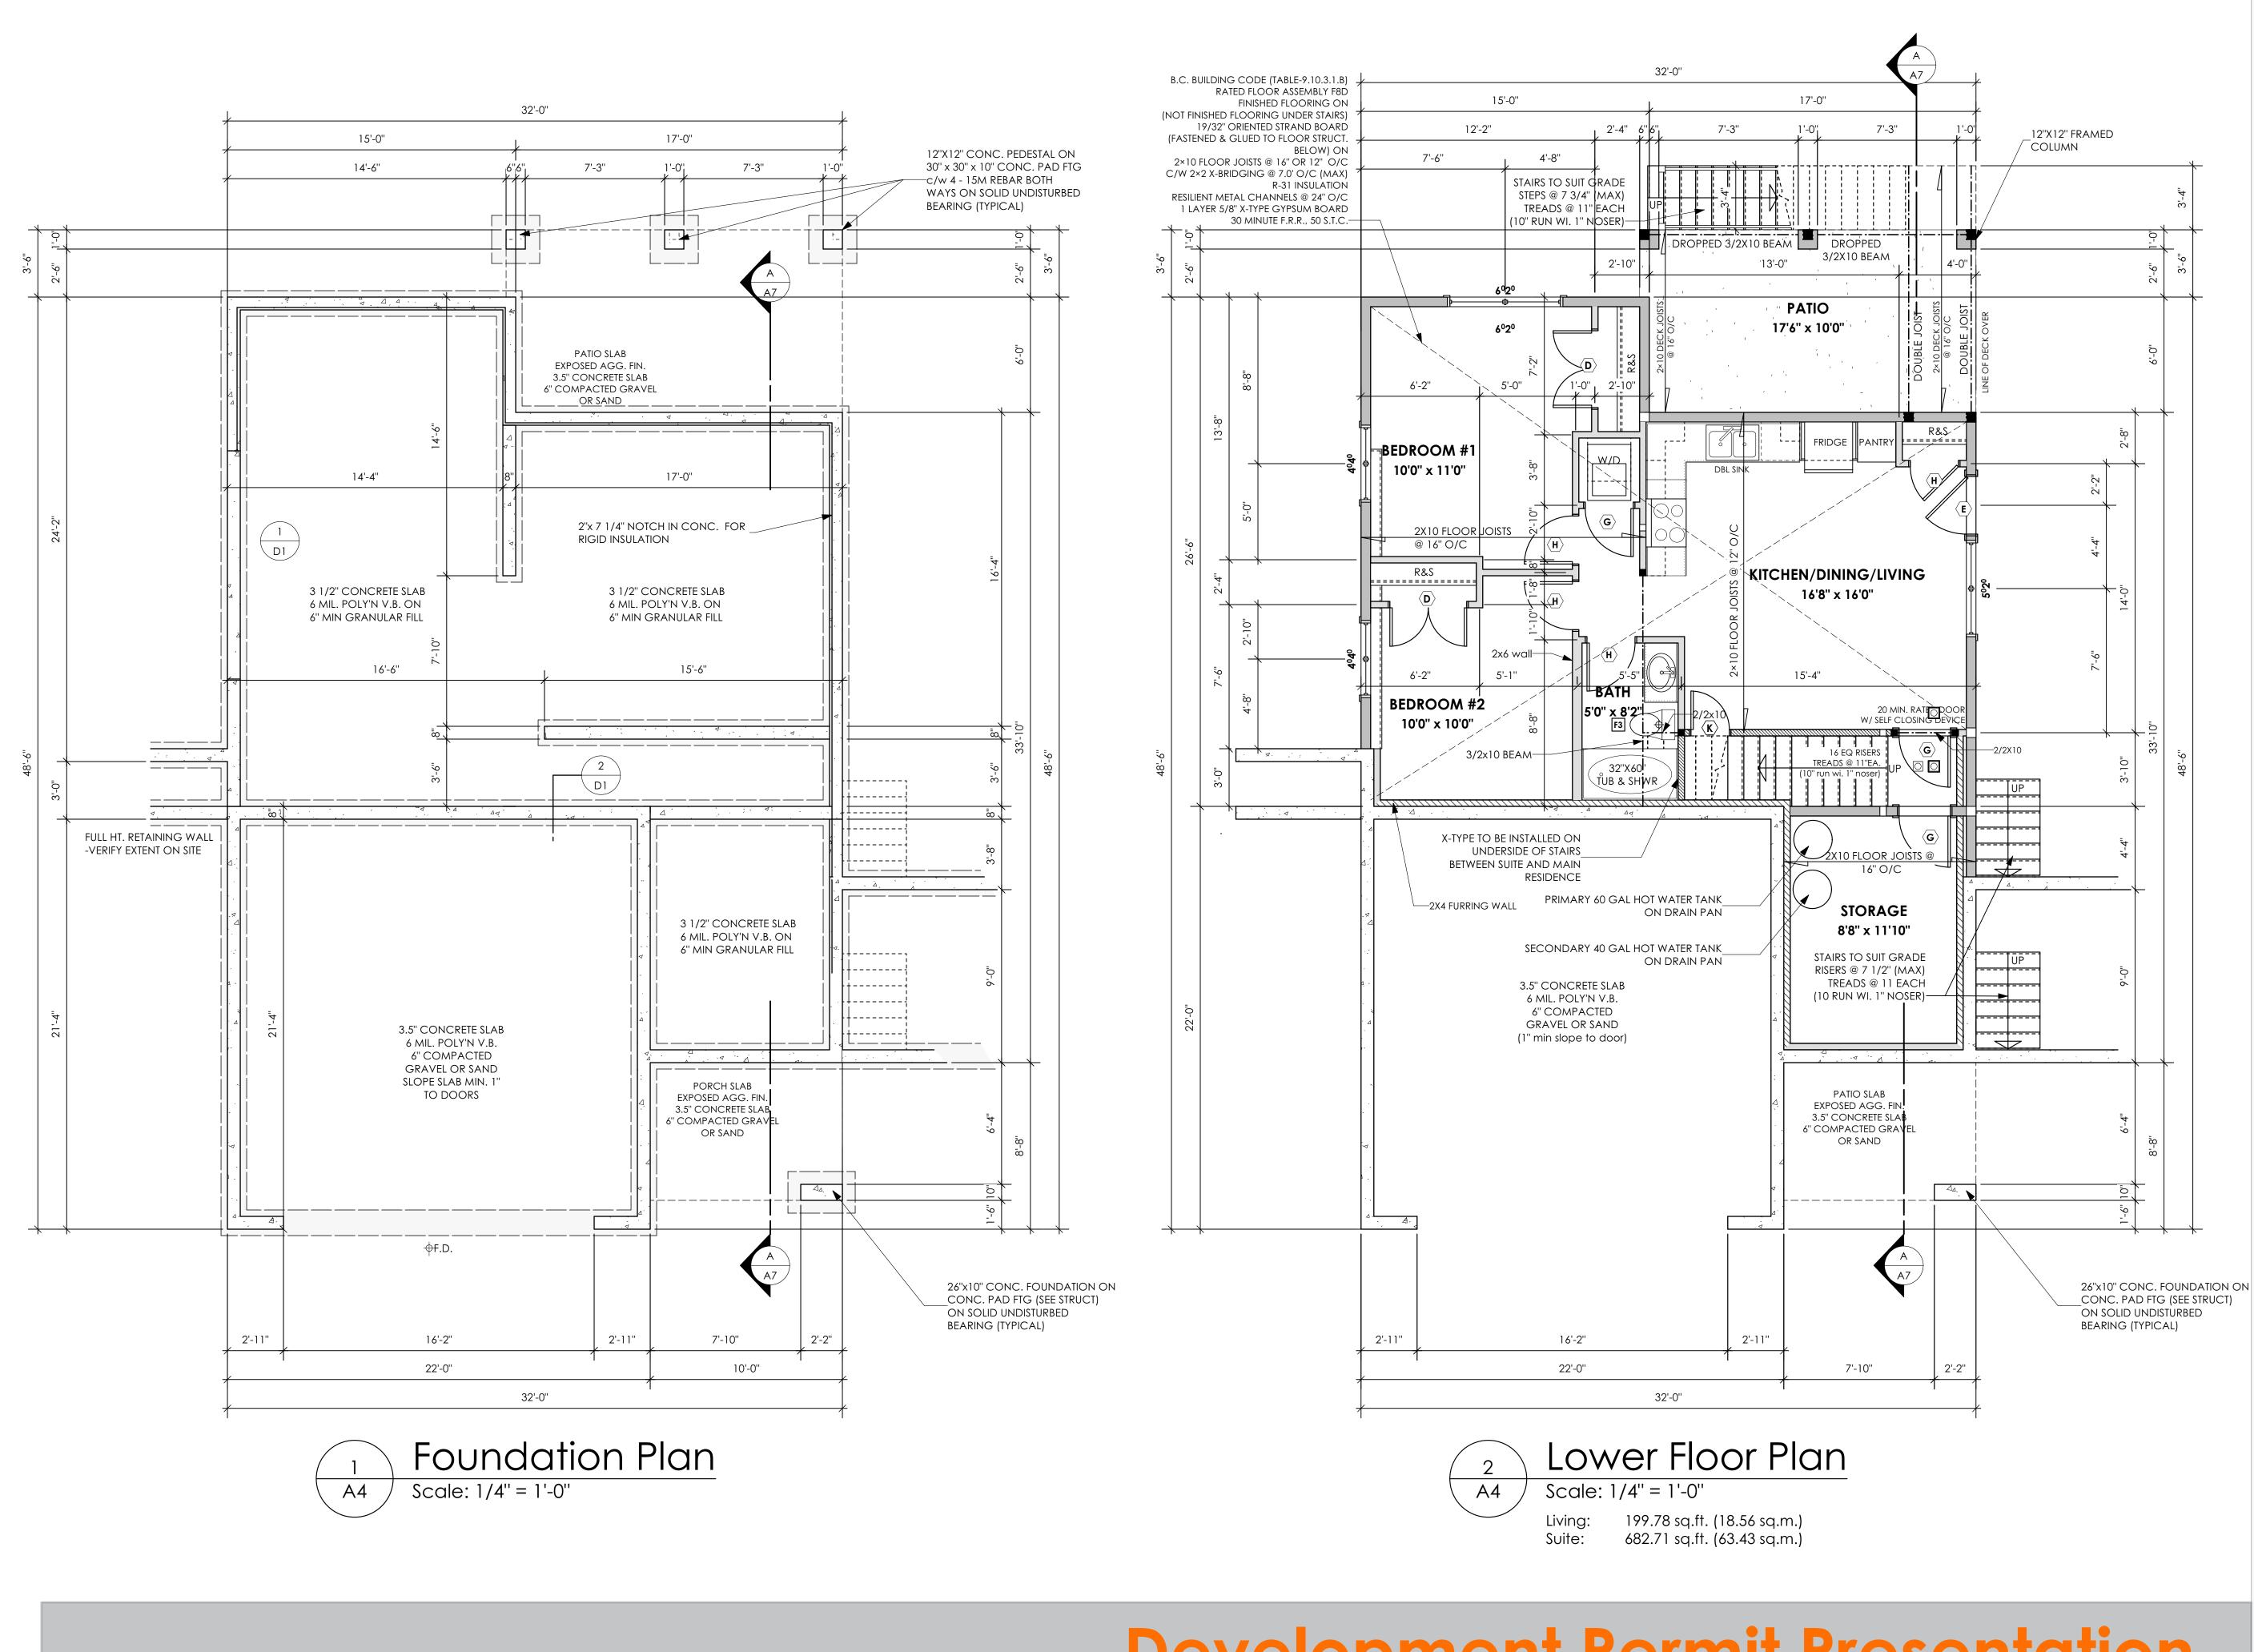
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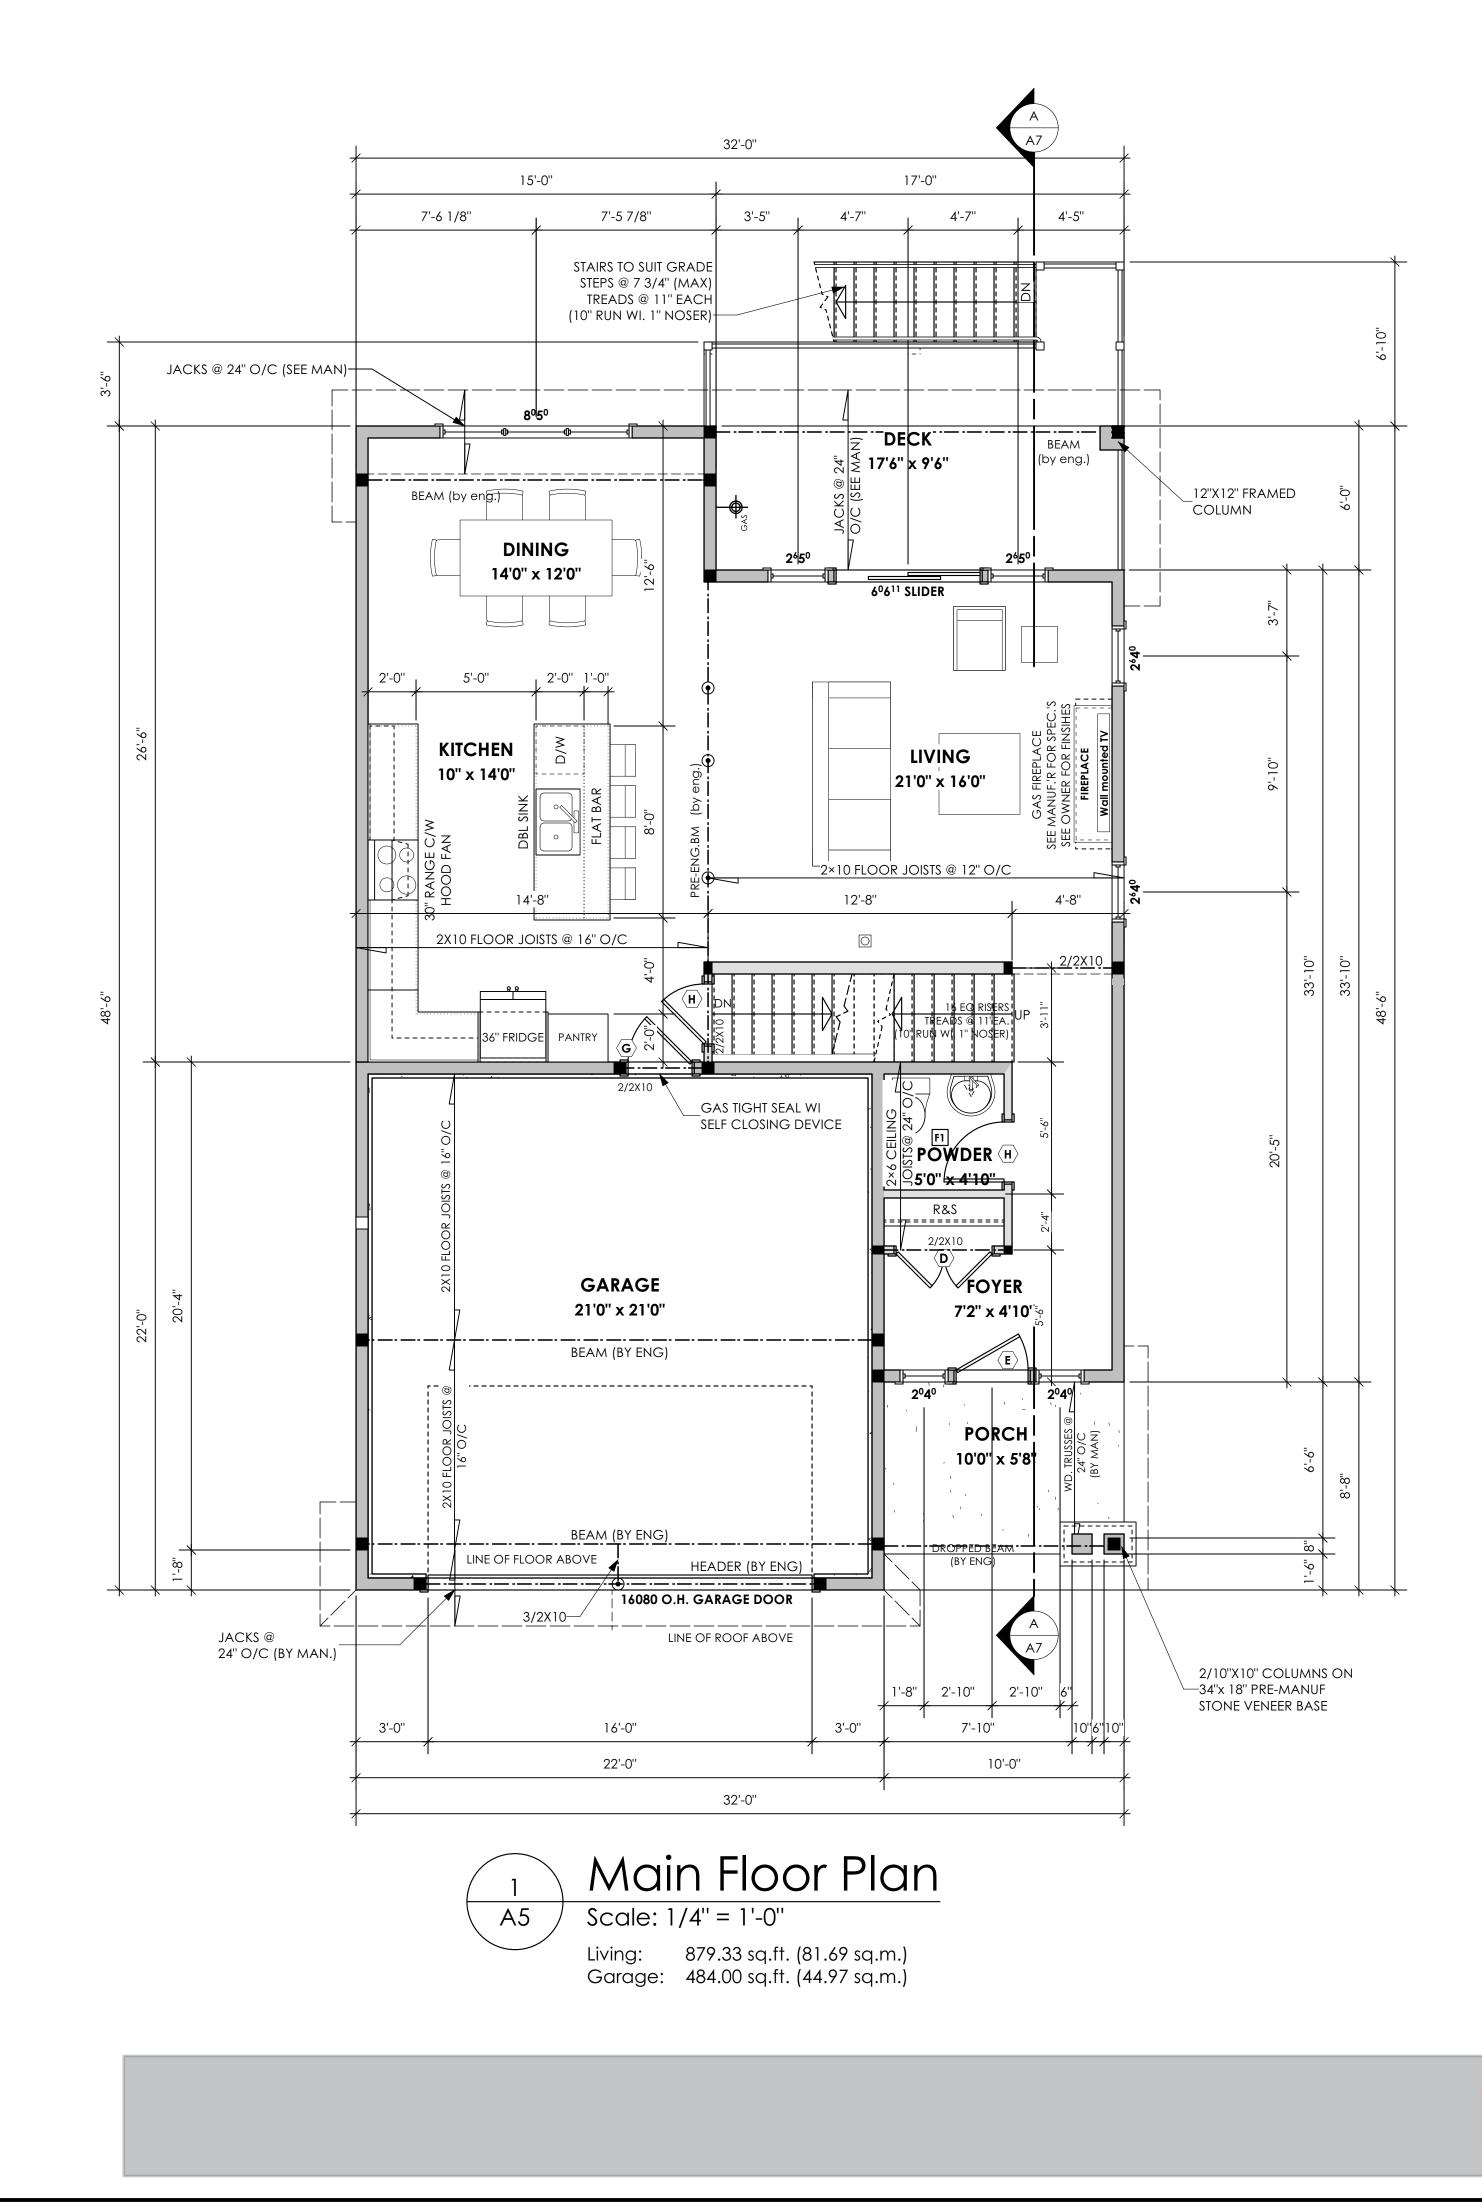
Project #


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Living: 1143.89 sq.ft. (106.27 sq.m.)



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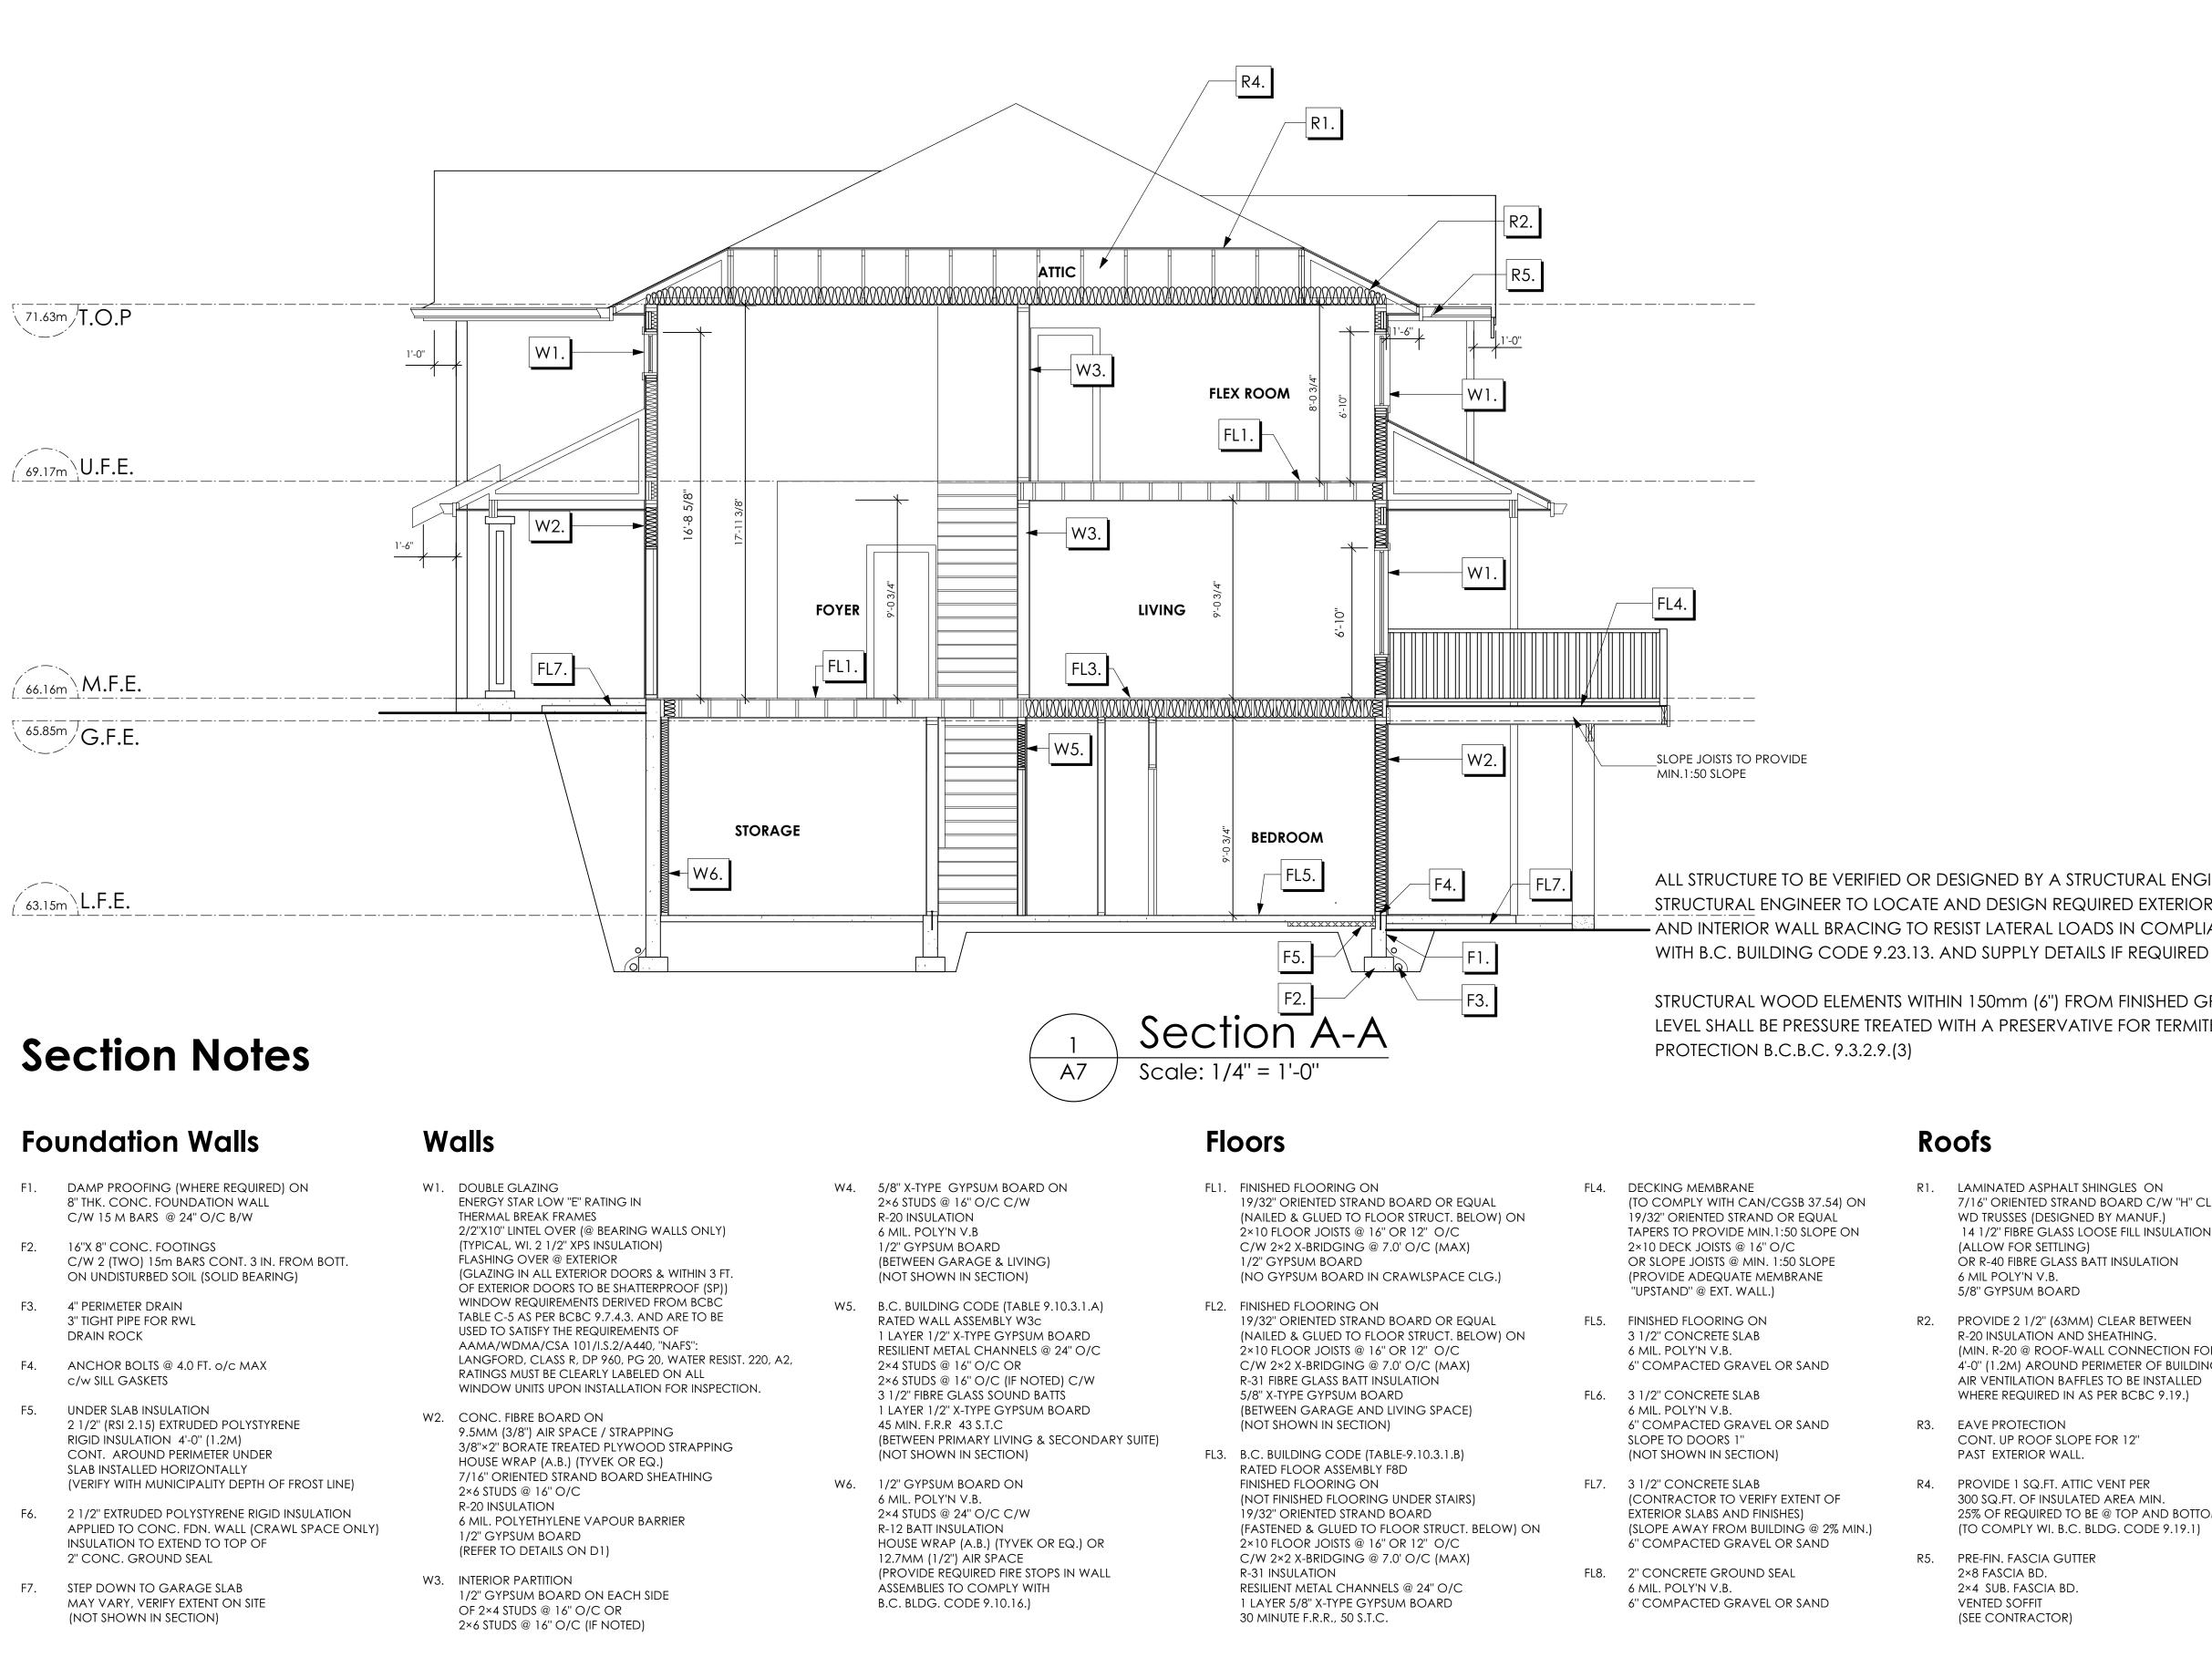
Project Address 409 Rock Dove Place Royal Bay - Sector 7 Colwood, B.C. **Prepared for**

Verity Construction

Project # 8298-75

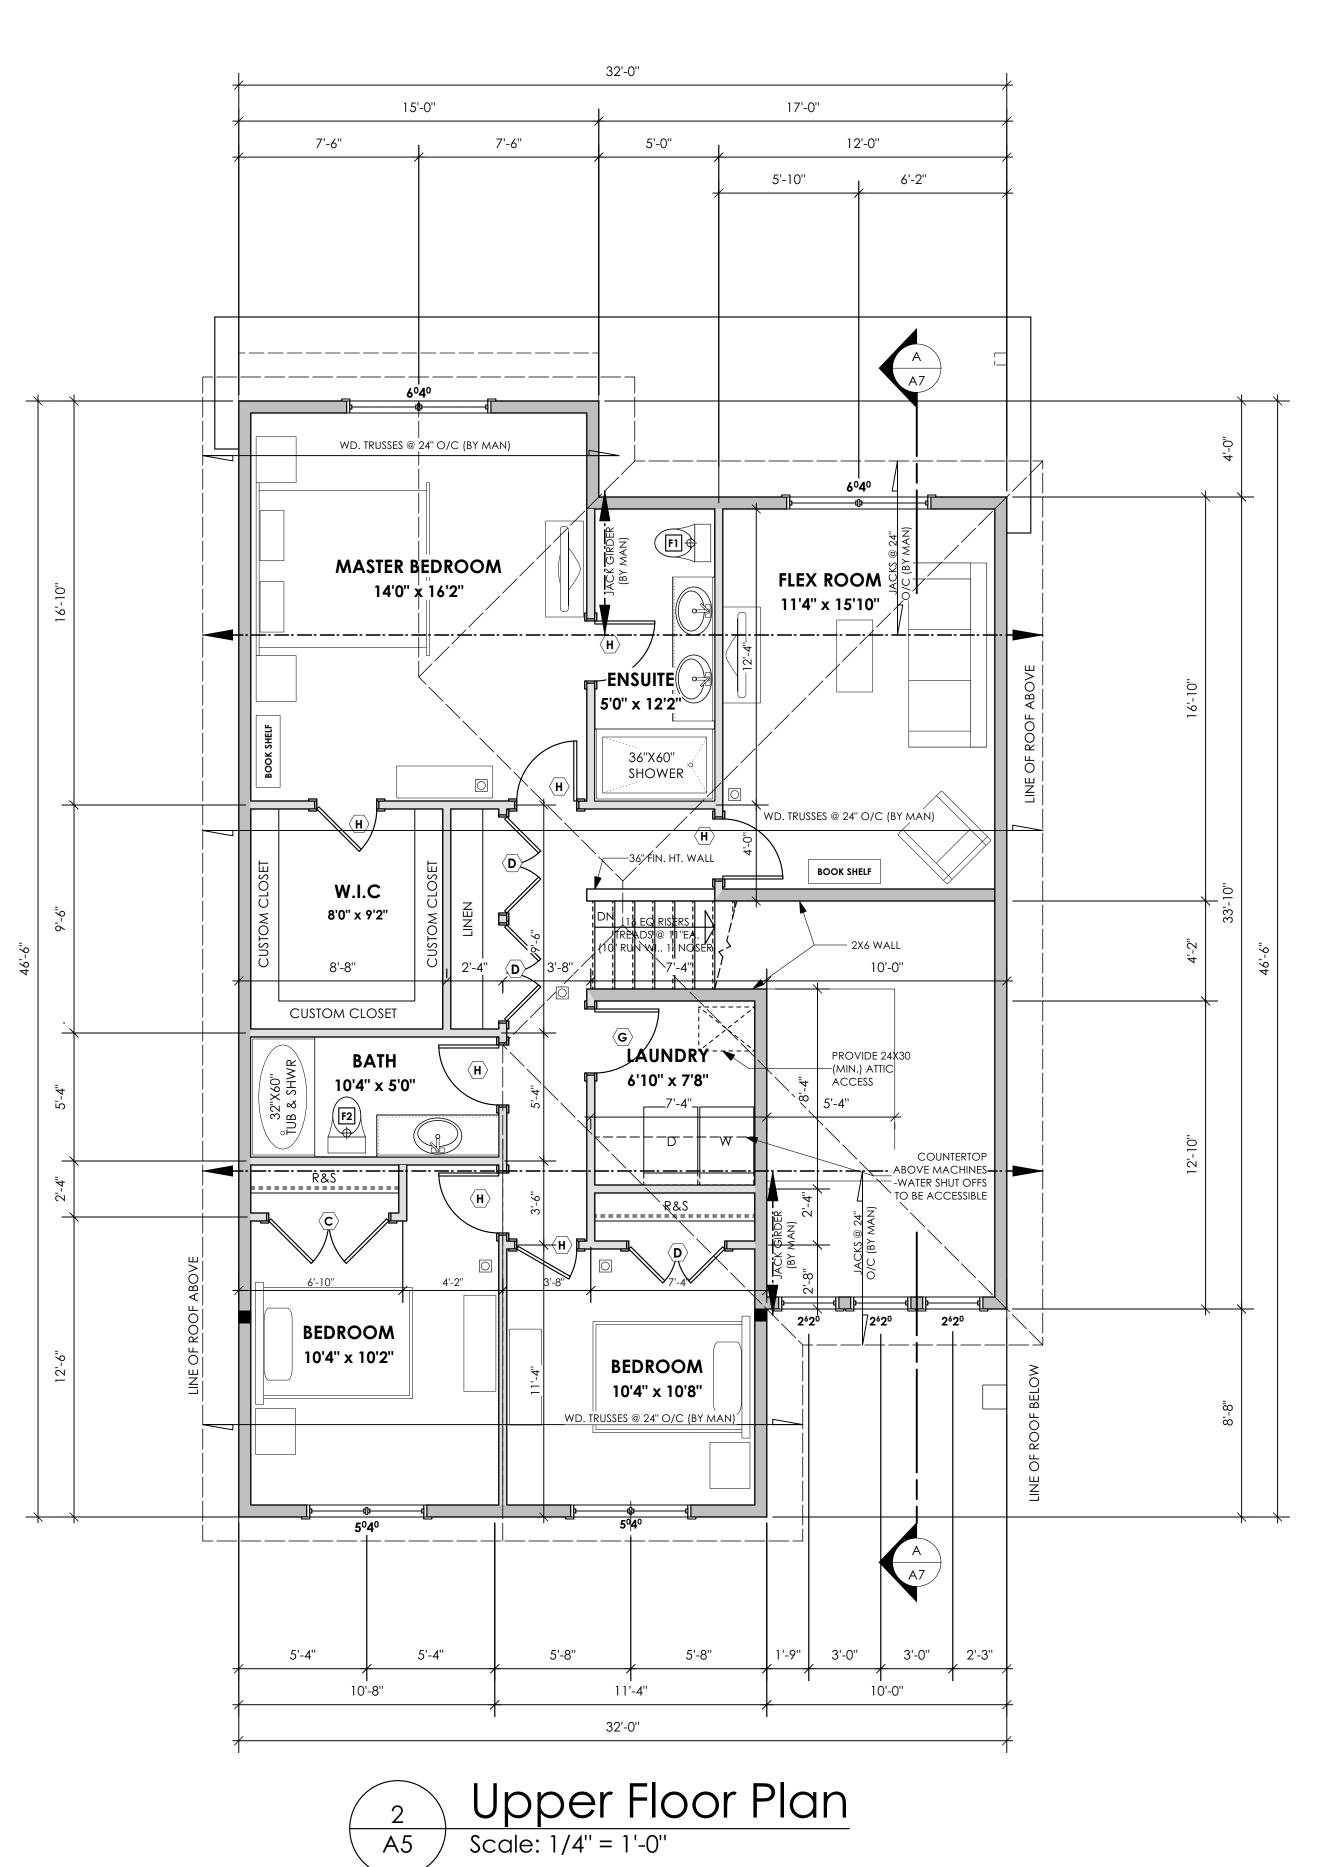Scale As Noted

Drawn By MDK



W1.	DOUBLE GLAZING ENERGY STAR LOW "E" RATING IN	W4.
	THERMAL BREAK FRAMES 2/2"X10" LINTEL OVER (@ BEARING WALLS ONLY) (TYPICAL, WI. 2 1/2" XPS INSULATION) FLASHING OVER @ EXTERIOR (GLAZING IN ALL EXTERIOR DOORS & WITHIN 3 FT. OF EXTERIOR DOORS TO BE SHATTERPROOF (SP)) WINDOW REQUIREMENTS DERIVED FROM BCBC TABLE C-5 AS PER BCBC 9.7.4.3. AND ARE TO BE USED TO SATISFY THE REQUIREMENTS OF AAMA/WDMA/CSA 101/I.S.2/A440, "NAFS": LANGFORD, CLASS R, DP 960, PG 20, WATER RESIST. 220, A2, RATINGS MUST BE CLEARLY LABELED ON ALL WINDOW UNITS UPON INSTALLATION FOR INSPECTION.	W5.
W2.	CONC. FIBRE BOARD ON 9.5MM (3/8") AIR SPACE / STRAPPING 3/8"×2" BORATE TREATED PLYWOOD STRAPPING HOUSE WRAP (A.B.) (TYVEK OR EQ.) 7/16" ORIENTED STRAND BOARD SHEATHING 2×6 STUDS @ 16" O/C R-20 INSULATION 6 MIL. POLYETHYLENE VAPOUR BARRIER 1/2" GYPSUM BOARD (REFER TO DETAILS ON D1)	W6.
W3.	INTERIOR PARTITION 1/2" GYPSUM BOARD ON EACH SIDE OF 2×4 STUDS @ 16" O/C OR	



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ALL STRUCTURE TO BE VERIFIED OR DESIGNED BY A STRUCTURAL ENGINEER. - AND INTERIOR WALL BRACING TO RESIST LATERAL LOADS IN COMPLIANCE

STRUCTURAL WOOD ELEMENTS WITHIN 150mm (6") FROM FINISHED GROUND LEVEL SHALL BE PRESSURE TREATED WITH A PRESERVATIVE FOR TERMITE AND DECAY

Roofs

- R1. LAMINATED ASPHALT SHINGLES ON 7/16" ORIENTED STRAND BOARD C/W "H" CLIPS WD TRUSSES (DESIGNED BY MANUF.) 14 1/2" FIBRE GLASS LOOSE FILL INSULATION (ALLOW FOR SETTLING) OR R-40 FIBRE GLASS BATT INSULATION 6 MIL POLY'N V.B. 5/8" GYPSUM BOARD
- R2. PROVIDE 2 1/2" (63MM) CLEAR BETWEEN R-20 INSULATION AND SHEATHING. (MIN. R-20 @ ROOF-WALL CONNECTION FOR 4'-0" (1.2M) AROUND PERIMETER OF BUILDING. AIR VENTILATION BAFFLES TO BE INSTALLED WHERE REQUIRED IN AS PER BCBC 9.19.)
- R3. EAVE PROTECTION CONT. UP ROOF SLOPE FOR 12" PAST EXTERIOR WALL.
- R4. PROVIDE 1 SQ.FT. ATTIC VENT PER 300 SQ.FT. OF INSULATED AREA MIN. 25% OF REQUIRED TO BE @ TOP AND BOTTOM (TO COMPLY WI. B.C. BLDG. CODE 9.19.1)
- R5. PRE-FIN. FASCIA GUTTER 2×8 FASCIA BD. 2×4 SUB. FASCIA BD. VENTED SOFFIT (SEE CONTRACTOR)

RIDGE TRADITIONAL

Date Oct 31, 2023


Project Address 409 Rock Dove Place Royal Bay - Sector 7 Colwood, B.C. Prepared for

Verity Construction

Project # 8298-75

Scale As Noted

Drawn By MDK

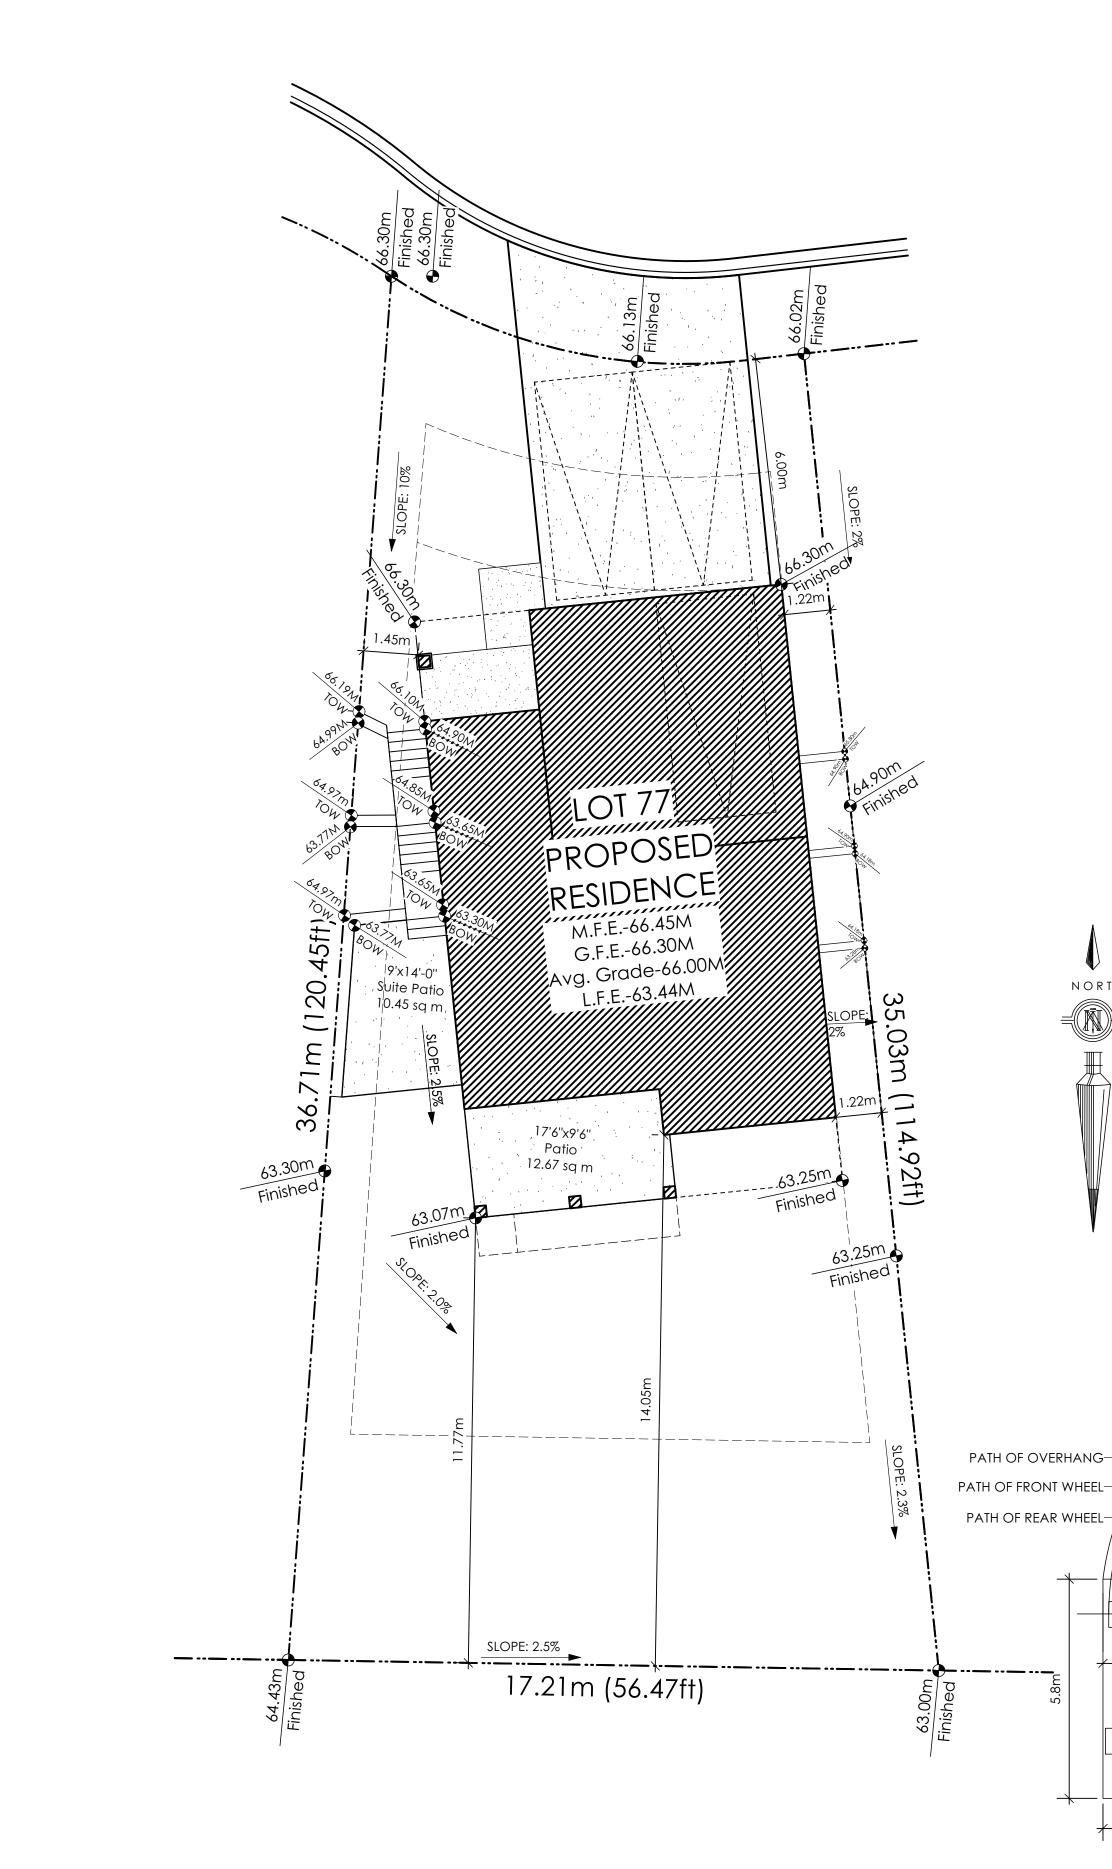

SITE DATA	RBCD5	LOT 77
ITEMS	PERMITTED	PROPOSED
LOT AREA	550 sq.m.	493.90 sq.m.
LOT COVERAGE	50.00 %	30.04 %
BUILDING HEIGHT	9.50 m.	8.50 m.
LOT WIDTH	16.50 m.	12.94 m.
SETBACKS		
- FRONT	4.50 m.	7.42 m.
- FRONT (GARAGE)	6.00 m.	7.42 m.
- REAR	6.00 m.	6.12 m.
- SIDE	1.20 m.	1.45 m.
- SIDE	1.20 m.	1.22 m.
PROPOSED FLOOR AREA		
- UPPER		106.27 sq.m.
- MAIN		78.91 sq.m.
- LOWER		78.91 sq.m.
- GARAGE		44.97 sq.m.
SUB-TOTAL G.F.A.		309.06 sq.m.
GARAGE ALLOWANCE	50.00 sq.m.	-44.97 sq.m.
GROSS FLOOR AREA		264.09 sq.m.
F.A.R.		0.53 TO 1.0
SECONDARY SUITE		
FLOOR AREA (%)	40.00 %	22.85 %
FLOOR AREA (SQ.M.)	90.00 sq.m.	60.35 sq.m.


AVERAGE NATURAL GRADE CALCULATION 66.30 m. + 66.30m. + 63.15 m. + 63.07 m. = 258.82 m. divided by 4 = ave. grade 64.71m.


SEE LANDSCAPING PLAN FOR TREE SCHEDULE


RETAINING WALLS


XX.Xm = DESIGNER APPROXIMATE HEIGHT MEASUREMENT, VERIFY ON SITE - TO BE CERTIFIED BY AN ENGINEER AND MEET BCBC REQUIREMENTS FOR EARTHQUAKE DESIGN (REFER TO STRUCTURAL DRAWINGS) - ALL LANDSCAPE RETAINING WALLS TO HAVE A 1.2m MAX. EXPOSED HT


OR A MAX. 1:1 RATIO OF HEIGHT TO HORIZONTAL SEPARATION IF TERRACED

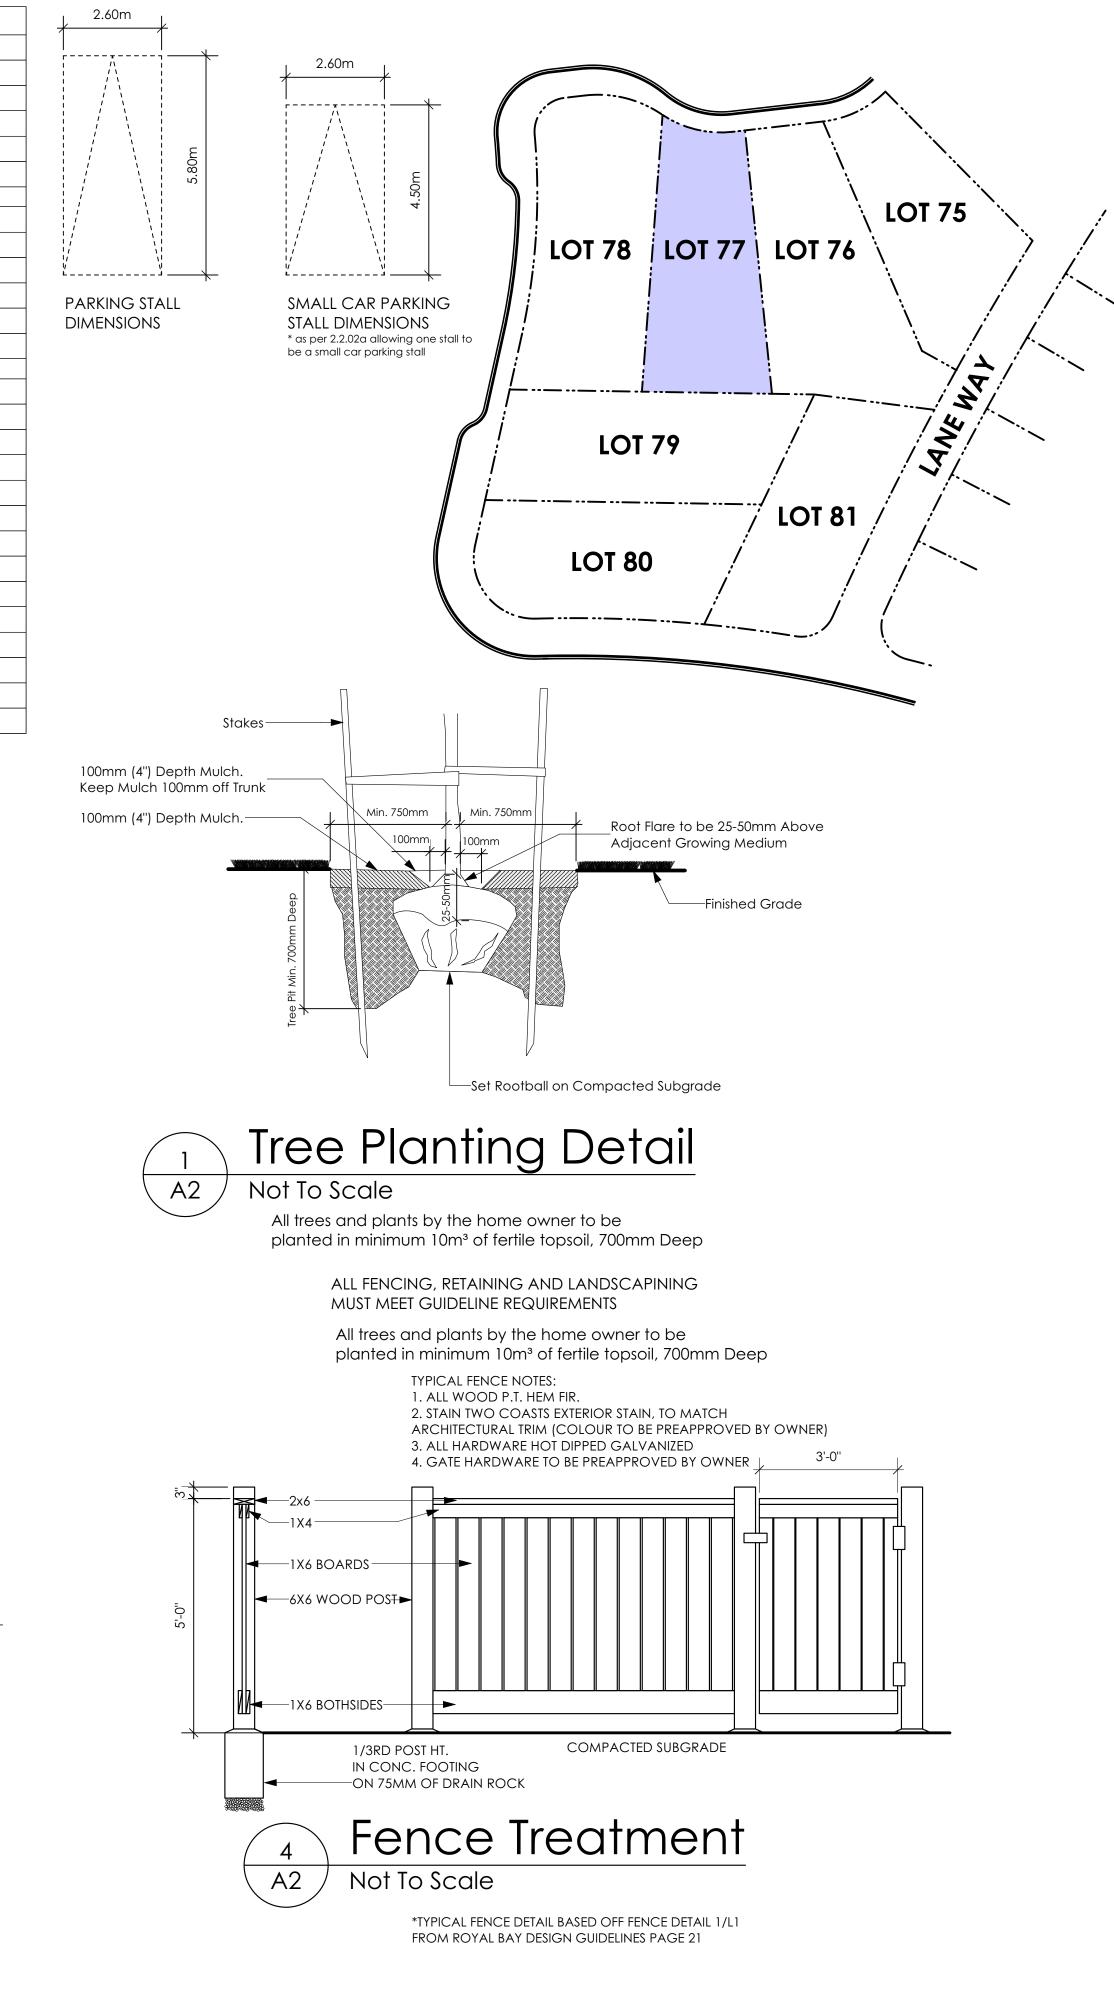

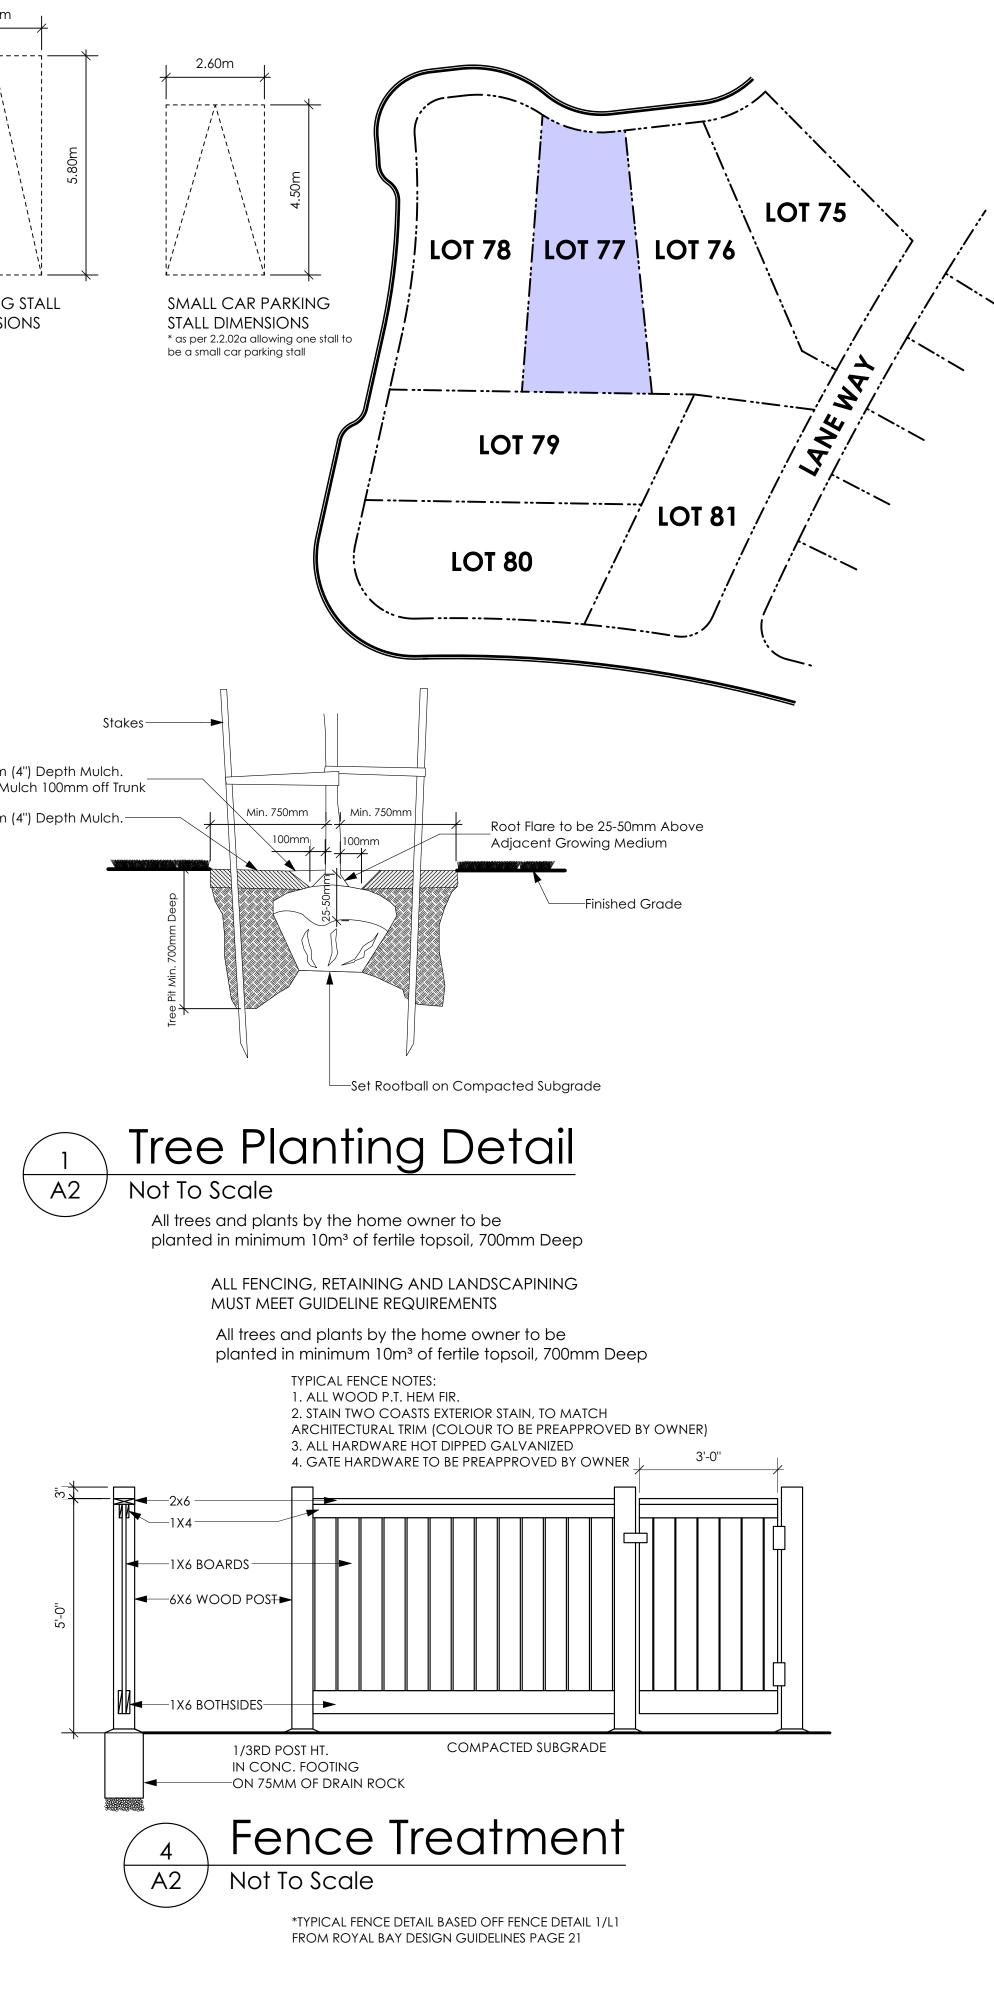

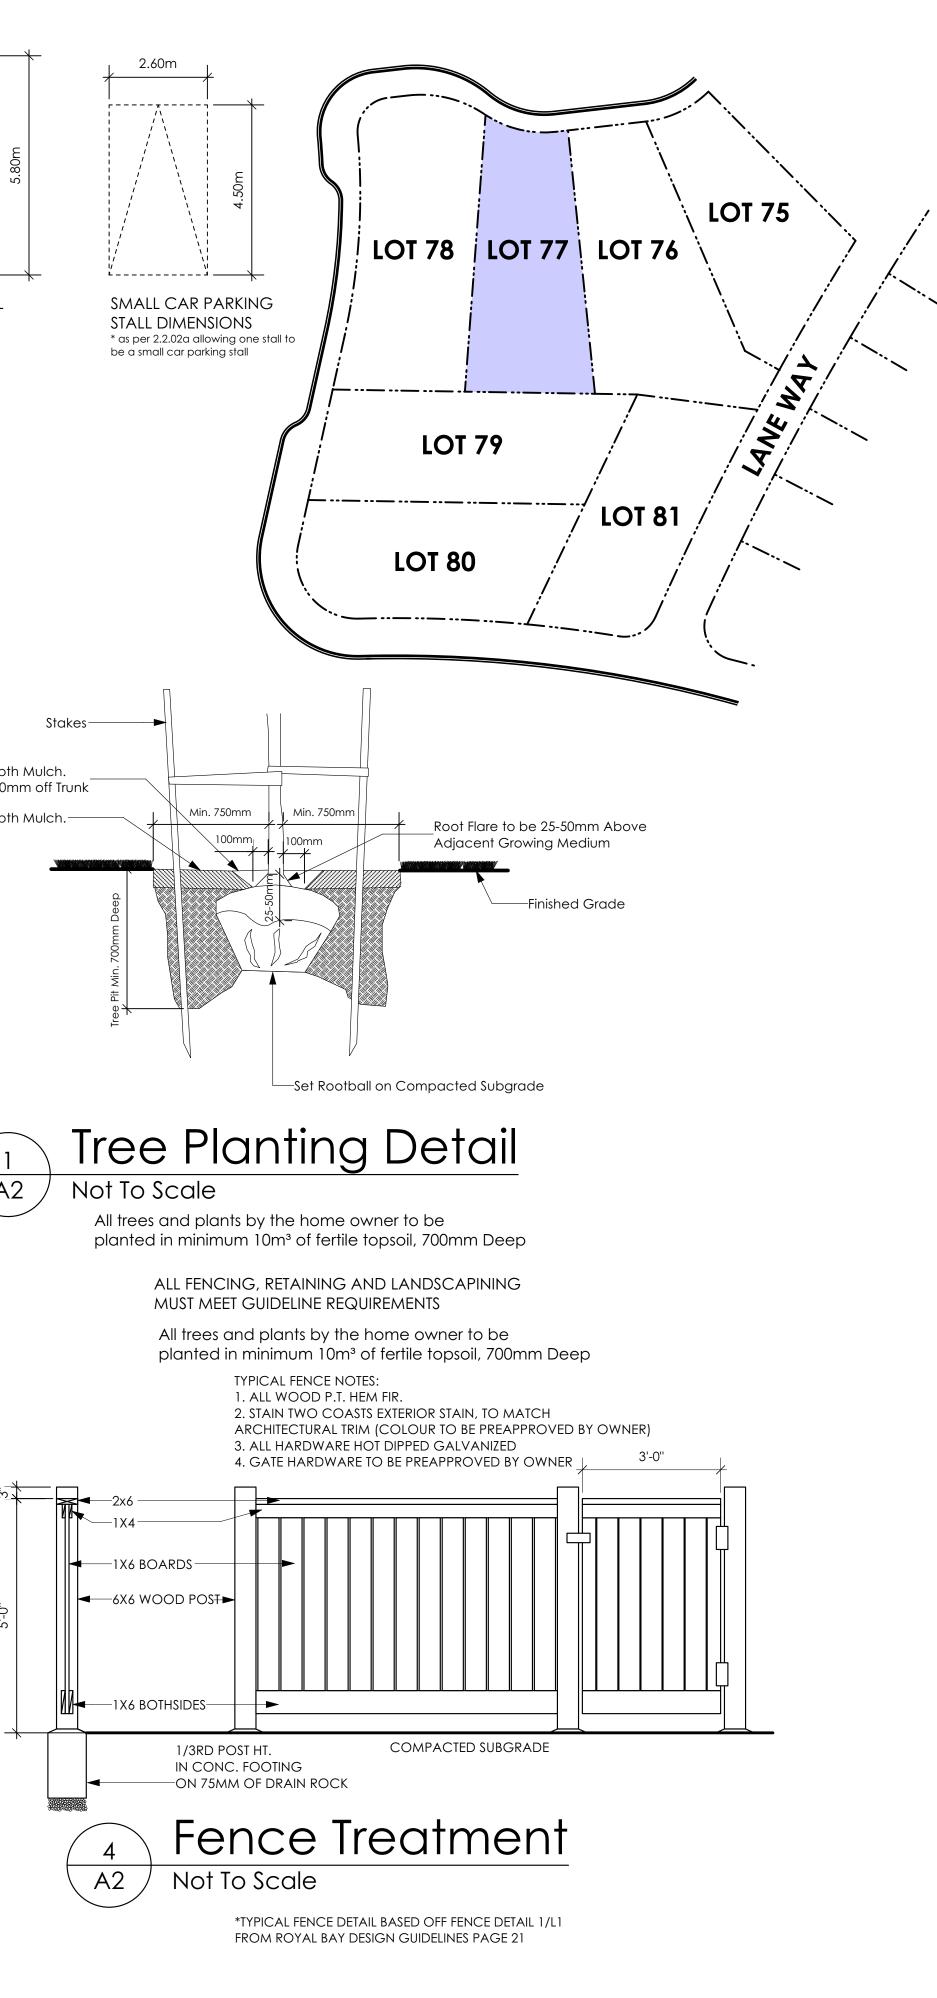

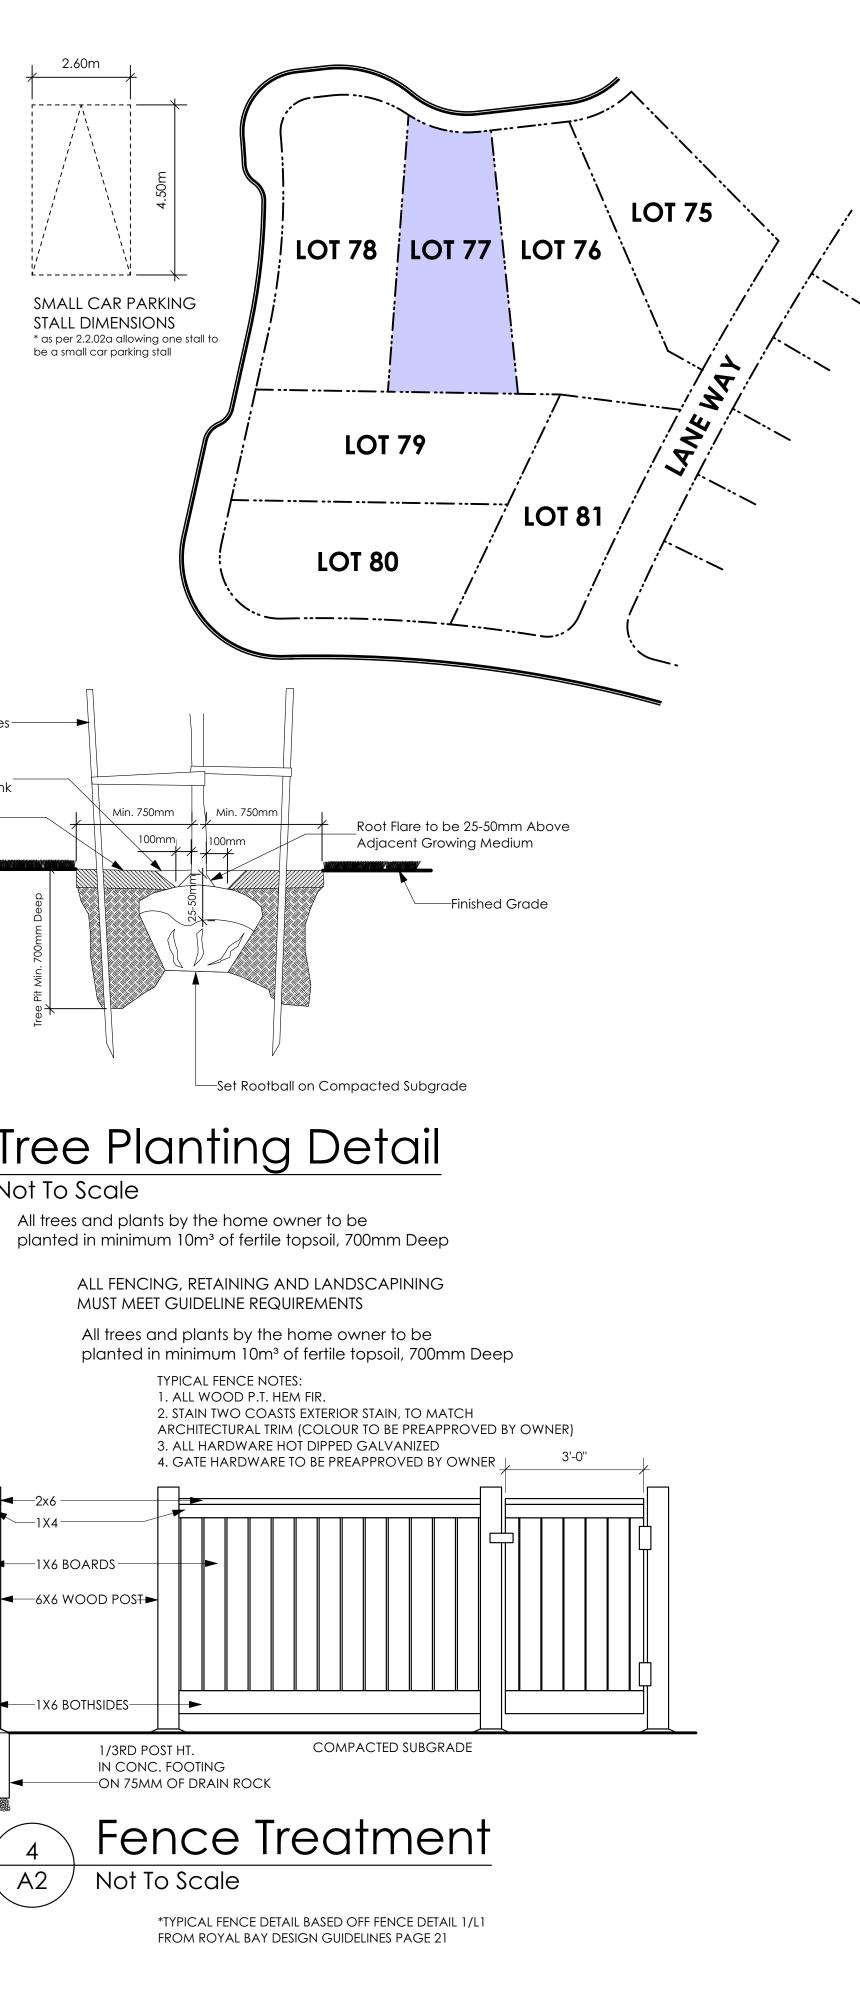

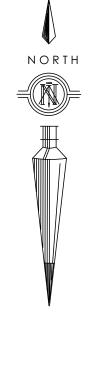



2.13m


Not To Scale

3

 $\sqrt{A2}$ /

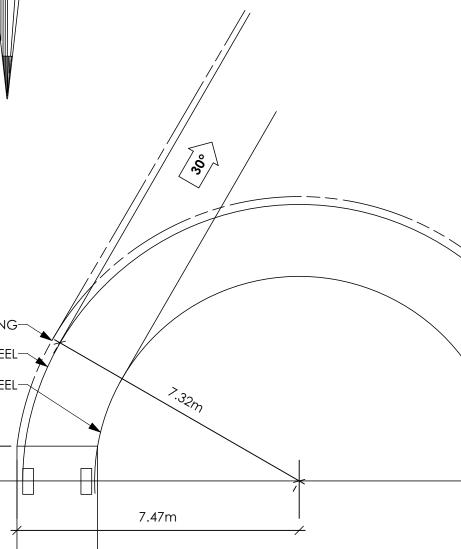

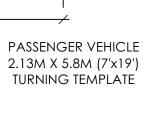

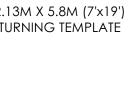





Development Permit Presentation



#103 - 891ATTREE AVENUE VICTORIA, B.C. V9B 0A6 P. 250.382.7374 F. 250.382.7364

RIDGE WESTCOAST

Date Nov 17, 2023


Project Address 417 Rock Dove Place Royal Bay - Sector 7 Colwood, B.C. Prepared for


Verity Construction

Project # 8298-77

Scale As Noted

Drawn By MDK

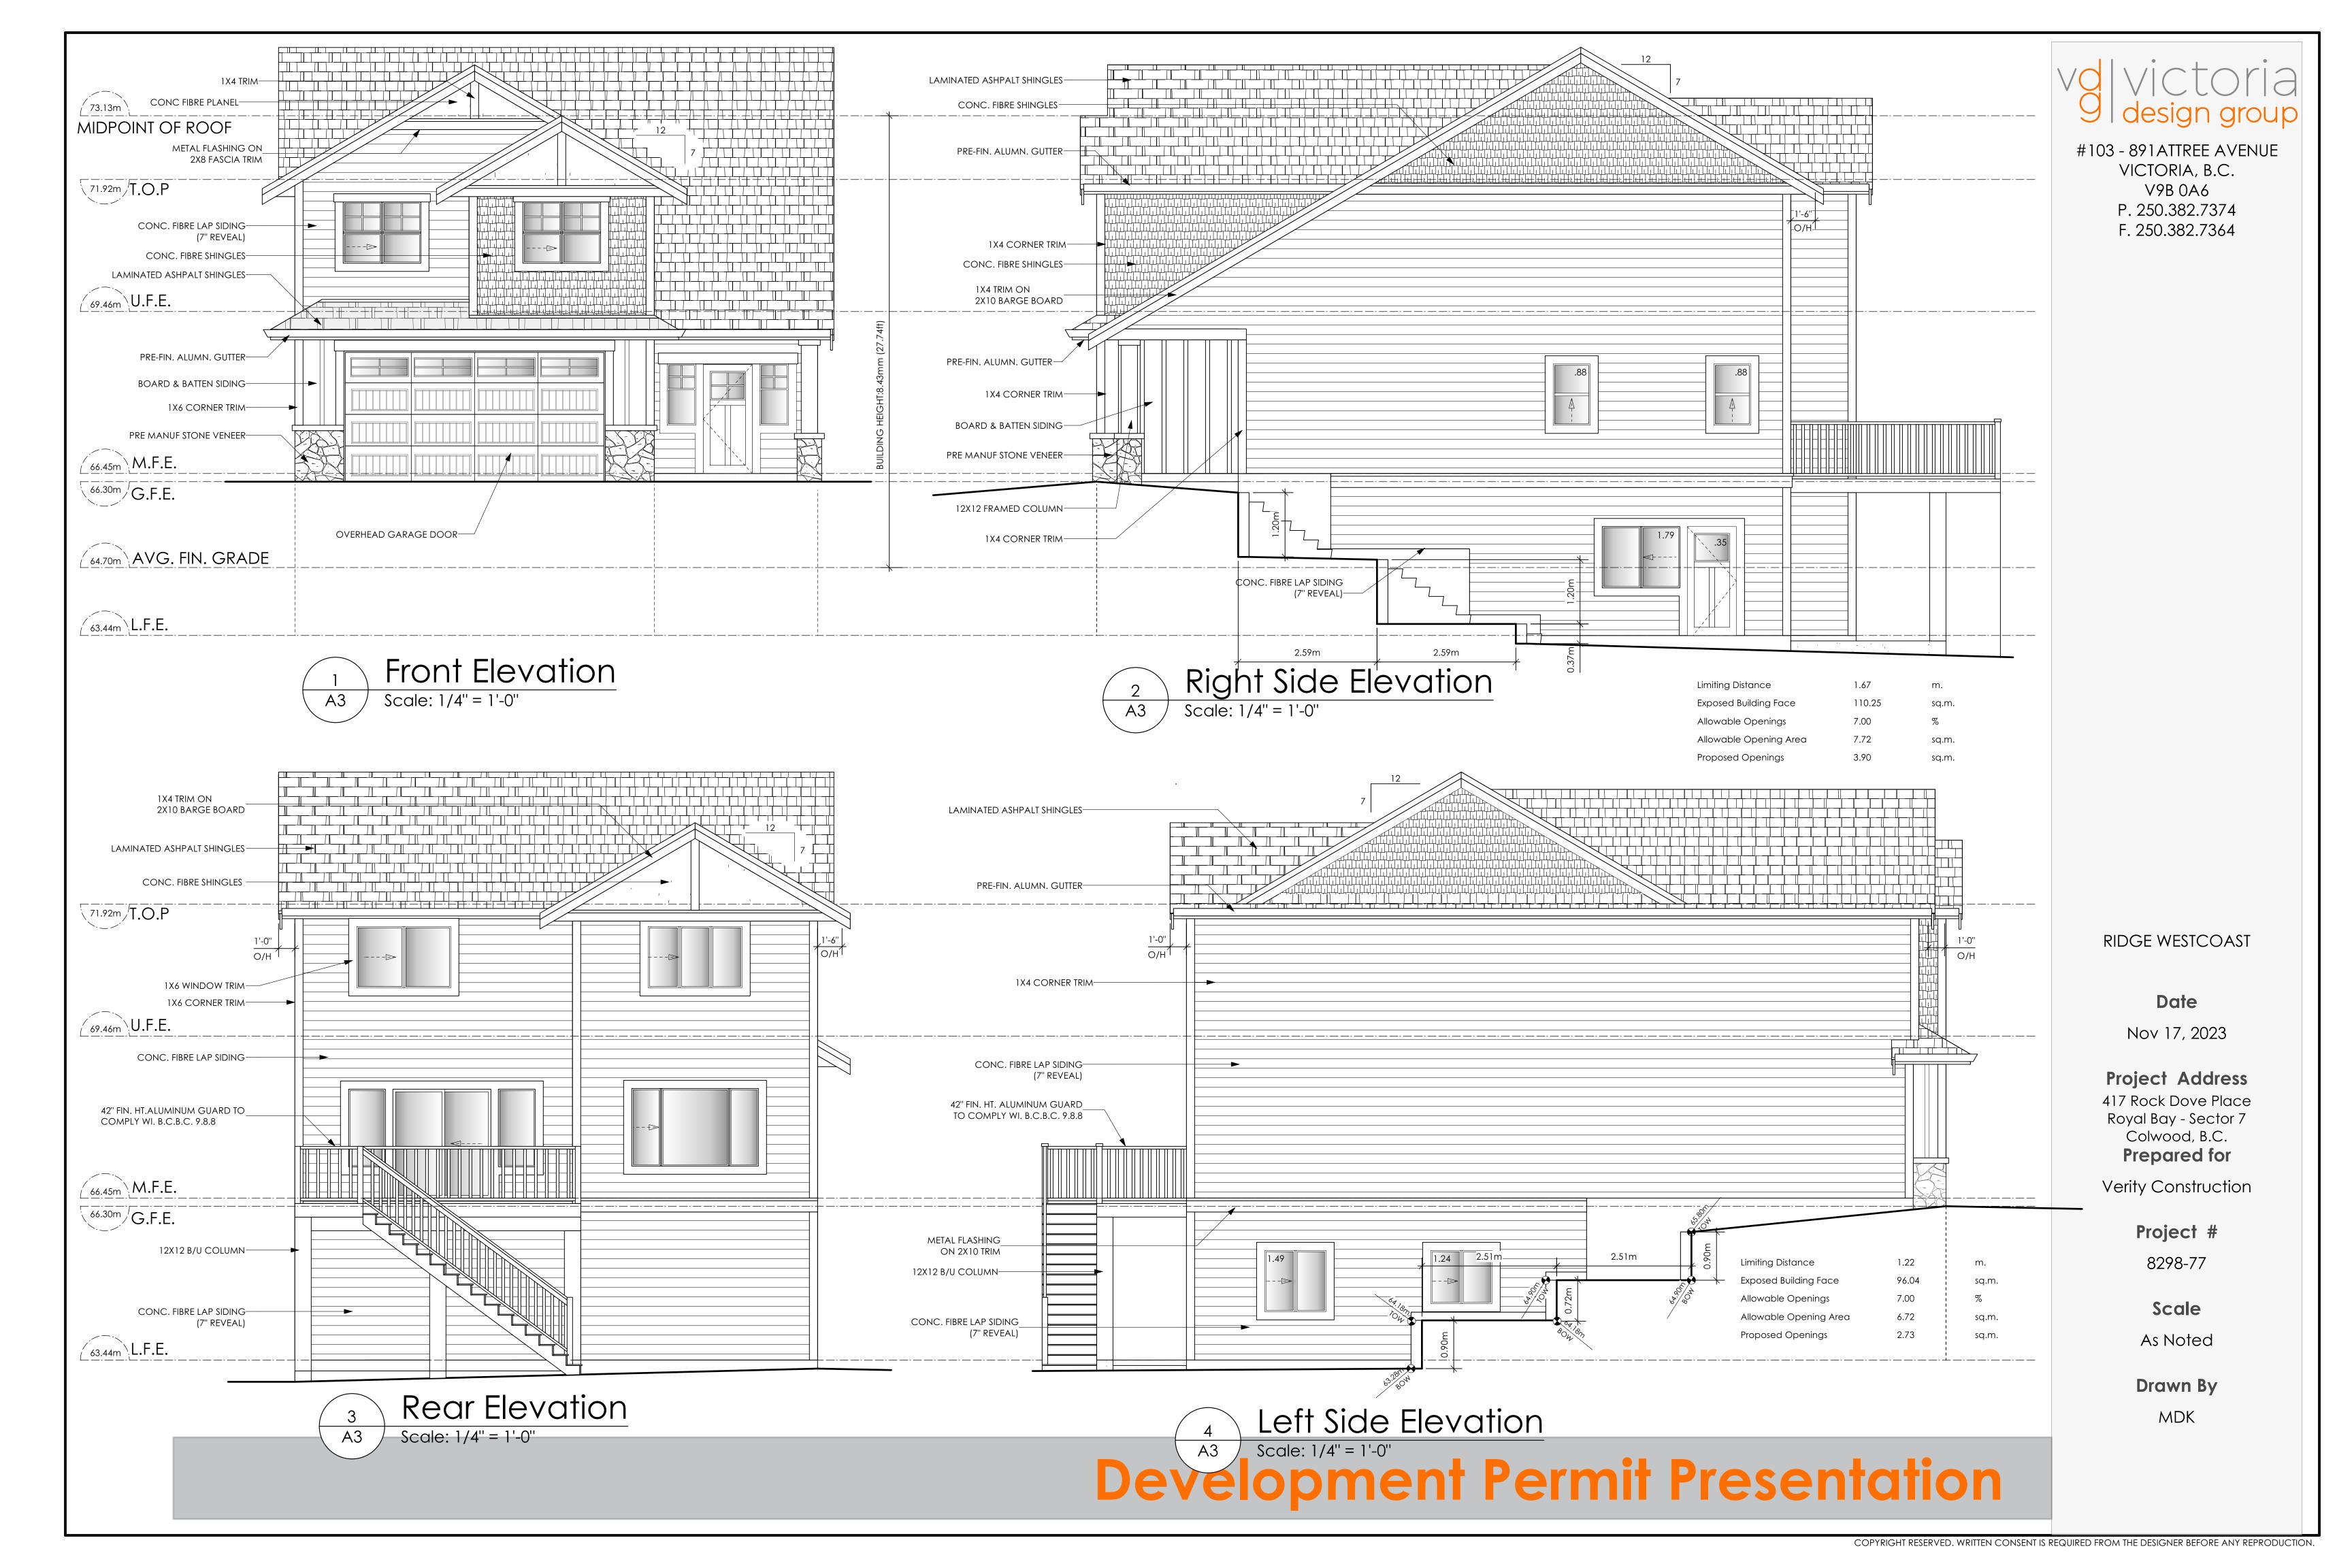

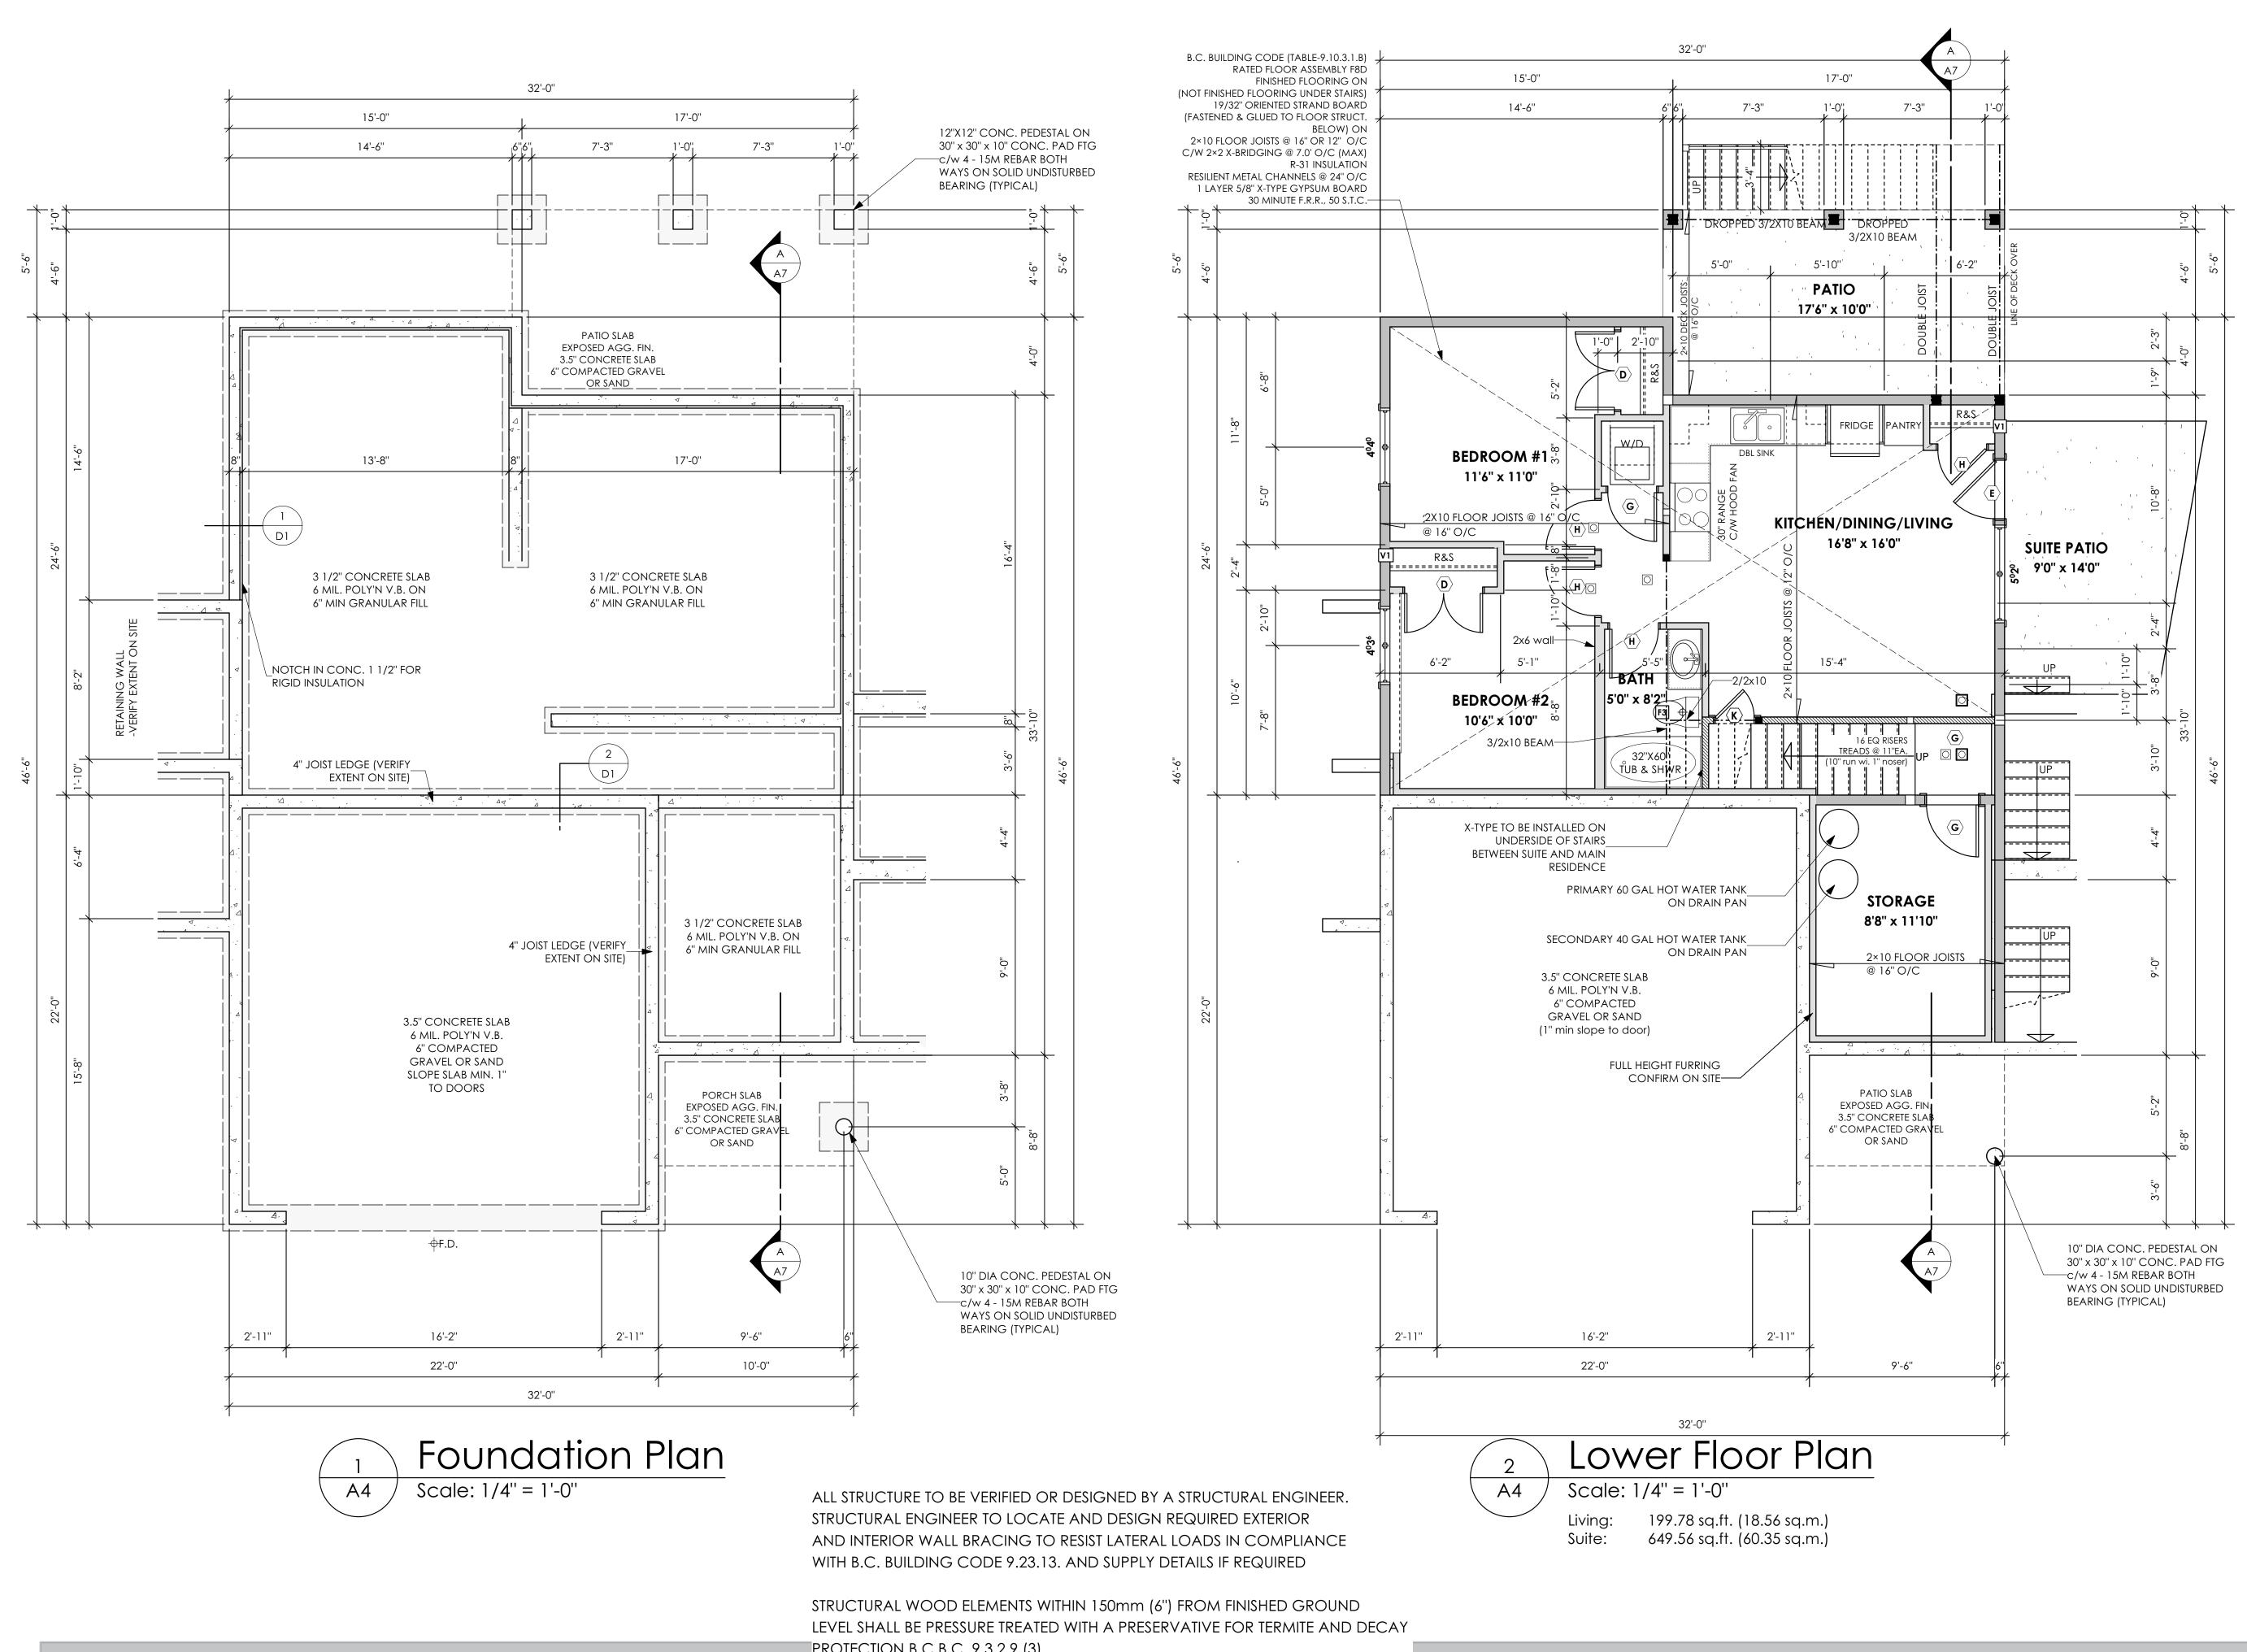

PROTECTION B.C.B.C. 9.3.2.9.(3)

SIZES AND ARE TO BE USED FOR CONSTRUCTION

NOTE: ROOM SIZES NOTED ON FLOOR PLANS ARE FOR REFERENCE PURPOSES ONLY AND NOT TO BE USED FOR CONSTRUCTION. DIMENSIONS TAKE PRECEDENCE OVER

9 design group

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RIDGE WESTCOAST

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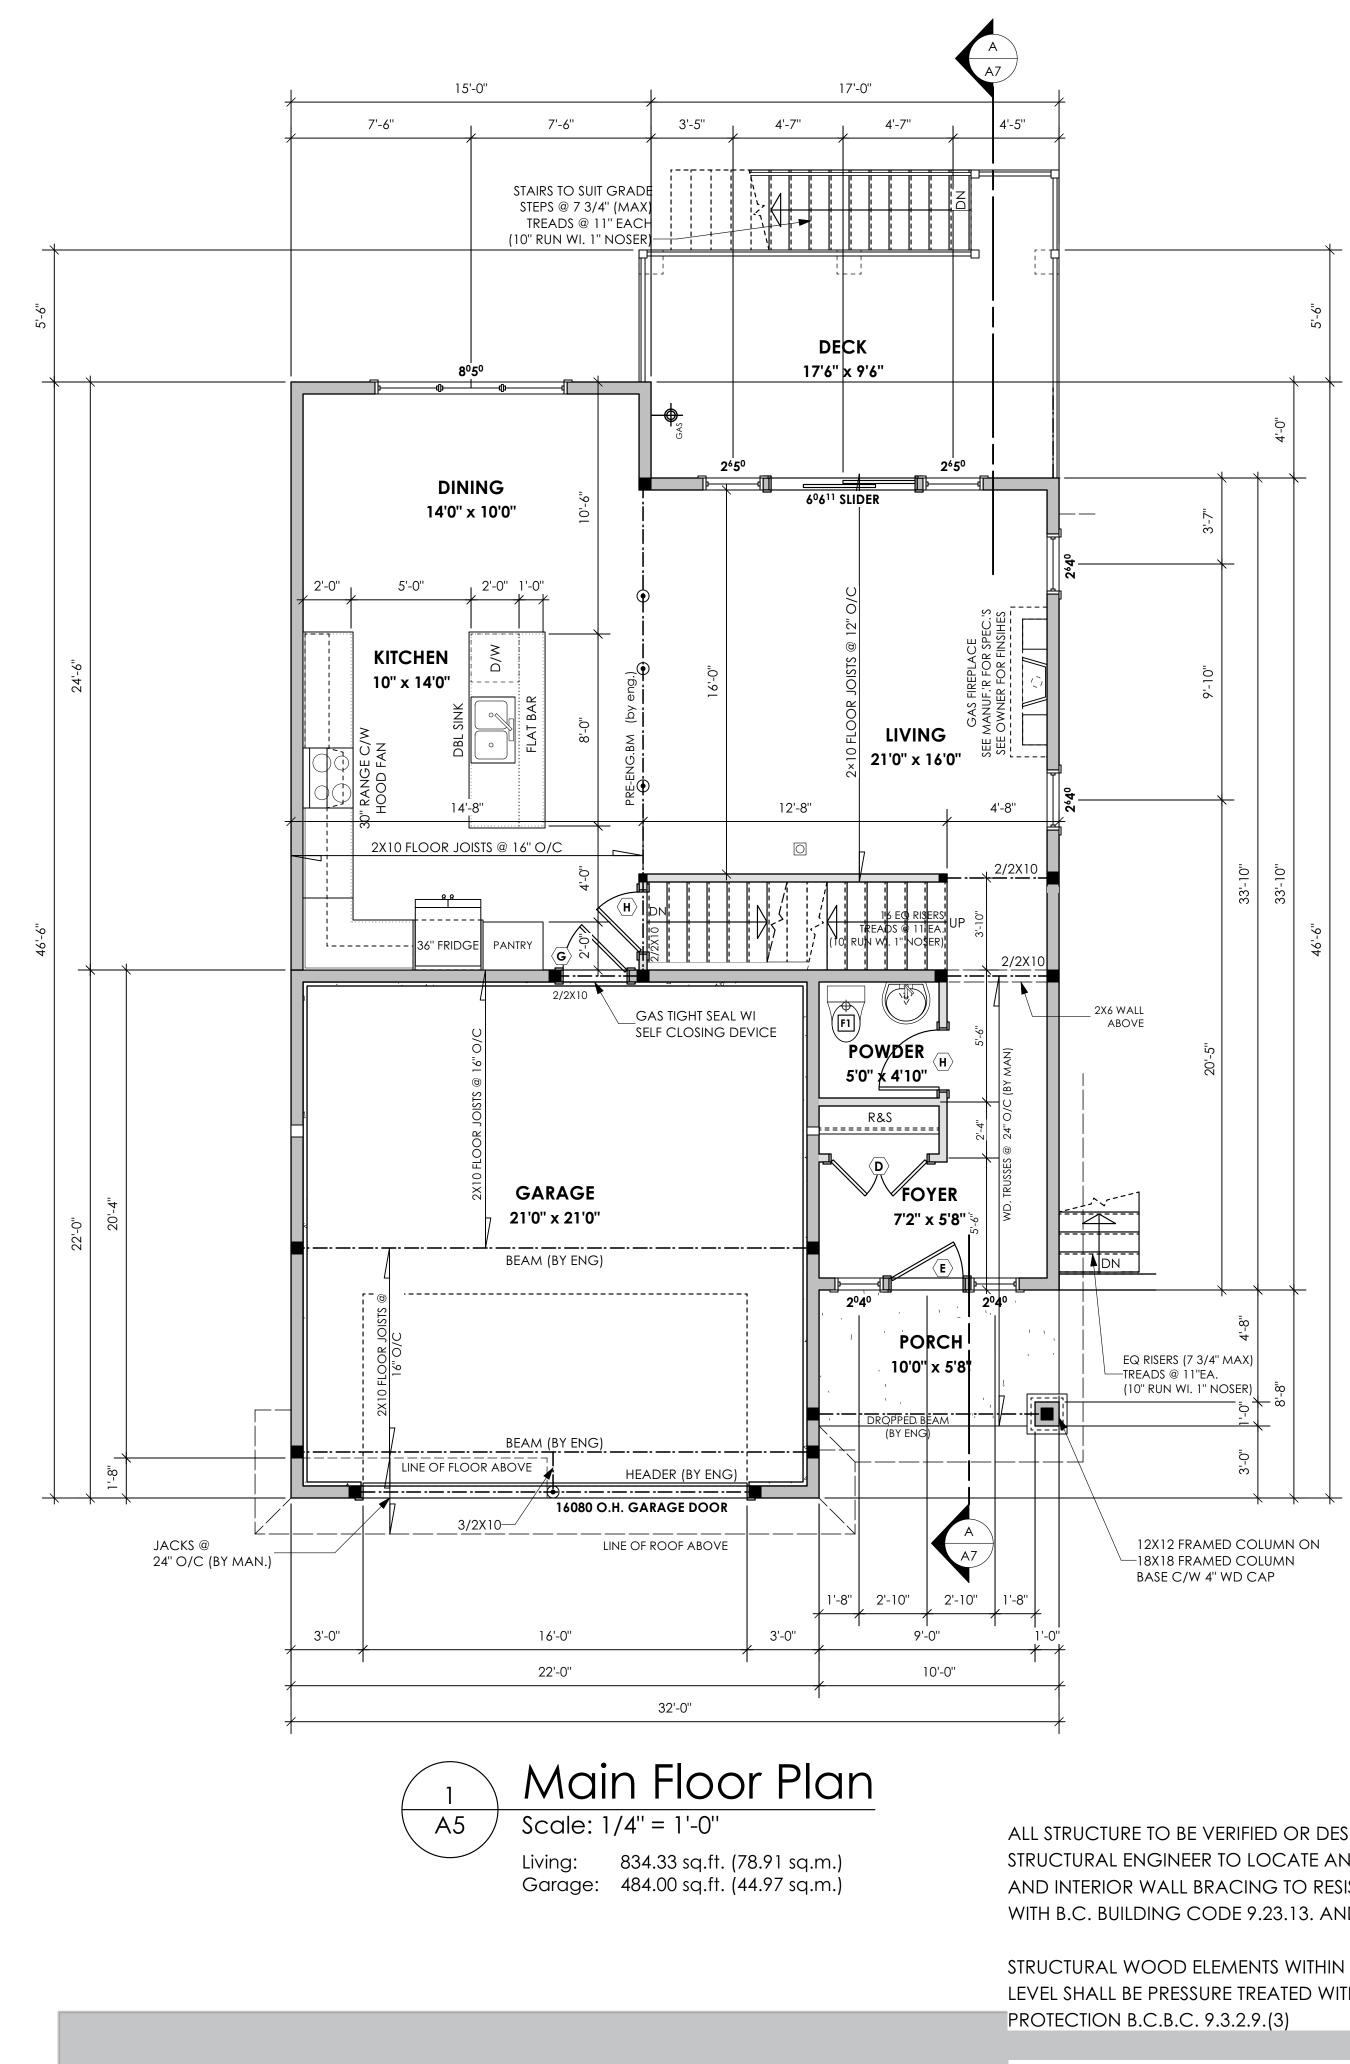
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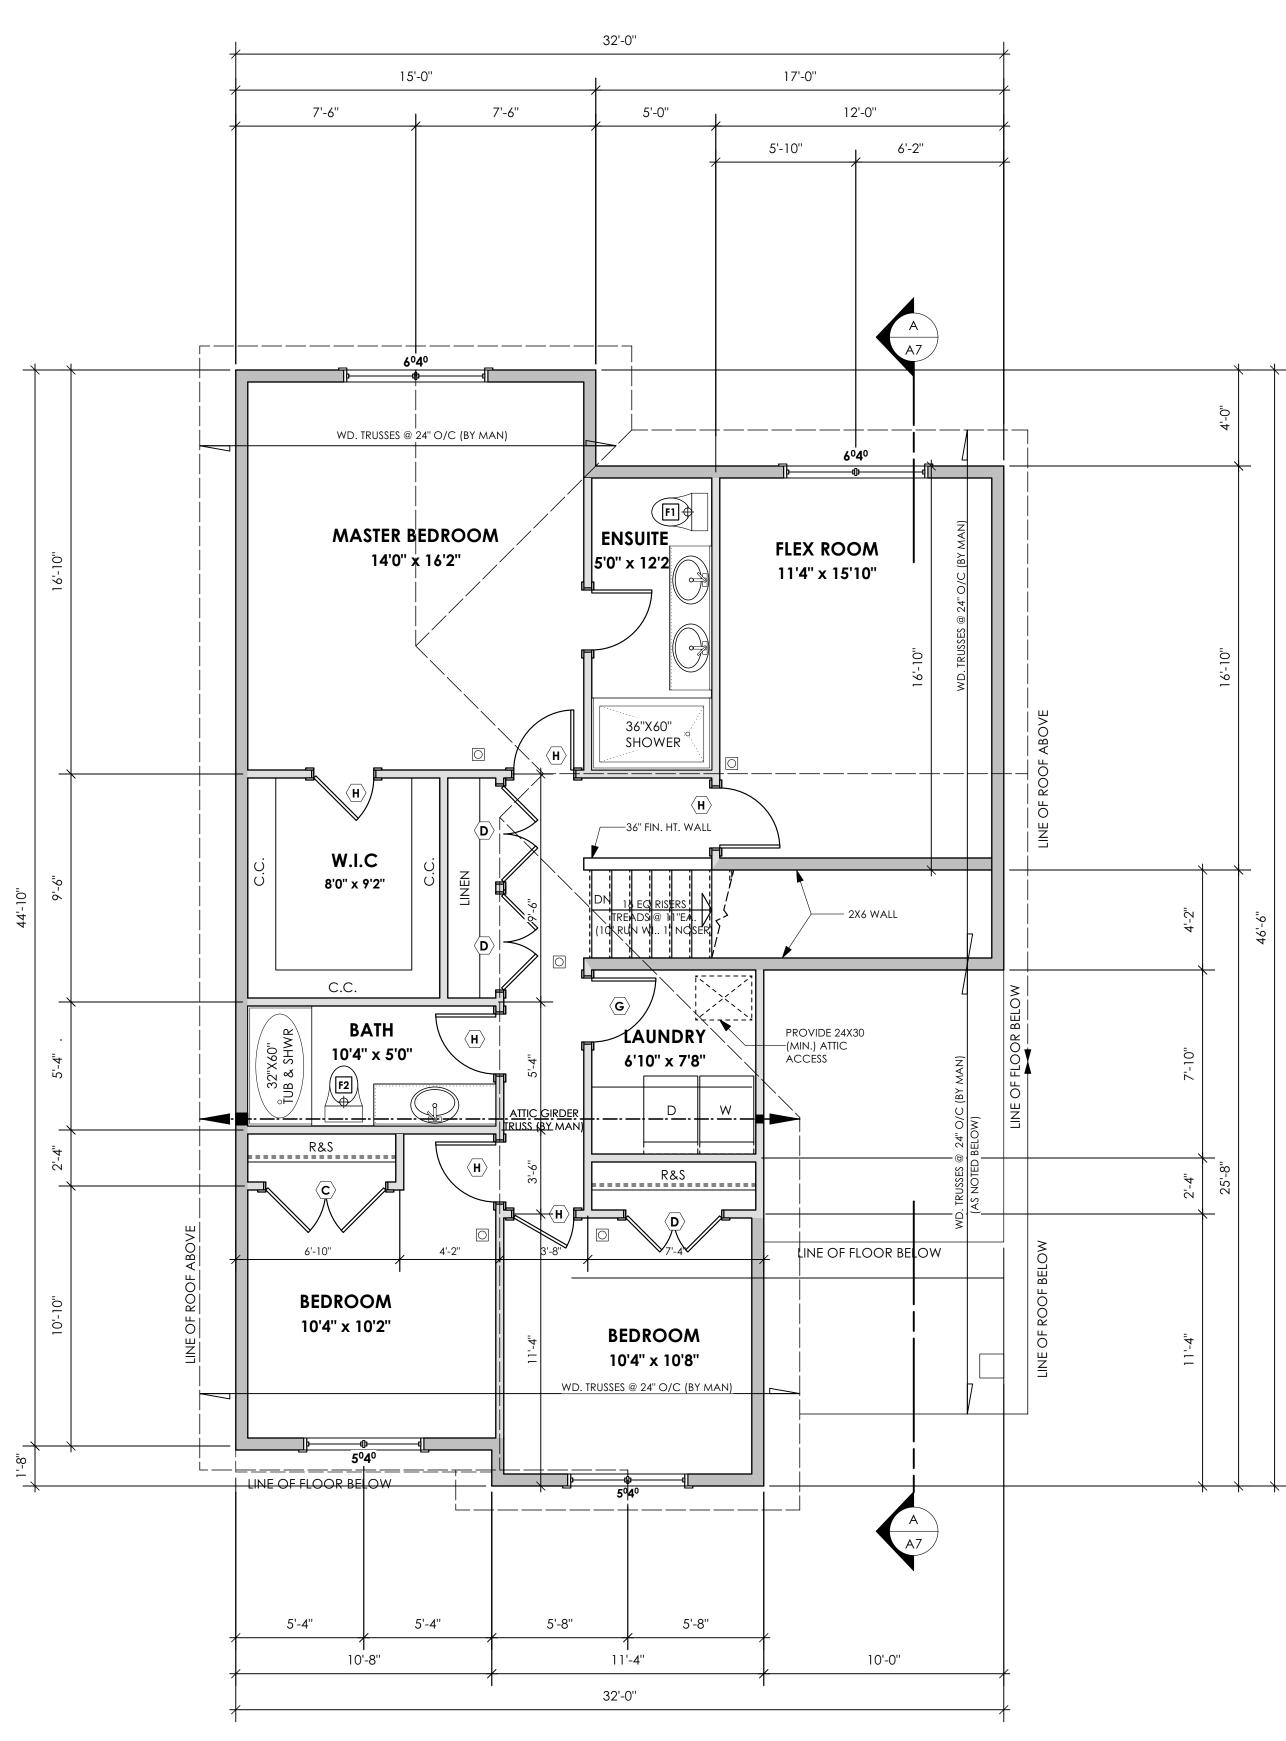
Verity Construction

Project # 8298-77

Scale As Noted

Drawn By MDK





ALL STRUCTURE TO BE VERIFIED OR DESIGNED BY A STRUCTURAL ENGINEER. STRUCTURAL ENGINEER TO LOCATE AND DESIGN REQUIRED EXTERIOR AND INTERIOR WALL BRACING TO RESIST LATERAL LOADS IN COMPLIANCE WITH B.C. BUILDING CODE 9.23.13. AND SUPPLY DETAILS IF REQUIRED

STRUCTURAL WOOD ELEMENTS WITHIN 150mm (6") FROM FINISHED GROUND LEVEL SHALL BE PRESSURE TREATED WITH A PRESERVATIVE FOR TERMITE AND DECAY

SIZES AND ARE TO BE USED FOR CONSTRUCTION

NOTE: ROOM SIZES NOTED ON FLOOR PLANS ARE FOR REFERENCE PURPOSES ONLY AND NOT TO BE USED FOR CONSTRUCTION. DIMENSIONS TAKE PRECEDENCE OVER

Scale: 1/4" = 1'-0"

2

A5



Living: 1126.11 sq.ft. (104.62 sq.m.)



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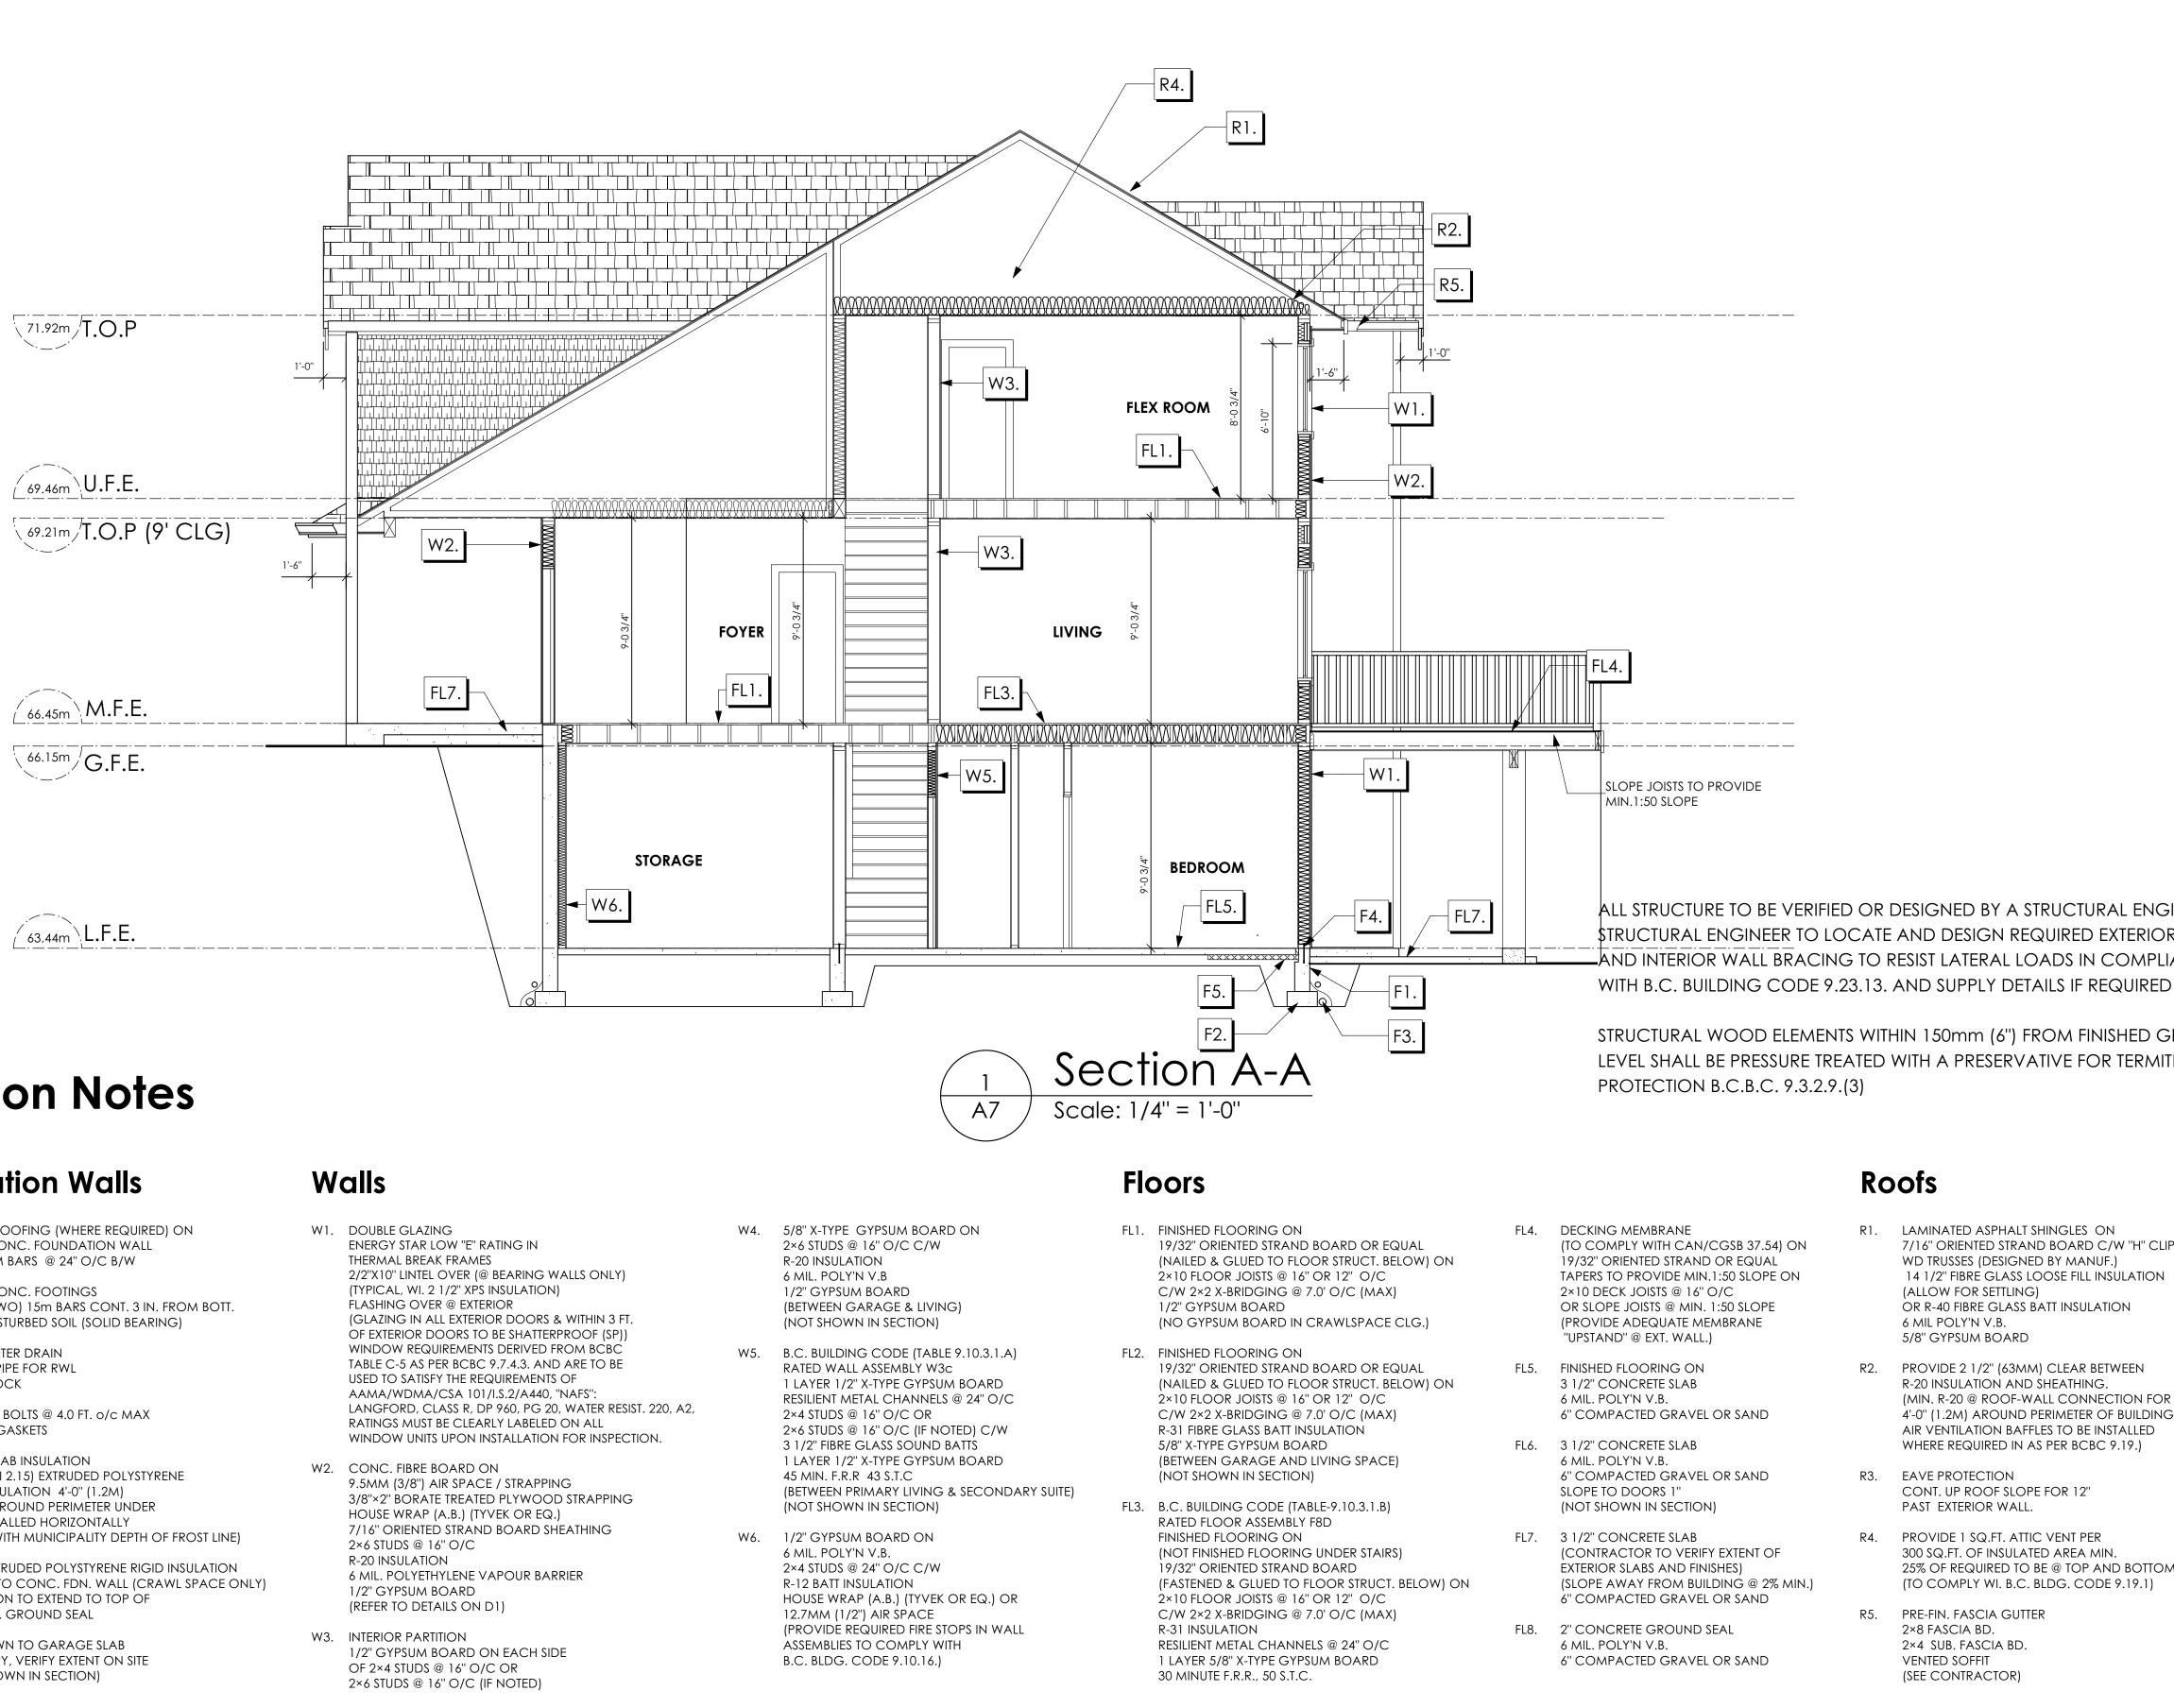
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Section Notes

Foundation Walls

- F1. DAMP PROOFING (WHERE REQUIRED) ON 8" THK. CONC. FOUNDATION WALL C/W 15 M BARS @ 24" O/C B/W
- F2. 16"X 8" CONC. FOOTINGS C/W 2 (TWO) 15m BARS CONT. 3 IN. FROM BOTT. ON UNDISTURBED SOIL (SOLID BEARING)
- F3. 4" PERIMETER DRAIN 3" TIGHT PIPE FOR RWL DRAIN ROCK
- F4. ANCHOR BOLTS @ 4.0 FT. o/c MAX c/w SILL GASKETS
- F5. UNDER SLAB INSULATION 2 1/2" (RSI 2.15) EXTRUDED POLYSTYRENE RIGID INSULATION 4'-0" (1.2M) CONT. AROUND PERIMETER UNDER SLAB INSTALLED HORIZONTALLY (VERIFY WITH MUNICIPALITY DEPTH OF FROST LINE)
- F6. 2 1/2" EXTRUDED POLYSTYRENE RIGID INSULATION APPLIED TO CONC. FDN. WALL (CRAWL SPACE ONLY) INSULATION TO EXTEND TO TOP OF 2" CONC. GROUND SEAL
- F7. STEP DOWN TO GARAGE SLAB MAY VARY, VERIFY EXTENT ON SITE (NOT SHOWN IN SECTION)

W1.	DOUBLE GLAZING ENERGY STAR LOW "E" RATING IN	W4.
	THERMAL BREAK FRAMES 2/2"X10" LINTEL OVER (@ BEARING WALLS ONLY) (TYPICAL, WI. 2 1/2" XPS INSULATION) FLASHING OVER @ EXTERIOR (GLAZING IN ALL EXTERIOR DOORS & WITHIN 3 FT. OF EXTERIOR DOORS TO BE SHATTERPROOF (SP)) WINDOW REQUIREMENTS DERIVED FROM BCBC TABLE C-5 AS PER BCBC 9.7.4.3. AND ARE TO BE USED TO SATISFY THE REQUIREMENTS OF AAMA/WDMA/CSA 101/I.S.2/A440, "NAFS": LANGFORD, CLASS R, DP 960, PG 20, WATER RESIST. 220, A2, RATINGS MUST BE CLEARLY LABELED ON ALL WINDOW UNITS UPON INSTALLATION FOR INSPECTION.	W5.
W2.	CONC. FIBRE BOARD ON 9.5MM (3/8") AIR SPACE / STRAPPING 3/8"×2" BORATE TREATED PLYWOOD STRAPPING HOUSE WRAP (A.B.) (TYVEK OR EQ.) 7/16" ORIENTED STRAND BOARD SHEATHING 2×6 STUDS @ 16" O/C R-20 INSULATION 6 MIL. POLYETHYLENE VAPOUR BARRIER 1/2" GYPSUM BOARD (REFER TO DETAILS ON D1)	W6.
W3.	INTERIOR PARTITION 1/2" GYPSUM BOARD ON EACH SIDE OF 2×4 STUDS @ 16" O/C OR	

Development Permit Presentation



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Roofs

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R2. PROVIDE 2 1/2" (63MM) CLEAR BETWEEN R-20 INSULATION AND SHEATHING. (MIN. R-20 @ ROOF-WALL CONNECTION FOR 4'-0" (1.2M) AROUND PERIMETER OF BUILDING. AIR VENTILATION BAFFLES TO BE INSTALLED WHERE REQUIRED IN AS PER BCBC 9.19.)

R3. EAVE PROTECTION CONT. UP ROOF SLOPE FOR 12" PAST EXTERIOR WALL.

R4. PROVIDE 1 SQ.FT. ATTIC VENT PER 300 SQ.FT. OF INSULATED AREA MIN. 25% OF REQUIRED TO BE @ TOP AND BOTTOM (TO COMPLY WI. B.C. BLDG. CODE 9.19.1)

R5. PRE-FIN. FASCIA GUTTER 2×8 FASCIA BD. 2×4 SUB. FASCIA BD. VENTED SOFFIT (SEE CONTRACTOR)

RIDGE WESTCOAST

Date Nov 17, 2023


Project Address 417 Rock Dove Place Royal Bay - Sector 7 Colwood, B.C. Prepared for

Verity Construction

Project # 8298-77

Scale As Noted

Drawn By MDK

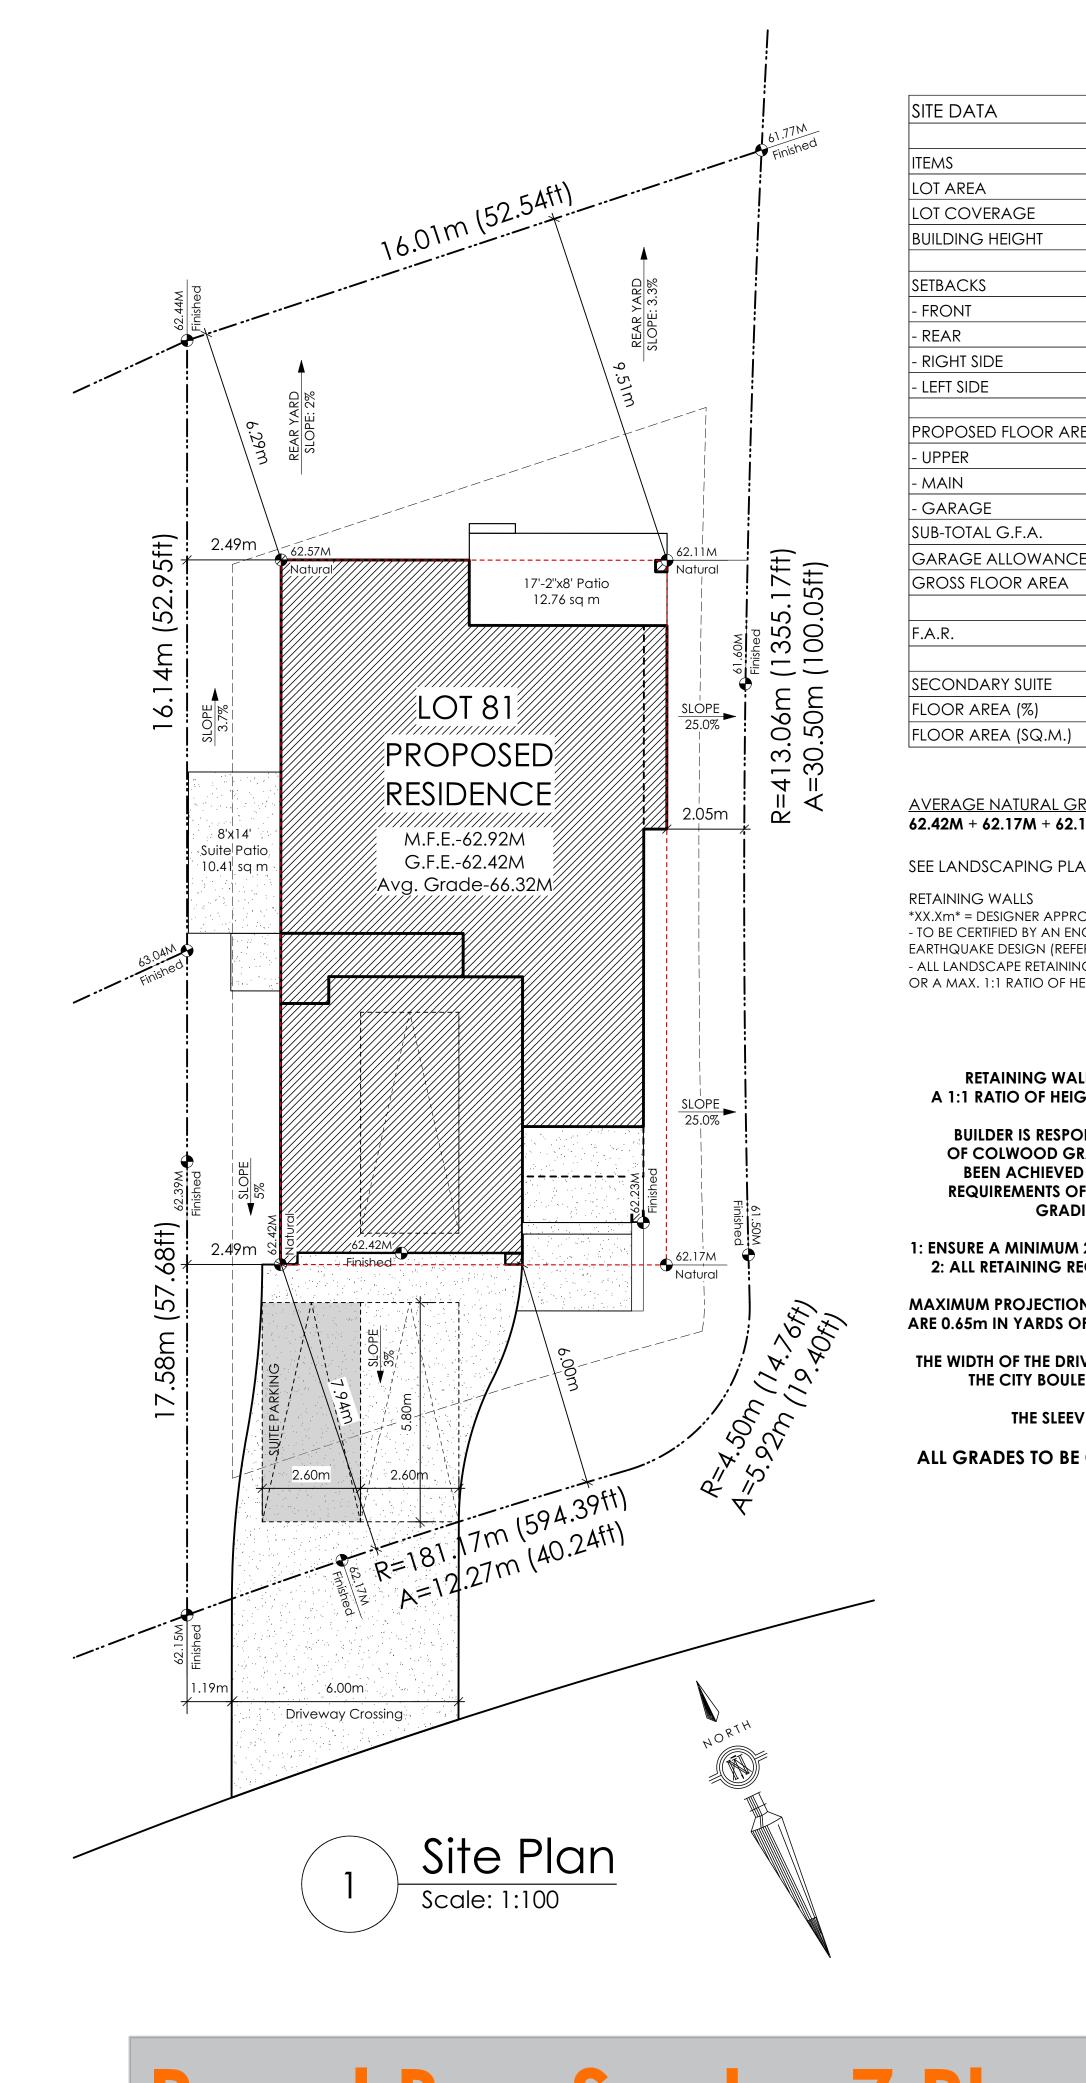

	RBCD5	LOT 81		١.
	PERMITTED	PROPOSED		
	368 sq.m.	498.56 sq.m.		
E	50.00 %	35.83 %		LC
HT	9.50 m.	7.59 m.	LOT 78 LOT 77 LOT 76	
				· \
	3.00 m. 6.00 m.	6.00 m. 6.29 m.		Ì
	1.20 m.	2.05 m.		
	1.20 m.	2.49 m.		
OR AREA				
		155.56 sq.m.	LOT 79	
		113.27 sq.m.		/
•		47.37 sq.m.	LOT 81 /	<u>/</u>
A.	50.00 ca m	268.83 sq.m.		
WANCE AREA	50.00 sq.m.	-47.37 sq.m. 221.46 sq.m.	LOT 80 /	í
		221.40 30.111.		/
		0.44 TO 1.0		'
				`\
JITE %)	40.00 %	34.63 %		
∘) iQ.M.)	90.00 sq.m.	76.70 sq.m.		
,		· · · · · ·	Key Plan	
GN (REFER TO ST RETAINING WALL	AND MEET BCBC REQUIREM RUCTURAL DRAWINGS) LS TO HAVE A 1.2m MAX. EX D HORIZONTAL SEPARATION	(POSED HT	100mm (4") Depth Mulch. Keep Mulch 100mm off Trunk 100mm (4") Depth Mulch.	
	TOP & READ		· 2.60m	
	HORIZONTAL SEPARATIO			
DOD GRADING CHIEVED AND ENTS OF THE D	E FOR ALL COSTS TO ENS G AND SETBACK REQUIR THIS PLOT PLAN COMPLI DESIGN GUIDELINES I.E. S ANDARDS (PAGE 30) ET	EMENTS HAVE ES WITH ALL EE APPENDIX:	Lie bit Wir 200m	
	OPE AWAY FROM STRUC D MUST MEET GUIDELINE		5.6 2.6 2.6 2.6 2.6 2.6 2.6 2.6 2.6 2.6 2	7
	ANTILEVERS / OVERHAN THAN 3.0m AND 1.0m IN			ן א
	Y ACCESS (AT PROPERTY) <u>MAY NOT EXCEED 7.0r</u>		PARKING STALL SMALL CAR PARKING DIMENSIONS STALL DIMENSIONS	1
IE SLEEVES TO	BE INSTALLED BY THE BU	ILDER	* as per 2.2.02a allowing one stall to be a small car parking stall	
TO BE CON	FIRMED ON SITE PRIC	R TO STARTING		
CC	ONSTRUCTION			
	PATH O	F OVERHANG		
				os—
				ı U
		<u>→</u>		

Royal Bay Sector 7 Phase 2, Lot 81 Development Permit Presentation

Not To Scale

PASSENGER VEHICLE

2.13M X 5.8M (7'x19')

TURNING TEMPLATE

Turning Template

7.47m

4

2.13m





Tree Planting Detail

Not To Scale

5

All trees and plants by the home owner to be planted in minimum 10m³ of fertile topsoil, 700mm Deep TYPICAL FENCE NOTES: 1. ALL WOOD P.T. HEM FIR. 2. STAIN TWO COASTS EXTERIOR STAIN, TO MATCH ARCHITECTURAL TRIM (COLOUR TO BE PREAPPROVED BY OWNER) 3. ALL HARDWARE HOT DIPPED GALVANIZED 3'-0'' 4. GATE HARDWARE TO BE PREAPPROVED BY OWNER -6X6 WOOD POST -1X6 BOTHSIDES-COMPACTED SUBGRADE 1/3RD POST HT. IN CONC. FOOTING -ON 75MM OF DRAIN ROCK Typical Fence Detail Not To Scale

> *TYPICAL FENCE DETAIL BASED OFF FENCE DETAIL 1/L1 FROM ROYAL BAY DESIGN GUIDELINES PAGE 21



#103 - 891ATTREE AVENUE VICTORIA, B.C. V9B 0A6 P. 250.382.7374 F. 250.382.7364

Date

Aug 9, 2023


Project Address Royal Bay Sector 7 Verity Construction 3426 Trumpeter Street Lot 81 Langford, B.C. Prepared for Verity Construction

> Project # 8298-81

Scale Not to Scale

Drawn By MRB

'PEARL II' WESTCOAST

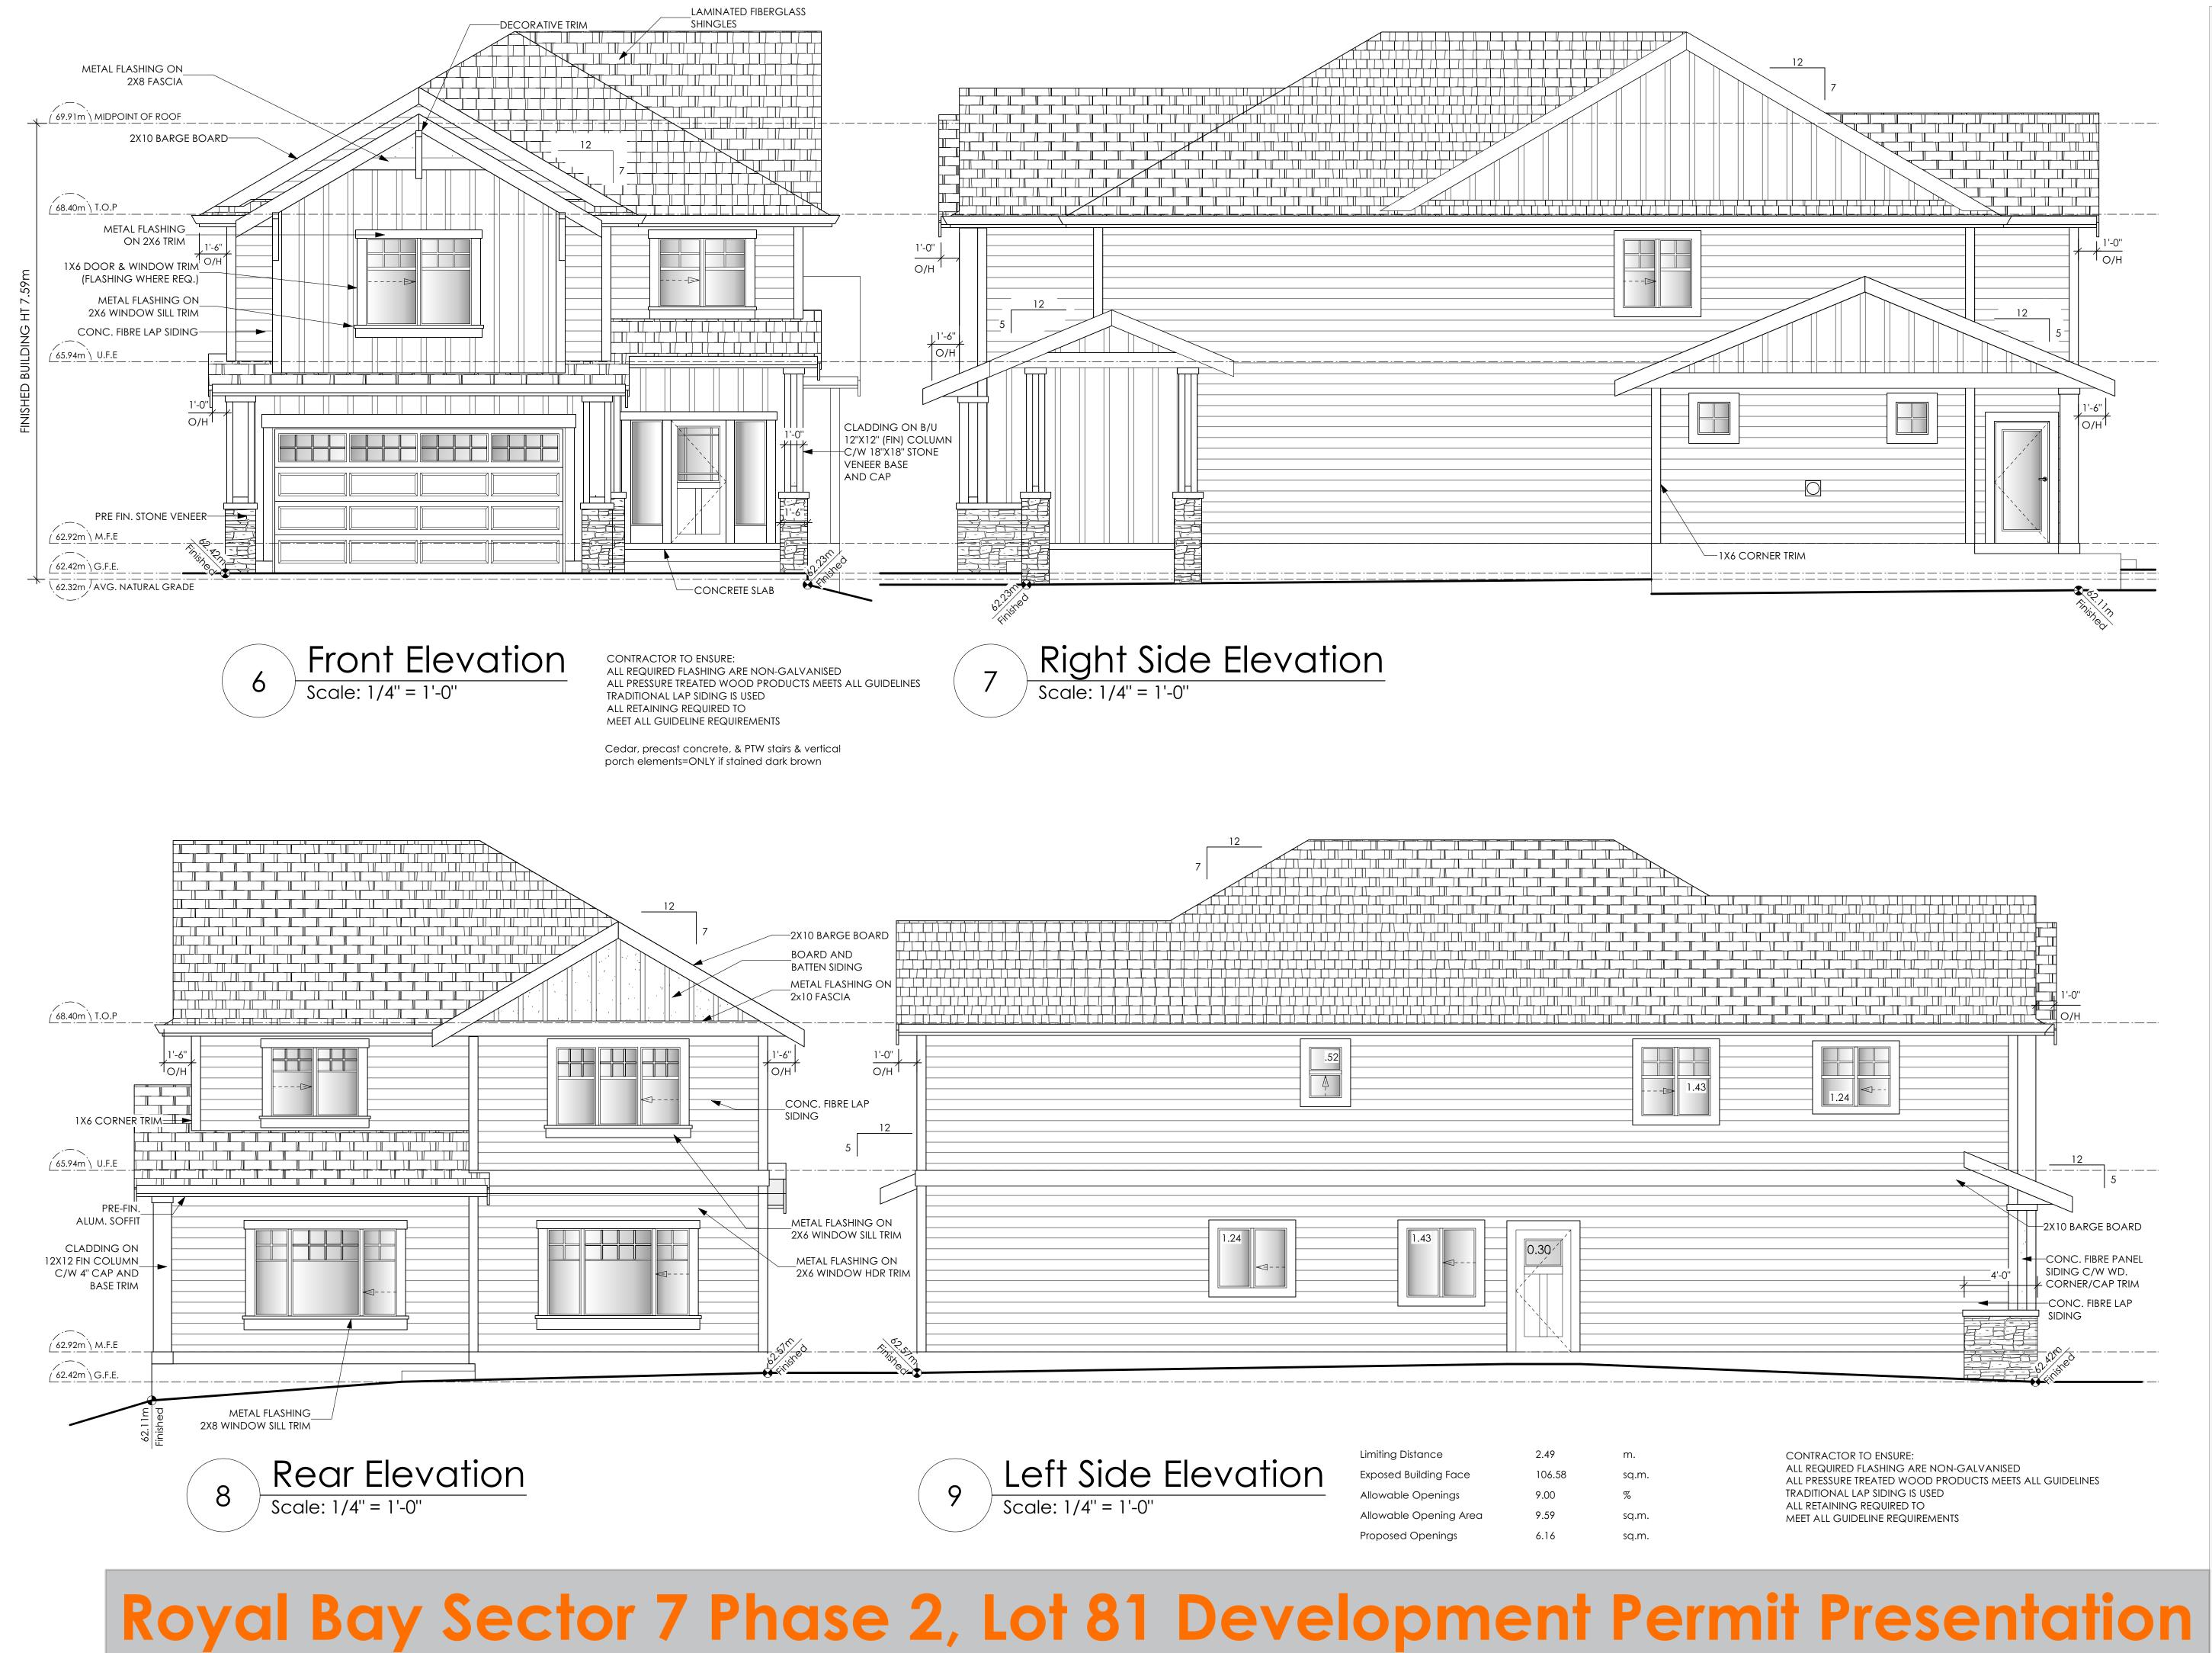

9 design group

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Date

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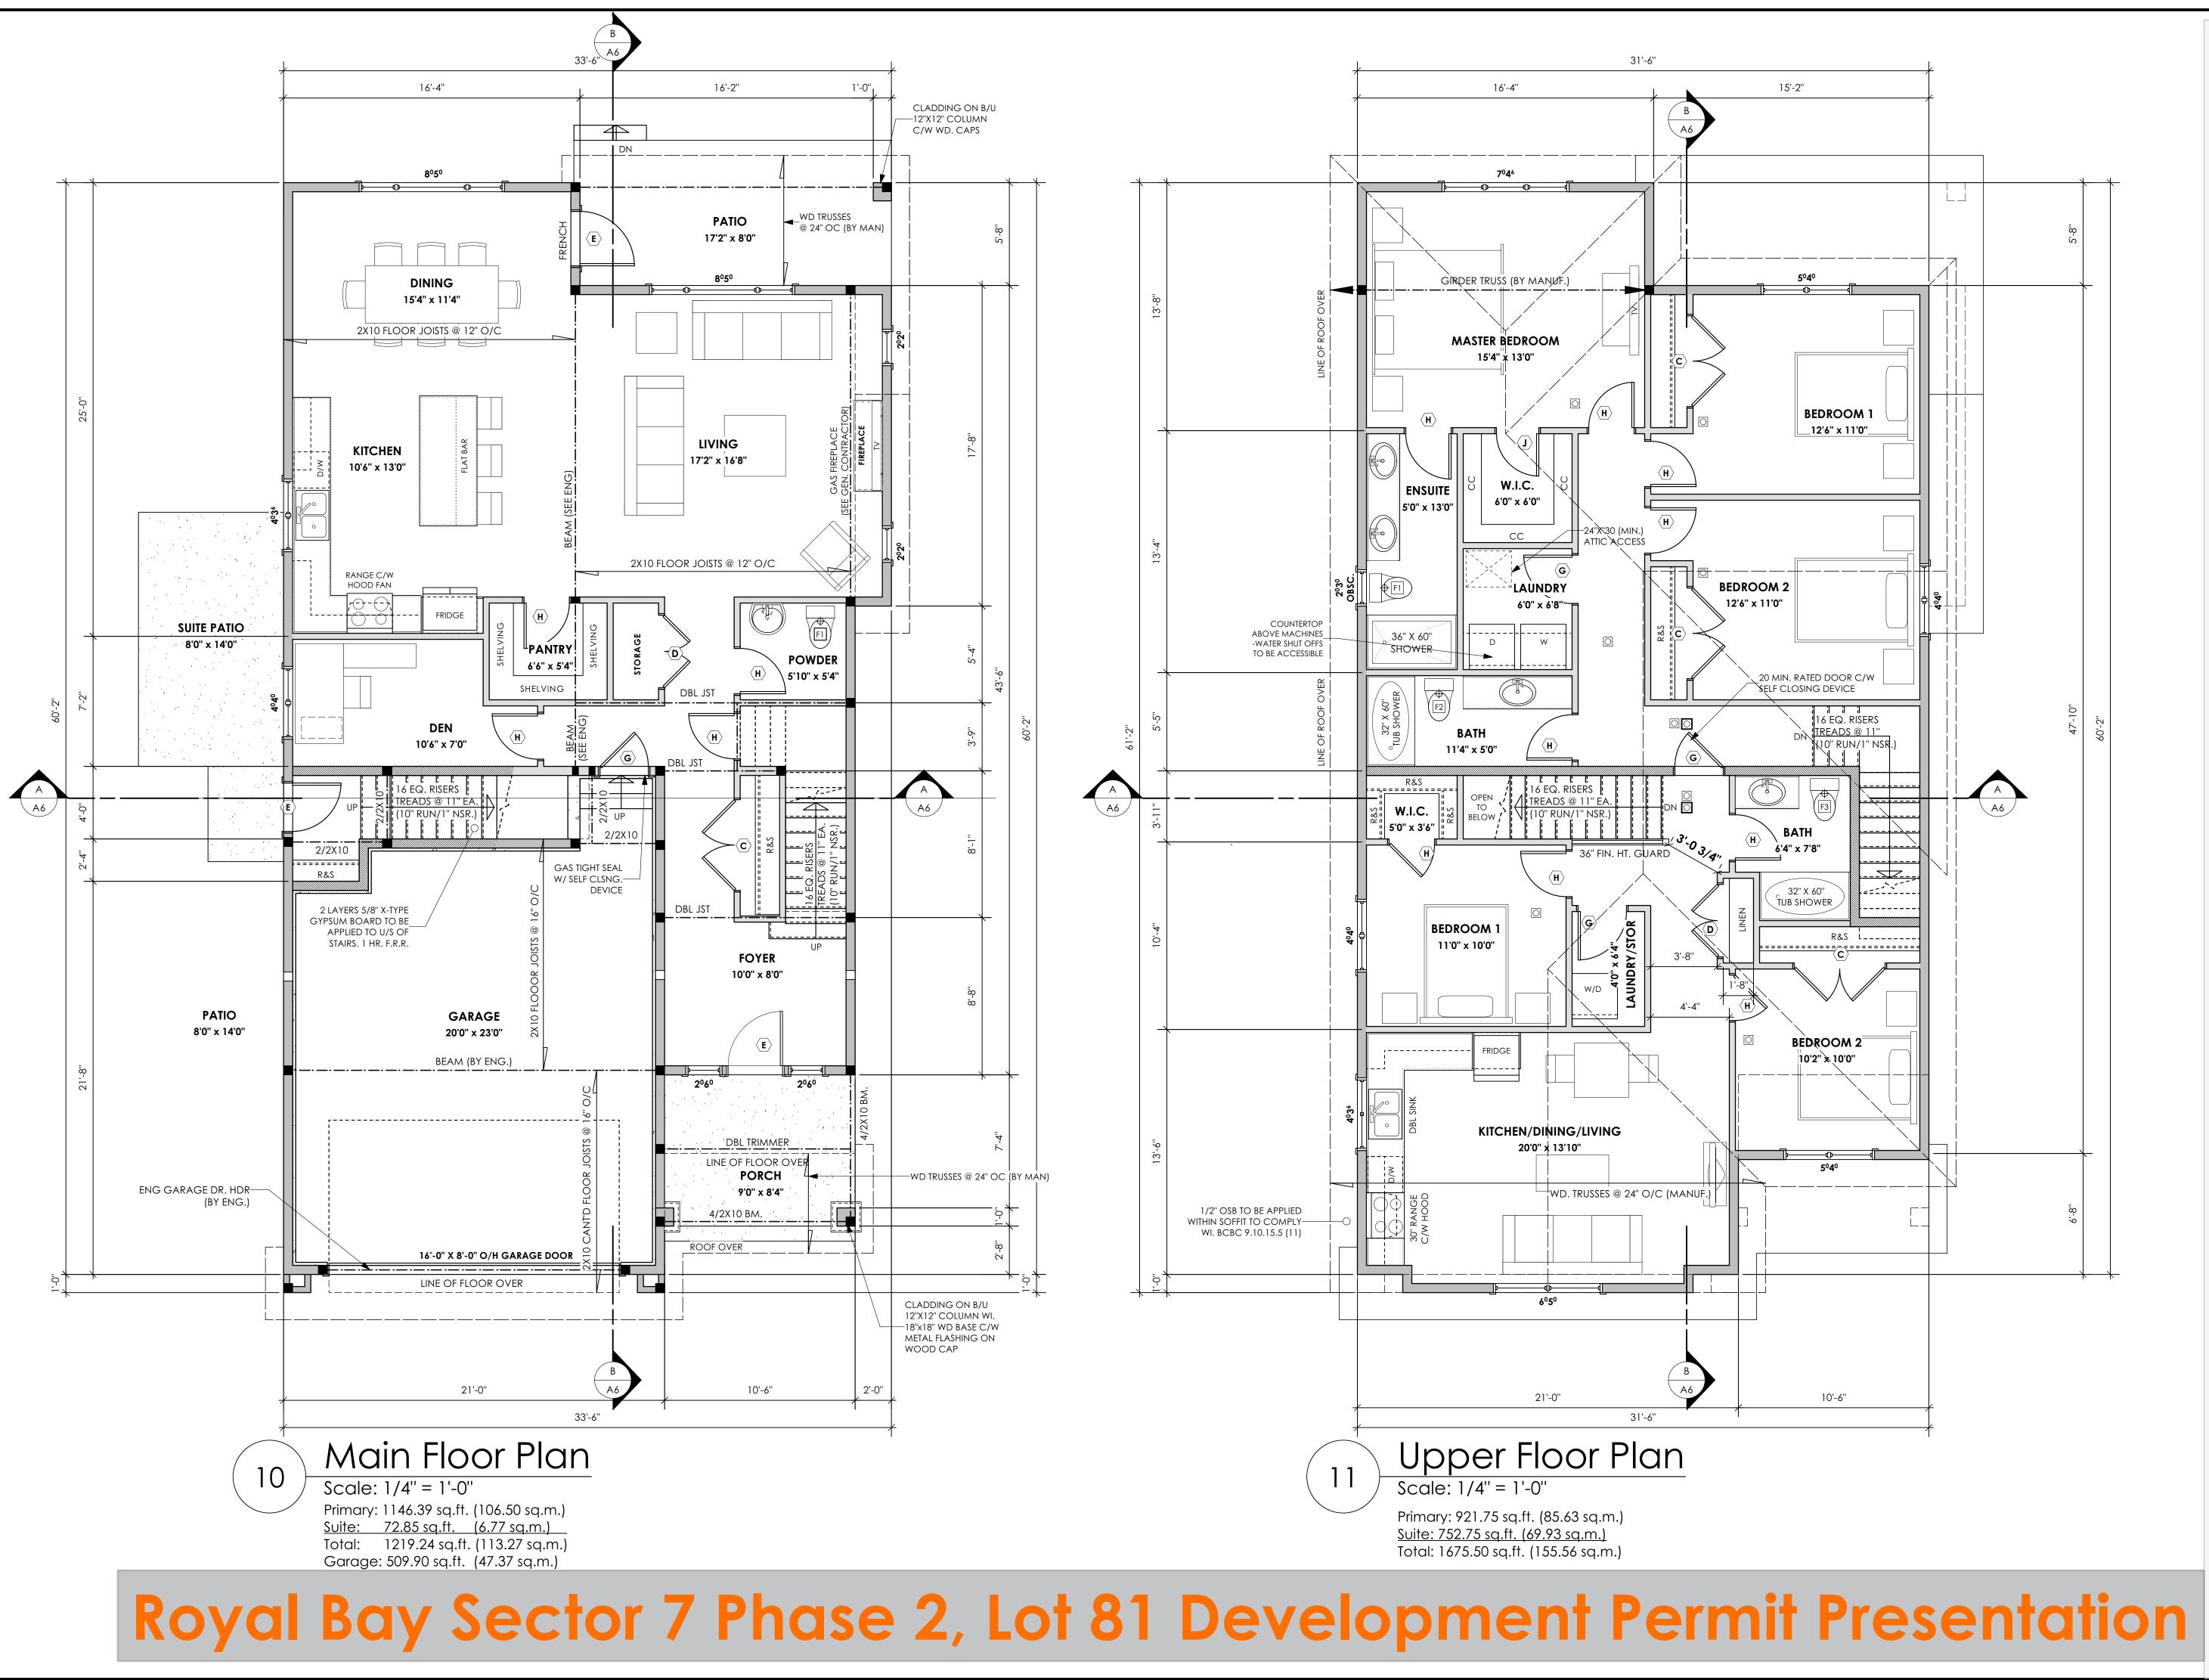
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Scale Not to Scale

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'PEARL II' WESTCOAST





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Date

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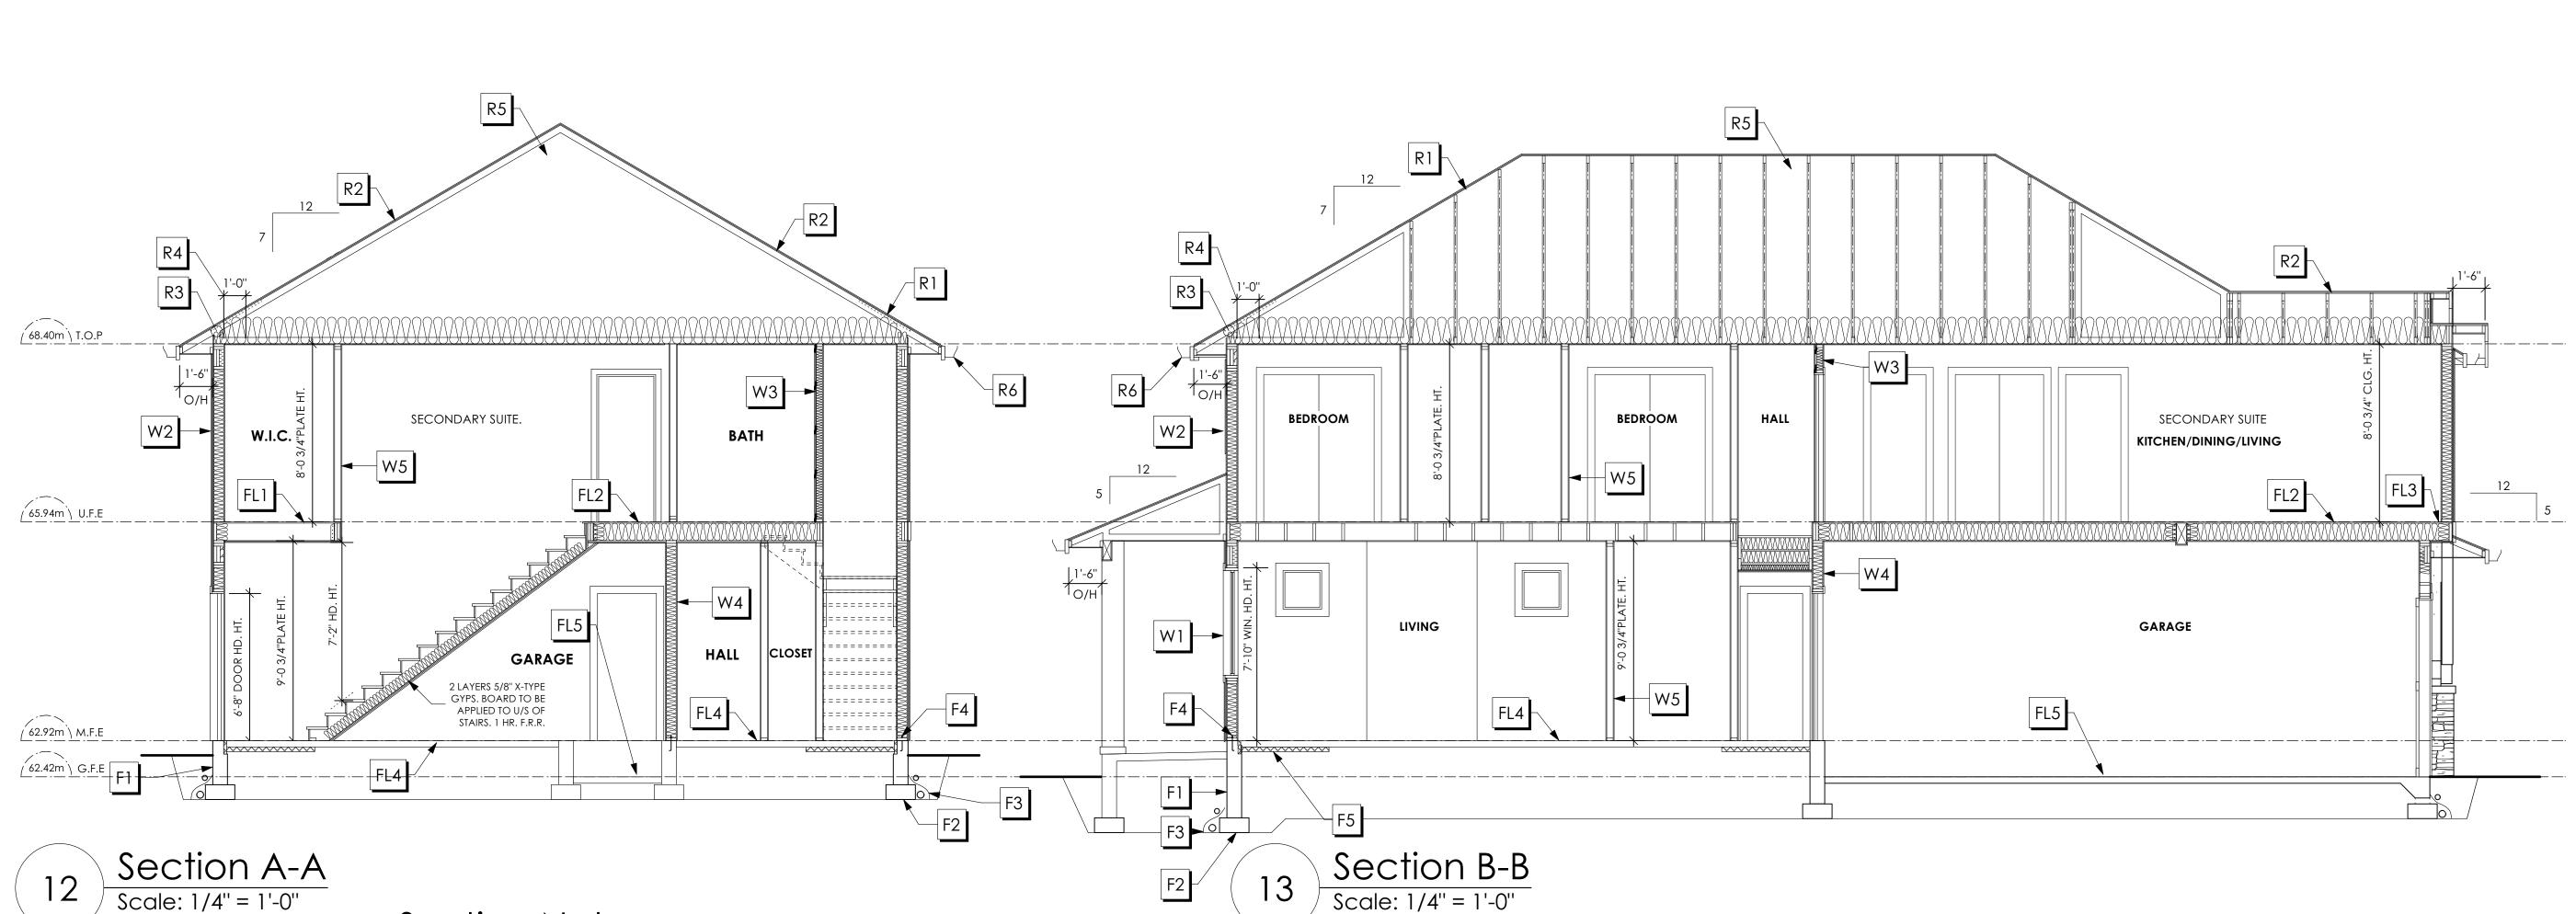
Project Address Royal Bay Sector 7 Verity Construction 3426 Trumpeter Street Lot 81 Langford, B.C. Prepared for Verity Construction

> Project # 8298-81

Scale Not to Scale

Drawn By MRB

'PEARL II' WESTCOAST



Section Notes

FOUNDATION

- F1. DAMP PROOFING (WHERE REQUIRED) ON 8" THK. CONC. FOUNDATION WALL C/W 15 M BARS @ 24" O/C B/W
- F2. 16"X 8" CONC. FOOTINGS C/W 2 (TWO) 15M BARS CONT. 3 IN. FROM BOTT. ON UNDISTURBED SOIL (SOLID BEARING)
- F3. 4" PERIMETER DRAIN **3" TIGHT PIPE FOR RWL** DRAIN ROCK
- F4. ANCHOR BOLTS @ 4.0 FT. O/C MAX C/W SILL GASKETS
- F5. UNDER SLAB INSULATION 2 1/2" (RSI 2.15) EXTRUDED POLYSTYRENE RIGID INSULATION 4'-0" (1.2M) CONT. AROUND PERIMETER UNDER SLAB INSTALLED HORIZONTALLY (VERIFY WITH MUNICIPALITY DEPTH OF FROST LINE)
- F6. STEP DOWN TO GARAGE SLAB MAY VARY, VERIFY EXTENT ON SITE

WALLS

- W1. DOUBLE GLAZING ENERGY STAR LOW "E" RATING IN THERMAL BREAK FRAMES 2/2"X10" LINTEL OVER (@ BEARING WALLS ONLY) (TYPICAL, WI. 2 1/2" XPS INSULATION) FLASHING OVER @ EXTERIOR (GLAZING IN ALL EXTERIOR DOORS & WITHIN 3 FT. OF EXTERIOR DOORS TO BE SHATTERPROOF (SP)) WINDOW REQUIREMENTS DERIVED FROM BCBC TABLE C-5 AS PER BCBC 9.7.4.3. AND ARE TO BE USED TO SATISFY THE REQUIREMENTS OF AAMA/WDMA/CSA 101/I.S.2/A440, "NAFS": COLWOOD, CLASS R, DP 1440, PG 30, WATER RESIST, 220, A2, RATINGS MUST BE CLEARLY LABELED ON ALL WINDOW UNITS UPON INSTALLATION FOR INSPECTION.
- W2. CONC. FIBRE BOARD ON 9.5MM (3/8") AIR SPACE / STRAPPING 3/8"×2" BORATE TREATED PLYWOOD STRAPPING HOUSE WRAP (A.B.) (TYVEK OR EQ.) 7/16" ORIENTED STRAND BOARD SHEATHING 2×6 STUDS @ 16" O/C **R-20 INSULATION** 6 MIL. POLYETHYLENE VAPOUR BARRIER

1/2'' GYPSUM BOARD

- W3. B.C. BUILDING CODE (TABLE 9.10.3.1.A) RATED WALL ASSEMBLY W3c 1 LAYER 1/2" X-TYPE GYPSUM BOARD ON EACH SIDE OF 2×4 STUDS @ 16" O/C OR 2×6 STUDS @ 16" O/C (IF NOTED) RESILIENT METAL CHANNELS ON ONE SIDE @ 400mm OR 600mm O.C. C/W 3 1/2" FIBRE GLASS SOUND BATTS FRICTION FITTED AND SOLID FILLED 45 MIN. F.R.R., 43 S.T.C. (BETWEEN PRIMARY LIVING & SECONDARY SUITE)
- W4. 5/8" X-TYPE GYPSUM BOARD ON 2×6 STUDS @ 16" O/C C/W **R-20 INSULATION** 6 MIL. POLY'N V.B 1/2" GYPSUM BOARD (BETWEEN GARAGE & LIVING)
- W5. INTERIOR PARTITION 1/2" GYPSUM BOARD ON EACH SIDE OF 2×4 STUDS @ 16" O/C OR 2×6 STUDS @ 16" O/C (IF NOTED)

Royal Bay Sector 7 Phase 2, Lot 81 Development Permit Presentation

FLOORS

FL1. FINISHED FLOORING ON 19/32" ORIENTED STRAND BOARD (FASTENED & GLUED TO FLOOR STRUCT. BELOW) ON 2×10 FLOOR JOISTS @ 16" OR 12" O/C C/W 2×2 X-BRIDGING @ 7.0' O/C (MAX) 1/2" GYPSUM BOARD

FL2. B.C. BUILDING CODE (TABLE-9.10.3.1.B) RATED FLOOR ASSEMBLY F8D 30 MINUTE F.R.R., 50 S.T.C. FINISHED FLOORING ON 19/32" ORIENTED STRAND BOARD (FASTENED & GLUED TO FLOOR STRUCT. BELOW) ON 2×10 FLOOR JOISTS @ 16" OR 12" O/C C/W 2×2 X-BRIDGING @ 7.0' O/C (MAX) **R-31 INSULATION** RESILIENT METAL CHANNELS @ 24" O/C 1 LAYER 5/8" X-TYPE GYPSUM BOARD

FL3. FINISHED FLOORING ON 19/32" ORIENTED STRAND BOARD (FASTENED & GLUED TO FLOOR STRUCT. BELOW) ON 2×10 FLOOR JOISTS @ 16" OR 12" O/C C/W 2×2 X-BRIDGING @ 7.0' O/C (MAX) PROVIDE R-31 F/G BATT INSULATION IN JOIST CAVITY C/W BUILDING WRAP VENTED SOFFIT (TO OWNERS SPEC'S) TO ALL SUSPENDED FLOOR AREAS

- FL4. 3 1/2" CONCRETE SLAB 6 MIL. POLY'N V.B. 6" COMPACTED GRAVEL OR SAND
- FL5. 3 1/2" CONCRETE SLAB 6 MIL. POLY'N V.B. 6" COMPACTED GRAVEL OR SAND SLOPE TO DOORS 1"
- FL6. DECKING MEMBRANE (TO COMPLY WITH CAN/CGSB 37.54) ON 19/32" ORIENTED STRAND BOARD 2×10 DECK JOISTS @ 16" O/C C/W (PROVIDE ADEQUATE MEMBRANE "UPSTAND" @ EXT. WALL.)
 - (SLOPE JOISTS TO PROVIDE MIN.1:50 SLOPE)

ROOFS

- R1. LAMINATED ASPHALT SHINGLES ON 7/16" ORIENTED STRAND BOARD C/W "H" CLIPS WD TRUSSES (DESIGNED BY MANUF.) R-40 FIBRE GLAS BATT INSULATION OR 14 1/2" FIBRE GLASS LOOSE FILL INSULATION 6 MIL POLY'N V.B. 5/8" GYPSUM BOARD
- R2. B.C. BUILDING CODE (TABLE-9.10.3.1.B) RATED ROOF ASSEMBLY R1 45 MINUTE RATED F.R.R. LAMINATED ASPHALT SHINGLES ON 7/16" ORIENTED STRAND BOARD C/W "H" CLIPS WD TRUSSES (DESIGNED BY MANUF.) R-40 FIBRE GLAS BATT INSULATION OR 14 1/2" FIBRE GLASS LOOSE FILL INSULATION 6 MIL POLY'N V.B. 5/8" X-TYPE GYPSUM BOARD
- R3. PROVIDE 2 1/2" (63MM) CLEAR BETWEEN R-20 INSULATION AND SHEATHING. (MIN. R-20 @ ROOF-WALL CONNECTION FOR 4'-0" (1.2M) AROUND PERIMETER OF BUILDING. AIR VENTILATION BAFFLES TO BE INSTALLED WHERE REQUIRED IN AS PER BCBC 9.19.)
- R4. EAVE PROTECTION CONT. UP ROOF SLOPE FOR 12" PAST EXTERIOR WALL.
- R5. PROVIDE 1 SQ.FT. ATTIC VENT PER 300 SQ.FT. OF INSULATED AREA MIN. 25% OF REQUIRED TO BE @ TOP AND BOTTOM (TO COMPLY WI. B.C. BLDG. CODE 9.19.1)
- R6. PRE-FIN. FASCIA GUTTER 2×8 FASCIA BD. 2×4 SUB. FASCIA BD. VENTED SOFFIT (SEE CONTRACTOR)
- R7. PRE-FIN. FASCIA GUTTER 2×8 FASCIA BD. 2×4 SUB. FASCIA BD. 1/2" ORIENTED STRAND BOARD VENTED SOFFIT (SEE CONTRACTOR)

Date

design group

#103 - 891ATTREE AVENUE

VICTORIA, B.C.

V9B 0A6

P. 250.382.7374

F. 250.382.7364

Aug 9, 2023

Project Address Royal Bay Sector 7 Verity Construction 3426 Trumpeter Street Lot 81 Langford, B.C. Prepared for Verity Construction

> Project # 8298-81

Scale Not to Scale

Drawn By MRB

'PEARL II' WESTCOAST

SECTOR 7 - LOT 80

SITE DATA	RBCD5	LOT 80
ITEMS	PERMITTED	PROPOSED
LOT AREA	368 sq.m.	516.70 sq.m.
LOT COVERAGE	50.00 %	46.08 %
BUILDING HEIGHT	9.50 m.	6.57 m.
SETBACKS		
- FRONT	3.00 m.	3.86 m.
- REAR	6.00 m.	6.20 m.
- RIGHT SIDE	1.20 m.	1.41 m.
- LEFT SIDE	1.20 m.	1.20 m.
PROPOSED FLOOR AREA		
- MAIN		159.05 sq.m.
- GARAGE		44.96 sq.m.
- LOWER		163.75 sq.m.
SUB-TOTAL G.F.A.		367.76 sq.m.
GARAGE ALLOWANCE	50.00 sq.m.	-44.96 sq.m.
GROSS FLOOR AREA		322.80 sq.m.
F.A.R.		0.62 TO 1.0
SECONDARY SUITE		
FLOOR AREA (%)	40.00 %	27.54 %
FLOOR AREA (SQ.M.)	90.00 sq.m.	88.90 sq.m.

<u>AVERAGE NATURAL GRADE CALCULATION:</u> 65.30m + 64.40m + 63.29m + 62.38m = 255.37m/4 = 63.84m

SEE LANDSCAPING PLAN FOR TREE SCHEDULE

RETAINING WALLS

XX.Xm = DESIGNER APPROXIMATE HEIGHT MEASUREMENT, VERIFY ON SITE - TO BE CERTIFIED BY AN ENGINEER AND MEET BCBC REQUIREMENTS FOR EARTHQUAKE DESIGN (REFER TO STRUCTURAL DRAWINGS) - ALL LANDSCAPE RETAINING WALLS TO HAVE A 1.2m MAX. EXPOSED HT OR A MAX. 1:1 RATIO OF HEIGHT TO HORIZONTAL SEPARATION IF TERRACED

STOP & READ

RETAINING WALLS <u>MAY NOT</u> EXCEED 1.2m IN HEIGHT, OR A 1:1 RATIO OF HEIGHT TO HORIZONTAL SEPARATION IF TERRACED

BUILDER IS RESPONSIBLE FOR ALL COSTS TO ENSURE ALL CITY OF COLWOOD GRADING AND SETBACK REQUIREMENTS HAVE BEEN ACHIEVED AND THIS PLOT PLAN COMPLIES WITH ALL REQUIREMENTS OF THE DESIGN GUIDELINES I.E. SEE APPENDIX: GRADING STANDARDS (PAGE 30) ETC.


1: ENSURE A MINIMUM 2% SLOPE AWAY FROM STRUCTURE ON ALL SIDES 2: ALL RETAINING REQUIRED MUST MEET GUIDELINE REQUIREMENTS


MAXIMUM PROJECTIONS / CANTILEVERS / OVERHANGS INTO SETBACKS ARE 0.65m IN YARDS OF LESS THAN 3.0m AND 1.0m IN YARDS OF 3.0m+.

THE WIDTH OF THE DRIVEWAY ACCESS (AT PROPERTY LINE - CROSSING THE CITY BOULEVARD) <u>MAY NOT EXCEED 7.0m</u> IN WIDTH

THE SLEEVES TO BE INSTALLED BY THE BUILDER


ALL GRADES TO BE CONFIRMED ON SITE PRIOR TO STARTING CONSTRUCTION

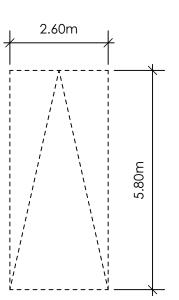

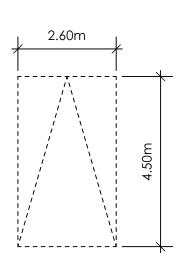

PARKING STALL DIMENSIONS

SMALL CAR PARKING STALL DIMENSIONS * as per 2.2.02a allowing one stall to be a small car parking stall

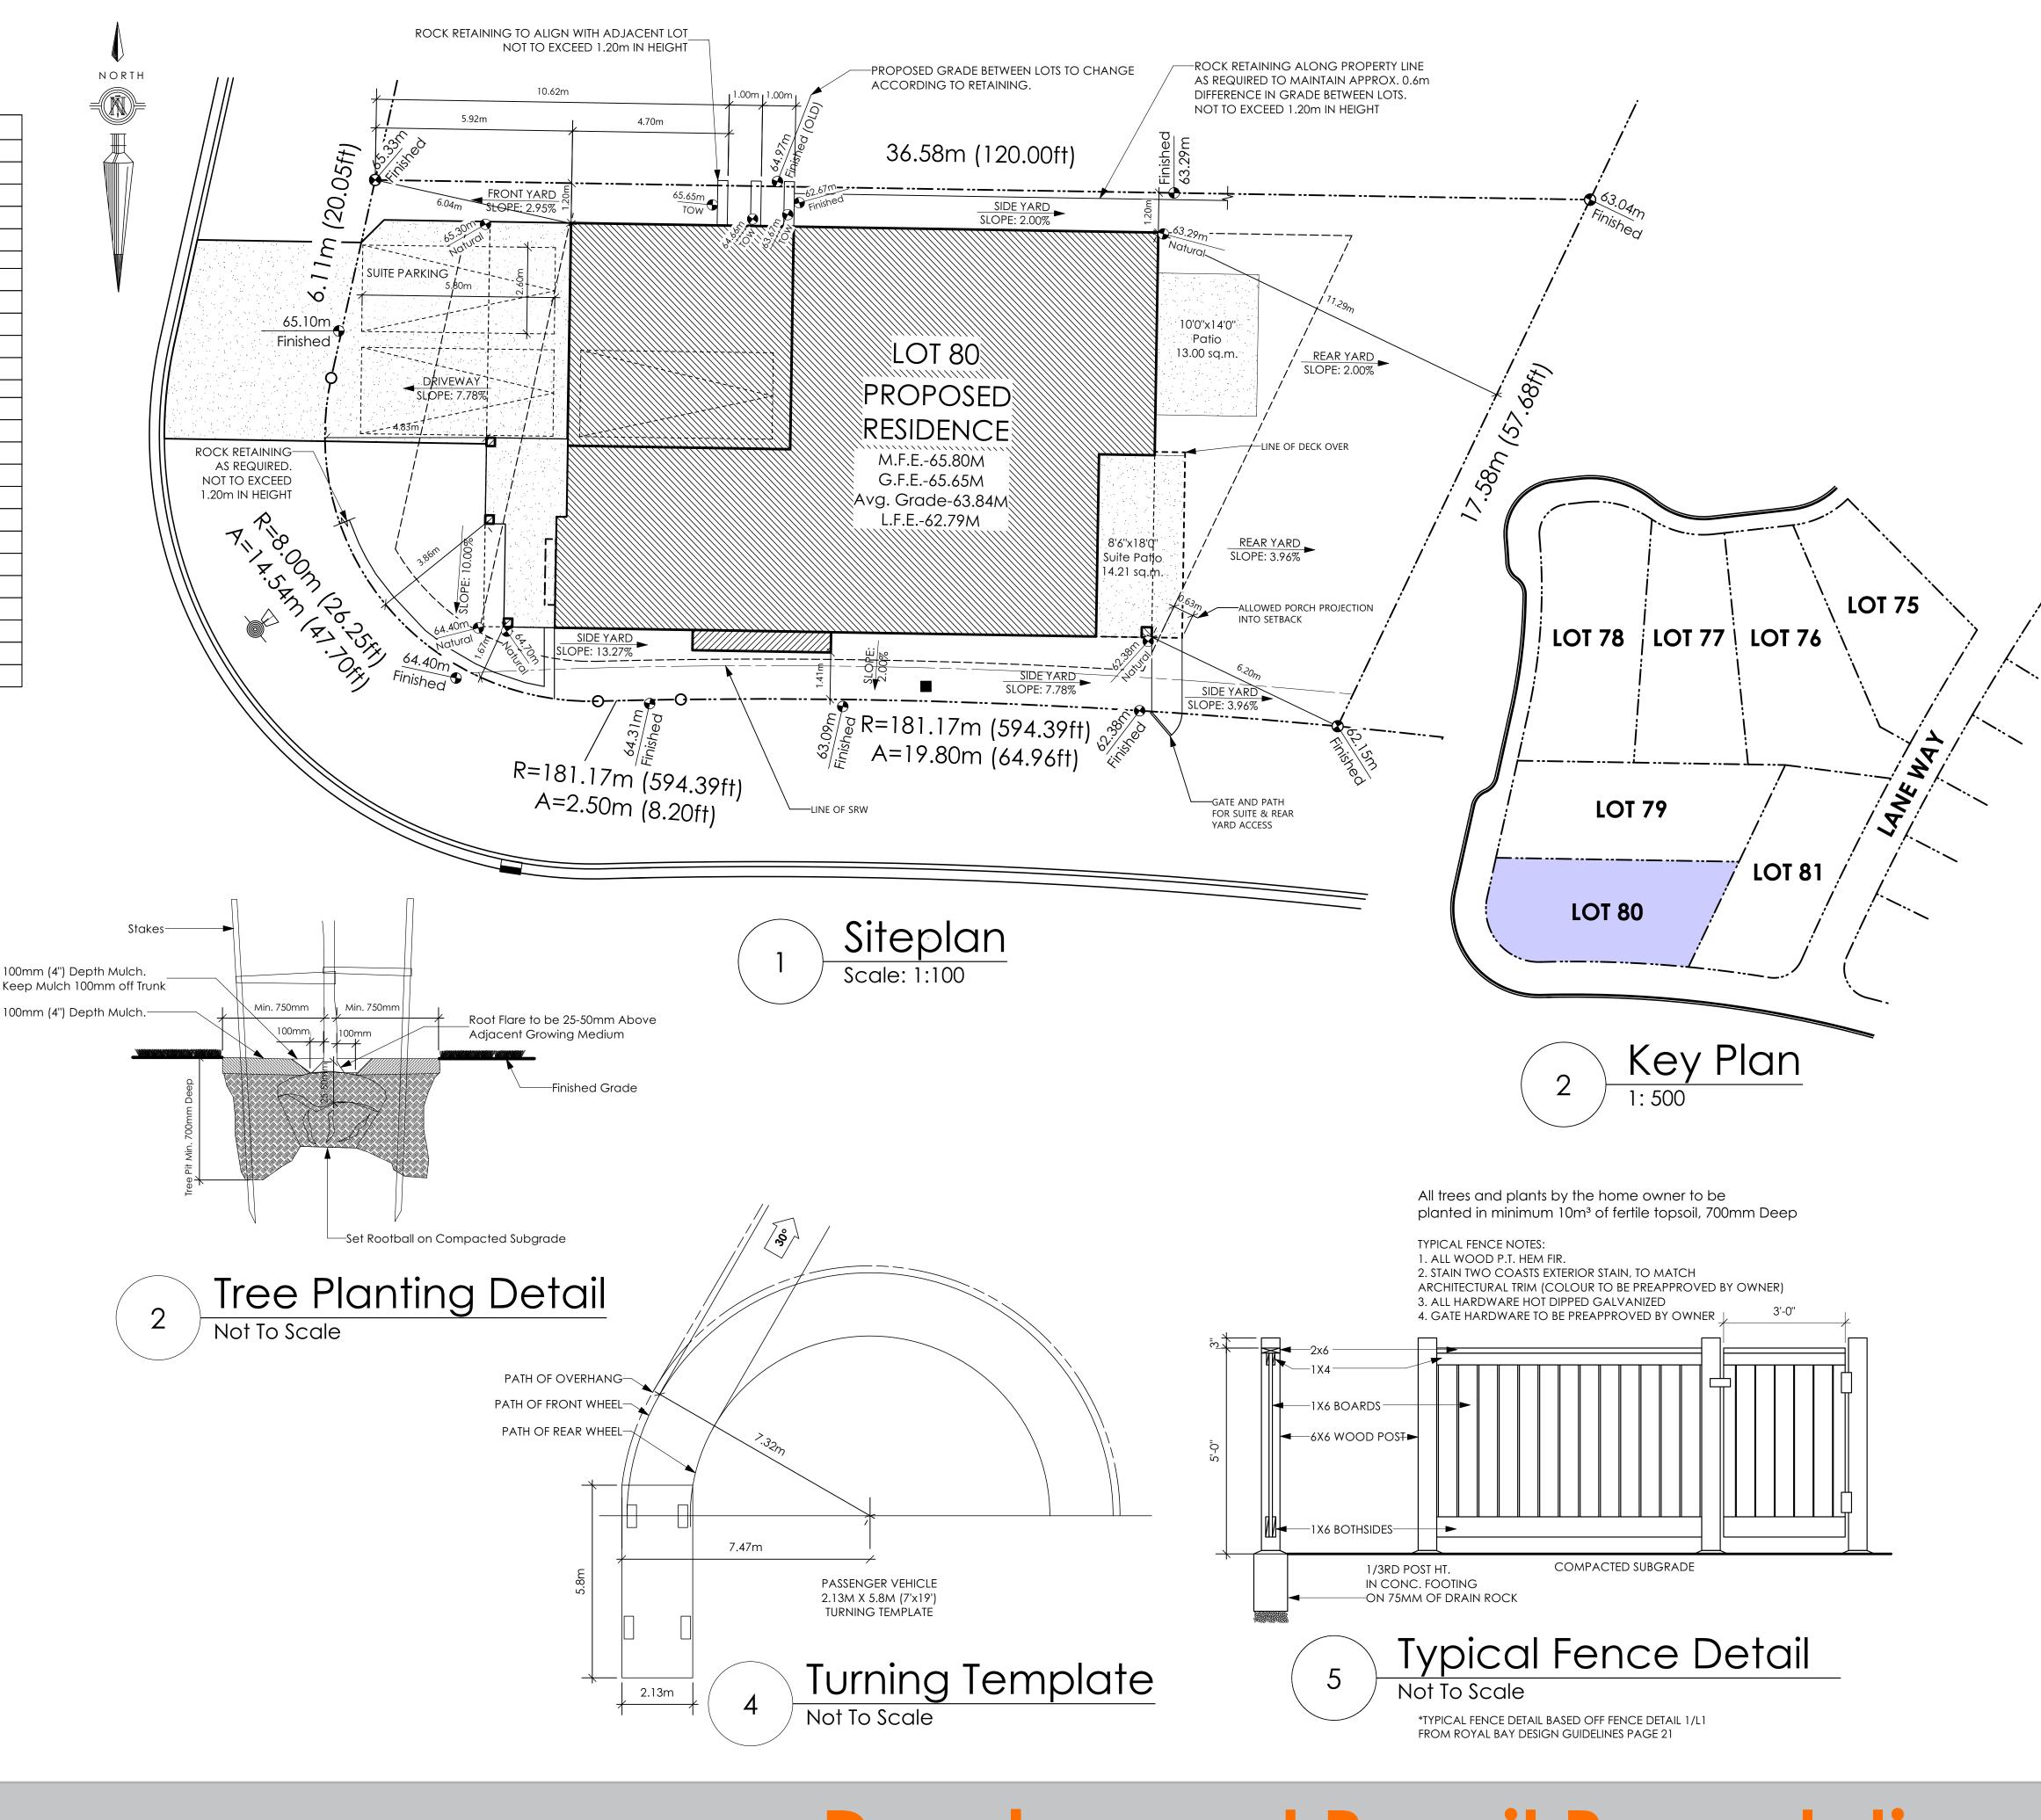

Development Permit Presentation

/d|victoria 9|design group

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Date Nov 09, 2023

Project Address 3442 TRUMPETER STREET Royal Bay - Sector 7 Colwood, B.C. Prepared for

Verity Construction


Project # 8298-80

Scale As Noted

Drawn By NS

MIDPOINT	
 OF ROOF	


				laminated ashf	Palt shingles—		
<u>68.57m</u> T.O.P			PRE-FIN. /				
			1X	6 CORNER TRIM	>		
		(MET.	1X6 DOOR AND AL FLASHING WH				
			CONC. FI	BRE LAP SIDING (7" REVEAL)			
				(/ KEVEAL)			
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() G.F.E.					/ :		
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^{63.84m} /Ave. Natural Grade		· · · · · · ·					
62.79m L.F.E.		· · ·					
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Ave. Natural Grade							
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Development Permit
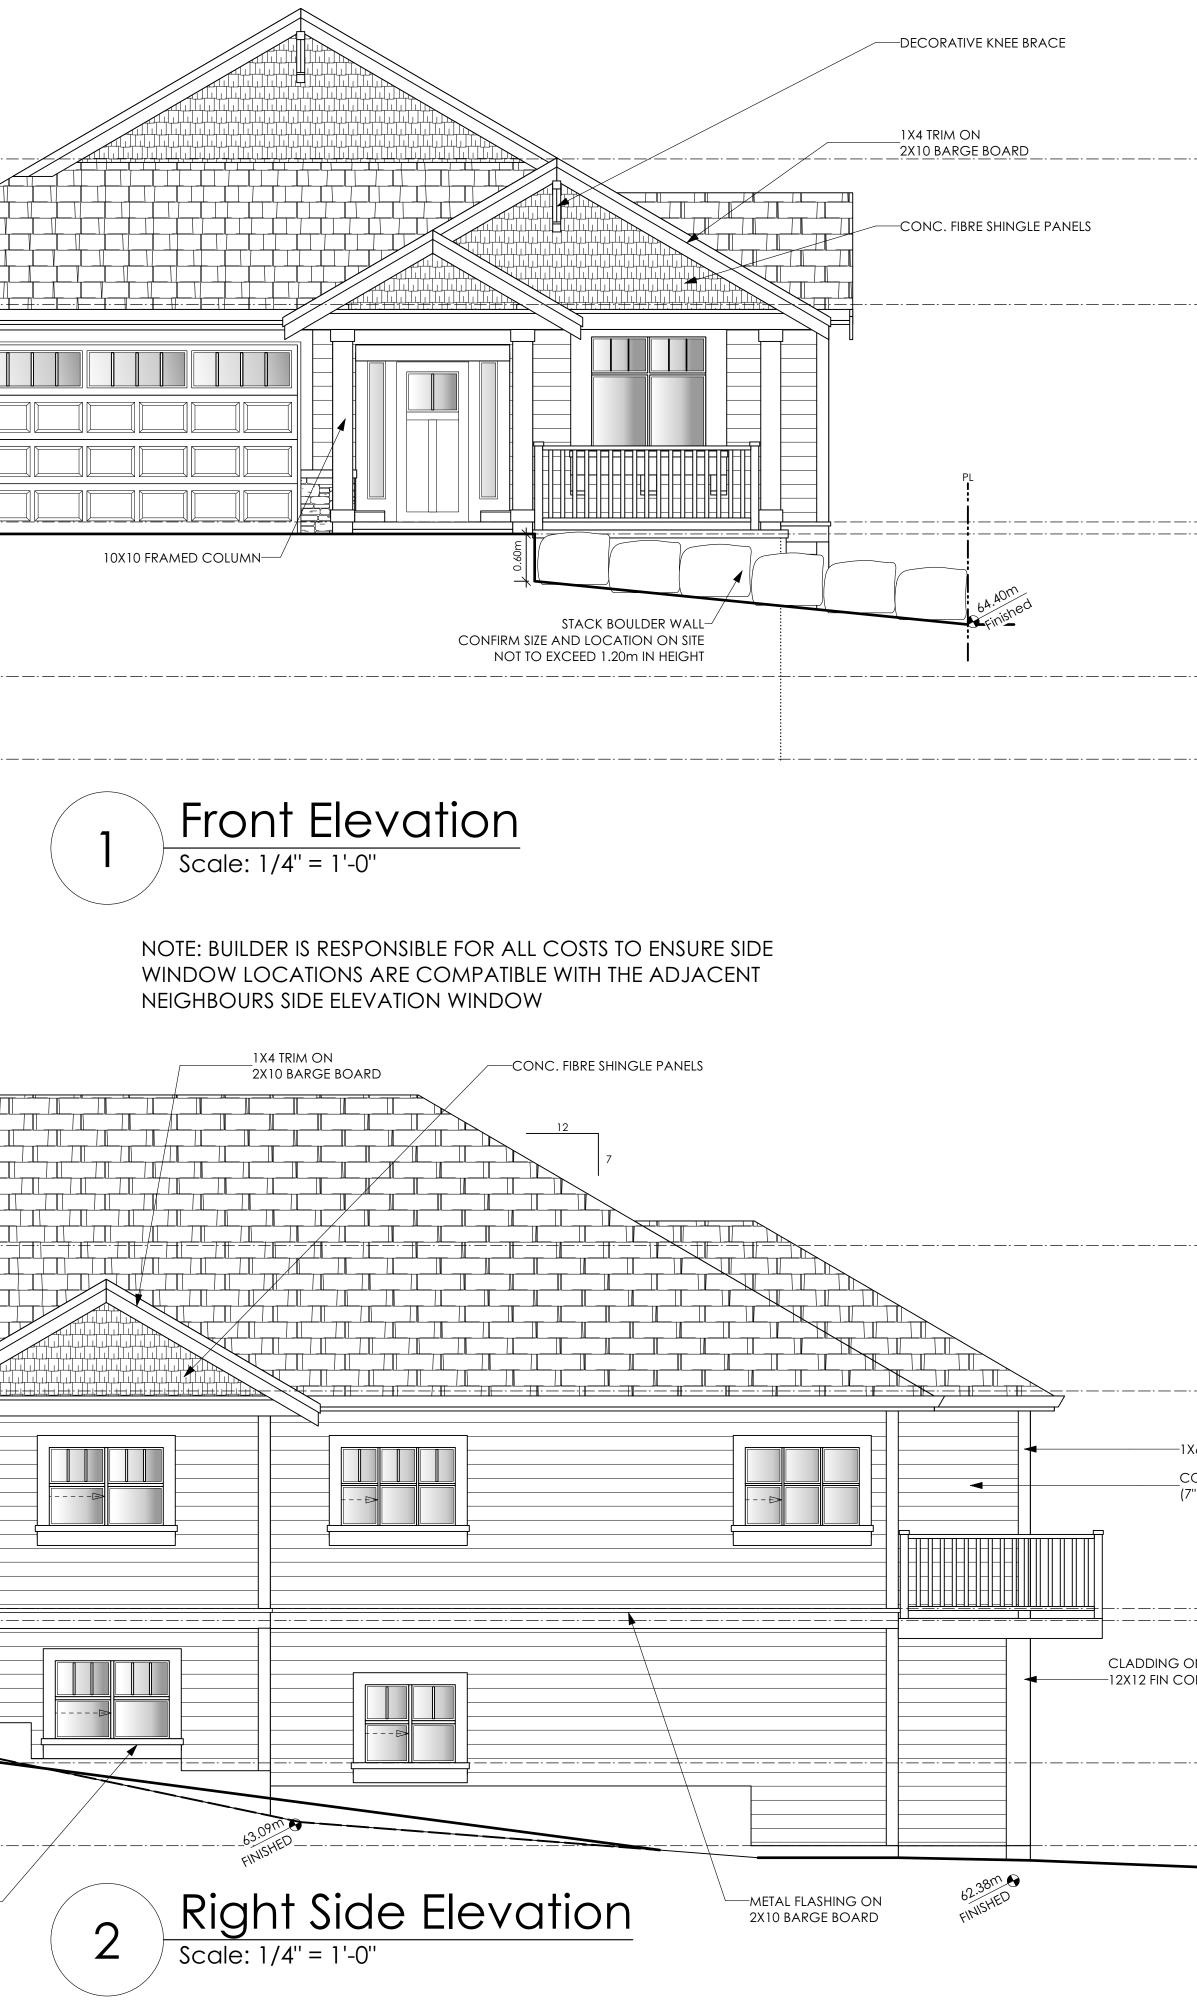
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66 CORNER TRIM ONC. FIBRE LAP SIDING "REVEAL)	Date Nov 09, 2023 Project Address S442 TRUMPETER STREET Royal Bay - Sector 7 Colwood, B.C. Project 6 Verity Construction Project 4 A298-80 Scale As Noted NS
t Presentation	

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63.84m Ave. Natural Grade 62.79m L.F.E.	42" FIN. HT. PRE-FIN ALUMN GUAR COMPLY WI/. B.C.BLDG CODE	
62.79m L.F.E.		
1X6 DOOR AND WINDOW TRIM_	^{63.84m} Ave. Natural Grade	
	62.79m L.F.E.	



design group
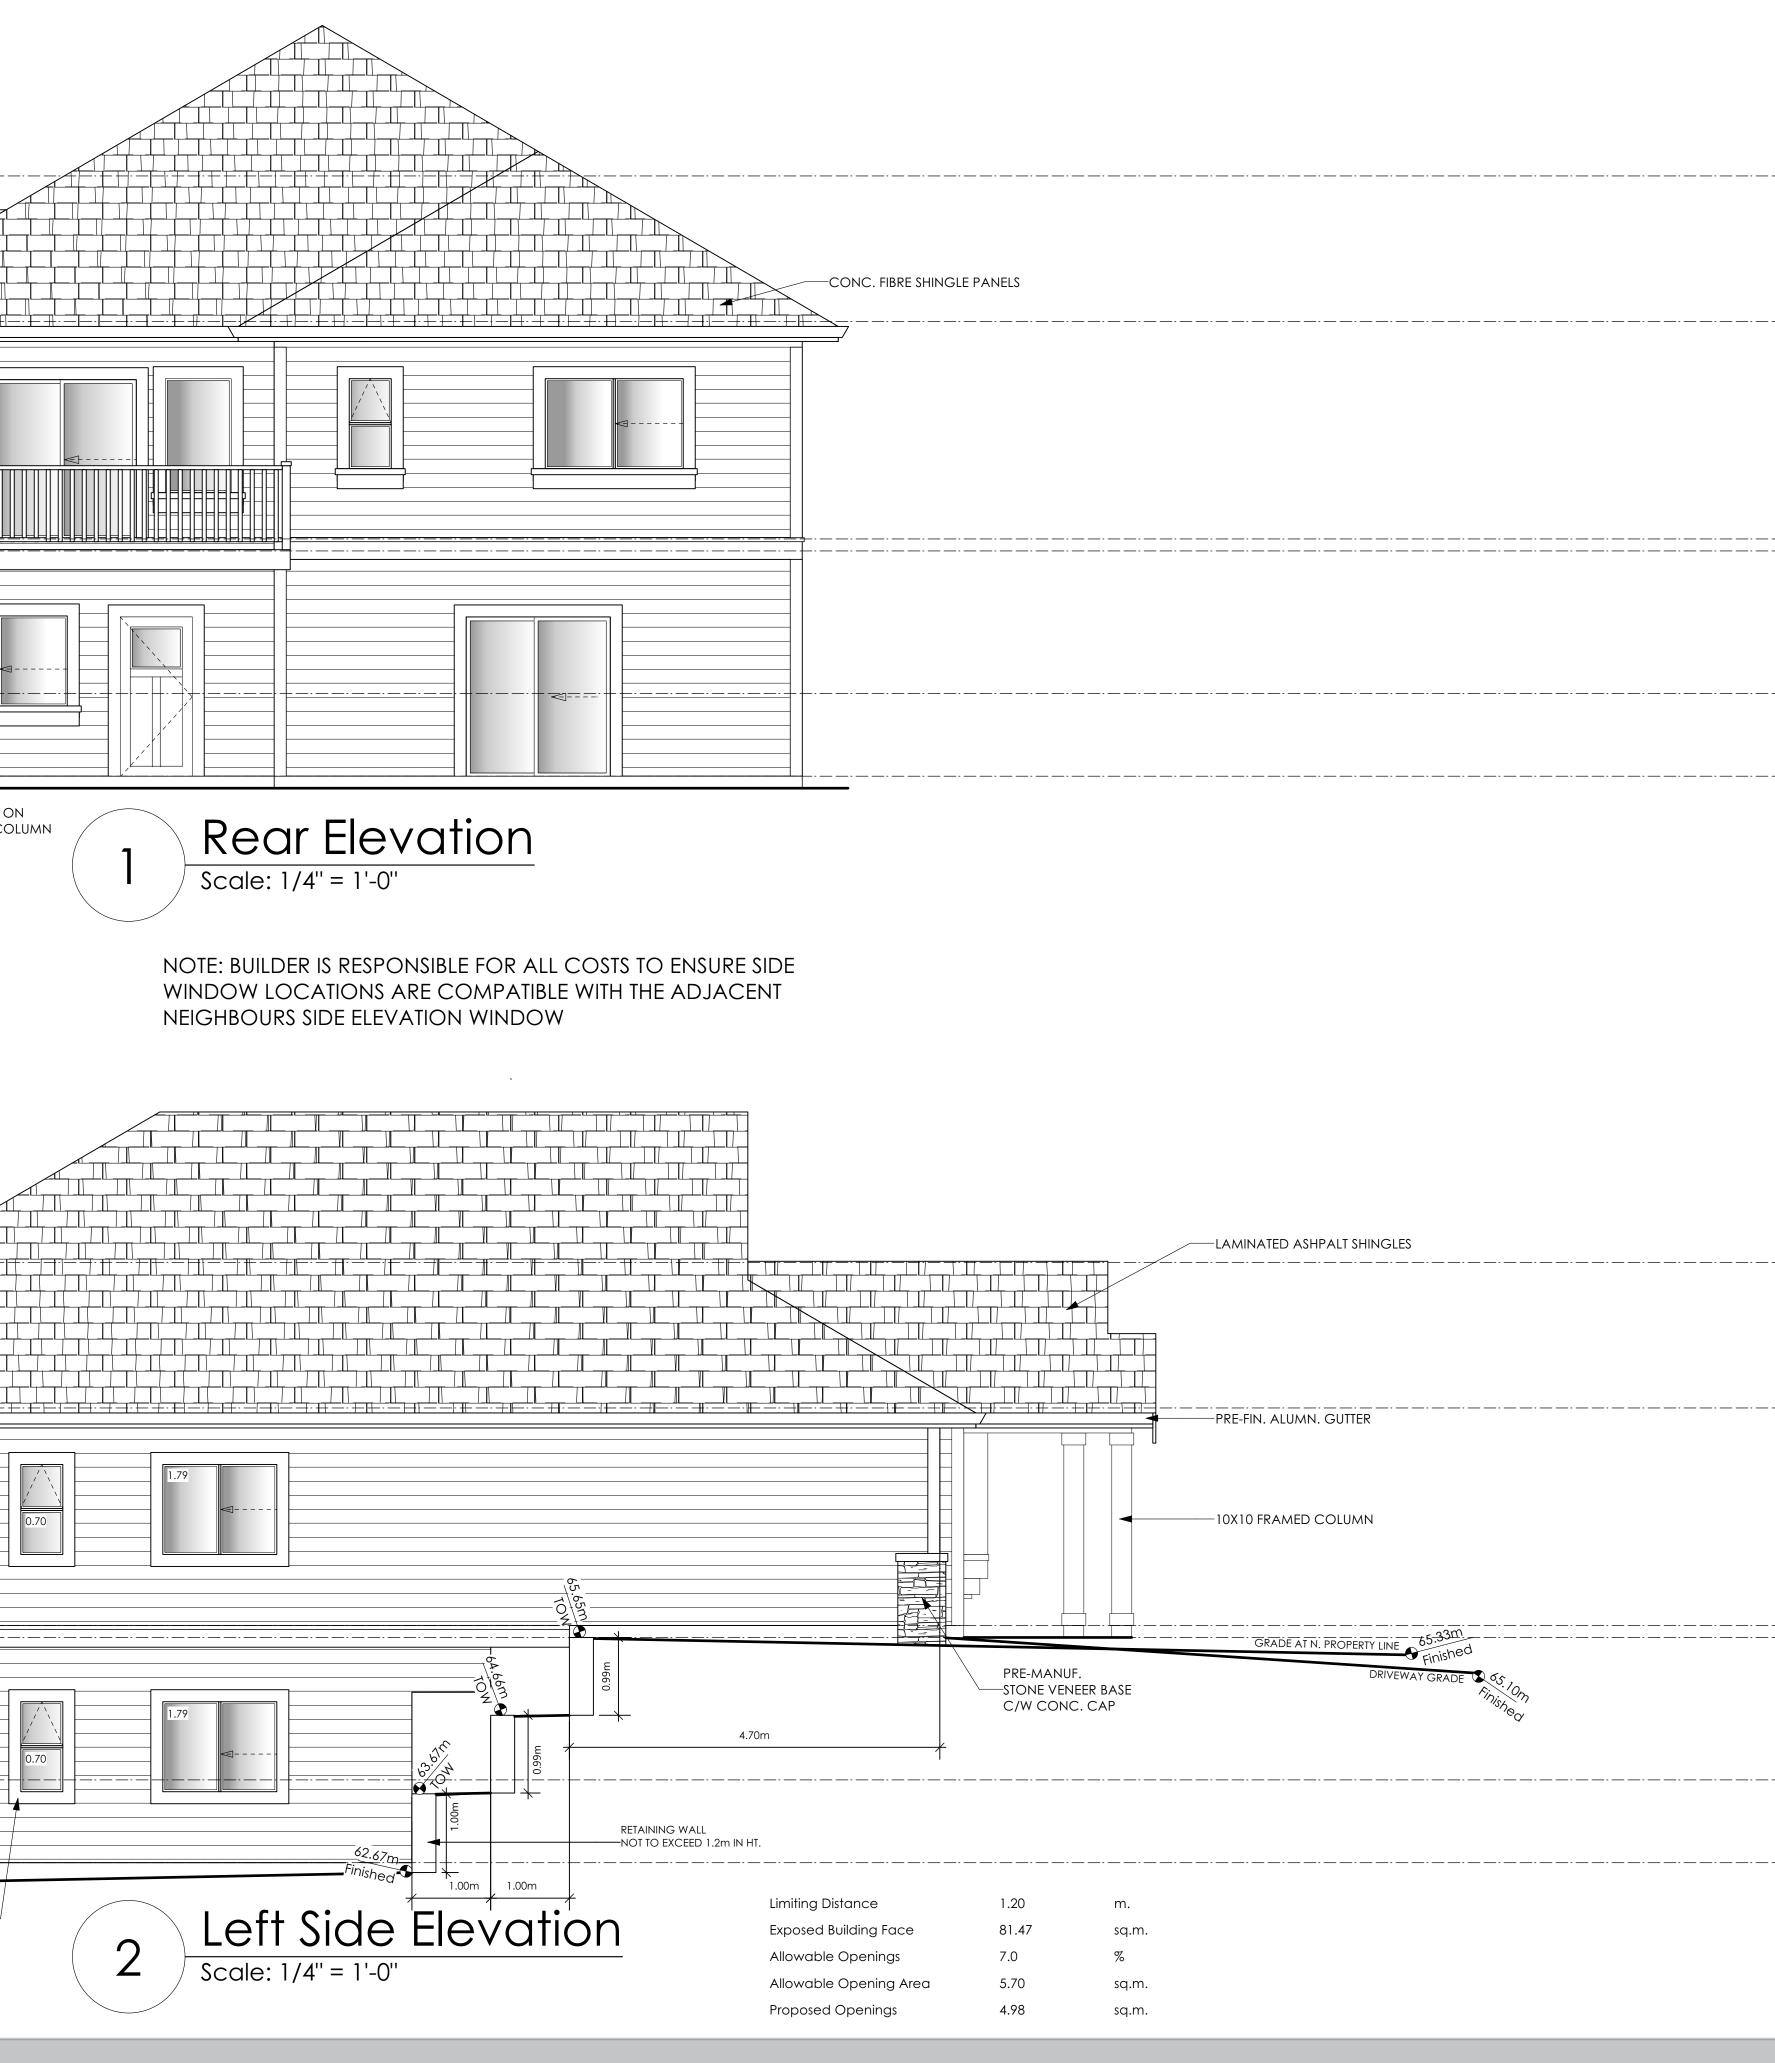
#103 - 891ATTREE AVENUE VICTORIA, B.C. V9B 0A6 P. 250.382.7374 F. 250.382.7364

-LAMINATED ASHPALT SHINGLES _____

-PRE-FIN. ALUMN. GUTTER

-10X10 FRAMED COLUMN

GRADE AT N. PROPERTY LINE

Date Nov 09, 2023


Project Address 3442 TRUMPETER STREET Royal Bay - Sector 7 Colwood, B.C. Prepared for


Verity Construction

Project # 8298-80

Scale As Noted


Drawn By NS

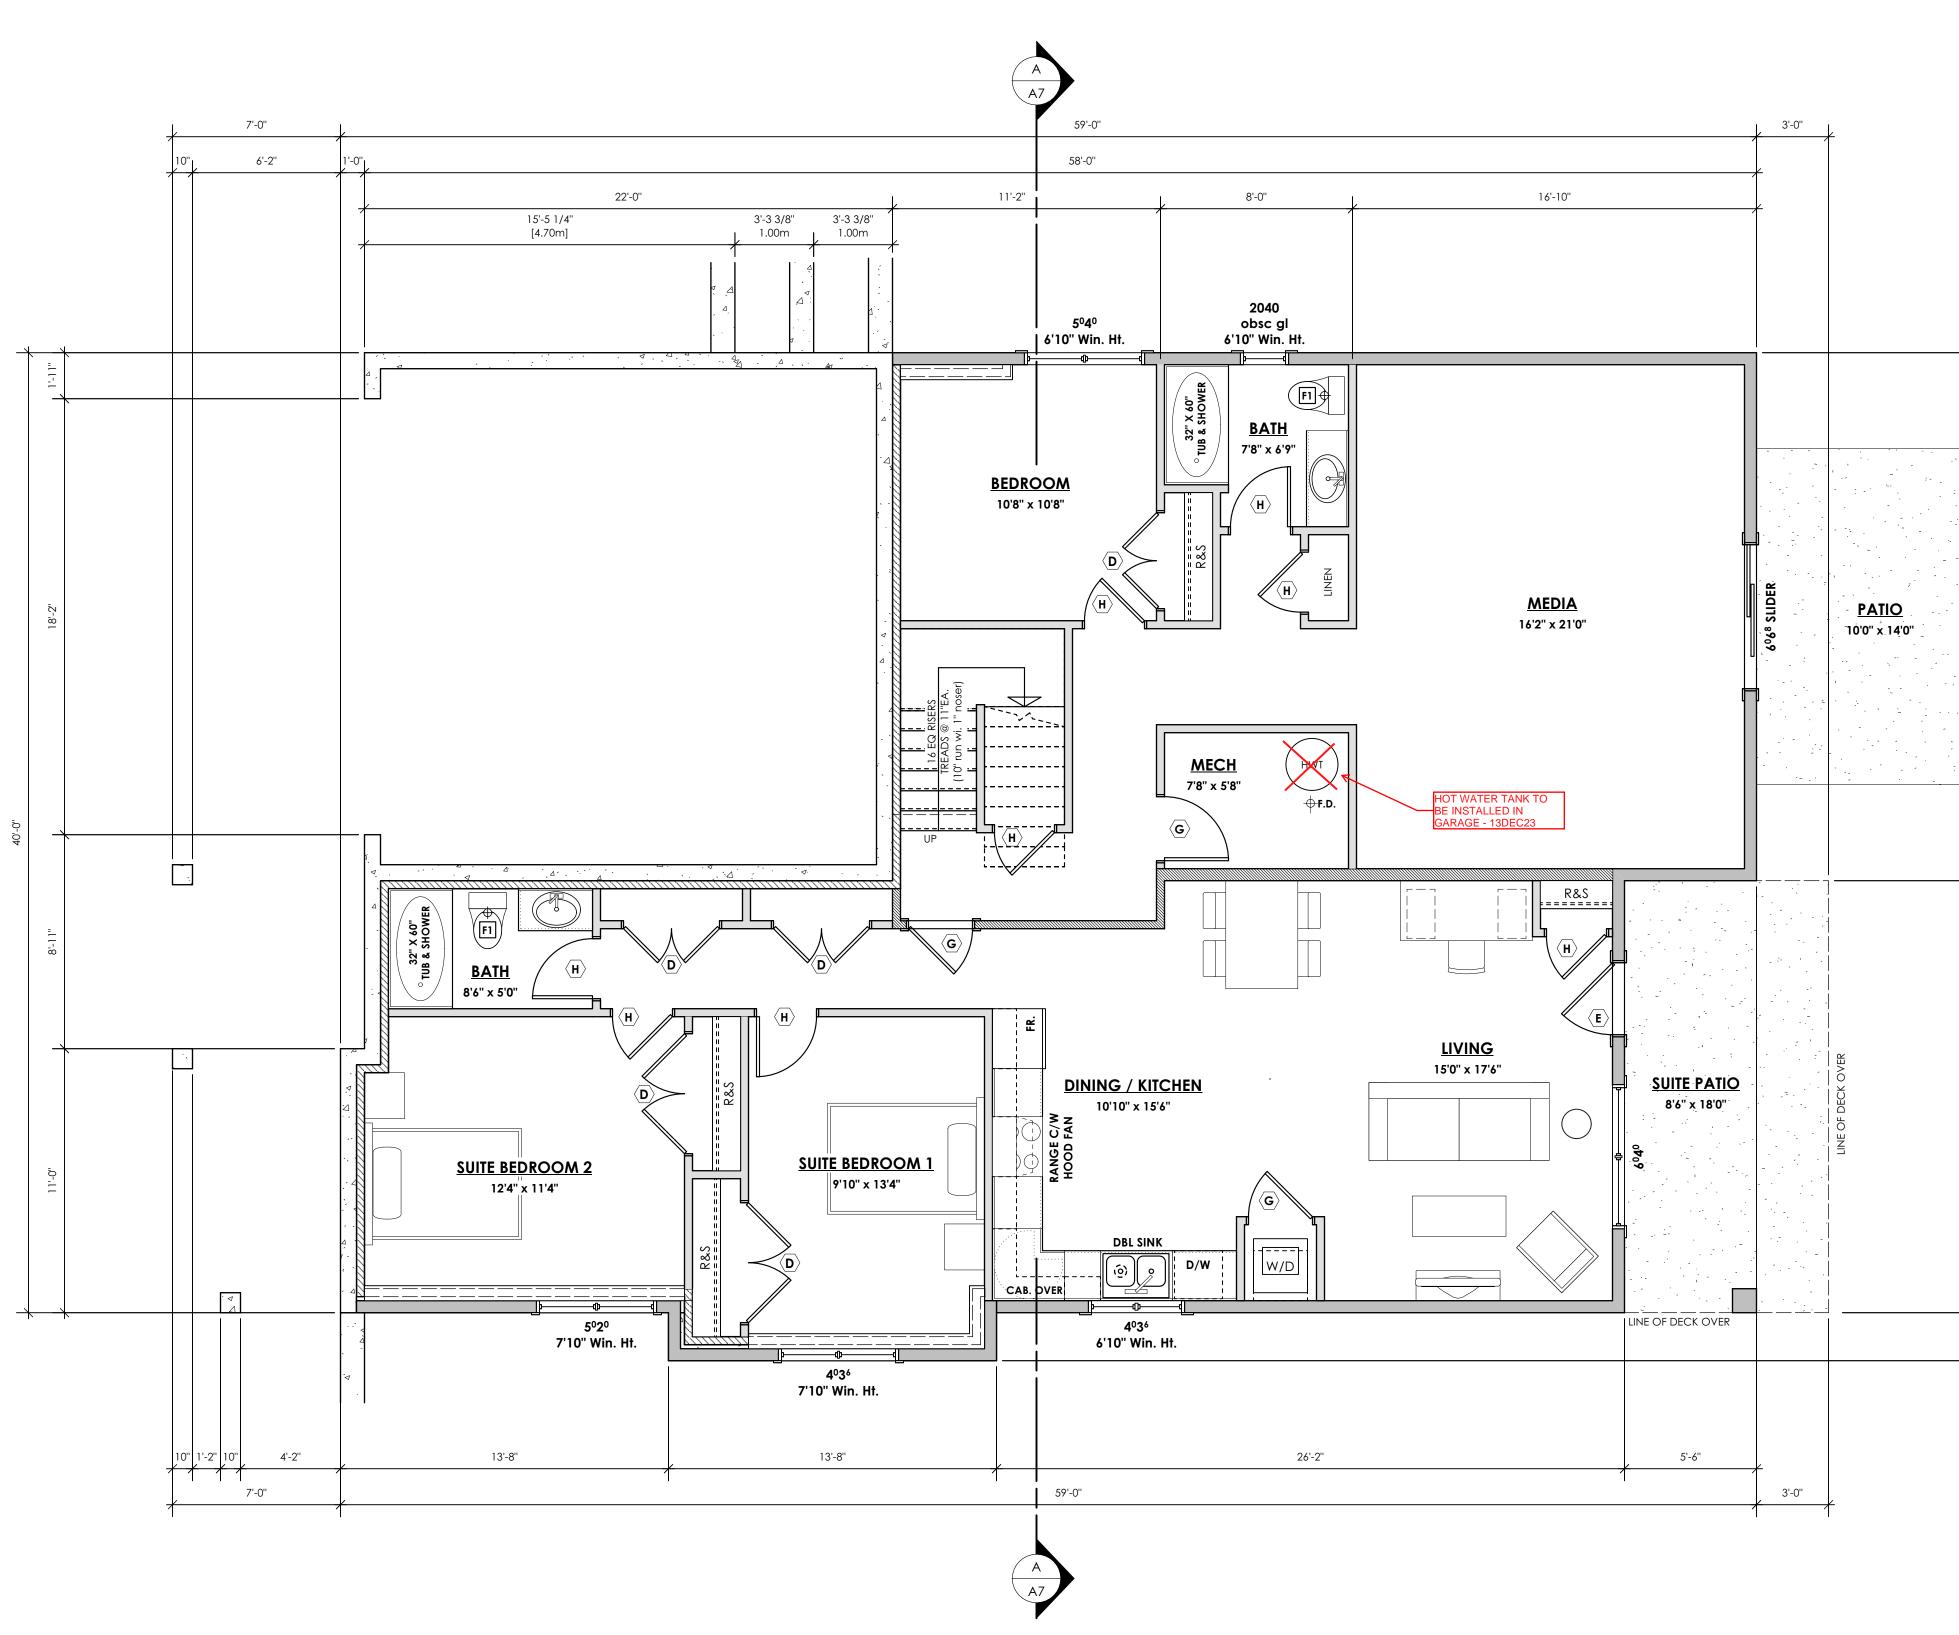

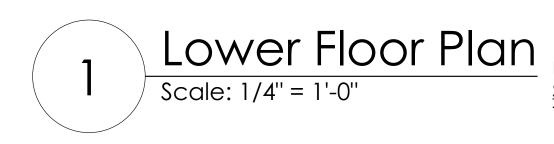

PRIMARY: 807.33 sq.ft. (75.00 sq.m.) <u>SUITE: 955.33 sq.ft. (88.75 sq.m.)</u> TOTAL: 1762.66 sq.ft. (163.75 sq.m.)

Development Permit Presentation

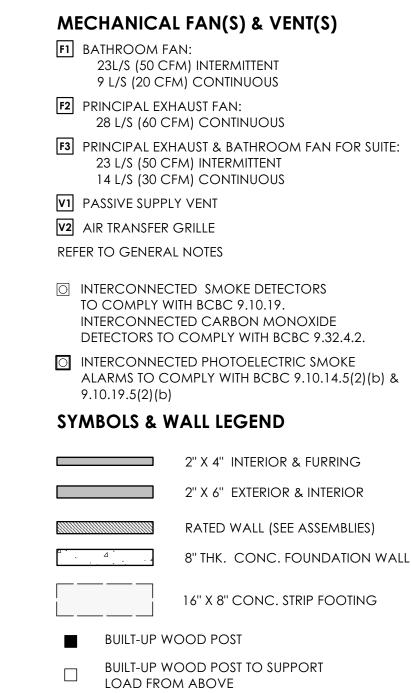

• POINT LOAD ON BEAM FROM ABOVE

VERIFY WINDOW OPERATIONS WITH OWNER

ONE WINDOW PER BEDROOM TO COMPLY WITH BCBC

 $\langle \mathbf{A} \rangle$ 8'0 X 6'8 (96" X 80") $\langle \mathbf{G} \rangle$ 2'8 X 6'8 (32" X 80")

⟨**B**⟩ 6'0 X 6'8 (72" X 80") ⟨**H**⟩ 2'6 X 6'8 (30" X 80") $\langle \mathbf{C} \rangle$ 5'0 X 6'8 (60" X 80") $\langle \mathbf{J} \rangle$ 2'4 X 6'8 (28" X 80")

 $\langle \mathbf{D} \rangle$ 4'0 X 6'8 (48" X 80") $\langle \mathbf{K} \rangle$ 2'0 X 6'8 (24" X 80")

 $\langle E \rangle$ 3'0 X 6'8 (36" X 80") $\langle L \rangle$ 1'6 X 6'8 (18" X 80")

⟨F⟩ 2'10 X 6'8 (34" X 80")

WINDOWS & DOORS

DOOR (EXIT)

PRIOR TO ORDERING

DOOR SCHEDULE



#103 - 891ATTREE AVENUE VICTORIA, B.C. V9B 0A6 P. 250.382.7374 F. 250.382.7364

Date

Nov 09, 2023

Project Address 3442 TRUMPETER STREET Royal Bay - Sector 7 Colwood, B.C. **Prepared for**

Verity Construction

Project #

8298-80

Scale

As Noted

Drawn By NS


þ 9.9.10.1 (EGRESS) FOR BEDROOMS WITHOUT AN EXTERIOR


7'-0'' LINE OF ROOF OVER _____ ·-----HOT WATER TANK · 13DEC23 ωü <u>GARAGE</u> 21'0" x 21'0" 0 A <u>დ</u> ტ GAS TIGHT SEAL WI SELF CLOSING DEVICE -------_____ <u>FOYER</u> 1Q'0" x 7'2" R&S _____ PANTRY 4'4" x 4'0" **BEDROOM** 11'0" x 10'0" 5'-0'' 13'-8" 2'-0''

<u>NOTE</u>:

ALL STRUCTURE TO BE VERIFIED OR DESIGNED BY A STRUCTURAL ENGINEER. STRUCTURAL ENGINEER TO LOCATE AND DESIGN REQUIRED EXTERIOR AND INTERIOR WALL BRACING TO RESIST LATERAL LOADS IN COMPLIANCE WITH B.C. BUILDING CODE 9.23.13. AND SUPPLY DETAILS IF REQUIRED

STRUCTURAL WOOD ELEMENTS WITHIN 150MM (6") FROM FINISHED GROUND LEVEL SHALL BE PRESSURE TREATED WITH A PRESERVATIVE FOR TERMITE AND DECAY PROTECTION B.C.B.C. 9.3.2.9.(3)

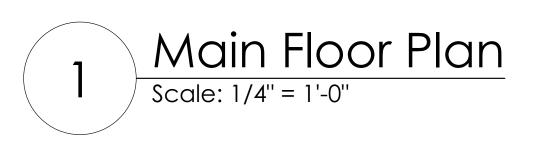

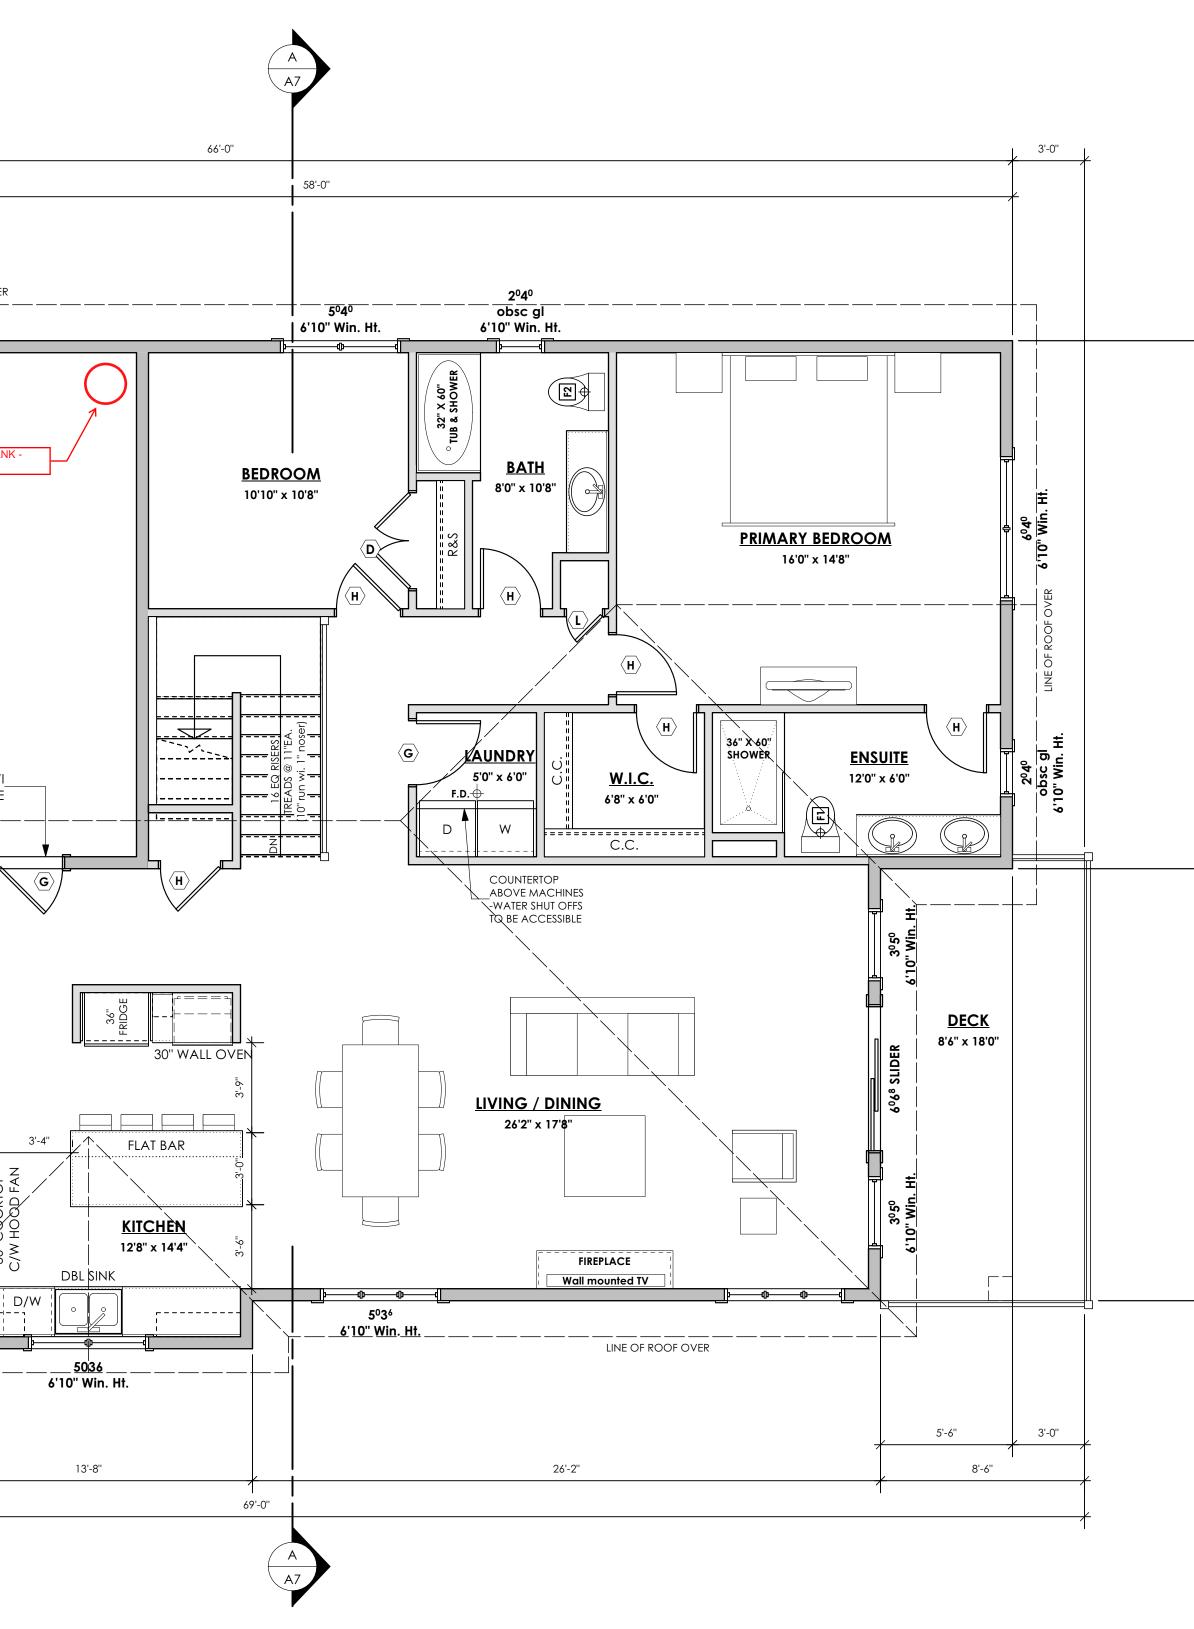

PRIMARY: 1711.97 sq.ft. (159.05 sq.m.) GARAGE: 484.00 sq.ft. (44.96 sq.m.) DECK: 154.00 sq.ft. (14.31 sq.m.)

Development Permit Presentation



- F1 BATHROOM FAN: 23L/S (50 CFM) INTERMITTENT
- 9 L/S (20 CFM) CONTINUOUS
- **F2** PRINCIPAL EXHAUST FAN: 28 L/S (60 CFM) CONTINUOUS
- F3 PRINCIPAL EXHAUST & BATHROOM FAN FOR SUITE: 23 L/S (50 CFM) INTERMITTENT 14 L/S (30 CFM) CONTINUOUS
- **V1** PASSIVE SUPPLY VENT
- **V2** AIR TRANSFER GRILLE
- REFER TO GENERAL NOTES
- INTERCONNECTED SMOKE DETECTORS TO COMPLY WITH BCBC 9.10.19. INTERCONNECTED CARBON MONOXIDE DETECTORS TO COMPLY WITH BCBC 9.32.4.2.
- INTERCONNECTED PHOTOELECTRIC SMOKE ALARMS TO COMPLY WITH BCBC 9.10.14.5(2)(b) & 9.10.19.5(2)(b)

SYMBOLS & WALL LEGEND

2" X 4" INTERIOR & FURRING

2" X 6" EXTERIOR & INTERIOR

- RATED WALL (SEE ASSEMBLIES)

16" X 8" CONC. STRIP FOOTING

8" THK. CONC. FOUNDATION WALL

- BUILT-UP WOOD POST
- BUILT-UP WOOD POST TO SUPPORT
- load from above
- POINT LOAD ON BEAM FROM ABOVE

WINDOWS & DOORS

ONE WINDOW PER BEDROOM TO COMPLY WITH BCBC 9.9.10.1 (EGRESS) FOR BEDROOMS WITHOUT AN EXTERIOR DOOR (EXIT) VERIFY WINDOW OPERATIONS WITH OWNER PRIOR TO ORDERING

DOOR SCHEDULE $\langle \mathbf{F} \rangle = 2'10 \times 6'8 (34'' \times 80'')$

			210 × 00 (34 × 00)	
$\langle \mathbf{A} \rangle$	8'0 X 6'8 (96'' X 80'')	$\langle \mathbf{G} \rangle$	2'8 X 6'8 (32" X 80")	
$\langle \mathbf{B} \rangle$	6'0 X 6'8 (72'' X 80'')	$\langle \mathbf{H} \rangle$	2'6 X 6'8 (30'' X 80'')	
$\langle \mathbf{c} \rangle$	5'0 X 6'8 (60" X 80")	$\langle \mathbf{I} \rangle$	2'4 X 6'8 (28'' X 80'')	
$\langle \mathbf{D} \rangle$	4'0 X 6'8 (48'' X 80'')	$\langle \mathbf{K} \rangle$	2'0 X 6'8 (24'' X 80'')	
$\langle \mathbf{E} \rangle$	3'0 X 6'8 (36" X 80")	$\langle \mathbf{L} \rangle$	1'6 X 6'8 (18'' X 80'')	



#103 - 891ATTREE AVENUE VICTORIA, B.C. V9B 0A6 P. 250.382.7374 F. 250.382.7364

Date

Nov 09, 2023

Project Address 3442 TRUMPETER STREET Royal Bay - Sector 7 Colwood, B.C. **Prepared for**

Verity Construction


Project #


8298-80

Scale

As Noted

Drawn By NS

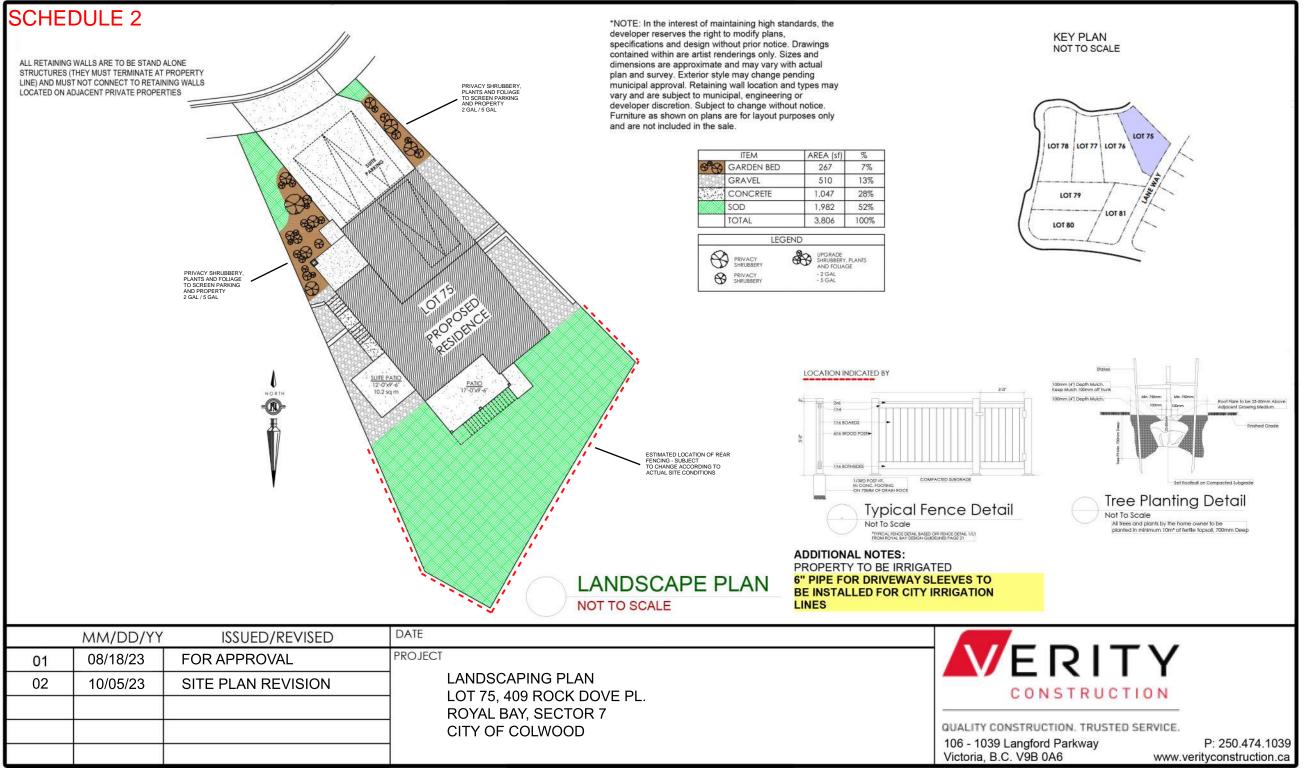

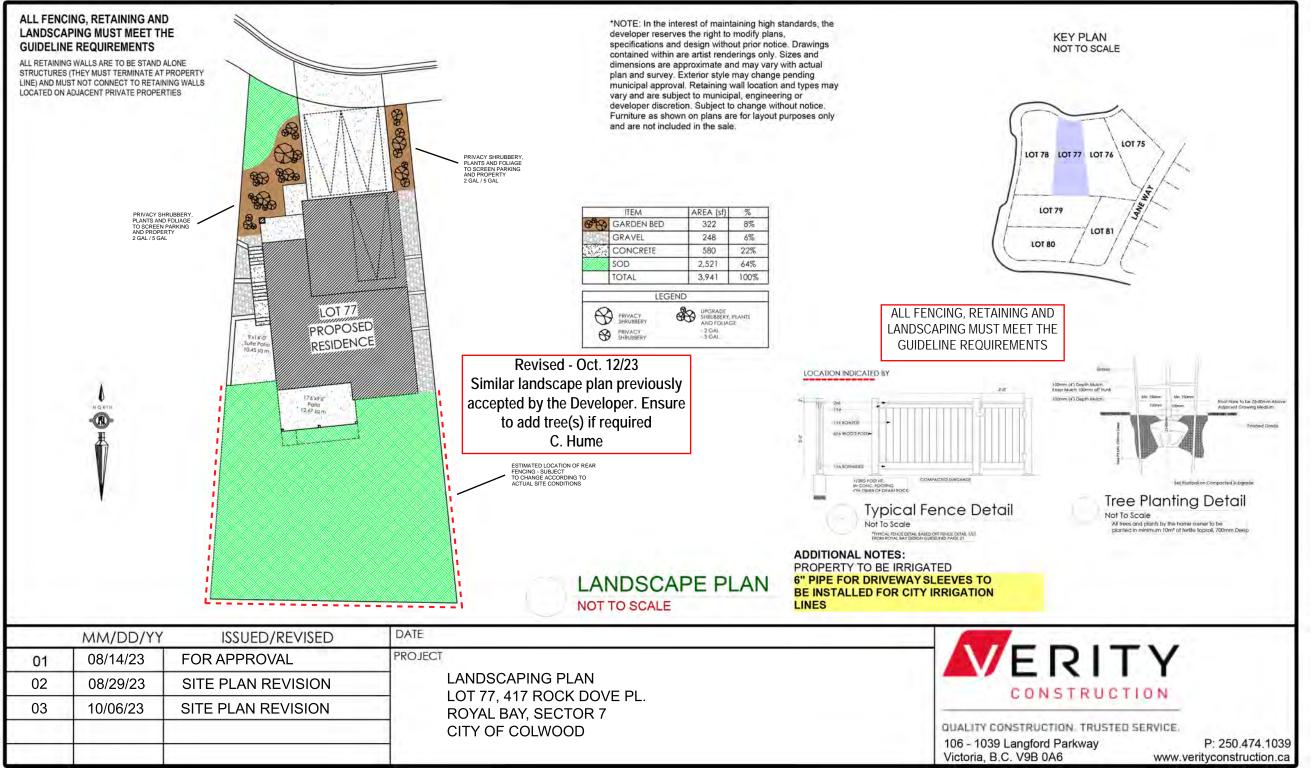

ALL FENCING, RETAINING AND LANDSCAPING MUST MEET THE GUIDELINE REQUIREMENTS

ALL RETAINING WALLS ARE TO BE STAND ALONE STRUCTURES (THEY MUST TERMINATE AT PROPERTY LINE) AND MUST NOT CONNECT TO RETAINING WALLS LOCATED ON ADJACENT PRIVATE PROPERTIES *NOTE: In the interest of maintaining high standards, the developer reserves the right to modify plans, specifications and design without prior notice. Drawings contained within are artist renderings only. Sizes and dimensions are approximate and may vary with actual plan and survey. Exterior style may change pending municipal approval. Retaining wall location and types may vary and are subject to municipal, engineering or developer discretion. Subject to change without notice. Furniture as shown on plans are for layout purposes only and are not included in the sale.

ITEM

GRAVEL

SOD

TOTAL

CONCRETE

9120


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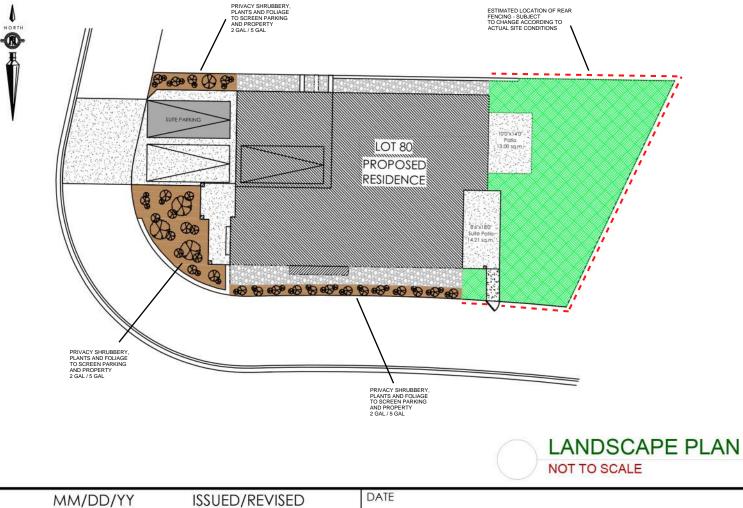
GARDEN BED

KEY PLAN NOT TO SCALE

> 100mm (41) Depth Mulch. Keep Mulch 100mm off Trunk

100mm (4") Depth Mulch.



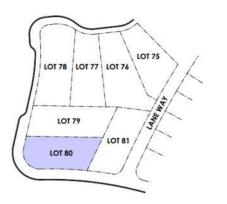

2	Th.	2x6 1x4 1x6 BOARDS	-		
2-0		6X6 WOOD POST-			
		1x6 BOTHSIDES			
		1/3RD POI IN CONC. ON 75MM		MPACTED SUBGRADE	

AREA (s

506

396

915

1,408

3,225

UPGRADE SHRUBBERY, PLANTS AND FOLIAGE

- 2 GAL - 5 GAL

LEGEND

%

15.7%

12.3%

28.4%

43.6%

100%

Broked Crock Set Booked to Compacted Subgrode Tree Planting Detail Not To Scale All frees and plants by the home owner to be

planted in minimum 10m² of tertile topsoil, 700mm Deep

Root Flare to be 25-30mm Above Adjacent Growing Medium

Mn. 750mm

PLAN BE INSTALLED FOR CRIVEN

PROPERTY TO BE IRRIGATED 6" PIPE FOR DRIVEWAY SLEEVES TO BE INSTALLED FOR CITY IRRIGATION LINES

	MM/DD/YY	ISSUED/REVISED	DATE					
01	10/20/23	FOR APPROVAL	PROJECT					
02	11/03/23	SITE PLAN REVISION	LANDSCAPING PLAN LOT 80, 3442 TRUMPETER ST.	CONSTRUCTION				
			ROYAL BAY, SECTOR 7					
			CITY OF COLWOOD	QUALITY CONSTRUCTION. TRUSTED SERVICE.				
				106 - 1039 Langford ParkwayP: 250.474.1039Victoria, B.C. V9B 0A6www.verityconstruction.ca				

