

## CITY OF COLWOOD

3300 Wishart Road | Colwood | BC V9C 1R1 | 250-294-8153 planning@colwood.ca | www.colwood.ca

File: DP-23-013

## DEVELOPMENT PERMIT DP-23-013

THIS PERMIT, issued August 2023 is,

ISSUED BY:

CITY OF COLWOOD, a municipality incorporated under the Local Government Act,

3300 Wishart Road, Victoria, BC, V9C 1R1

(the "City")

PURSUANT TO:

Section 490 of the Local Government Act, RSBC 2015, Chapter 1

ISSUED TO:

Verity Construction LTD. 106-1039 Langford Parkway

Victoria, BC V8B 0A5

(the "Permittee")

 This Form & Character Development Permit applies to those lands within the City of Colwood described below, and any and all buildings, structures, and other development thereon:

> Lots 56 - 61, 63 & 64 Plan EPP117070, Section 38, Esquimalt Land District 3485, 3482, 3480, 3478, 3476, 3474, 3470 & 3468 Trumpeter Street

> > (the "Lands")

- This Development Permit regulates the development and alterations of the Land, and supplements
  the "Colwood Land Use Bylaw, 1989" (Bylaw No. 151), to ensure the form & character
  considerations for a single family home with secondary suite and associated site improvements are
  consistent with the guidelines for areas designated as "Intensive Residential" in the City of Colwood
  Official Community Plan (Bylaw No. 1700).
- This Development Permit is NOT a Building Permit or a subdivision approval.
- This Development Permit is issued subject to compliance with all of the bylaws of the City of Colwood that apply to the development of the Lands, except as specifically varied by Council or supplemented by this Permit including DP-21-008.

- 8.3. Any future additions of telecommunications antennas or equipment to the exterior of the buildings and/or structures included in this Permit shall be architecturally integrated into the buildings and/or structures they are mounted on or screened from views so as not to be visually obtrusive, to the satisfaction of the Director of Development Services.
- 8.4. No future construction/installation of unenclosed or enclosed outdoor storage areas, and recycling/refuse collection and storage areas shall be undertaken without the issuance of a further Development Permit or amendment to this Permit.
- 8.5. All mechanical roof elements, including mechanical equipment, elevator housings, and vents shall be visually screened with sloped roofs or parapets, or other forms of solid screening to the satisfaction of the Director of Development Services.

### Landscaping

8.6. The design and construction of the proposed landscaping shall be in substantial compliance with the Landscape Plan prepared by Verity Construction (Schedules 2-9).

### Grading

- 8.7. As required by Covenant CA9828107 registered on title, a geotechnical memo was prepared to assess lots where the horizontal distance between the building setback and the foot of the retaining wall was less than 5m. Recommendations from the memo must be followed (Schedule 1).
- Lot preparations shall be in compliance with site-specific grading plans prepared by Gablecraft Homes (Schedules 2-9).
- 8.9. All cut and fill expectations must be in substantial compliance with the Site Sections prepared by Victoria Design Group (Schedules 2-9).
- 8.10. Retaining walls are not to connect with neighbouring properties and be a maximum height of 1.2m.

ISSUED ON THIS 4-DAY OF AUGUST, 2023.

Yazmin Hernandez

Director of Development Services



MGE Services Inc.

EGBC Permit to Practice No. 1003085

740 Cowper Street, Victoria, BC V9A 2E9 250-661-8335
MGEservices@shaw.ca

July 12, 2023 File: 23V-003

Verity Construction Ltd. 106-1039 Langford Parkway Victoria, BC V9B 0A5

Attention: Ms. Patricia Gomes

RE: Proposed House Construction

Lots 56-61, 63 & 64, Sector 7, Royal Bay (Trumpeter St. & Rock Dove Pl.), Colwood

**Geotechnical Assessment Report** 

### INTRODUCTION

As requested by Verity Construction Ltd. (the Client), MGE Services Inc. (MGE) has carried out a geotechnical assessment for eight lots within the residential subdivision at the above-referenced site. The site was developed as part of the Royal Bay subdivision in Colwood, BC. Review of the Geotechnical

Assessment Report for the Sector 7 Subdivision where the subject lots are located (prepared by Thurber Engineering Ltd. (Thurber) dated February 4, 2022) was carried out as part of our site review. This geotechnical report has been prepared as part of the development permit application specifically for Lots 56 to 61, 63 and 64 within Sector 7 at the Royal Bay subdivision in Colwood.

The Royal Bay subdivision is located within a former gravel pit within the Colwood Outwash deposit. The subgrade within the subject sites consist of well-graded, pit run sand and gravel that was placed as part of the gravel pit reclamation following closure in 2008. MGE conducted site walkover of the subject lots in early July 2023, at which time the lots were graded approximately level with slopes and/or existing boulder walls at the rear of the sites. Grading of the existing slopes/walls was prepared by the developer of the Royal Bay subdivision, which is proposed to be altered by the Client to achieve the house designs prepared for the subject lots.

MGE has conducted visual review of the subject lots, as documented in the attached Table 1 – Site Photos. The lot layout is shown in the attached Comprehensive Site Plan provided by the Client, with cross sections of the final grading on Lots 56, 57, 58 and 63 (where existing retaining walls are located within 5m of the proposed house sites) also attached to this report. This geotechnical assessment has been prepared in support of the development permit application prepared by the Client for single family houses to be constructed on the eight subject lots.

## PROJECT / SITE CONDITIONS

The proposed development includes eight detached, single family homes that will be constructed with slab-on-grade foundations and with either full or partial step up backyards. Due to the grading, which

July 12, 2023 File: 23V-003

slopes down at the rear of the lots, the houses are to be constructed with foundation walls increased to provide support for backyards. The existing boulder walls on Lots 56, 57 and 58 will be backfilled as part of the final grading, as shown in their cross sections attached to this report. The retaining walls on Lots 63 and 64 are to remain as constructed in their rear yards. It is noted that the wall on Lot 64 is beyond 5m from the house, which meets the guideline established by Thurber. These walls are constructed to a maximum height of 1.2m, as per City of Colwood requirements. Backfilling of the walls was observed to be pit run sand and gravel that is free-draining and suitable for positive drainage.

Our review of open excavations onsite indicate that the lots are underlain by dense, native sand and gravel, which is consistent with the local geology mapping that shows the site to be within the Colwood Outwash deposit. The surface of the pit run sand and gravel has been disturbed since initial subdivision development and will require further site preparation, as per recommendations provided herein.

### GEOTECHNICAL RECOMMENDATIONS

Based on our review of the subsurface conditions, the development of eight single family houses is considered geotechnically appropriate. The native sand and gravel is considered suitable for providing bearing of the house foundations and associated retaining walls. It is recommended that building foundation design be based on a 100 kPa allowable bearing capacity, as determined by independent calculations. The sand and gravel subgrade is expected to require re-compaction, which is recommended to be carried out with a 10 tonne, steel drum, vibratory roller. MGE should be contacted to carry out review of the sand and gravel subgrade prior to foundation construction or structural filling, as needed by final grading.

If structural filling is required, the excavated sand and gravel material from the site is considered suitable for re-use based on past experience with the Colwood Outwash deposit. It is recommended that the sand and gravel is placed in maximum 300mm thickness lifts and thoroughly compacted with the vibratory roller. The extent of structural filling should be outside the building footprint or road alignment by at least the thickness of the fill, ie. a 1H:1V splay. As per the BC Building Code, MGE needs to carry out continuous monitoring of structural fill placement procedures to provide subgrade approval for the building foundations.

As discussed above, re-grading at the rear of the lots, specifically Lots 56 to 58 will be carried out following foundation construction and is shown in the Cross Sections attached to this report. It is not proposed to construct new retaining walls on the eight subject lots. If grading does require new wall construction, MGE can provide retaining wall design to meet City of Colwood bylaw requirements.



## MGE Services Inc.

EGBC Permit to Practice No. 1003085

740 Cowper Street, Victoria, BC V9A 2E9 250-661-8335

MGEservices@shaw.ca

### CLOSURE

Our geotechnical assessment of the project site and the proposed development indicates that the lands are considered safe and suitable for the use intended. MGE to carry out field reviews during site preparation to confirm the intent of our geotechnical recommendations is met.

July 12, 2023

File: 23V-003

This letter has been prepared exclusively for Verity Construction Ltd. in accordance with the January 3, 2023 contract between MGE and Verity Construction Ltd. No third party can rely on this report, except for the City of Colwood, which is considered to be an authorized user, subject to the terms and conditions under which the work was completed.

We trust this meets your current requirements and ask that you contact the undersigned if there are any questions or concerns.

Yours truly,

MGE Services Inc.

Per: Alec Morse, P.Eng.

Attach: Table 1 – Site Photos Comprehensive Site Plan

Cross Sections – Lots 56, 57, 58 & 63



## Table 1 – Site Photos Project: Lots 56-61, 63 & 64, Royal Bay, Sector 7

Verity Construction Ltd. File: 23V-003



July 4, 2023: Current condition of Lot 56, with boulder wall above cut slope in pit run sand and gravel, which will also compose subgrade.



July 4, 2023: Current condition of Lot 57, with boulder wall founded on pit run sand and gravel, which will also compose subgrade.



July 4, 2023: Current condition of Lot 58, with boulder wall founded on pit run sand and gravel, which will compose subgrade.



July 4, 2023: Current condition of Lot 59, with pit run sand and gravel exposed as subgrade.




July 4, 2023: Current condition of Lot 60, with pit run sand and gravel exposed as subgrade.




July 4, 2023: Current condition of Lot 61, with pit run sand and gravel exposed as subgrade.



Table 1 – Site Photos Project: Lots 56-61, 63 & 64, Royal Bay, Sector 7 Verity Construction Ltd. File: 23V-003

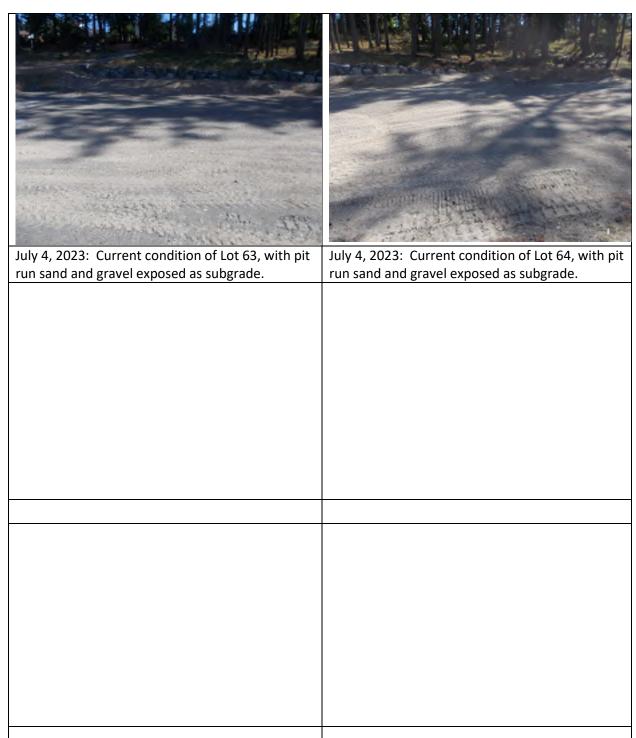

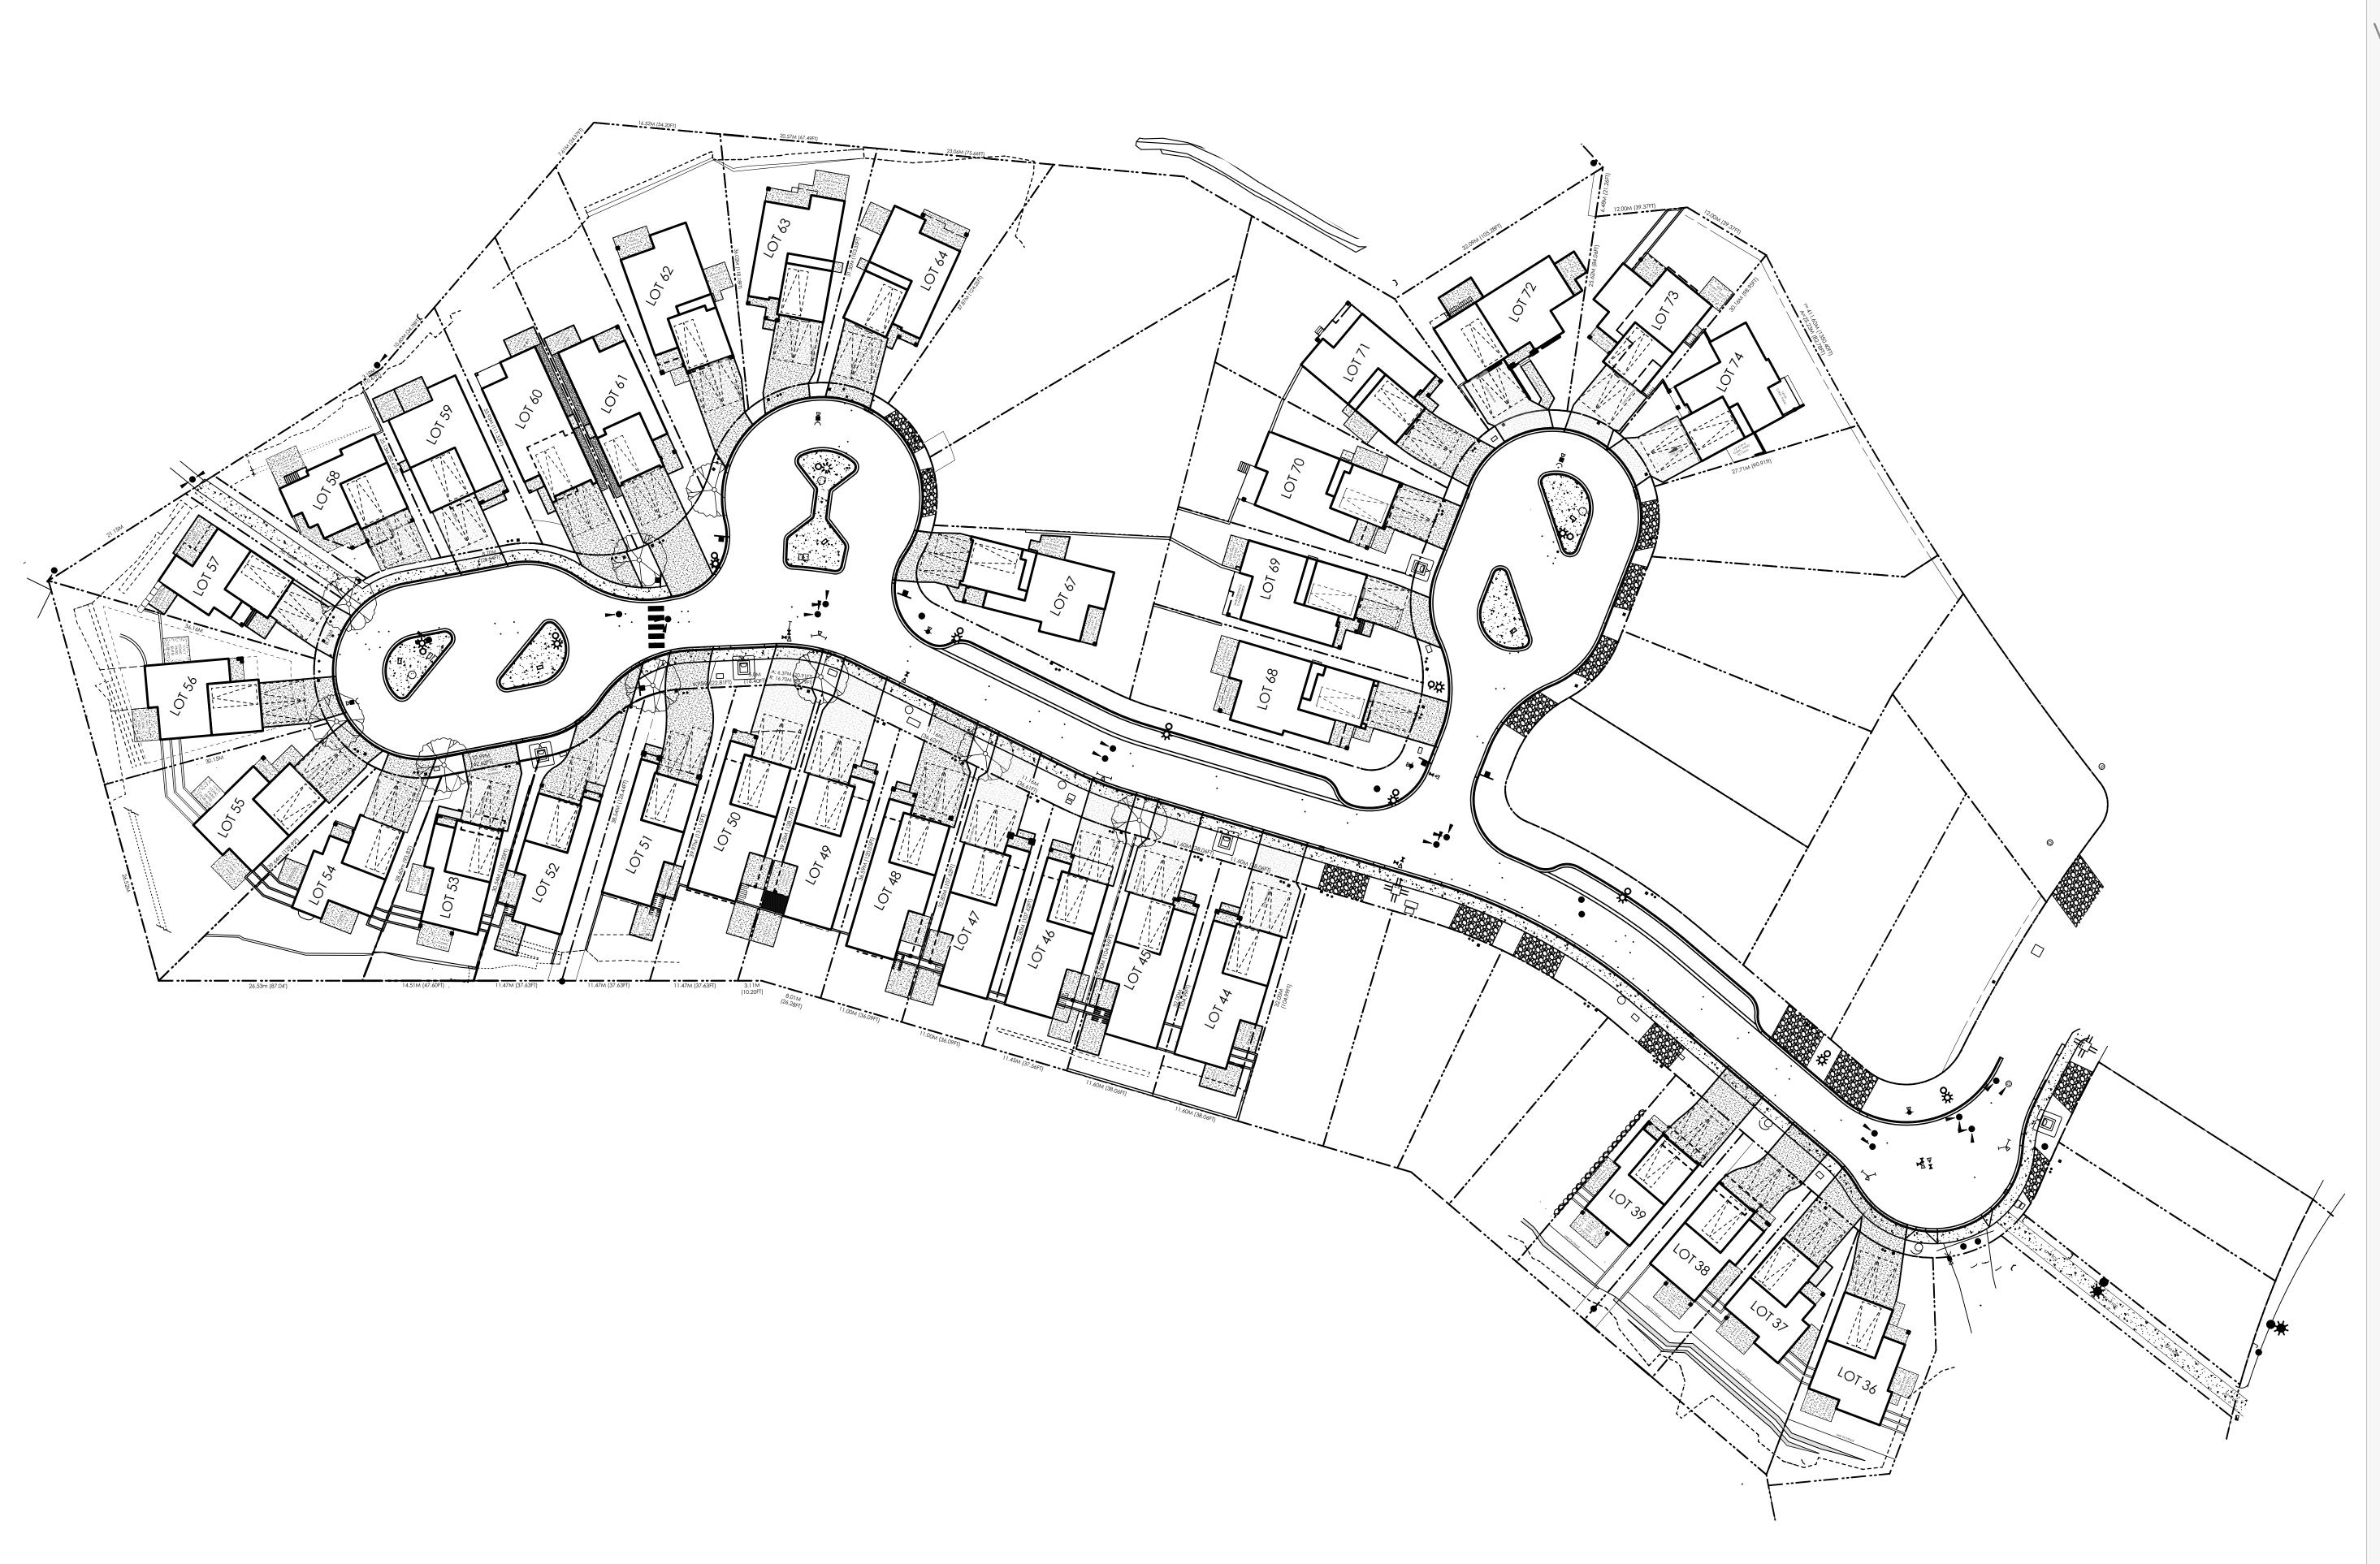

volvictoria 9 design group

#103 - 891 ATTREE AVENUE VICTORIA, B.C. V9B 0A6 P. 250.382.7374 F. 250.382.7364

Date

June 12 2023

Project Address

Royal Bay Sector 7 Colwood, B.C.

Prepared for Verity Construction

**D** • 1 "


**Project #** 8298-Sector 7

Scale

1:350

Drawn By
MDK/MRB


Comprehensive Site Plan

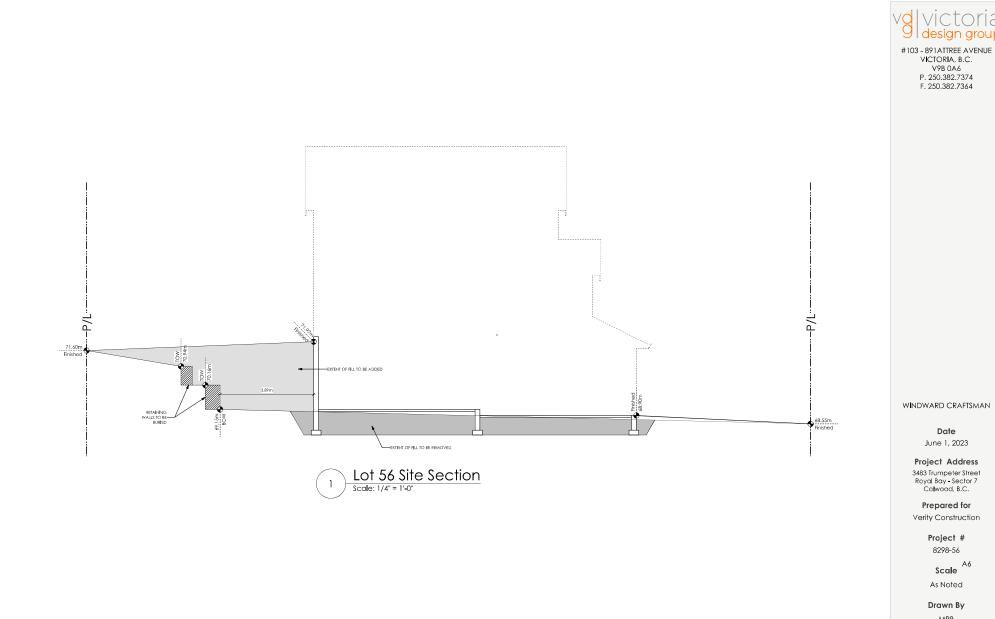

MRB



#103 - 891ATTREE AVENUE VICTORIA, B.C. V9B 0A6 P. 250.382.7374 F. 250.382.7364

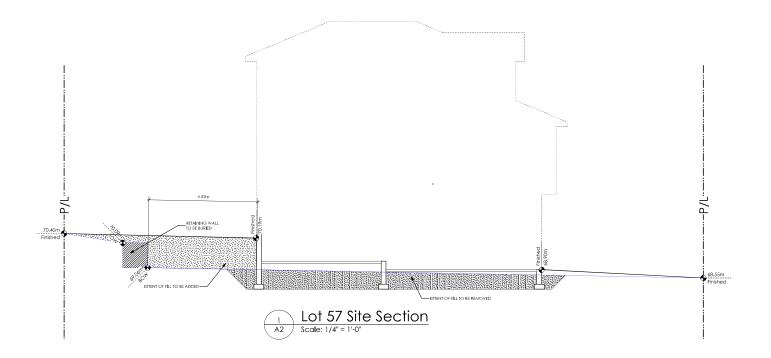

GENOA TRAD**ITI**ONAL

Date

June 29, 2023

Project Address 3482 Trumpeter Street Royal Bay - Sector 7 Colwood, B.C. Prepared for

Verity Construction

Project #


8298-57

Scale

As Noted

Drawn By

MDK

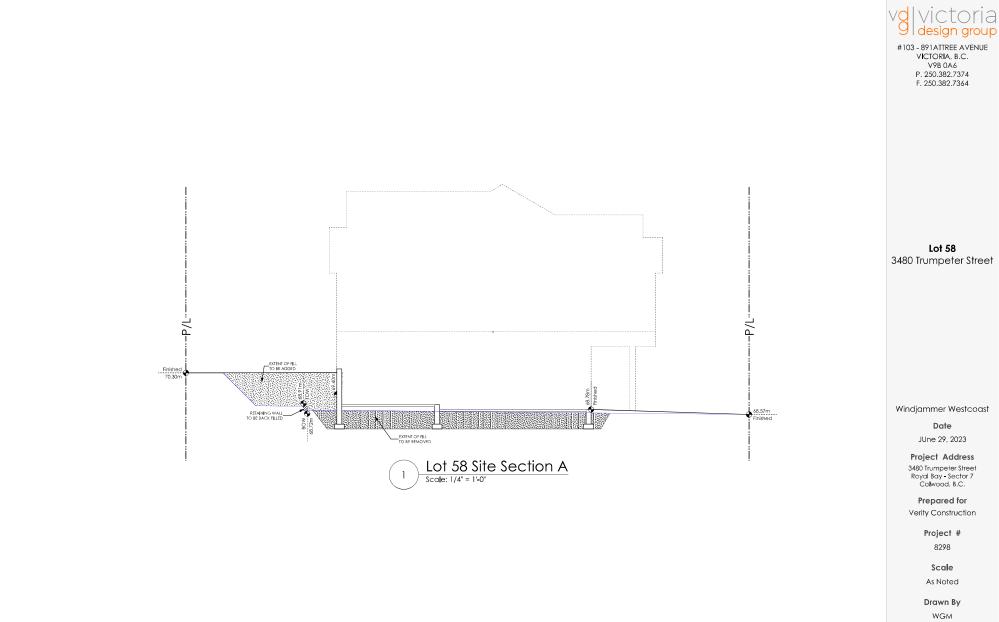

3480 Trumpeter Street



#103 - 891ATTREE AVENUE VICTORIA, B.C. V9B 0A6 P. 250.382.7374 F. 250.382.7364



'FLEMMING' CRAFTSMAN

Date

July 11, 2023

Project Address Royal Bay Sector 7 Verity Construction 3470 Trumpeter Street Lot 63

Colwood, B.C.


Prepared for

Verity Construction

Project # 8298-63

**Scale** Not to Scale

Drawn By MRB

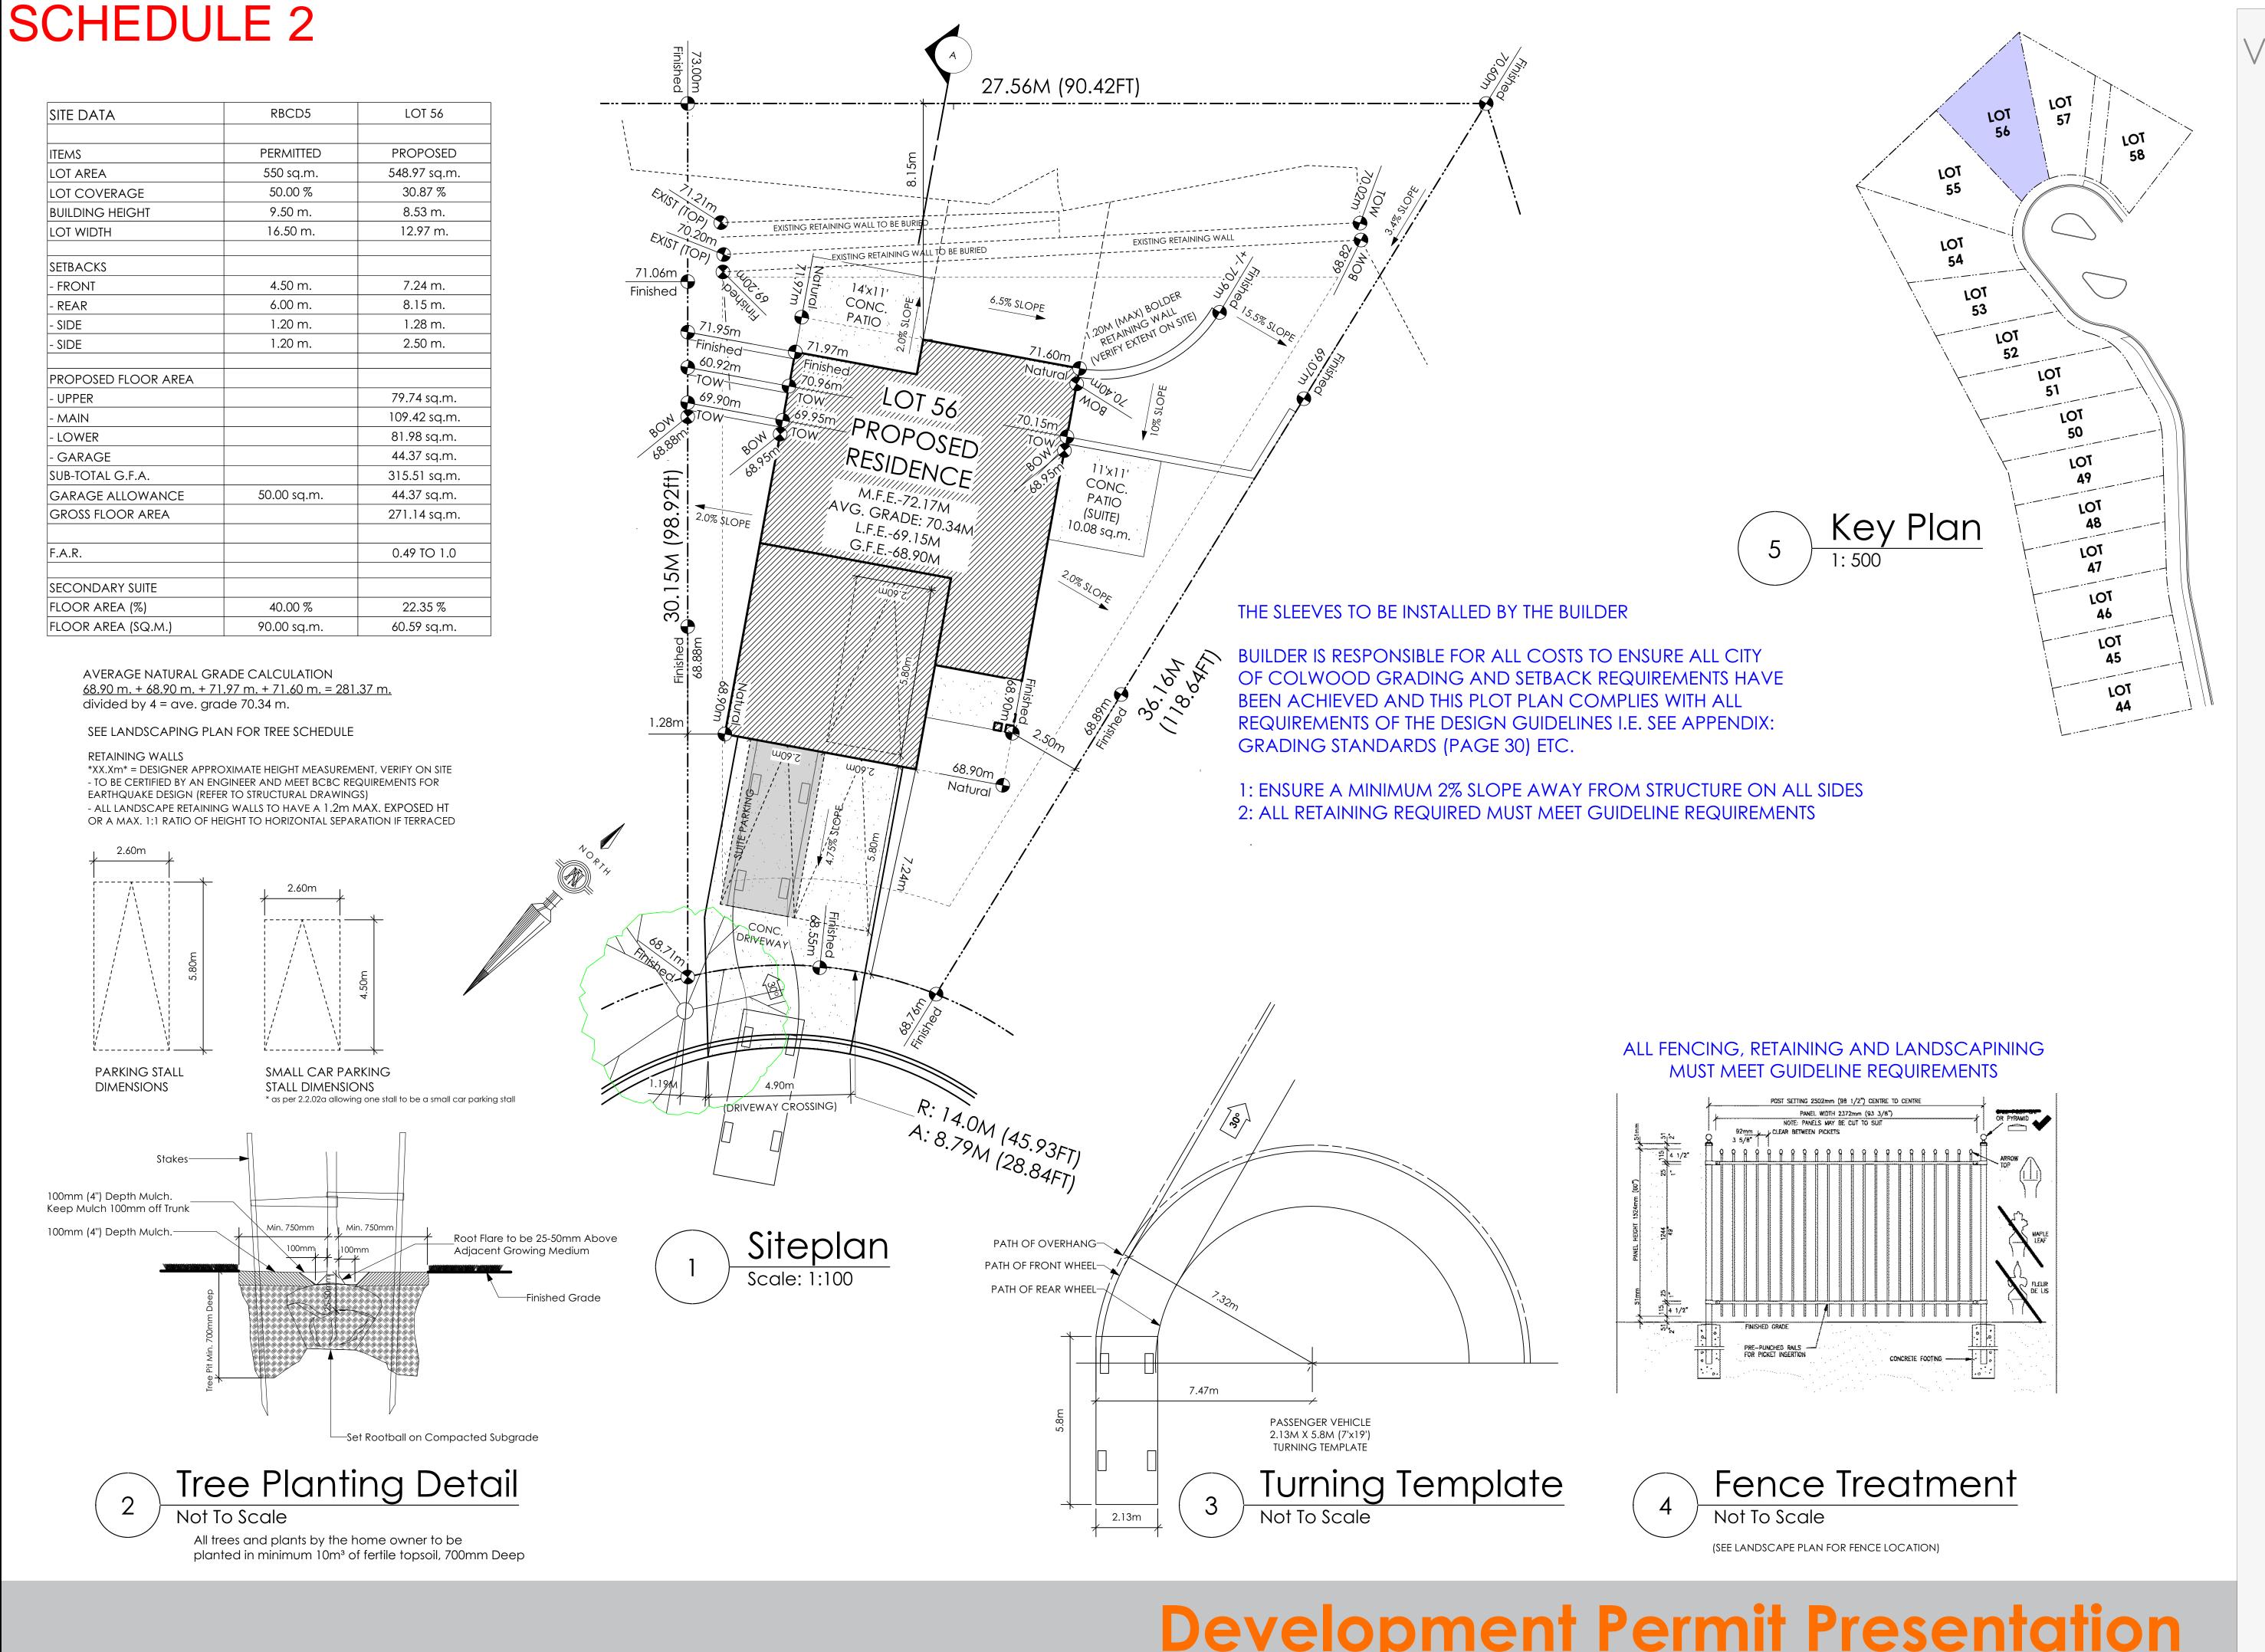

#103 - 891ATTREE AVENUE VICTORIA, B.C. V9B 0A6 P. 250.382.7374 F. 250.382.7364

WINDWARD CRAFTSMAN

Date

June 1, 2023

**Project Address** 

3483 Trumpeter Street Royal Bay - Sector 7 Colwood, B.C.

Prepared for Verity Construction


> Project # 8298-56


Scale

As Noted

Drawn By

MRB

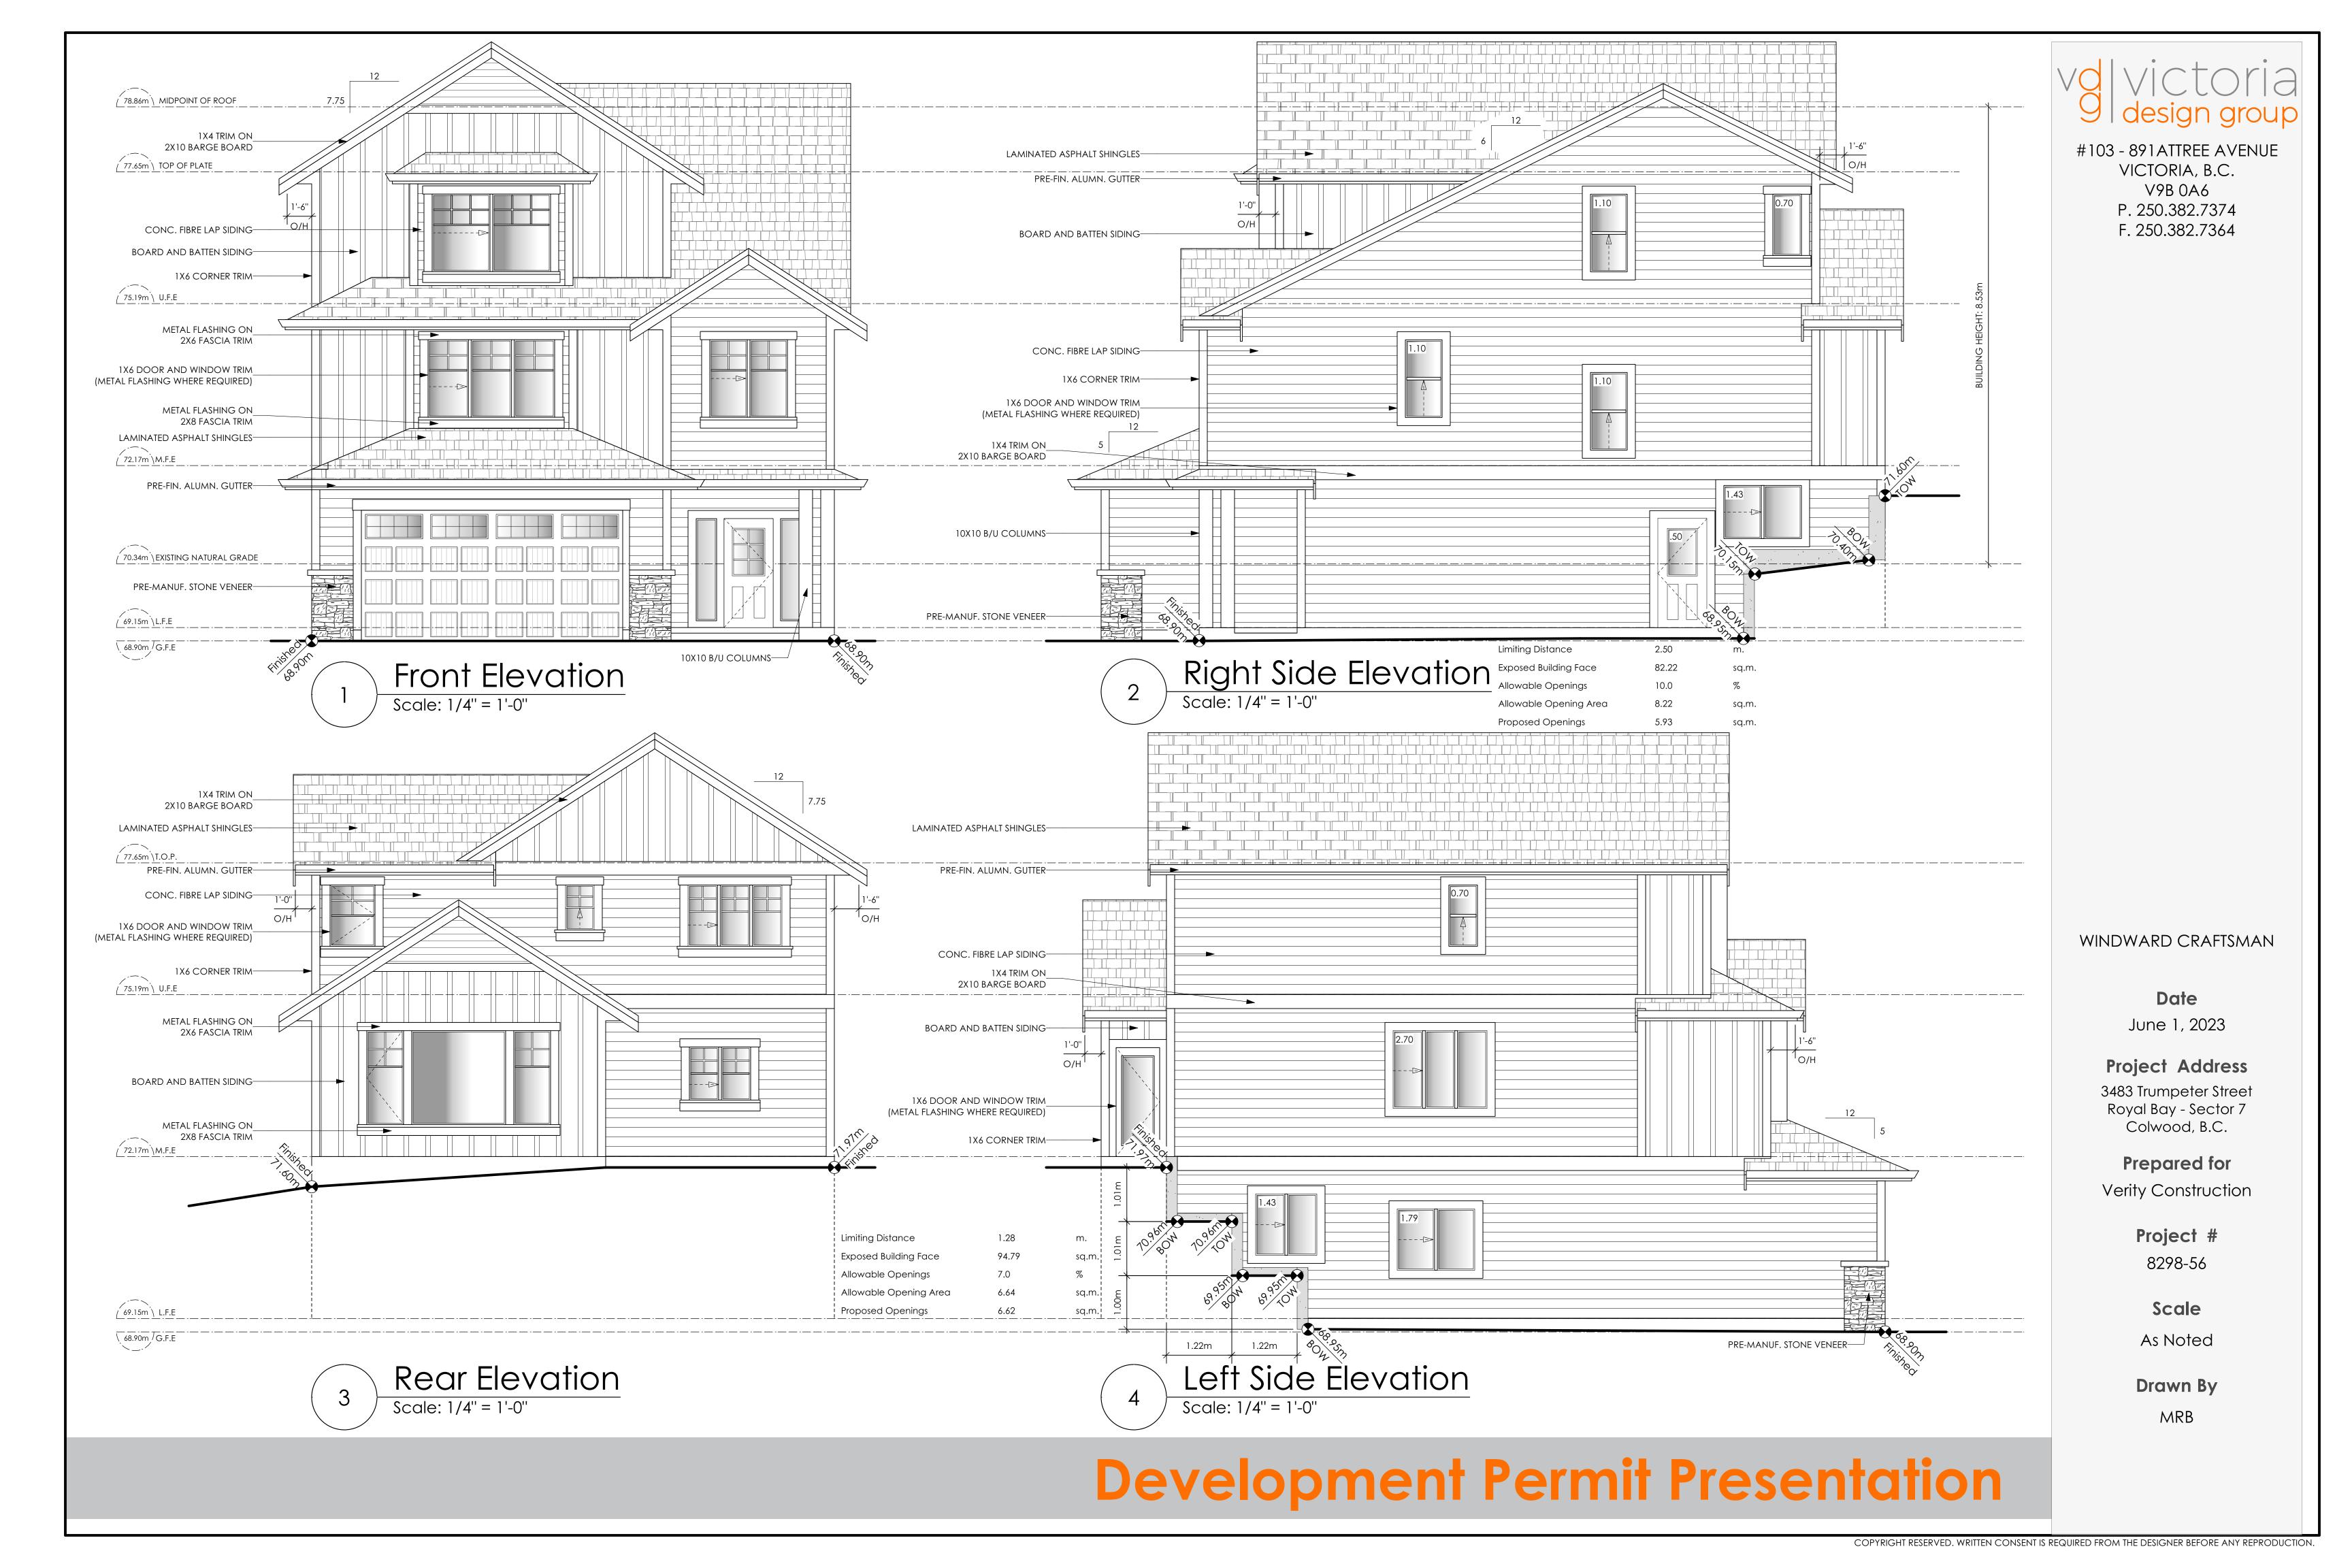

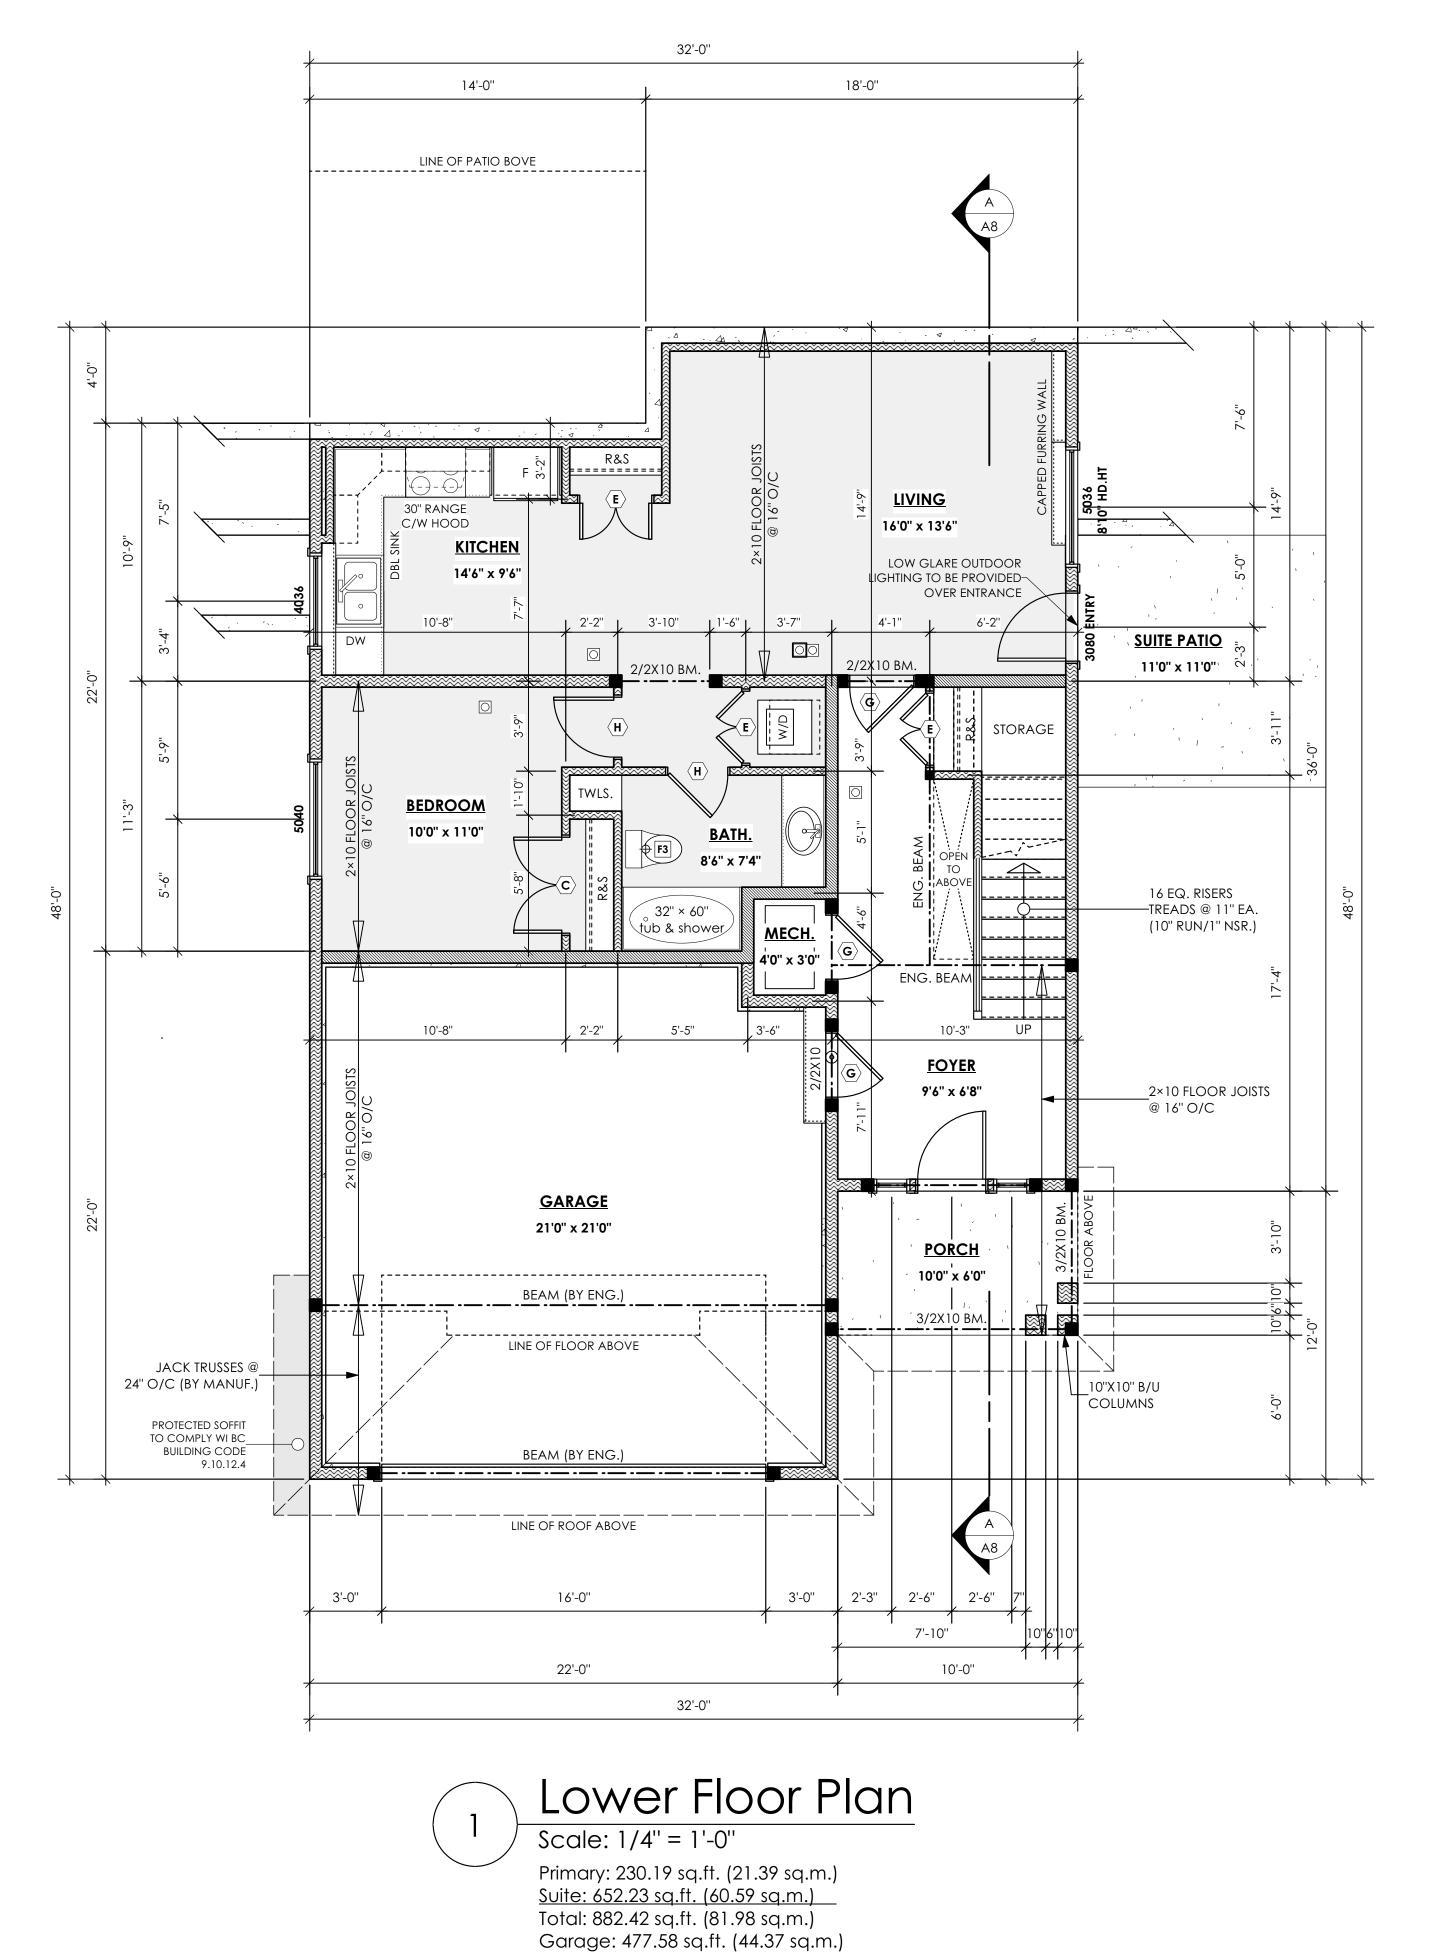

volvictoria 9 design group

> #103 - 891 ATTREE AVENUE VICTORIA, B.C. V9B 0A6 P. 250.382.7374 F. 250.382.7364

WINDWARD CRAFTSMAN

Date

June 1, 2023

**Project Address** 

3483 Trumpeter Street Royal Bay - Sector 7 Colwood, B.C.

Prepared for Verity Construction


**Project #** 8298-56

Scale

As Noted

Drawn By

MRB

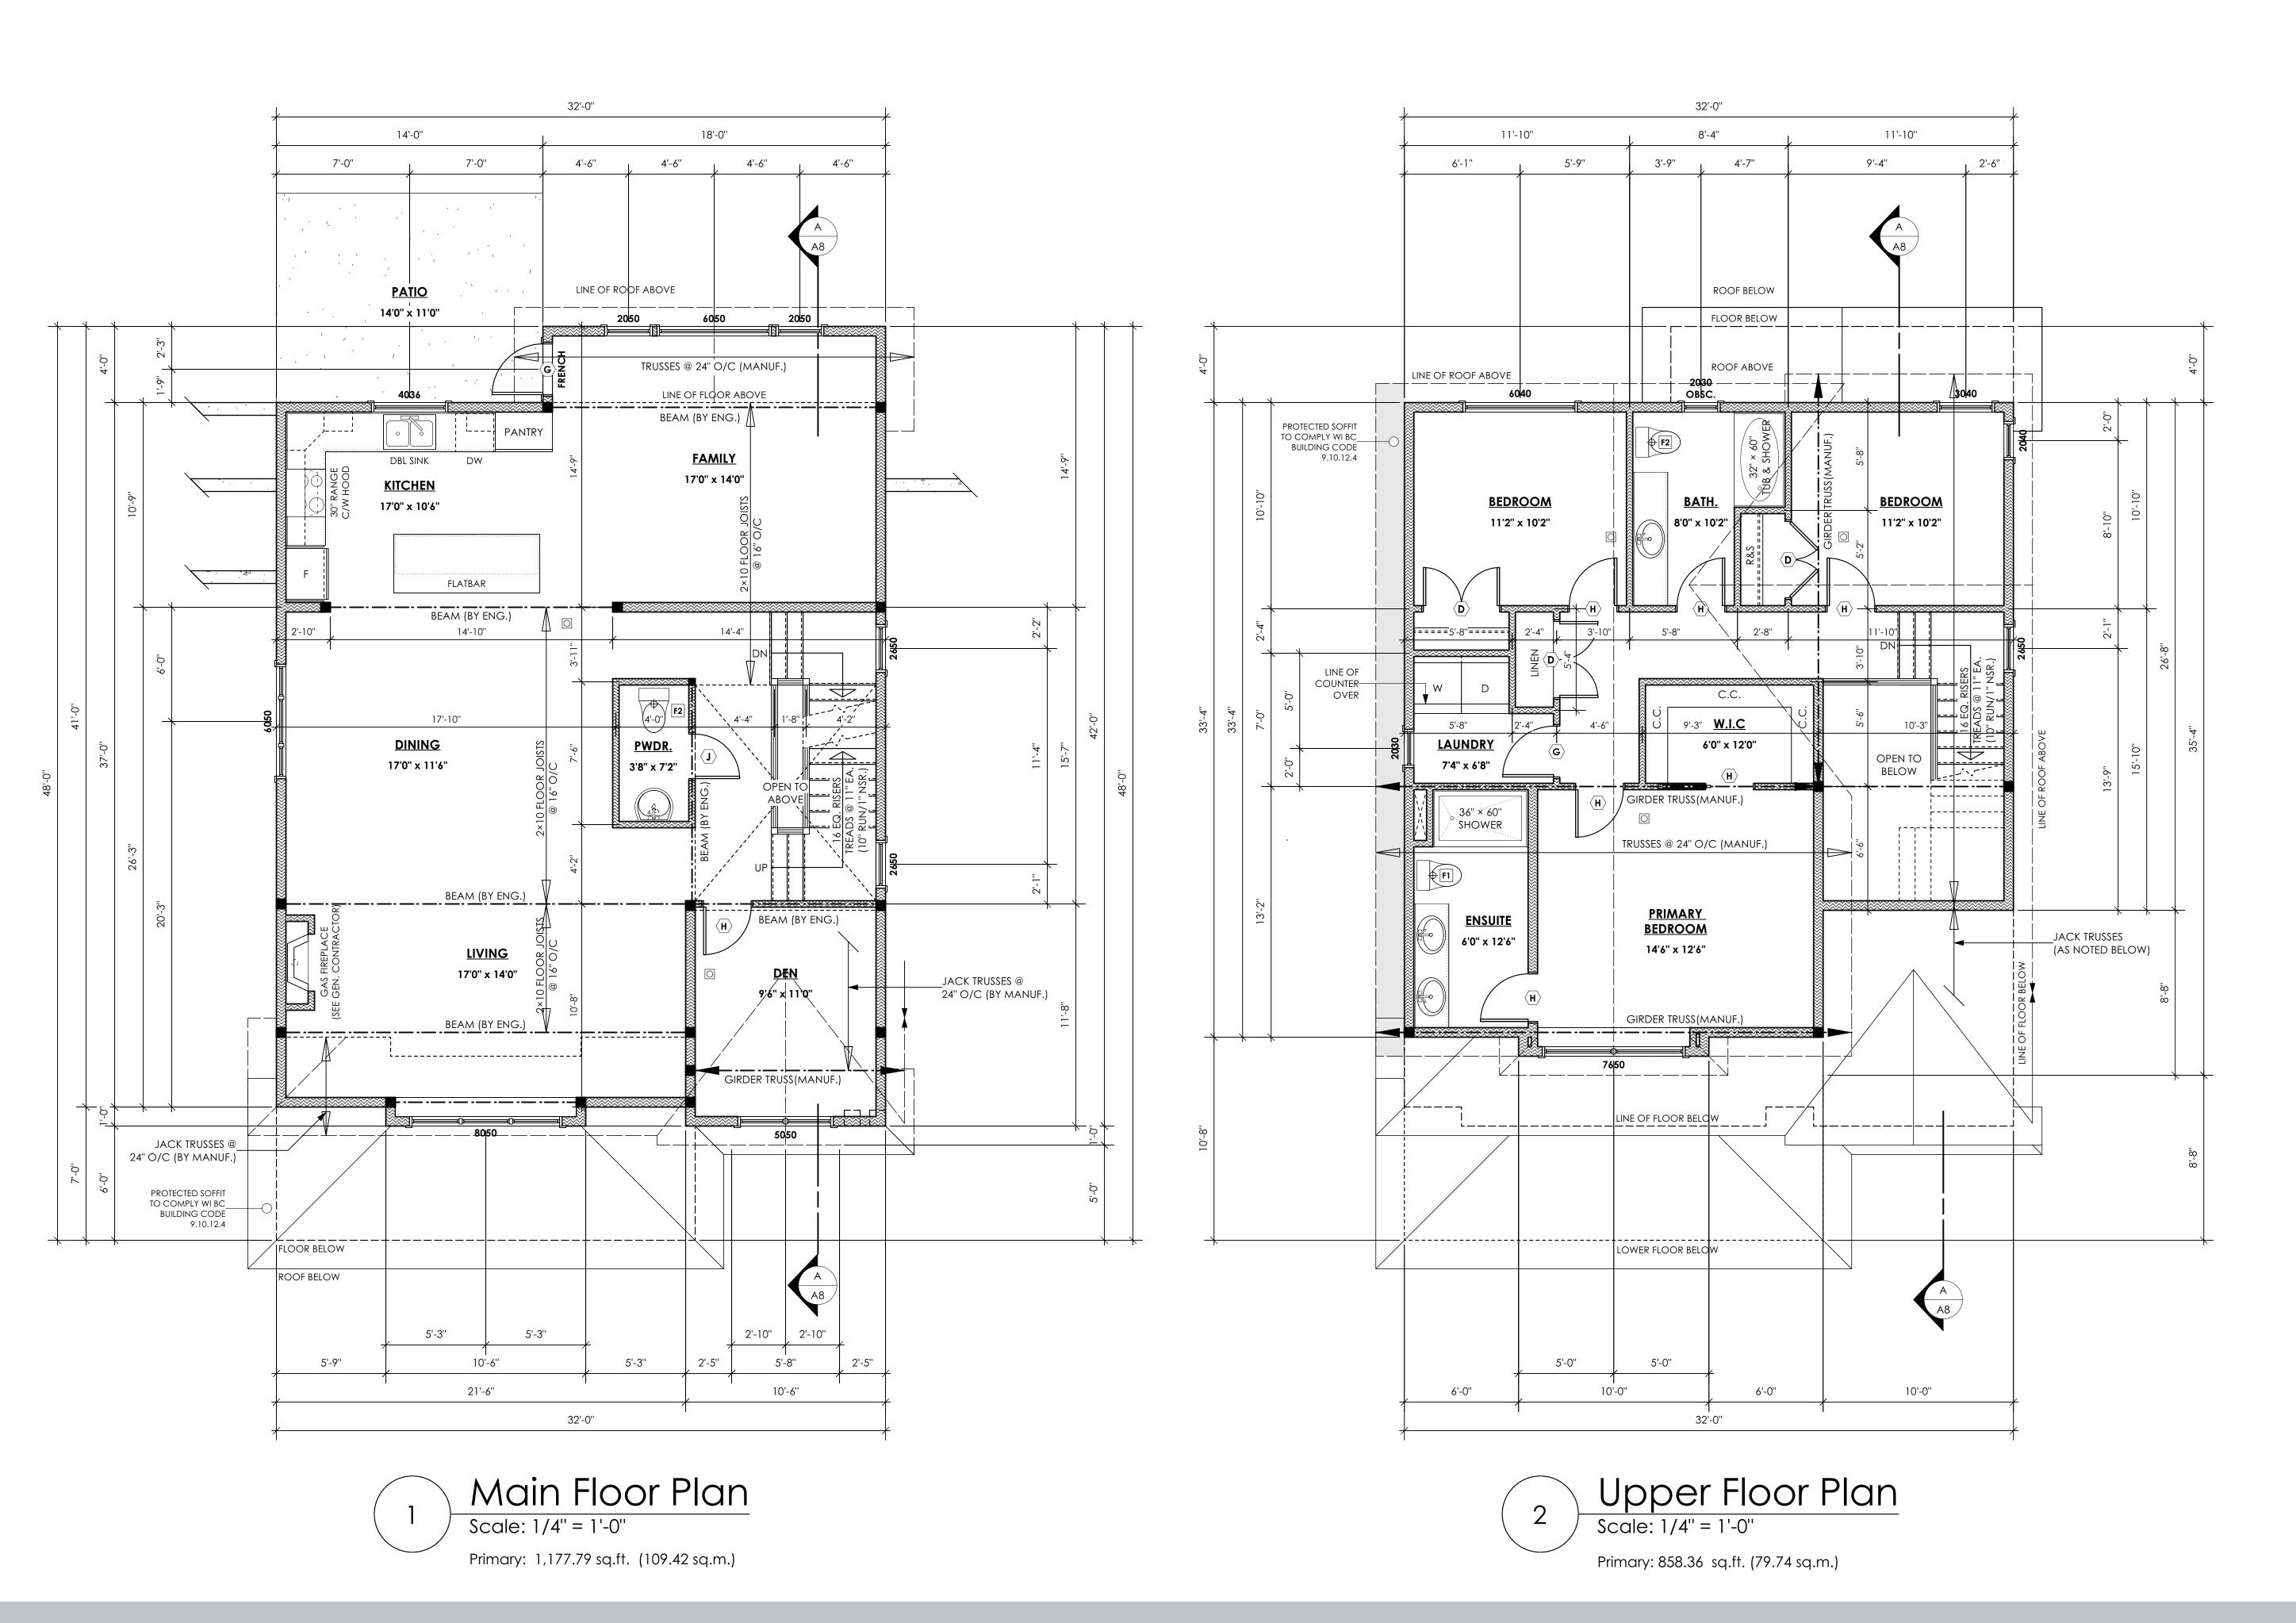

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#103 - 891 ATTREE AVENUE VICTORIA, B.C. V9B 0A6 P. 250.382.7374 F. 250.382.7364

WINDWARD CRAFTSMAN

Date

June 1, 2023

## **Project Address**

3483 Trumpeter Street Royal Bay - Sector 7 Colwood, B.C.

# Prepared for Verity Construction


**Project #** 8298-56

Scale

As Noted

Drawn By

MRB

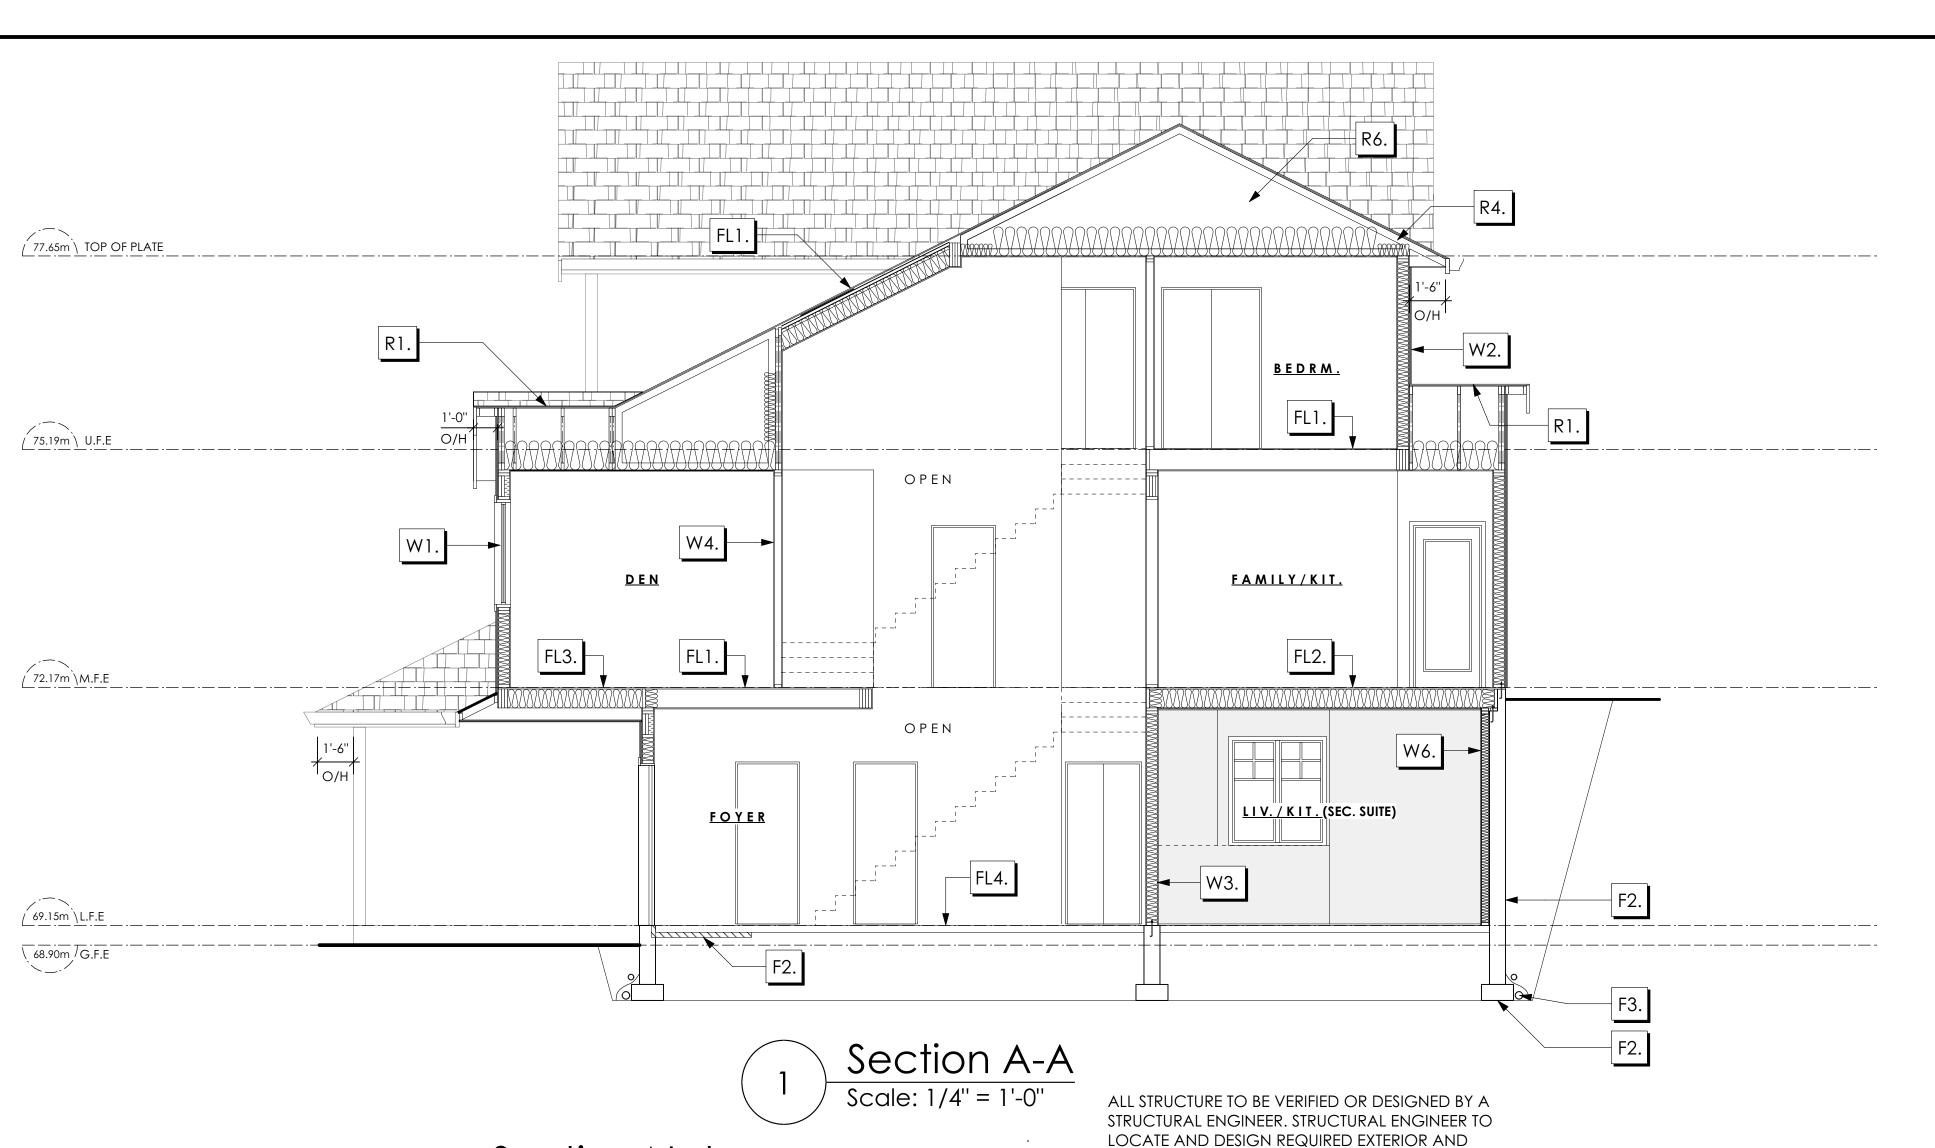

<u>Section Notes</u>

**FLOORS** 

LAMINATED ASPHALT SHINGLES ON 7/16" ORIENTED STRAND BOARD C/W "H" CLIPS WD TRUSSES (DESIGNED BY MANUF.) R-40 FIBRE GLAS BATT INSULATION OR 14 1/2" FIBRE GLASS LOOSE FILL INSULATION 6 MIL POLY'N V.B. 1/2" GYPSUM BOARD 5/8" GYPSUM BOARD

LAMINATED ASPHALT SHINGLES ON 7/16" ORIENTED STRAND BOARD C/W "H" CLIPS WD TRUSSES (DESIGNED BY MANUF.) 1/2" ORIENTED STRAND BOARD VENTED SOFFIT

ROOFS

R3. LAMINATED ASPHALT SHINGLES ON 1/2" PLYWOOD SHEATHING C/W "H" CLIPS 2×4 STRAPPING @ 16" O/C ON 2×10 ROOF JOISTS @ 16" O/C R-28 BATT INSULATION 1/2" EXTRUDED POLYSTYRENE INSULATION 6 MIL POLY'N V.B. 1/2" GYPSUM BOARD

R4. PROVIDE 2 1/2" (63MM) CLEAR BETWEEN R-20 INSULATION AND SHEATHING. (MIN. R-20 @ ROOF-WALL CONNECTION FOR 4'-0" (1.2M) AROUND PERIMETER OF BUILDING. AIR VENTILATION BAFFLES TO BE INSTALLED WHERE REQUIRED IN AS PER BCBC 9.19.)

EAVE PROTECTION CONT. UP ROOF SLOPE FOR 12" PAST EXTERIOR WALL.

PROVIDE 1 SQ.FT. ATTIC VENT PER 300 SQ.FT. OF INSULATED AREA MIN. 25% OF REQUIRED TO BE @ TOP AND BOTTOM (TO COMPLY WI. B.C. BLDG. CODE 9.19.1)

R7. PRE-FIN. FASCIA GUTTER 2×8 FASCIA BD. 2×4 SUB. FASCIA BD. VENTED SOFFIT (SEE CONTRACTOR)

PRE-FIN. FASCIA GUTTER 2×8 FASCIA BD. 2×4 SUB. FASCIA BD. 1/2" ORIENTED STRAND BOARD **VENTED SOFFIT** 

FL1. FINISHED FLOORING ON 11/16" ORIENTED STRAND BOARD (FASTENED & GLUED TO FLOOR STRUCT. BELOW) ON 2×10 FLOOR JOISTS @ 16" OR 12" O/C C/W 2×2 X-BRIDGING @ 7.0' O/C (MAX)

FL2. B.C. BUILDING CODE (TABLE-9.10.3.1.B) RATED FLOOR ASSEMBLY F8D FINISHED FLOORING ON 11/16" ORIENTED STRAND BOARD (FASTENED & GLUED TO FLOOR STRUCT. BELOW) ON 2×10 FLOOR JOISTS @ 16" OR 12" O/C C/W 2×2 X-BRIDGING @ 7.0' O/C (MAX) R-31 INSULATION RESILIENT METAL CHANNELS @ 24" O/C 1 LAYERS 5/8" X-TYPE GYPSUM BOARD 30 MINUTE F.R.R., 50 S.T.C.

FL3. FINISHED FLOORING ON 11/16" ORIENTED STRAND BOARD (FASTENED & GLUED TO FLOOR STRUCT. BELOW) ON 2×10 FLOOR JOISTS @ 16" OR 12" O/C C/W 2×2 X-BRIDGING @ 7.0' O/C (MAX) PROVIDE R-31 F/G BATT INSULATION IN JOIST CAVITY C/W BUILDING WRAP VENTED SOFFIT (TO OWNERS SPEC'S) TO ALL SUSPENDED FLOOR AREAS

FL4. 3 1/2" CONCRETE SLAB 6 MIL. POLY'N V.B. 6" COMPACTED GRAVEL OR SAND

FL5. 3 1/2" CONCRETE SLAB 6 MIL. POLY'N V.B. 6" COMPACTED GRAVEL OR SAND SLOPE TO DOORS 1" (NOT IN SECTION)

## WALLS

W1. DOUBLE GLAZING ENERGY STAR LOW "E" RATING IN THERMAL BREAK FRAMES 2/2"X10" LINTEL OVER (@ bearing walls only) (TYPICAL, wi. 2 1/2" XPS insulation) FLASHING OVER @ EXTERIOR (glazing in all exterior doors & within 3 ft. of exterior doors to be shatterproof (SP)) WINDOW REQUIREMENTS DERIVED FROM CITY OF COLWOOD BUILDING BYLAW AND ARE TO BE USED TO SATISFY THE REQUIREMENTS OF AAMA/WDMA/CSA 101/I.S.2/A440, "NAFS": COLWOOD, CLASS R - PG30 (220) A3, RATINGS MUST BE CLEARLY LABELED ON ALL

W2. CONC. FIBRE BOARD ON 9.5MM (3/8") AIR SPACE / STRAPPING 3/8"×2" BORATE TREATED PLYWOOD STRAPPING HOUSE WRAP (A.B.) (TYVEK OR EQ.) 7/16" ORIENTED STRAND BOARD SHEATHING 2×6 STUDS @ 16" O/C R-20 INSULATION 6 MIL. POLYETHYLENE VAPOUR BARRIER 1/2" GYPSUM BOARD

UNITS UPON INSTALLATION FOR INSPECTION.

W3. B.C. BUILDING CODE (TABLE 9.10.3.1.A) RATED WALL ASSEMBLY W3c 1 LAYER 1/2" X-TYPE GYPSUM BOARD RESILIENT METAL CHANNELS @ 24" O/C 2×4 STUDS @ 16" O/C OR 2×6 STUDS @ 16" O/C (IF NOTED) C/W 3 1/2" FIBRE GLASS SOUND BATTS 1 LAYER 1/2" X-TYPE GYPSUM BOARD 45 MIN. F.R.R 43 S.T.C (BETWEEN PRIMARY LIVING & SECONDARY SUITE)

## W4. INTERIOR PARTITION 1/2" GYPSUM BOARD ON EACH SIDE OF 2×4 STUDS @ 16" O/C OR 2×6 STUDS @ 16" O/C (IF NOTED)

INTERIOR BRACING TO RESIST LATERAL LOADS IN COMPLIANCE WITH B.C. BUILDING CODE 2012 9.23.13.3 AND SUPPLY DETAILS IF REQUIRED

> W5. 5/8" X-TYPE GYPSUM BOARD ON 2×6 STUDS @ 16" O/C C/W R-20 INSULATION 6 MIL. POLY'N V.B 1/2" GYPSUM BOARD (BETWEEN GARAGE & LIVING) (NOT SHOWN IN SECTION)

W6. 1/2" GYPSUM BOARD ON 6 MIL. POLY'N V.B. 2×4 STUDS @ 24" O/C C/W R-12 BATT INSULATION BUILDING WRAP OR 12.7MM (1/2") AIR SPACE (PROVIDE REQUIRED FIRE STOPS IN WALL ASSEMBLIES TO COMPLY WITH B.C. BLDG. CODE 9.10.16.)

## FOUNDATION

F1. DAMP PROOFING (WHERE REQUIRED) ON 8" THK. CONC. FOUNDATION WALL C/W 15 M BARS @ 24" O/C B/W

F2. 16"X 8" CONC. FOOTINGS C/W 2 (TWO) 15M BARS CONT. 3 IN. FROM BOTT. ON UNDISTURBED SOIL (SOLID BEARING)

F3. 4" PERIMETER DRAIN 3" TIGHT PIPE FOR RWL DRAIN ROCK

F4. ANCHOR BOLTS @ 4.0 FT. O/C MAX C/W SILL GASKETS

F5. STEP DOWN TO GARAGE SLAB MAY VARY, VERIFY EXTENT ON SITE (NOT IN SECTION)

#103 - 891ATTREE AVENUE VICTORIA, B.C. V9B 0A6 P. 250.382.7374 F. 250.382.7364

WINDWARD CRAFTSMAN

Date

June 1, 2023

**Project Address** 

3483 Trumpeter Street Royal Bay - Sector 7 Colwood, B.C.

Prepared for Verity Construction

> Project # 8298-56


> > Scale

As Noted

Drawn By MRB



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Lot 56 Site Section Scale: 1/4" = 1'-0"
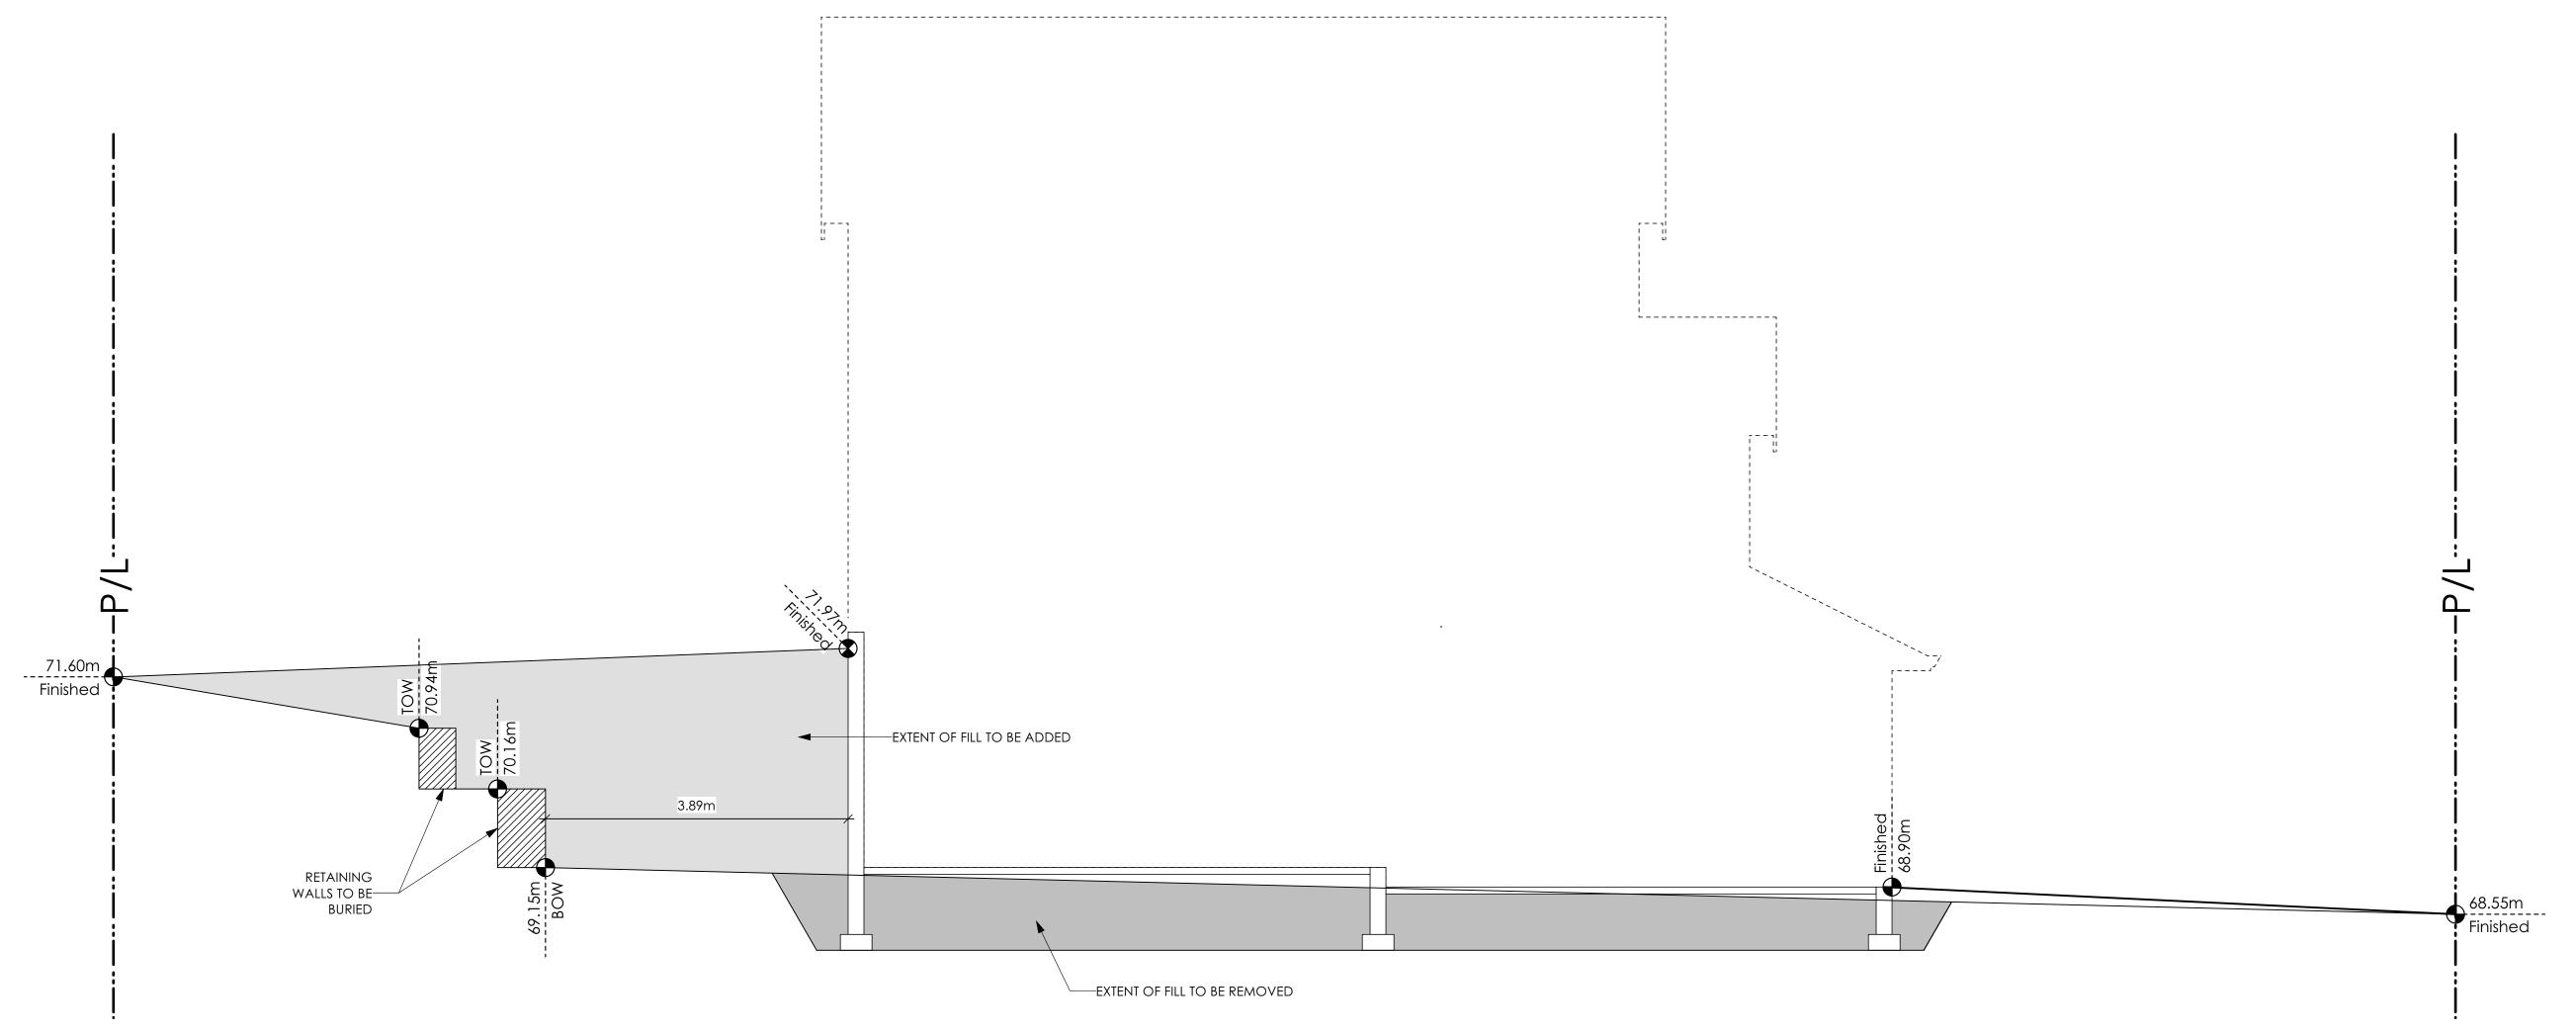
## WINDWARD CRAFTSMAN

## Date

June 1, 2023

# **Project Address**

3483 Trumpeter Street Royal Bay - Sector 7 Colwood, B.C.

# **Prepared for**

Verity Construction


Project # 8298-56

Scale

As Noted


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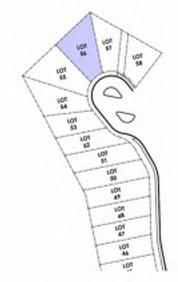
MRB

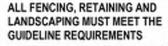

ALL RETAINING WALLS ARE TO BE STAND ALONE STRUCTURES (THEY MUST TERMINATE AT PROPERTY LINE) AND MUST NOT CONNECT TO RETAINING WALLS LOCATED ON ADJACENT PRIVATE PROPERTIES


developer reserves the right to modify plans. specifications and design without prior notice. Drawings contained within are artist renderings only. Sizes and dimensions are approximate and may vary with actual plan and survey. Exterior style may change pending municipal approval. Retaining wall location and types may vary and are subject to municipal, engineering or developer discretion. Subject to change without notice. Furniture as shown on plans are for layout purposes only and are not included in the sale.



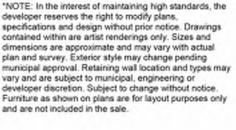

KEY PLAN

NOT TO SCALE

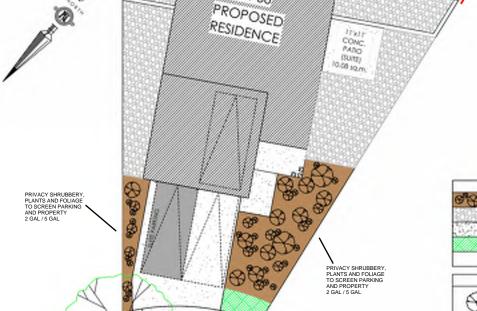

CONC. PATIO

20156

|       | ITEM       | AREA (sf) | - %  |
|-------|------------|-----------|------|
| 96    | GARDEN BED | 464       | 10%  |
| 2593  | GRAVEL     | 937       | 21%  |
| 43.00 | CONCRETE   | 854       | 19%  |
|       | SOD        | 2,224     | 50%  |
|       | TOTAL      | 4,479     | 100% |

ESTIMATED LOCATION OF REAR FENCING - SUBJECT TO CHANGE ACCORDING TO ACTUAL SITE CONDITIONS


LEGEND UPGRADE SHRUBBERY, PLANTS AND FOUNCE TRIVACIAN STREET -2 GAL -5 GAL PRIVACY SHRUBBERY

NOT TO SCALE

LANDSCAPE PLAN

LOCATION INDICATED BY WAY WOOD FORM Typical Fence Detail Not To Scale

THICK PROJUDIAL MAIL OF PERCENTIAL VICE

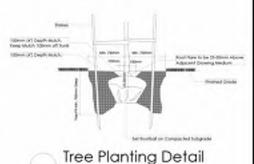

All hers and pions by the home owner to be

## ADDITIONAL NOTES:

PROPERTY TO BE IRRIGATED 6" PIPE FOR DRIVEWAY SLEEVES TO BE INSTALLED FOR CITY IRRIGATION LINES

| DATE  | ISSUED/REVISED             | MM/DD/YY |    |
|-------|----------------------------|----------|----|
| PROJE | FOR APPROVAL               | 06/28/22 | 01 |
|       | GC REVISION - FOR APPROVAL | 07/27/22 | 02 |
|       | GARDEN BED PLANTING        | 10/19/22 | 03 |
|       | SITE PLAN REVISION         | 02/28/23 | 04 |
|       | SITE PLAN REVISION         | 06/13/23 | 05 |

PROJECT

LANDSCAPING PLAN LOT 56, 3485 TRUMPETER ST. **ROYAL BAY, SECTOR 7** CITY OF COLWOOD



CONSTRUCTION

QUALITY CONSTRUCTION. TRUSTED SERVICE.

106 - 1039 Langford Parkway Victoria, B.C. V9B 0A6

P: 250.474.1039 www.verityconstruction.ca


## **GABLECTAST HOMES**


## **BUILDING GRADE SLIP**


| WSP | Project | No: | 201-08151-00 |
|-----|---------|-----|--------------|
|     | ,       |     |              |


C. Hume - July 26/22

| BUILDING   | Issue Date:  |
|--|--|
| MUNICIPAL ADDRESS 3485 Trumpeter Street  | P.I.D.   |
| LOT 56   | PLAN   |
| BUILDER VERITY HOMES   | SUBDIVISION POYAL BAY SECTION 7  |
| ADDRESS  | ROYAL BAY SECTOR 7  DEVELOPER  |
| REPRESENTATIVE PH.   | MEADOWS DEVELOPMENT LP  CONSULTANT  WSP CANADA INC   |
| PROPOSED BUILDING GRADES   | PLAN   |
| ALL ELEVATIONS ARE METRIC GEODETIC +   | LOT: PLAN:   |
| MAIN FLOOR ELEVATION 69.40   |  |
| FRONT ELEV. 68.93 REAR ELEV. 69.25   | TRUMPETER ST.  |
| (FINISHED GRADE) (FINISHED GRADE)  |  |
| FINISHED GRADE AT GARAGE 68.90 ≥   |  |
| HEADROOM   | 68.55  |
| HEA  | <b>/</b>   |
| ACTUAL TOP OF FOOTING  | 56<br>EG. 68-3   |
| LOWEST PERMITTED TOP OF not provided FLOOR SLAB  | EG 68-3 88 99 99 99 99 99 99 99 99 99 99 99 99   |
| FOOTING ELEVATION (LTF) (BOTTOM OF BASEMENT SLAB FROST WALLS ARE REQUIRED.)  | S 65.39<br>D 66.33<br>BFT  |
| SERVICES FRONT REAR CENTER REFER SIZE  | -  |
| TO PLAN (mm)   |  |
| WATER  |  |
| SANITARY   | 7/3 00   |
| STORM  | A STATE OF THE STA |
| COMMENTS YES NO  | RETAINING WALLS  |
| DRAIN TO SUMP PUMP LIKELY REQUIRED  (FOR BASEMENT IF INSTALLED)  | LEGEND   |
| SEWER TO SUMP PUMP LIKELY REQUIRED  (FOR BASEMENT IF INSTALLED)  | STREET   |
| SERVICES INSTALLED TO m INSIDE PROPERTY  | SAN.<br>STAN.<br>WAT.  |
| FOUNDATION SOIL BEARING INVESTIGATION  CERTIFICATION REQUIRED  |  |
| GEOTECHNICAL RESTRICTIONS APPLY  | SROW  SROW  PROPOSED FRONT CORNER ELEVATIONS  RESTAURANT OF THE PROPOSED FRONT SIDE YARD GRADES  |
| (SEE GEOTECHNICAL REPORT)  | 2000 EAW - CIVIL LOT NUMBER  |
| ENVIRONMENTAL RESTRICTIONS APPLY (SEE ENVIRONMENTAL REPORT)  | L# 6 C# 256 BEG 49.90  L# 6  EG 49.90  CH 256 CH 25 |
| UTILITY EASEMENTS AFFECT THIS LOT  | LFE/MFE 47.70 - LOWER/MAIN FLOOR ELEVATION   |
|  | MFGE 47.70 — MAXIMUM FINAL GROUND ELEVATION  |
|  | S 49.12 (P)  S A9.12 (P)  SAN SERVICE INV.   |
|  | D 49.12 (P) (P) DENOTES PUMP IS LIKELY REQUIRED FOR BASEMENT IF INSTALLED  |
|  | - STORM SERVICE INV.  (P) DENOTES PUMP IS LIKELY REQUIRED FOR BASEMENT IF INSTALLED  |
|  | PROPOSED REAR SIDE YARD GRADES   |
|  | — MAXIMUM BASEMENT SLAB DEPTH ELEVATION — LOT TYPE (L/LB/LBT)  |
| NOTES  | LANE/LOT - PROPOSED REAR CORNER ELEVATIONS   |
| IT IS THE RESPONSIBILITY OF THE BUILDER TO ENSURE THE FOOTINGS     ARE PLACED ON A PROPER BASE THAT IS FREE FROM FROST,     EXCESSIVE MOISTURE AND DELETERIOUS MATERIALS AND HAVE     APPROPRIATE FROST PROTECTION WHEN COMPLETED. |  |
| 2. THE INFORMATION CONTAINED HEREIN IS BASED ON THE APPROVED LOT GRADING PLAN FOR THIS SUBDIVISION. UN—AUTHORIZED DEVIATIONS WILL BE THE RESPONSIBILITY OF THE BUILDER TO ENSURE COMPLIANCE WITH ALL LOCAL BYLAWS.                 | I, THE BUILDER'S REPRESENTATIVE,  CERTIFY THAT THE FINAL HOUSE PLANS PROVIDED IN THE BUILDING PERMIT   |
| 3. OTHER NOTES:  | APPLICATION ARE THE SAME AS PROCESSED UNDER THIS GRADE SLIP AND THAT I UNDERSTAND THE INFORMATION AND THE REQUIREMENTS CONTAINED HEREIN AND WILL BUILD ACCORDINGLY.  |
|  |  |
|  | AUTHORIZED BUILDER'S REPRESENTATIVE DATE  THE INFORMATION CONTAINED HEREIN IS RASED ON THE APPROVED.   |
|  | THE INFORMATION CONTAINED HEREIN IS BASED ON THE APPROVED LOT GRADING PLAN FOR THIS SUBDIVISION, DATED   |

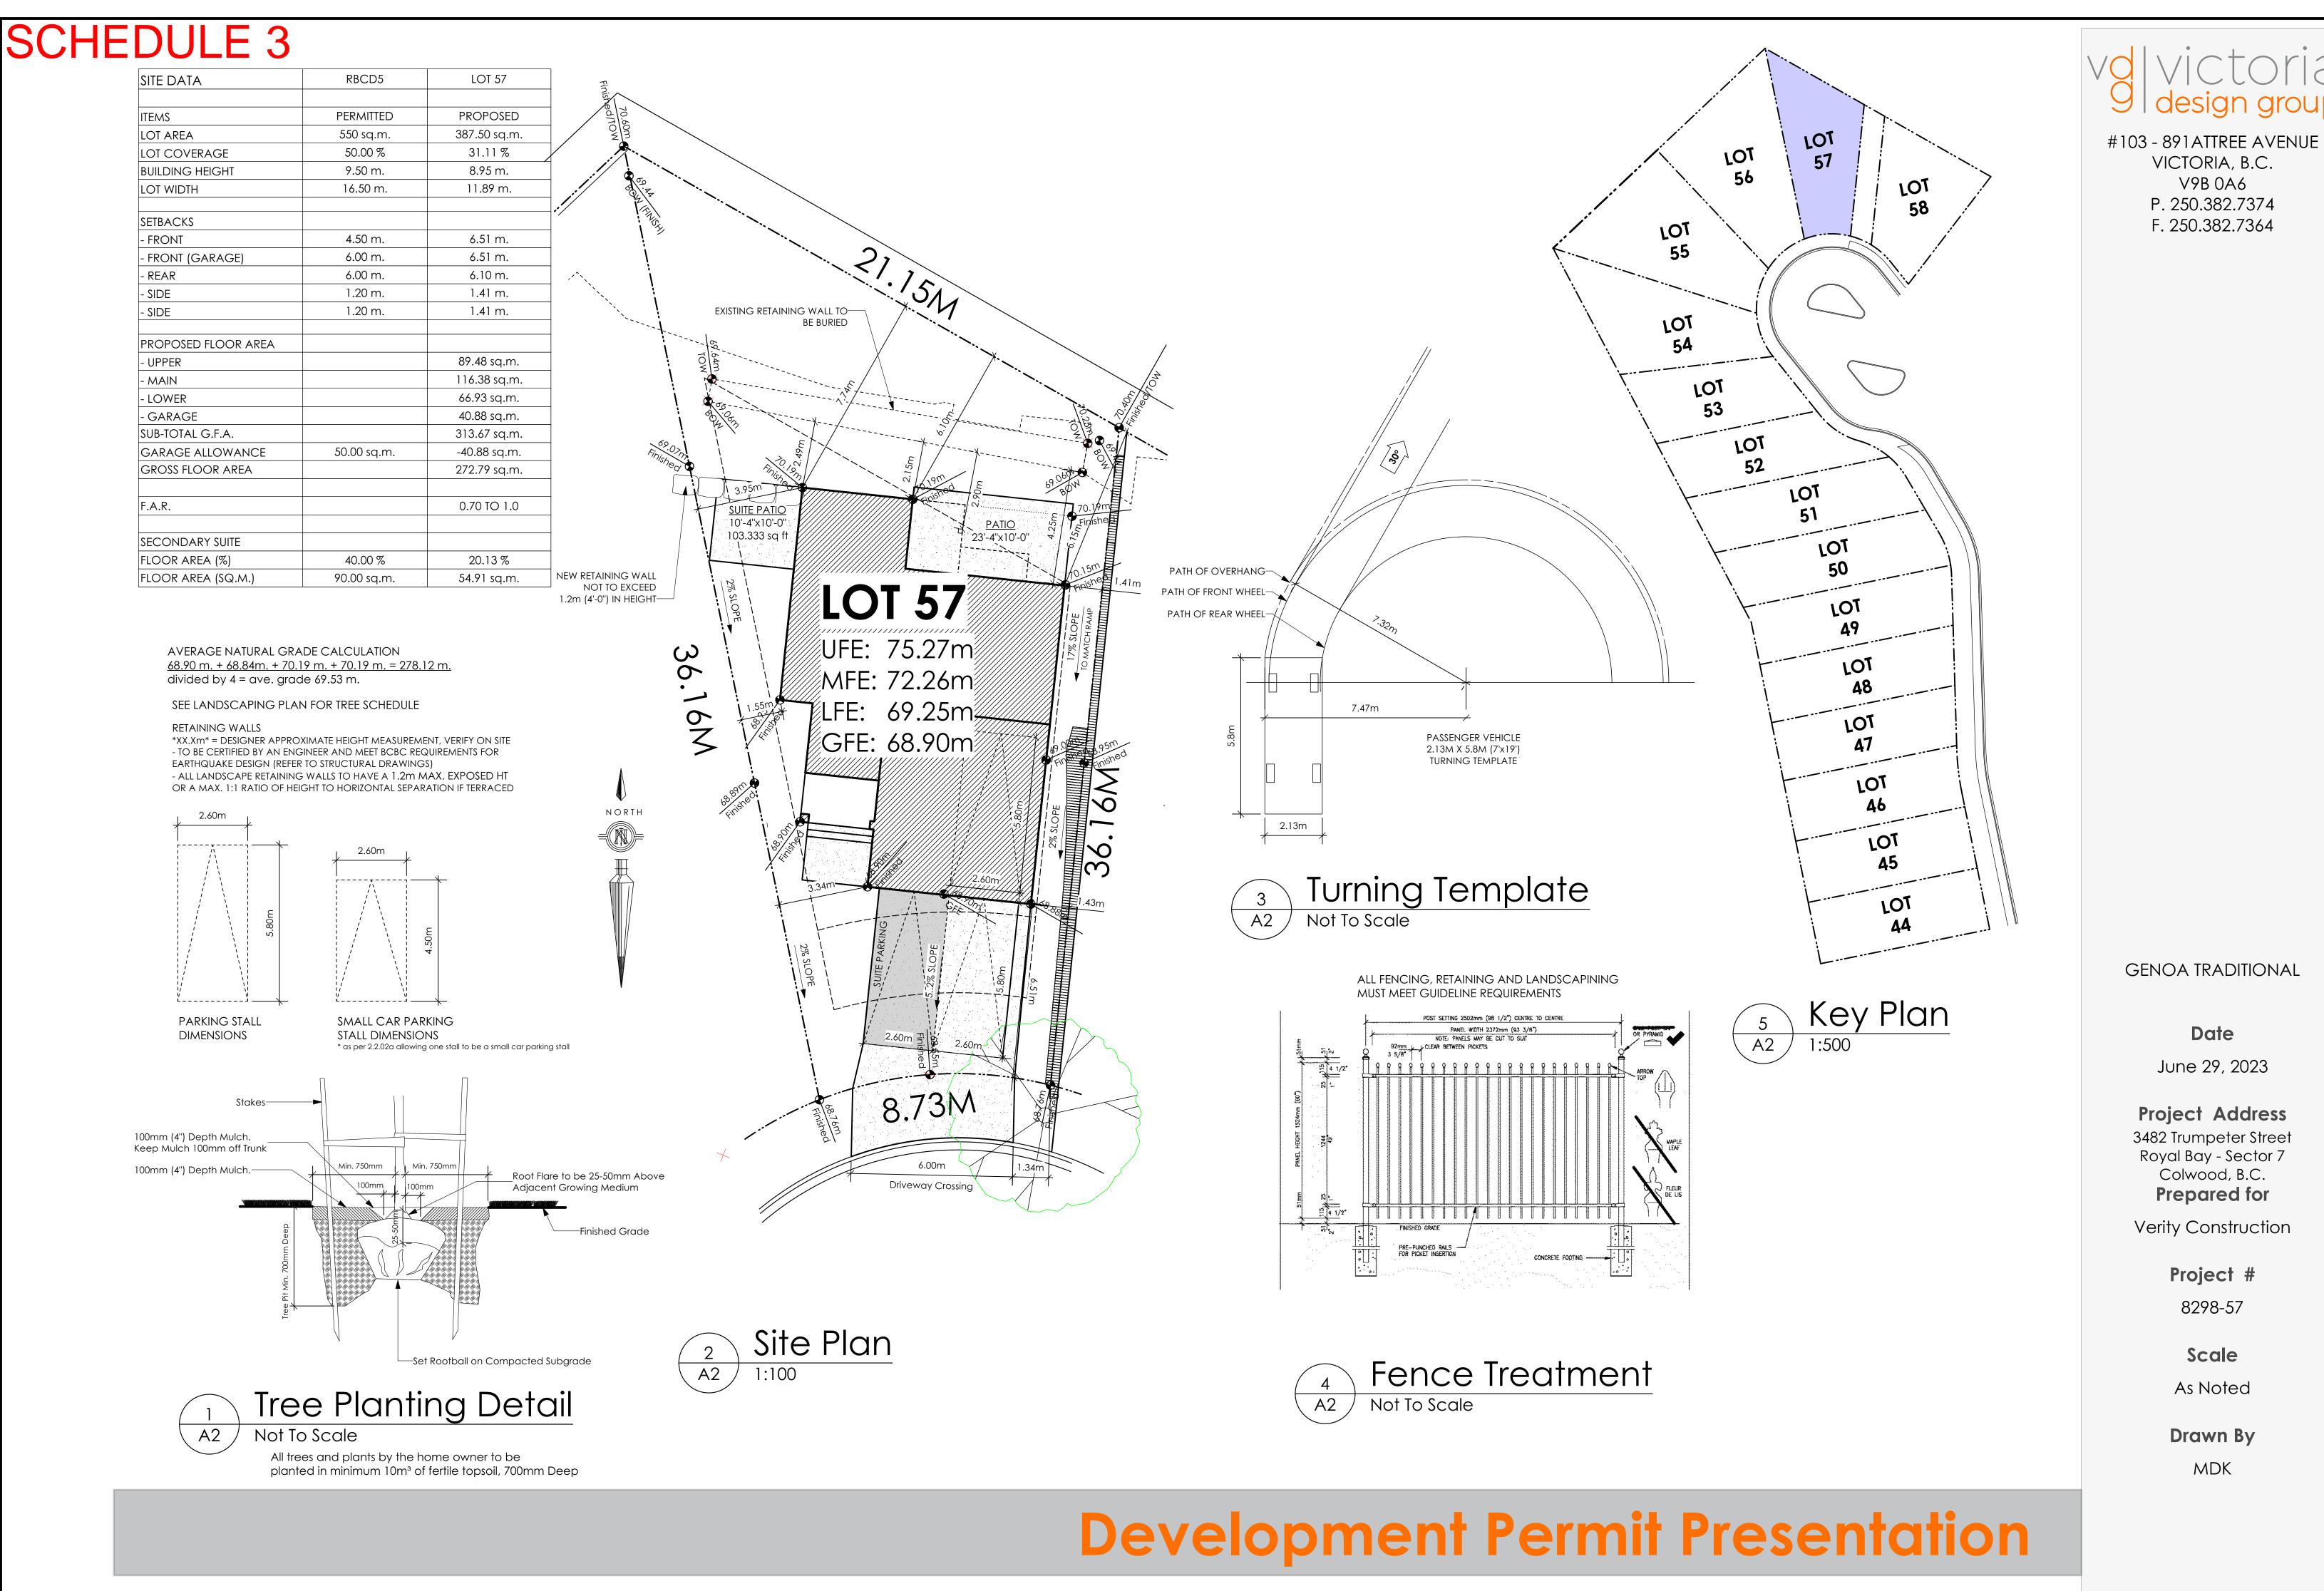

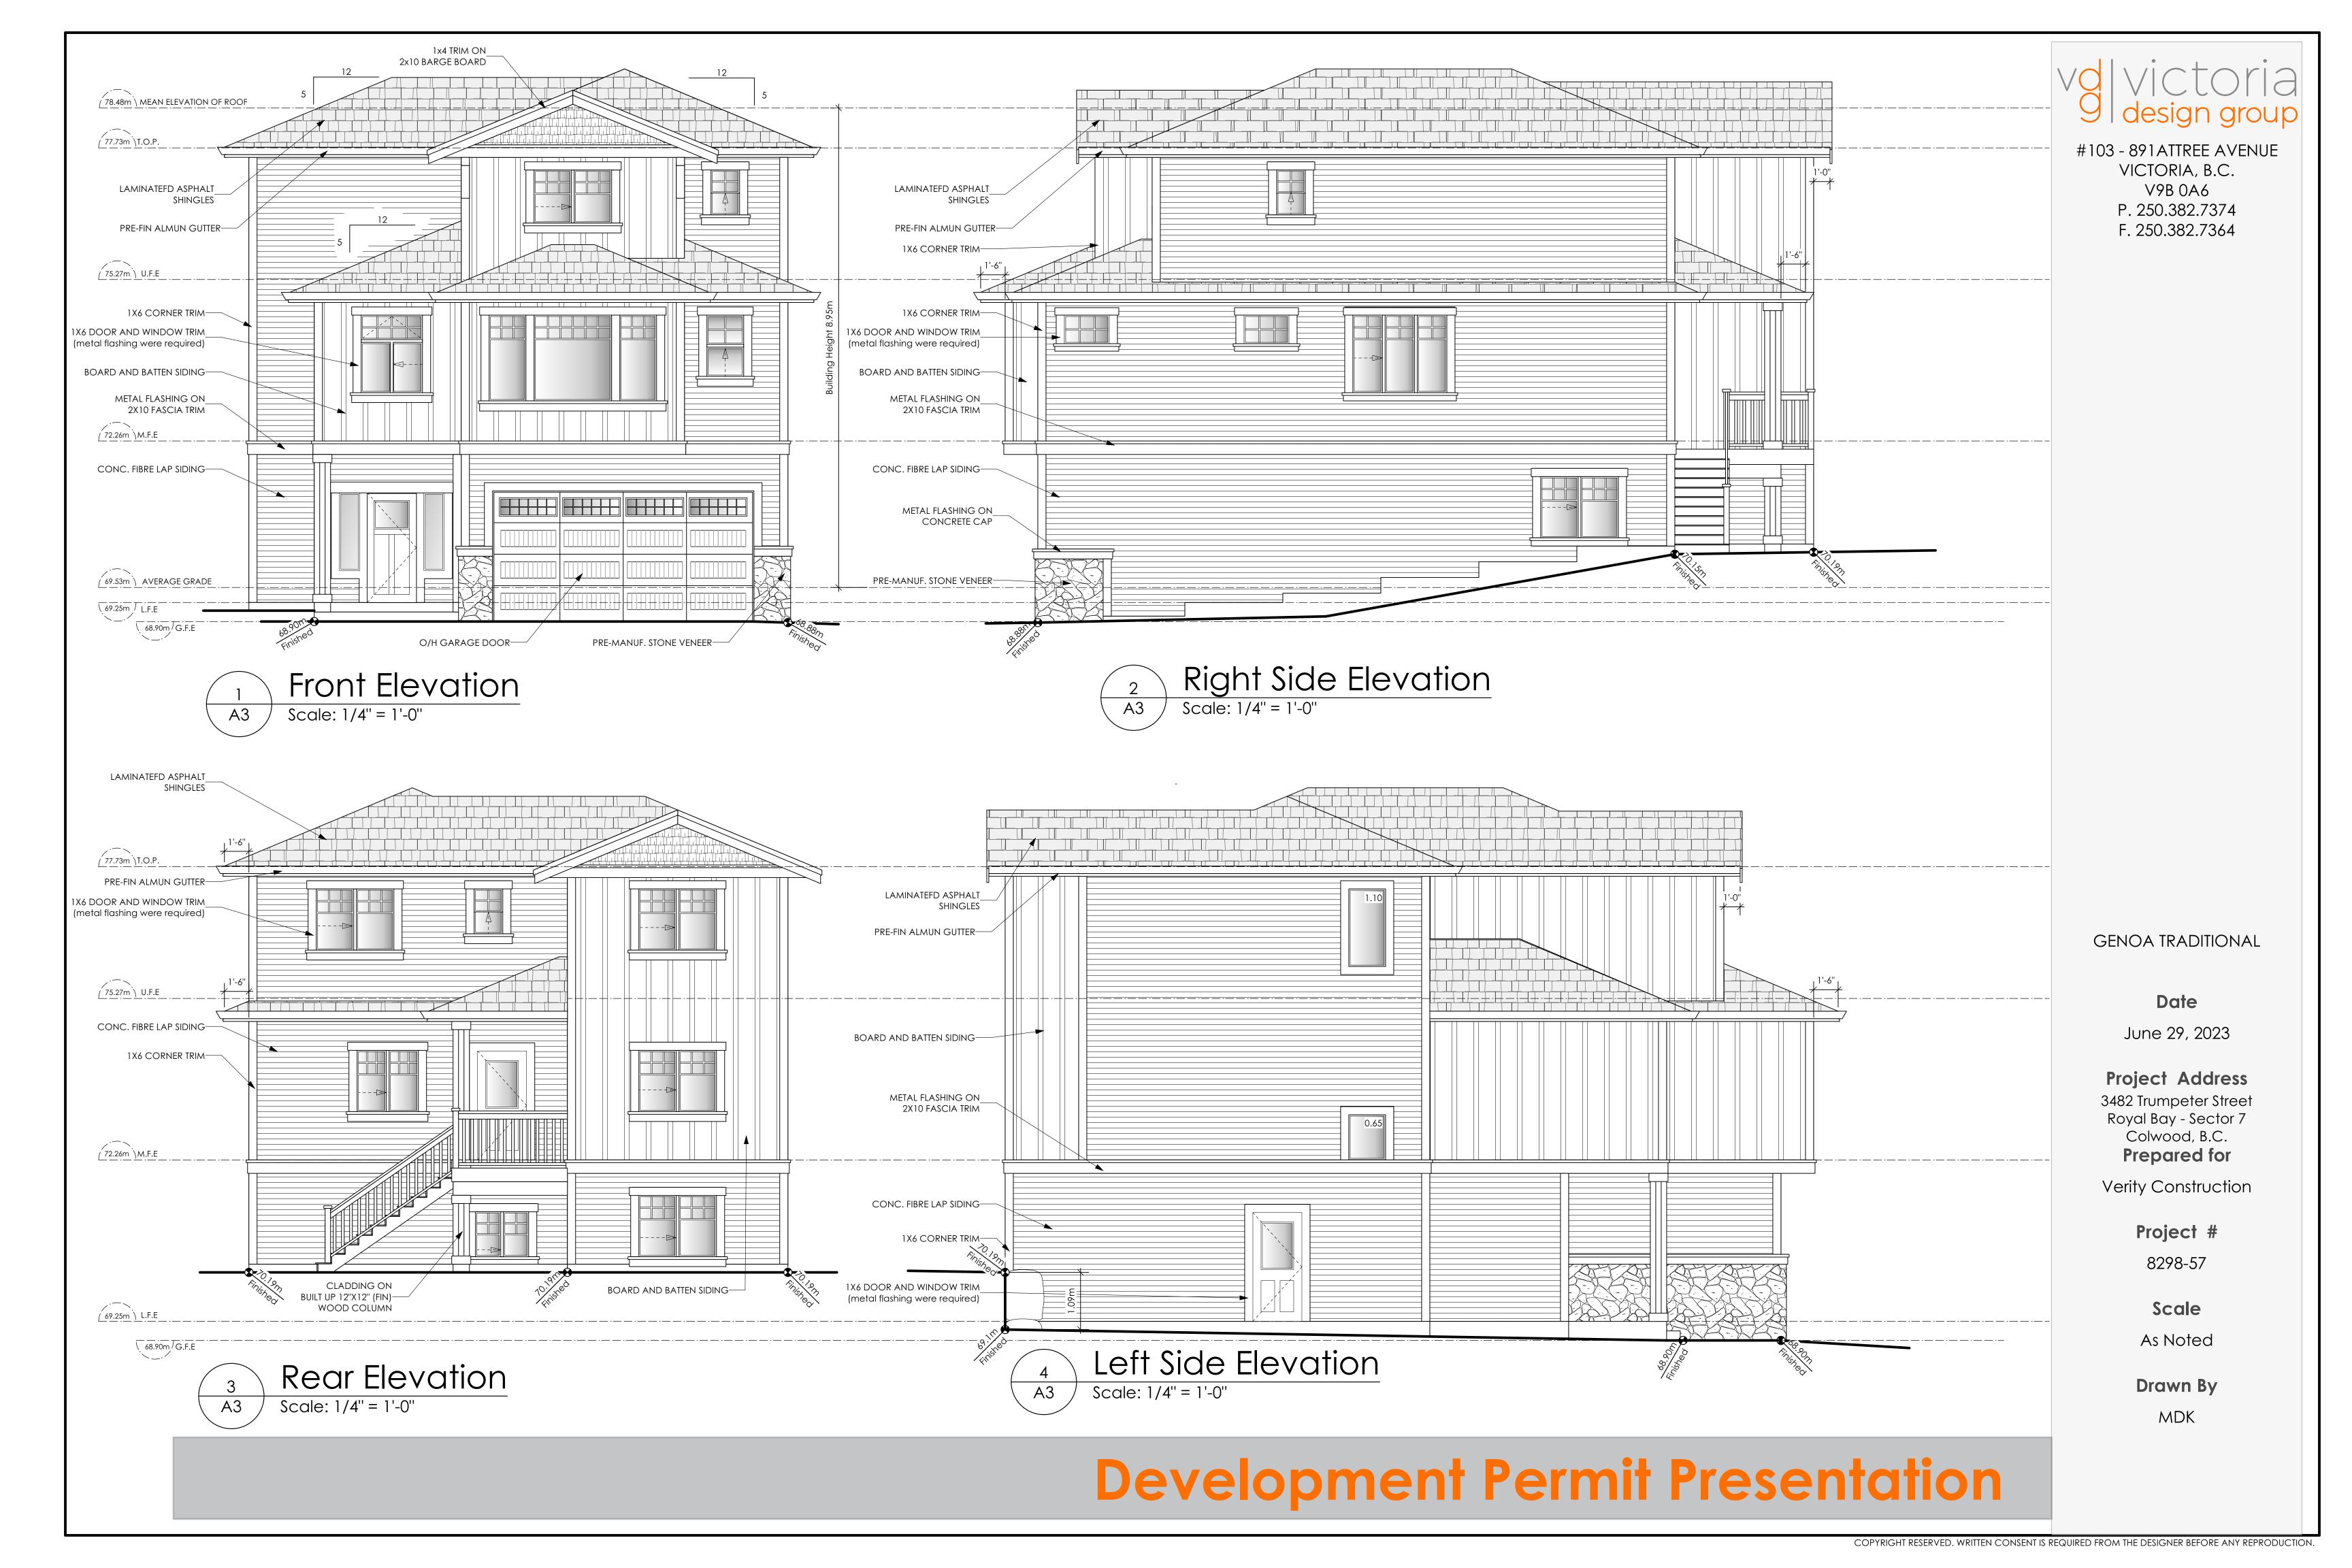

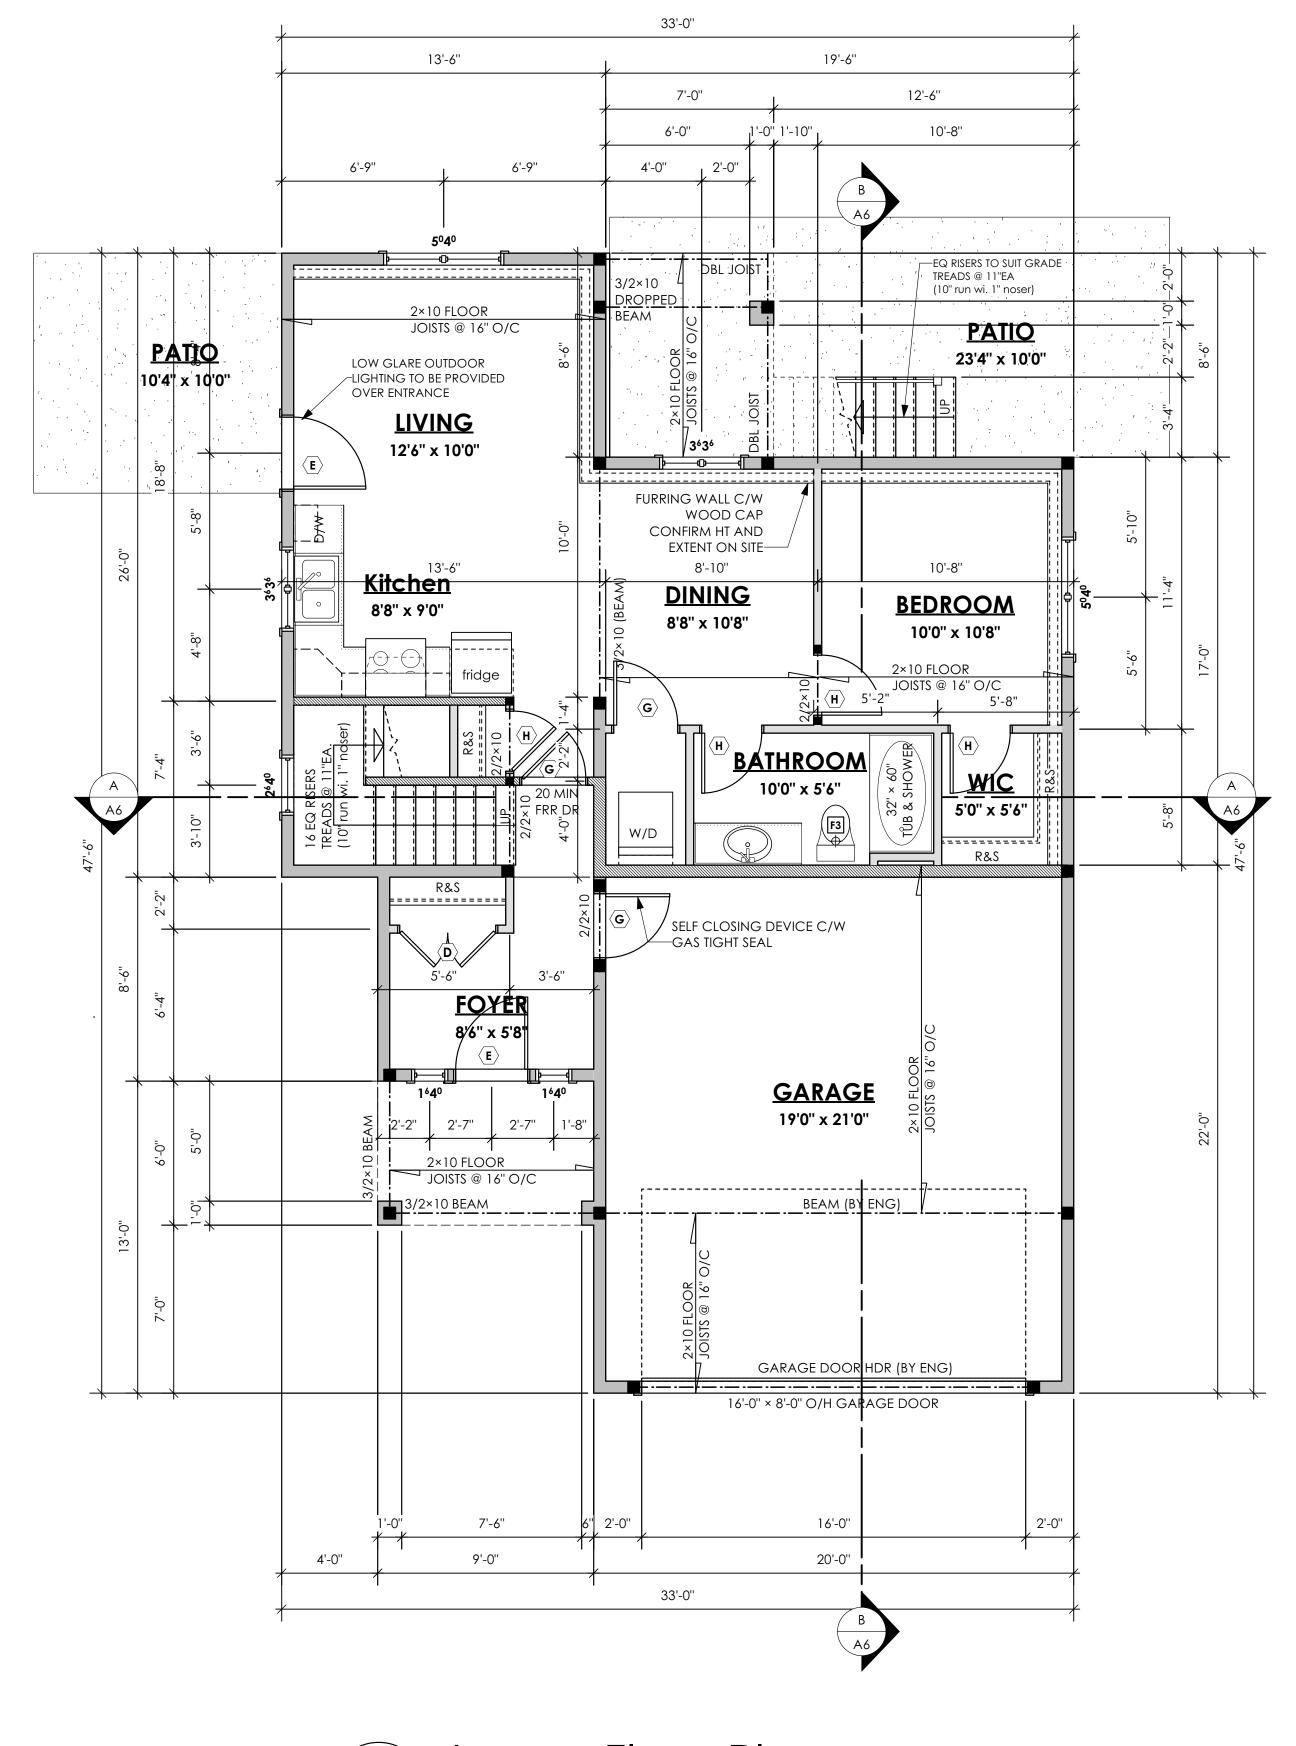

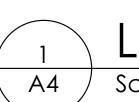

Lower Floor Plan

Scale: 1/4" = 1'-0"

PRIMARY: 129.38 sq.ft. (12.02 sq.m.) <u>SUITE: 591.00 sq.ft.4 (54.91 sq.m.)</u> TOTAL: 720.38 sq.ft. (66.93 sq.m.) GARAGE: 440.00 sq.ft. (40.88 sq.m.)

# volvictoria design group

#103 - 891 ATTREE AVENUE VICTORIA, B.C. V9B 0A6 P. 250.382.7374 F. 250.382.7364

GENOA TRADITIONAL

Date

June 29, 2023

Project Address
3482 Trumpeter Street
Royal Bay - Sector 7
Colwood, B.C.

Verity Construction

Prepared for

Project #


8298-57

As Noted

Scale

Drawn By

MDK

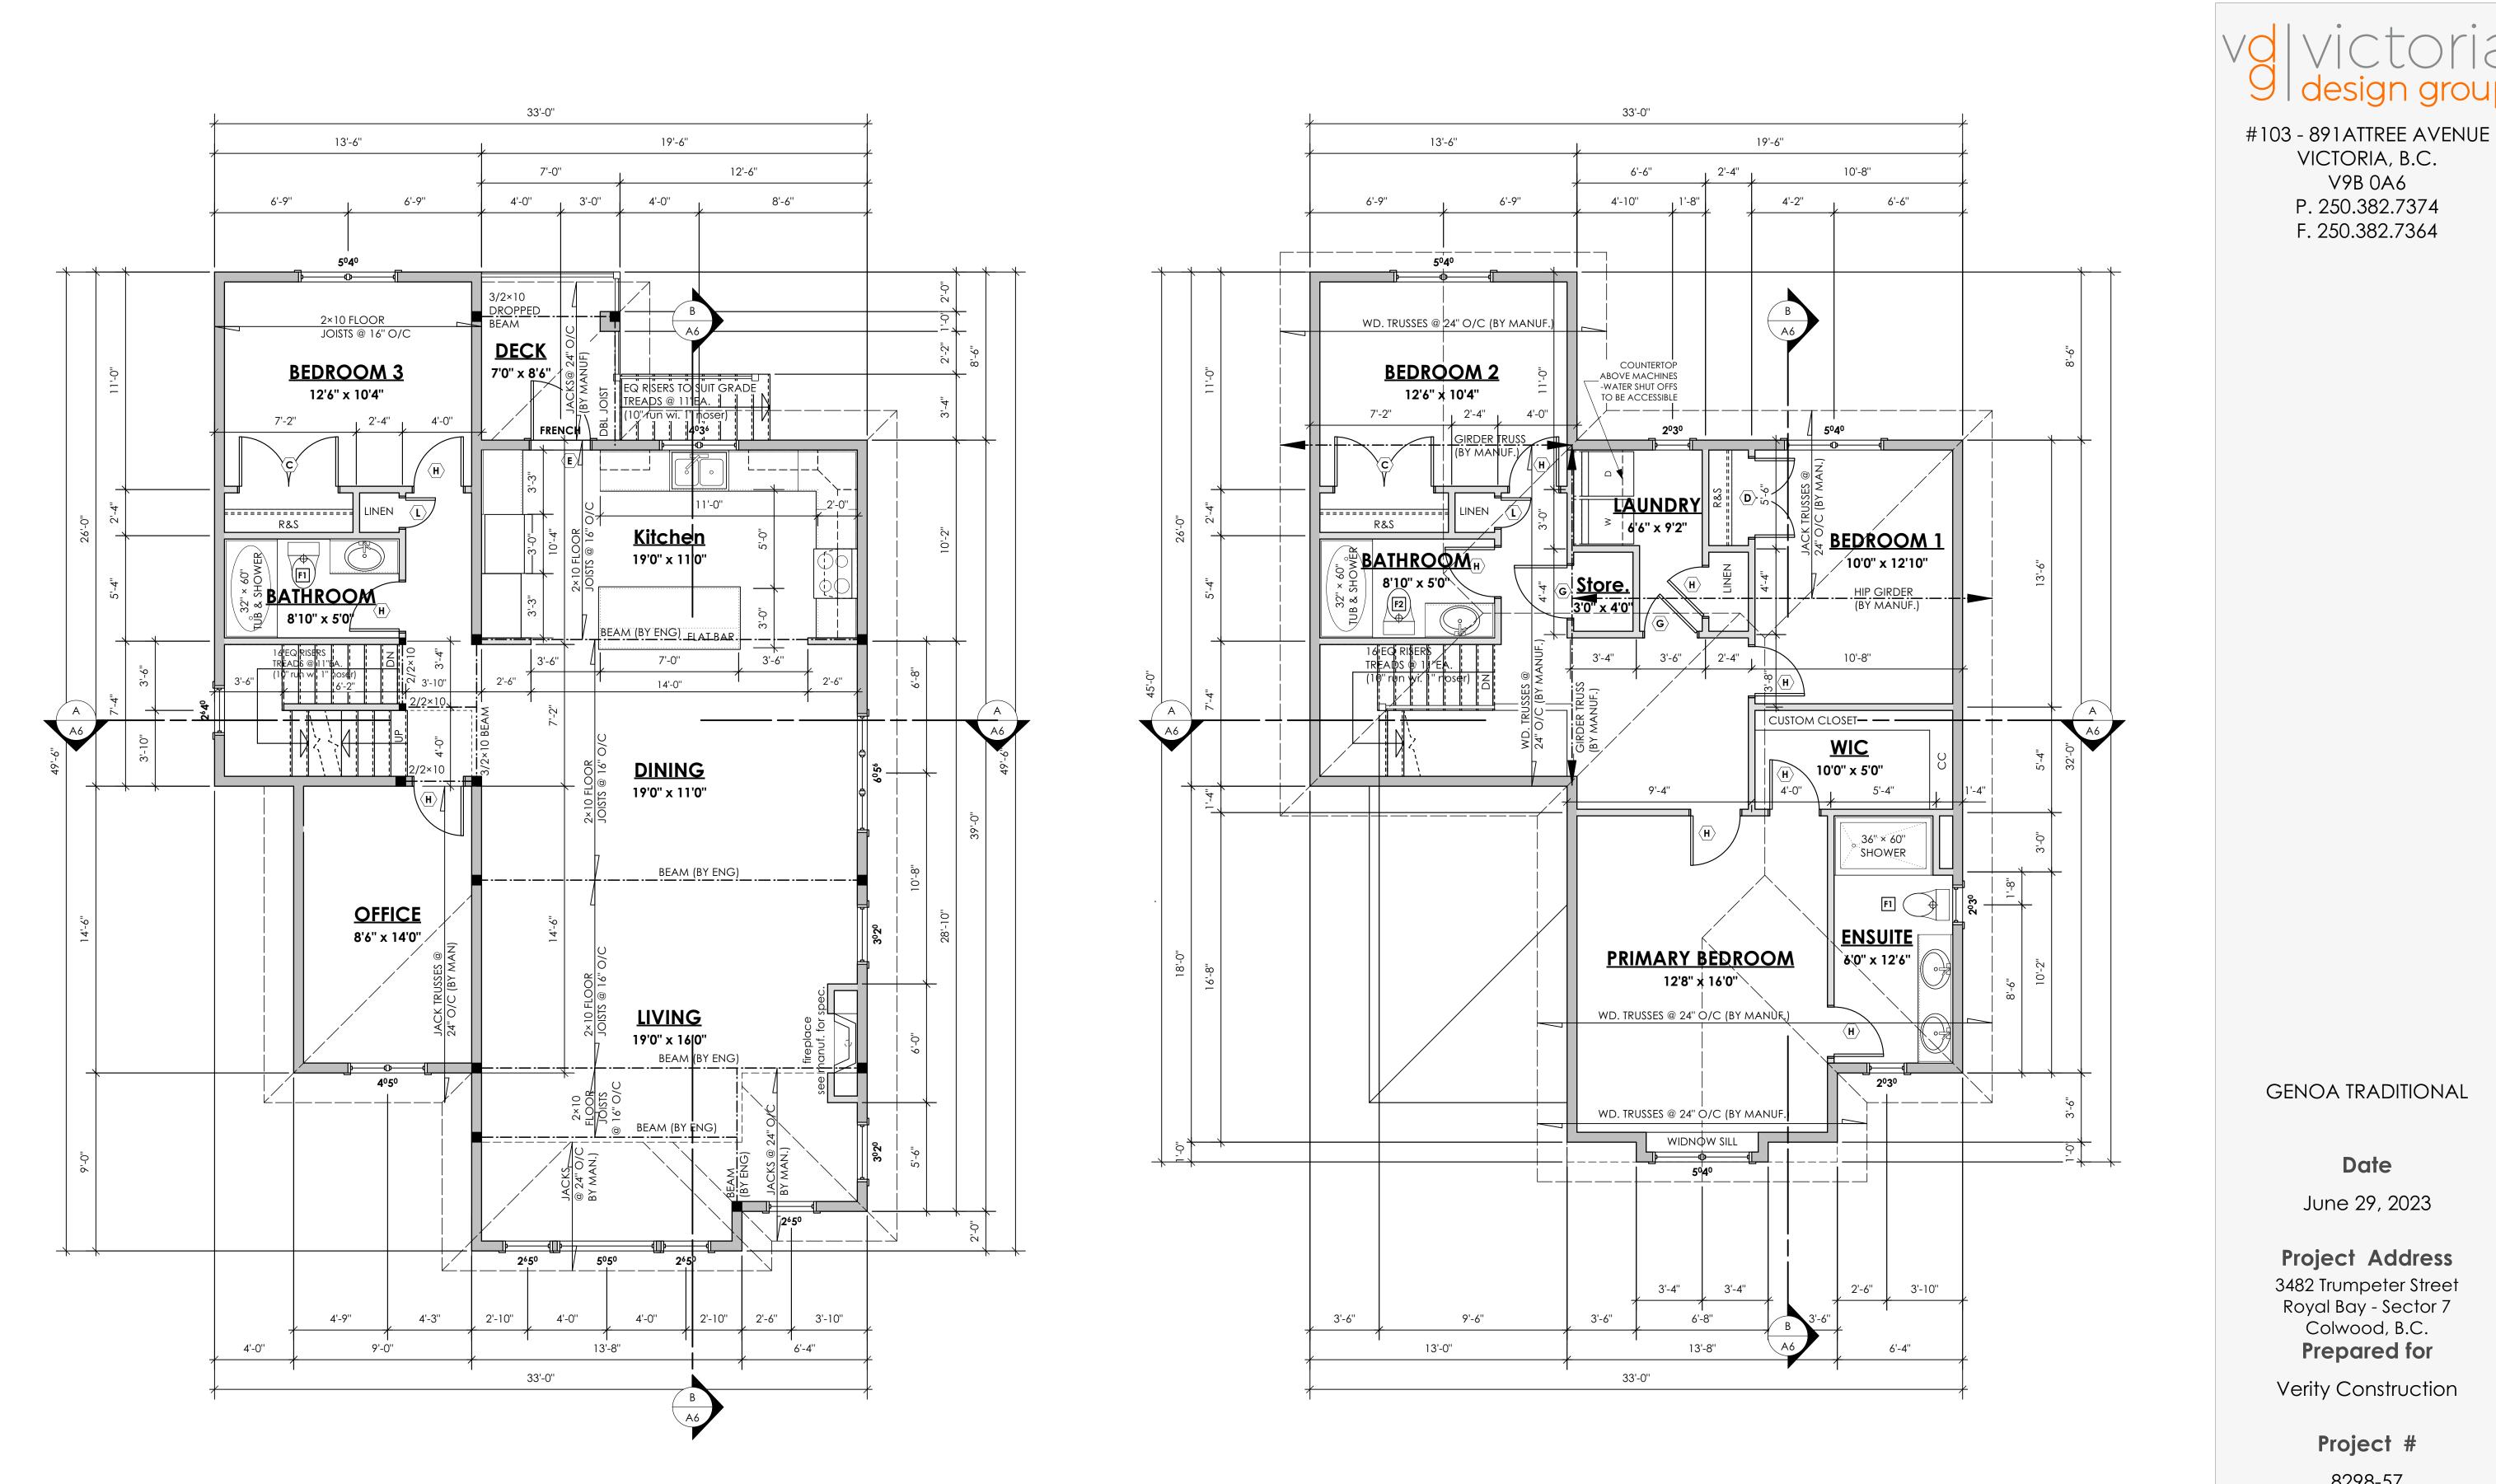

NOTE:
ALL STRUCTURE TO BE VERIFIED OR DESIGNED BY A STRUCTURAL ENGINEER.

AND INTERIOR WALL BRACING TO RESIST LATERAL LOADS IN COMPLIANCE

STRUCTURAL ENGINEER TO LOCATE AND DESIGN REQUIRED EXTERIOR

WITH B.C. BUILDING CODE 9.23.13. AND SUPPLY DETAILS IF REQUIRED

STRUCTURAL WOOD ELEMENTS WITHIN 150MM (6") FROM FINISHED GROUND LEVEL SHALL BE PRESSURE TREATED WITH A PRESERVATIVE

FOR TERMITE AND DECAY PROTECTION B.C.B.C. 9.3.2.9.(3)

Main Floor Plan

PRIMARY: 1252.75 sq.ft. (116.38 sq.m.)

Scale: 1/4" = 1'-0"

VICTORIA, B.C.

V9B 0A6

P. 250.382.7374

F. 250.382.7364

GENOA TRADITIONAL

Date

June 29, 2023

**Project Address** 3482 Trumpeter Street Royal Bay - Sector 7 Colwood, B.C. Prepared for

Verity Construction

Project #

8298-57

Scale

As Noted

Drawn By


MDK

Development Permit Presentation

Upper Floor Plan

PRIMARY: 963.14 sq.ft. (89.48 sq.m.)

Scale: 1/4" = 1'-0"

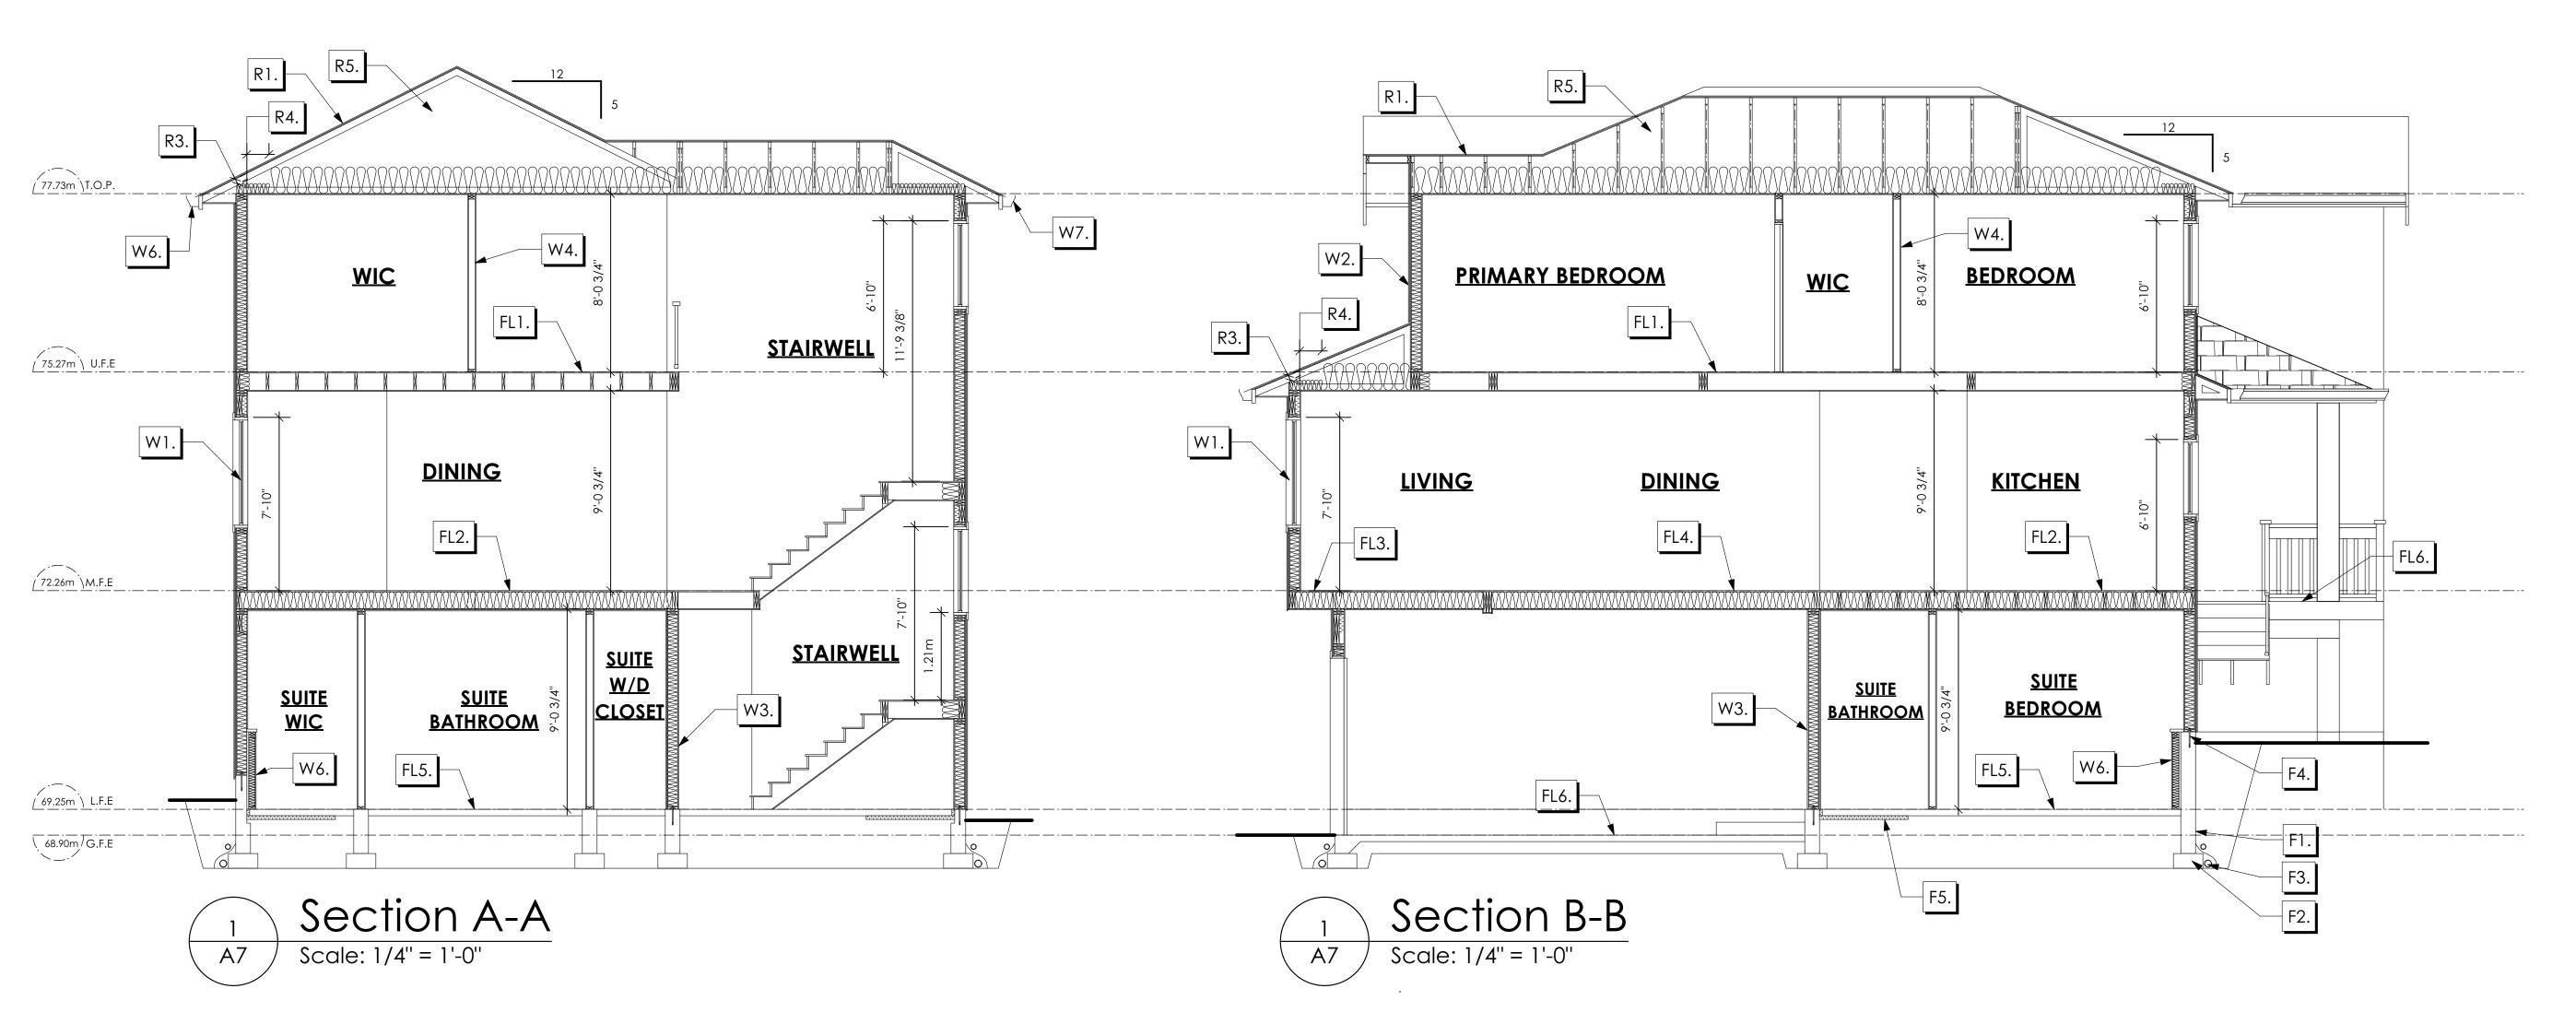

- R1. LAMINATED ASPHALT SHINGLES ON
  7/16" ORIENTED STRAND BOARD C/W "H" CLIPS
  WD TRUSSES (DESIGNED BY MANUF.)
  R-40 FIBRE GLAS BATT INSULATION OR
  14 1/2" FIBRE GLASS LOOSE FILL INSULATION
  6 MIL POLY'N V.B.
  5/8" GYPSUM BOARD
- R2. LAMINATED ASPHALT SHINGLES ON 7/16" ORIENTED STRAND BOARD C/W "H" CLIPS WD TRUSSES (DESIGNED BY MANUF.) 1/2" ORIENTED STRAND BOARD VENTED SOFFIT
- R3. PROVIDE 2 1/2" (63MM) CLEAR BETWEEN
  R-20 INSULATION AND SHEATHING.
  (MIN. R-20 @ ROOF-WALL CONNECTION FOR
  4'-0" (1.2M) AROUND PERIMETER OF BUILDING.
  AIR VENTILATION BAFFLES TO BE INSTALLED
  WHERE REQUIRED IN AS PER BCBC 9.19.)
- R4. EAVE PROTECTION

  CONT. UP ROOF SLOPE FOR 12"

  PAST EXTERIOR WALL.
- R5. PROVIDE 1 SQ.FT. ATTIC VENT PER
  300 SQ.FT. OF INSULATED AREA MIN.
  25% OF REQUIRED TO BE @ TOP AND BOTTOM
  (TO COMPLY WI. B.C. BLDG. CODE 9.19.1)
- R6. PRE-FIN. FASCIA GUTTER
  2×8 FASCIA BD.
  2×4 SUB. FASCIA BD.
  VENTED SOFFIT
  (SEE CONTRACTOR)
- R7. PRE-FIN. FASCIA GUTTER
  2×8 FASCIA BD.
  2×4 SUB. FASCIA BD.
  1/2" ORIENTED STRAND BOARD
  VENTED SOFFIT
  (SEE CONTRACTOR)

- FL1. FINISHED FLOORING ON
  11/16" ORIENTED STRAND BOARD
  (FASTENED & GLUED TO FLOOR STRUCT. BELOW) ON
  2×10 FLOOR JOISTS @ 16" OR 12" O/C
  C/W 2×2 X-BRIDGING @ 7.0' O/C (MAX)
  1/2" GYPSUM BOARD
- FL2. B.C. BUILDING CODE (TABLE-9.10.3.1.B)
  RATED FLOOR ASSEMBLY F8D
  FINISHED FLOORING ON
  11/16" ORIENTED STRAND BOARD
  (FASTENED & GLUED TO FLOOR STRUCT. BELOW) ON
  2×10 FLOOR JOISTS @ 16" OR 12" O/C
  C/W 2×2 X-BRIDGING @ 7.0' O/C (MAX)
  R-31 INSULATION
  RESILIENT METAL CHANNELS @ 24" O/C
  1 LAYERS 5/8" X-TYPE GYPSUM BOARD
  30 MINUTE F.R.R., 50 S.T.C.
- FL3. FINISHED FLOORING ON

  11/16" ORIENTED STRAND BOARD

  (FASTENED & GLUED TO FLOOR STRUCT. BELOW) ON

  2×10 FLOOR JOISTS @ 16" OR 12" O/C

  C/W 2×2 X-BRIDGING @ 7.0' O/C (MAX)

  PROVIDE R-31 F/G BATT INSULATION IN

  JOIST CAVITY C/W

  BUILDING WRAP

  VENTED SOFFIT (TO OWNERS SPEC'S)

  TO ALL SUSPENDED FLOOR AREAS
- FL4. FINISHED FLOORING ON

  19/32" ORIENTED STRAND BOARD
  (NAILED & GLUED TO FLOOR STRUCT. BELOW) ON

  2×10 FLOOR JOISTS @ 16" OR 12" O/C
  C/W 2×2 X-BRIDGING @ 7.0' O/C (MAX)

  R-31 INSULATION

  5/8" X-TYPE GYPSUM BOARD
  (BETWEEN GARAGE AND LIVING SPACE)
- FL5. 3 1/2" CONCRETE SLAB
  6 MIL. POLY'N V.B.
  6" COMPACTED GRAVEL OR SAND
- FL6. 3 1/2" CONCRETE SLAB
  6 MIL. POLY'N V.B.
  6" COMPACTED GRAVEL OR SAND
  SLOPE TO DOORS 1"
  (NOT IN SECTION)
- FL7. DECKING MEMBRANE

  (TO COMPLY WITH CAN/CGSB 37.54) ON

  11/16" ORIENTED STRAND BOARD

  2×10 DECK JOISTS @ 16" O/C C/W

  (PROVIDE ADEQUATE MEMBRANE

  "UPSTAND" @ EXT. WALL.)

  (SLOPE JOISTS TO PROVIDE MIN.1:50 SLOPE)

- W1. DOUBLE GLAZING
  ENERGY STAR LOW "E" RATING IN
  THERMAL BREAK FRAMES
  2/2"X10" LINTEL OVER (@ bearing walls only)
  (TYPICAL, wi. 2 1/2" XPS insulation)
  FLASHING OVER @ EXTERIOR
  (glazing in all exterior doors & within 3 ft.
  of exterior doors to be shatterproof (SP))
  WINDOW REQUIREMENTS DERIVED FROM
  CITY OF COLWOOD BUILDING BYLAW
  AND ARE TO BE USED TO SATISFY
  THE REQUIREMENTS OF
  AAMA/WDMA/CSA 101/I.S.2/A440, "NAFS":
  COLWOOD, CLASS R PG30 (220) A3,
- W2. CONC. FIBRE BOARD ON
  9.5MM (3/8") AIR SPACE / STRAPPING
  3/8"×2" BORATE TREATED PLYWOOD STRAPPING
  HOUSE WRAP (A.B.) (TYVEK OR EQ.)
  7/16" ORIENTED STRAND BOARD SHEATHING
  2×6 STUDS @ 16" O/C
  R-20 INSULATION
  6 MIL. POLYETHYLENE VAPOUR BARRIER
  1/2" GYPSUM BOARD

RATINGS MUST BE CLEARLY LABELED ON ALL

UNITS UPON INSTALLATION FOR INSPECTION.

W3. B.C. BUILDING CODE (TABLE 9.10.3.1.A)
RATED WALL ASSEMBLY W3C

1 LAYER 1/2" X-TYPE GYPSUM BOARD
RESILIENT METAL CHANNELS @ 24" O/C
2×4 STUDS @ 16" O/C OR
2×6 STUDS @ 16" O/C (IF NOTED) C/W
3 1/2" FIBRE GLASS SOUND BATTS
1 LAYER 1/2" X-TYPE GYPSUM BOARD
45 MIN. F.R.R 43 S.T.C
(BETWEEN PRIMARY LIVING & SECONDARY SUITE)

- W4. INTERIOR PARTITION

  1/2" GYPSUM BOARD ON EACH SIDE

  OF 2×4 STUDS @ 16" O/C OR

  2×6 STUDS @ 16" O/C (IF NOTED)
- W5. 5/8" X-TYPE GYPSUM BOARD ON 2×6 STUDS @ 16" O/C C/W
  R-20 INSULATION
  6 MIL. POLY'N V.B
  1/2" GYPSUM BOARD
  (BETWEEN GARAGE & LIVING)
  (not in section)
- W6. 1/2" GYPSUM BOARD ON
  6 MIL. POLY'N V.B.
  2×4 STUDS @ 24" O/C C/W
  R-12 BATT INSULATION
  BUILDING WRAP OR
  12.7MM (1/2") AIR SPACE
  (PROVIDE REQUIRED FIRE STOPS IN WALL
  ASSEMBLIES TO COMPLY WITH

B.C. BLDG. CODE 9.10.16.)

- F1. DAMP PROOFING (WHERE REQUIRED) ON 8" THK. CONC. FOUNDATION WALL C/W 15 M BARS @ 24" O/C B/W
- F2. 16"X 8" CONC. FOOTINGS

  C/W 2 (TWO) 15M BARS CONT. 3 IN. FROM BOTT.

  ON UNDISTURBED SOIL (SOLID BEARING)
- F3. 4" PERIMETER DRAIN 3" TIGHT PIPE FOR RWL DRAIN ROCK
- F4. ANCHOR BOLTS @ 4.0 FT. O/C MAX C/W SILL GASKETS
- F5. STEP DOWN TO GARAGE SLAB MAY VARY, VERIFY EXTENT ON SITE (NOT IN SECTION)

volvictoria 9 design group

#103 - 891 ATTREE AVENUE VICTORIA, B.C. V9B 0A6 P. 250.382.7374 F. 250.382.7364

GENOA TRADITIONAL

Date

June 29, 2023

Project Address
3482 Trumpeter Street
Royal Bay - Sector 7
Colwood, B.C.
Prepared for

Verity Construction

Project #

8298-57

Scale


As Noted

Drawn By

MDK



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Project #

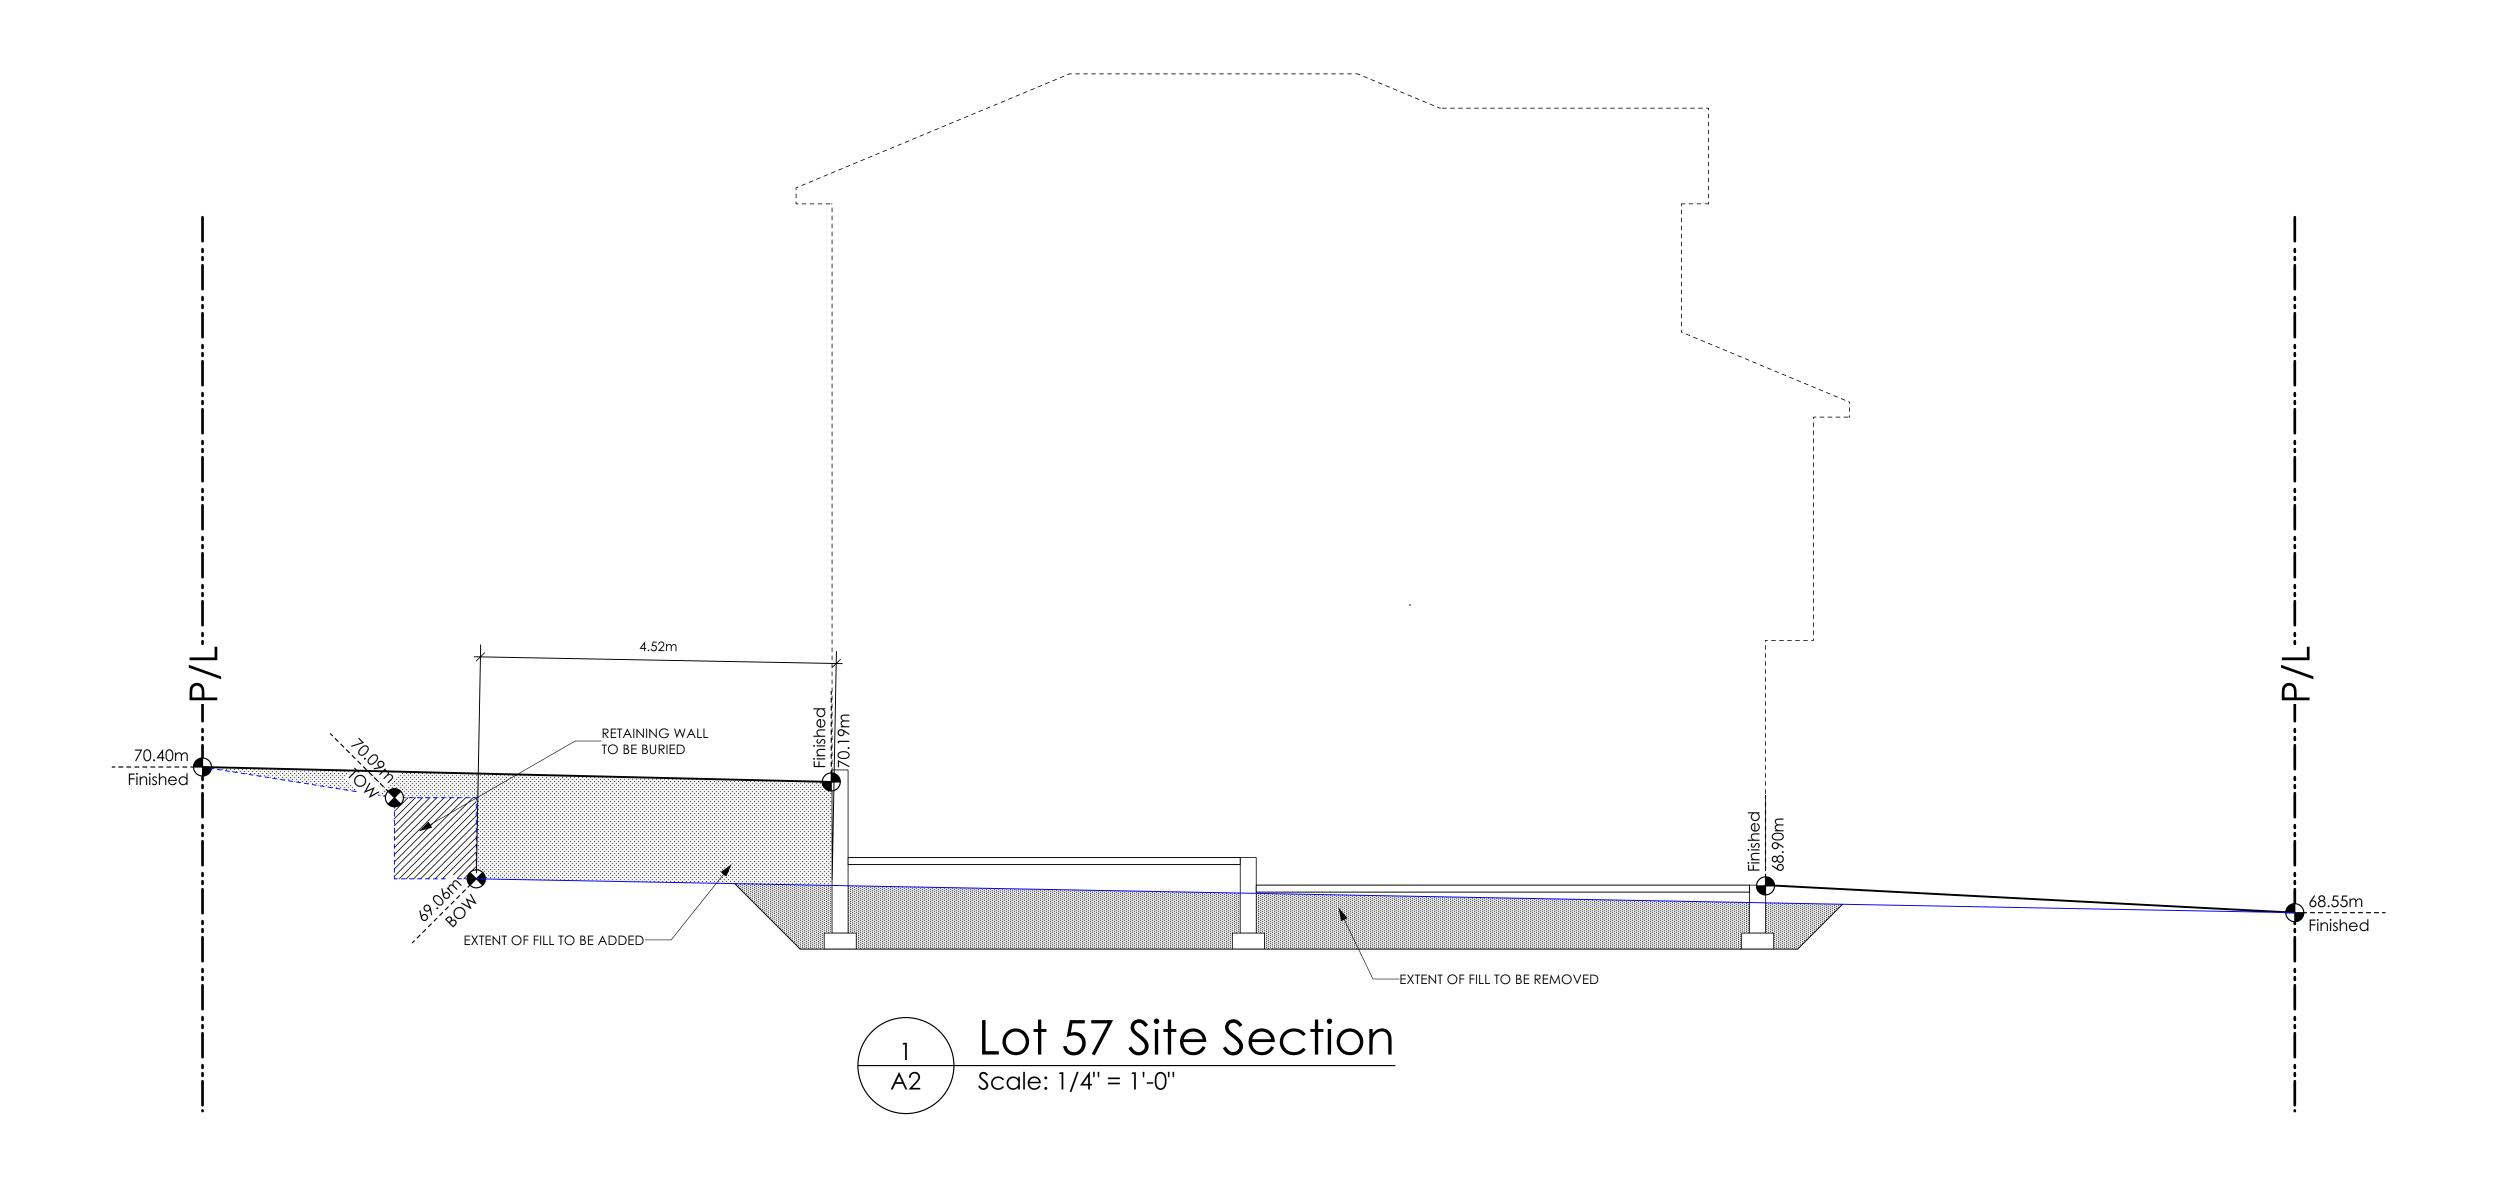8298-57

Scale

As Noted

Drawn By

MDK

### ALL FENCING, RETAINING AND LANDSCAPING MUST MEET THE **GUIDELINE REQUIREMENTS**

ALL RETAINING WALLS ARE TO BE STAND ALONE STRUCTURES (THEY MUST TERMINATE AT PROPERTY LINE) AND MUST NOT CONNECT TO RETAINING WALLS LOCATED ON ADJACENT PRIVATE PROPERTIES

"NOTE: In the interest of maintaining high standards, the developer reserves the right to modify plans, specifications and design without prior notice. Drawings contained within are artist renderings only. Sizes and dimensions are approximate and may vary with actual plan and survey. Exterior style may change pending municipal approval. Retaining wall location and types may vary and are subject to municipal, engineering or developer discretion. Subject to change without notice. Furniture as shown on plans are for layout purposes only and are not included in the sale.


|            | ITEM     | AREA (sf) | %    |
|------------|----------|-----------|------|
| GARDEN BED |          | 351       | 12%  |
| 391        | GRAVEL   | 391       | 13%  |
| 100        | CONCRETE | 853       | 29%  |
|            | SOD      | 1,375     | 46%  |
|            | TOTAL    | 2.970     | 100% |


LEGEND UPGRADE SHRUBBERY, PLANTS AND FOUNGE PRIVACY SHEAREN PRIVACY DIRECTOR -2 GAL

LANDSCAPE PLAN


NOT TO SCALE



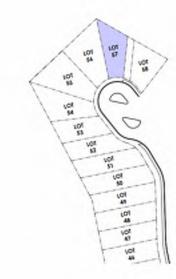

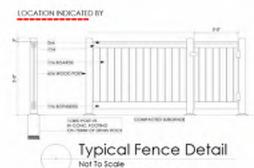

ADDITIONAL NOTES: PROPERTY TO BE IRRIGATED 6" PIPE FOR DRIVEWAY SLEEVES TO BE INSTALLED FOR CITY IRRIGATION

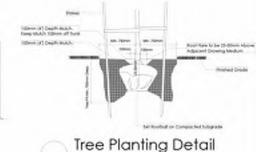

All hers and pions by the home owner to be

THICK PROJUDIAL MAIL OF PERCENTIAL VICE

LINES

|    | MM/DD/YY | ISSUED/REVISED     |  |  |  |
|----|----------|--------------------|--|--|--|
| 01 | 10/26/22 | FOR APPROVAL       |  |  |  |
| 02 | 03/02/23 | SITE PLAN REVISION |  |  |  |
| 03 | 05/12/23 | SITE PLAN REVISION |  |  |  |
|    |          |                    |  |  |  |
|    |          |                    |  |  |  |

HORTH

PRIVACY SHRUBBERY, PLANTS AND FOLIAGE TO SCREEN PARKING

PROJECT

DATE

12-4110-0

305,333 to 9

LANDSCAPING PLAN LOT 57, 3482 TRUMPETER ST. **ROYAL BAY, SECTOR 7** CITY OF COLWOOD

PRIVACY SHRUBBERY, PLANTS AND FOLIAGE TO SCREEN PARKING AND PROPERTY 2 GAL / 5 GAL

ESTIMATED LOCATION OF REAR

FENCING - SUBJECT
TO CHANGE ACCORDING TO
ACTUAL SITE CONDITIONS

27-6310 d

**LOT 57** 



CONSTRUCTION

QUALITY CONSTRUCTION. TRUSTED SERVICE.

106 - 1039 Langford Parkway Victoria, B.C. V9B 0A6

P: 250.474.1039 www.verityconstruction.ca

# GABLECTART HOMES BUILDING GRADE SLIP

| WSP | Project | No: | 201-08151-00 |
|-----|---------|-----|--------------|
|     | ,       |     |              |

C. Hume - Nov. 9/22

| BUILDING  | GRADE SLIP Issue Date:   |
|---|--|
| MUNICIPAL ADDRESS 3482 Trumpeter Street   | P.I.D.   |
| LOT 57  | PLAN   |
| BUILDER VERITY HOMES  | SUBDIVISION ROYAL BAY SECTOR 7   |
| ADDRESS   | DEVELOPER  MEADOWS DEVELOPMENT LP  |
| REPRESENTATIVE PH.  | CONSULTANT  WSP CANADA INC   |
| PROPOSED BUILDING GRADES  ALL ELEVATIONS ARE METRIC GEODETIC +  | PLAN LOT: PLAN:  |
| MAIN FLOOR ELEVATION 72.26 (TOP OF JOISTS)  |  |
| FRONT ELEV_68.90 REAR ELEV_69.10 (FINISHED GRADE) (FINISHED GRADE)  FINISHED GRADE AT GARAGE 68.90/68.88  | TRUMPETER ST.  |
| ACTUAL TOP OF FOOTING   | EG 68.2<br>MFE 69.21<br>GFE 69.01<br>MSE 65.69<br>S 65.33<br>D 66.30<br>BF   |
| SERVICES FRONT REAR CENTER REFER SIZE TO PLAN (mm)  WATER   |  |
| SANITARY 100  | 70.4   |
| STORM 100   |  |
| COMMENTS YES NO   | RETAINING WALL   |
| DRAIN TO SUMP PUMP LIKELY REQUIRED (FOR BASEMENT IF INSTALLED)  |  |
| SEWER TO SUMP PUMP LIKELY REQUIRED  (FOR BASEMENT IF INSTALLED)   | LEGEND  STREET   |
| SERVICES INSTALLED TO m INSIDE PROPERTY   | ZYN L'<br>Ø55  |
| CERTIFICATION REQUIRED  | SROW (SHOWN ON ABOVE PLAN)   |
| GEOTECHNICAL RESTRICTIONS APPLY (SEE GEOTECHNICAL REPORT)   | SGRACIO TO STAN THE S |
| ENVIRONMENTAL RESTRICTIONS APPLY (SEE ENVIRONMENTAL REPORT)   | -  |
| UTILITY EASEMENTS AFFECT THIS LOT   | EG 49.90    LFE/MFE 47.70   — EXISTING GROUND ELEVATION    LFE/MFE 47.70   — LOWER/MAIN FLOOR ELEVATION    GFE 47.55   — GARAGE FLOOR ELEVATION  |
|   | MSE 52.20 S 49.12 (P) D 49.12 (P) D 49.12 (P)  S TORM SERVICE INV. (P) DENOTES PUMP IS LIKELY REQUIRED FOR BASEMENT IF INSTALLED  STORM SERVICE INV. (P) DENOTES PUMP IS LIKELY REQUIRED FOR BASEMENT IF INSTALLED  PROPOSED REAR SIDE YARD GRADES   |
|   |  |
| NOTES  1. IT IS THE RESPONSIBILITY OF THE BUILDER TO ENSURE THE FOOTINGS ARE PLACED ON A PROPER BASE THAT IS FREE FROM FROST,   | - LOT TYPE (L/LB/LBT) - PROPOSED REAR CORNER ELEVATIONS LANE/LOT   |
| EXCESSIVE MOISTURE AND DELETERIOUS MATERIALS AND HAVE APPROPRIATE FROST PROTECTION WHEN COMPLETED.  |  |
| <ol> <li>THE INFORMATION CONTAINED HEREIN IS BASED ON THE APPROVED<br/>LOT GRADING PLAN FOR THIS SUBDIVISION. UN—AUTHORIZED<br/>DEVIATIONS WILL BE THE RESPONSIBILITY OF THE BUILDER TO<br/>ENSURE COMPLIANCE WITH ALL LOCAL BYLAWS.</li> </ol> | I, THE BUILDER'S REPRESENTATIVE,  CERTIFY THAT THE FINAL HOUSE PLANS PROVIDED IN THE BUILDING PERMIT   |
| 3. OTHER NOTES:   | APPLICATION ARE THE SAME AS PROCESSED UNDER THIS GRADE SLIP AND THAT I UNDERSTAND THE INFORMATION AND THE REQUIREMENTS CONTAINED HEREIN AND WILL BUILD ACCORDINGLY.  |
|   | AUTHORIZED BUILDER'S REPRESENTATIVE DATE   |
|   | THE INFORMATION CONTAINED HEREIN IS BASED ON THE APPROVED LOT GRADING PLAN FOR THIS SUBDIVISION, DATED   |

### SCHEDULE 4 SITE DATA RBCD5 LOT 58 PERMITTED **PROPOSED** 550 sq.m. 370.48 sq.m. LOT AREA 50.00 % 33.25 % LOT COVERAGE 9.50 m. 6.62 m. BUILDING HEIGHT 16.50 m. LOT WIDTH 15.12 m. SETBACKS 3.00 m. 4.25 m. - FRONT - FRONT (GARAGE) 6.00 m. 6.02 m. - REAR 6.00 m. 6.00 m. - SIDE 1.20 m. 1.20 m. 1.20 m. 1.20 m. - SIDE PROPOSED FLOOR AREA 143.63 sq.m. - MAIN - LOWER 81.84 sq.m. - GARAGE 43.60 sq.m. SUB-TOTAL G.F.A. 412.70 sq.m. -43.60 sq.m. GARAGE ALLOWANCE 50.00 sq.m. GROSS FLOOR AREA 225.47 sq.m. F.A.R. 0.60 TO 1.0 SECONDARY SUITE

AVERAGE NATURAL GRADE CALCULATION 70.14 m. + 70.31 m. + 68.90 m. + 68.80 m. = 278.25 m. divided by 4 = 69.56m

## SEE LANDSCAPING PLAN FOR TREE SCHEDULE

FLOOR AREA (%)

FLOOR AREA (SQ.M.)


\*XX.Xm\* = DESIGNER APPROXIMATE HEIGHT MEASUREMENT, VERIFY ON SITE - TO BE CERTIFIED BY AN ENGINEER AND MEET BCBC REQUIREMENTS FOR EARTHQUAKE DESIGN (REFER TO STRUCTURAL DRAWINGS) - ALL LANDSCAPE RETAINING WALLS TO HAVE A 1.2m MAX. EXPOSED HT OR A MAX. 1:1 RATIO OF HEIGHT TO HORIZONTAL SEPARATION IF TERRACED

40.00 %

90.00 sq.m.


25.59 %

57.69 sq.m.

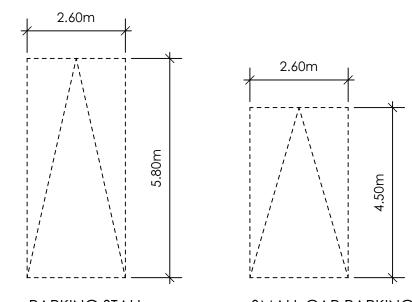


PARKING STALL **DIMENSIONS** 

SMALL CAR PARKING STALL DIMENSIONS \* as per 2.2.02a allowing one stall to be a small car parking stall

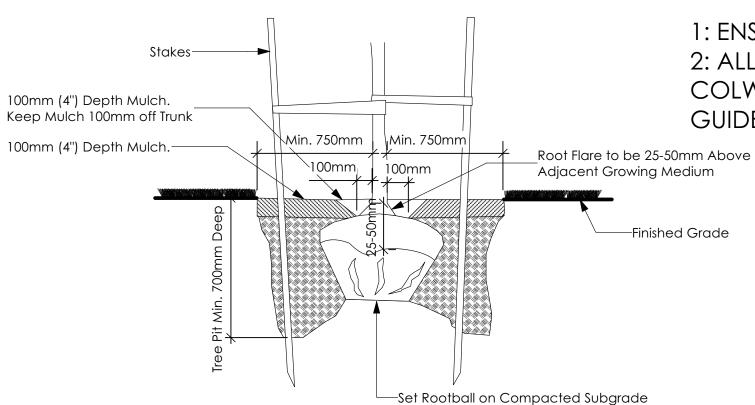



All trees and plants by the home owner to be planted in minimum 10m³ of fertile topsoil, 700mm Deep

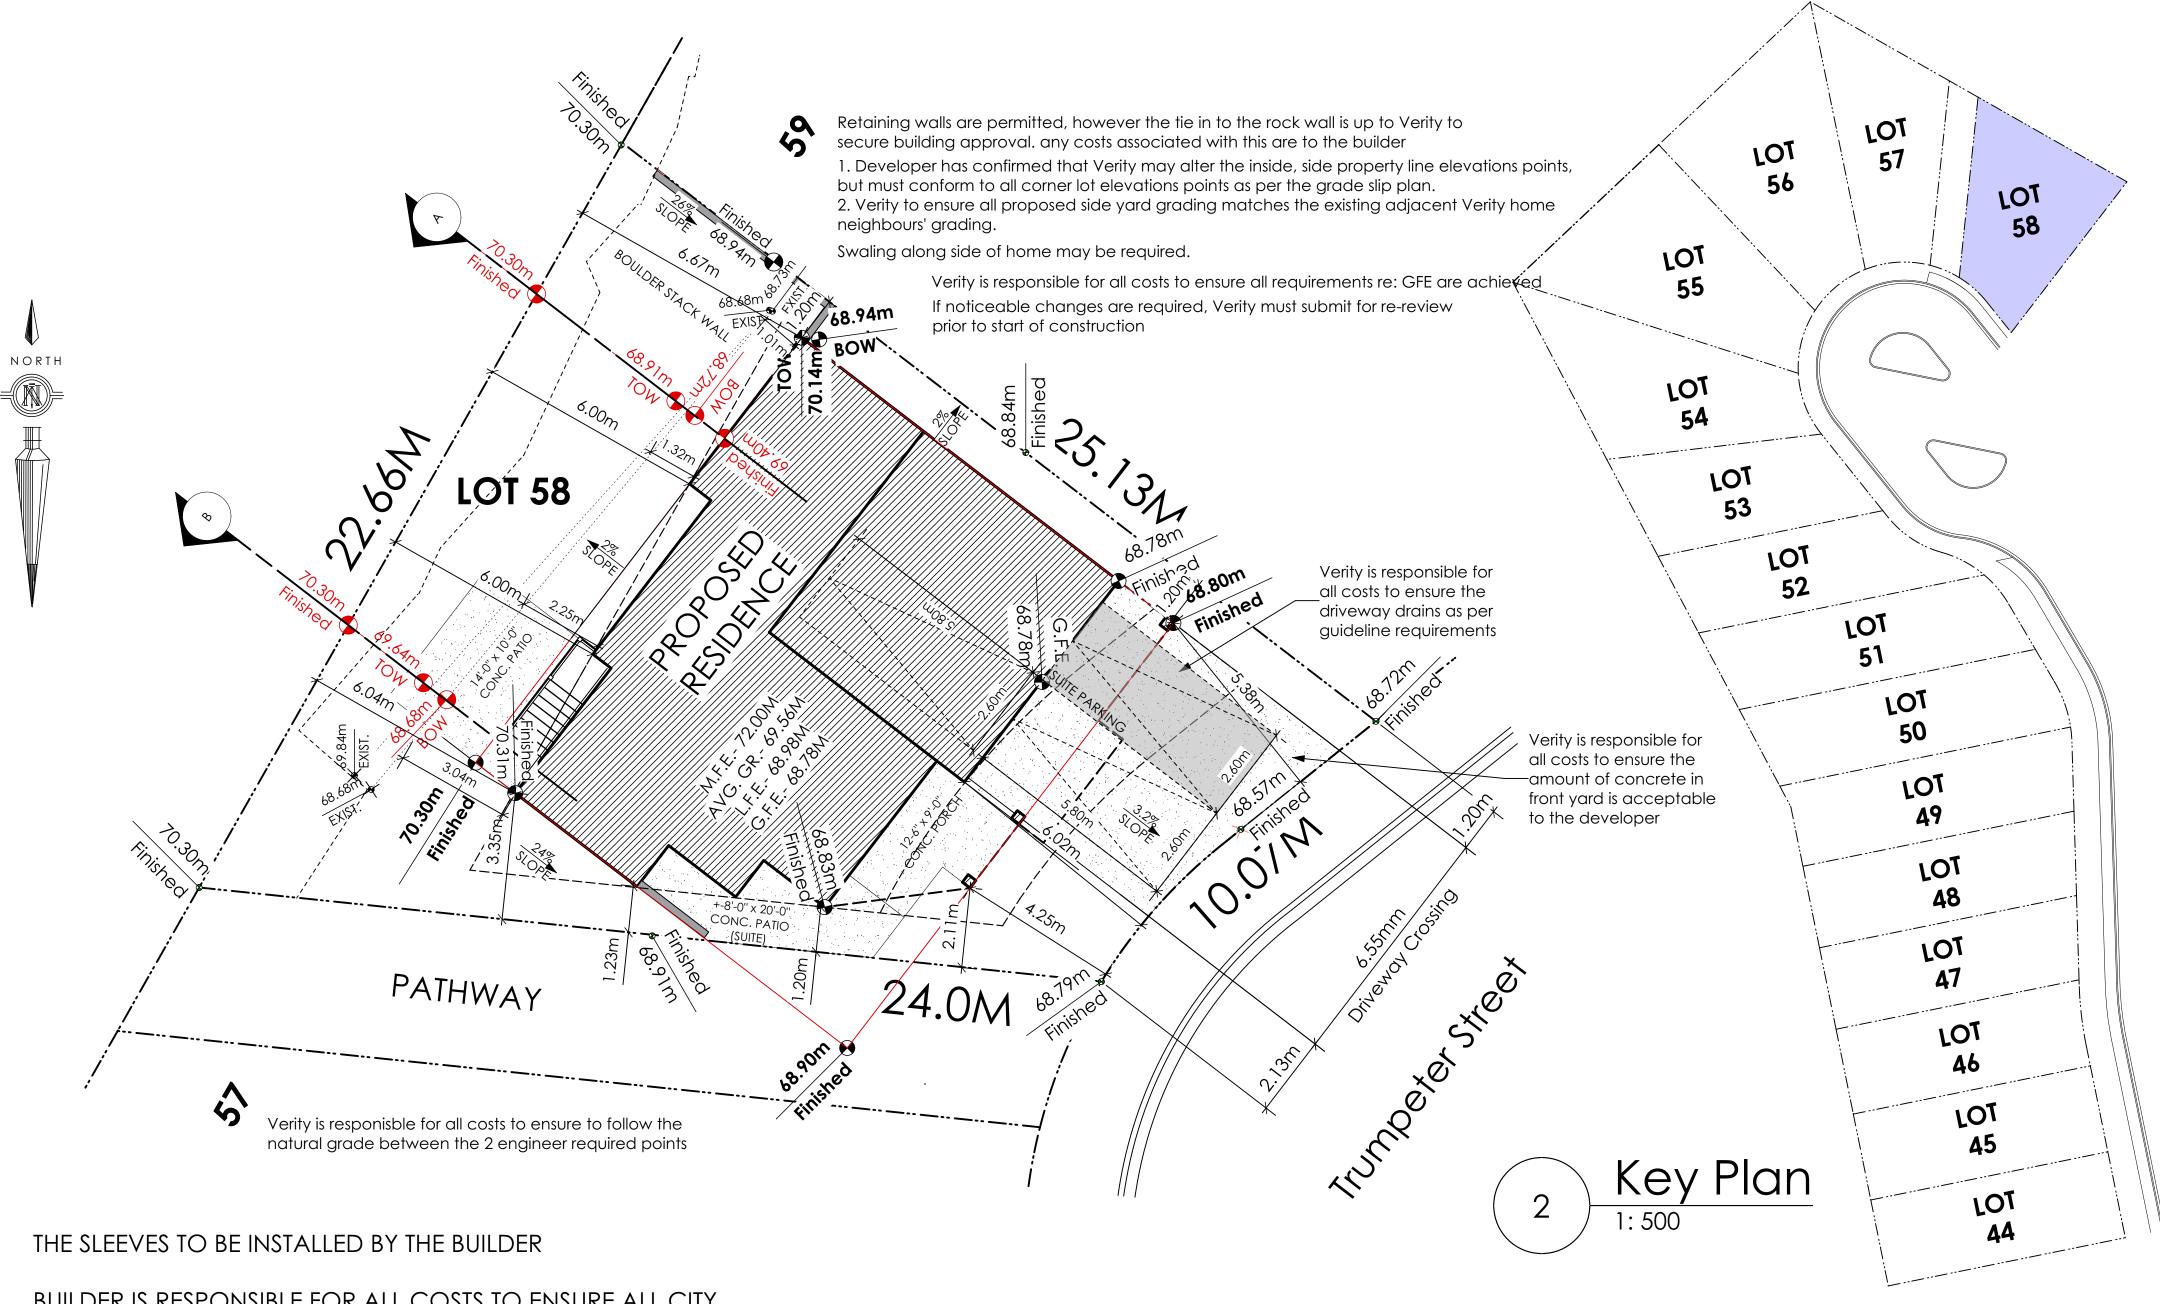


BUILDER IS RESPONSIBLE FOR ALL COSTS TO ENSURE ALL CITY OF COLWOOD GRADING AND SETBACK REQUIREMENTS HAVE BEEN ACHIEVED AND THIS PLOT PLAN COMPLIES WITH ALL REQUIREMENTS OF THE DESIGN GUIDELINES I.E. SEE APPENDIX: GRADING STANDARDS (PAGE 30) ETC.

1: ENSURE A MINIMUM 2% SLOPE AWAY FROM STRUCTURE ON ALL SIDES 2: ALL RETAINING REQUIRED ARE SUBJECT TO GEOTECHNICAL, CITY OF COLWOOD APPROVAL AND MUST FOLLOW ALL APPLICABLE DESIGN **GUIDELINES** 

Siteplan

PATH OF OVERHANG-PATH OF REAR WHEEL 7.47m 2.13M X 5.8M (7'x19') TURNING TEMPLATE Turning Template Not To Scale 2.13m

ALL FENCING, RETAINING AND LANDSCAPINING MUST MEET GUIDELINE REQUIREMENTS

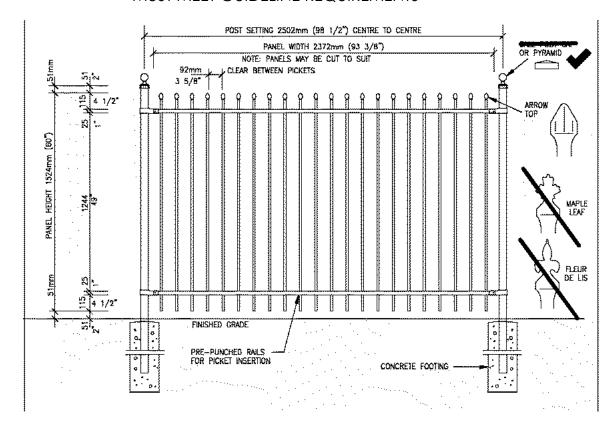

Fence Treatment Not To Scale

(SEE LANDSCAPE PLAN FOR FENCE LOCATION)

9 design group

#103 - 891ATTREE AVENUE VICTORIA, B.C. V9B 0A6 P. 250.382.7374 F. 250.382.7364

> APPROVED BY VERITY CONSTRUCTION

APPROVED BY REALTOR

**Lot 58** 3480 Trumpeter Street

Windjammer Westcoast

Date

JUne 29, 2023

## **Project Address**

3480 Trumpeter Street Royal Bay - Sector 7 Colwood, B.C.

## Prepared for Verity Construction

Project #


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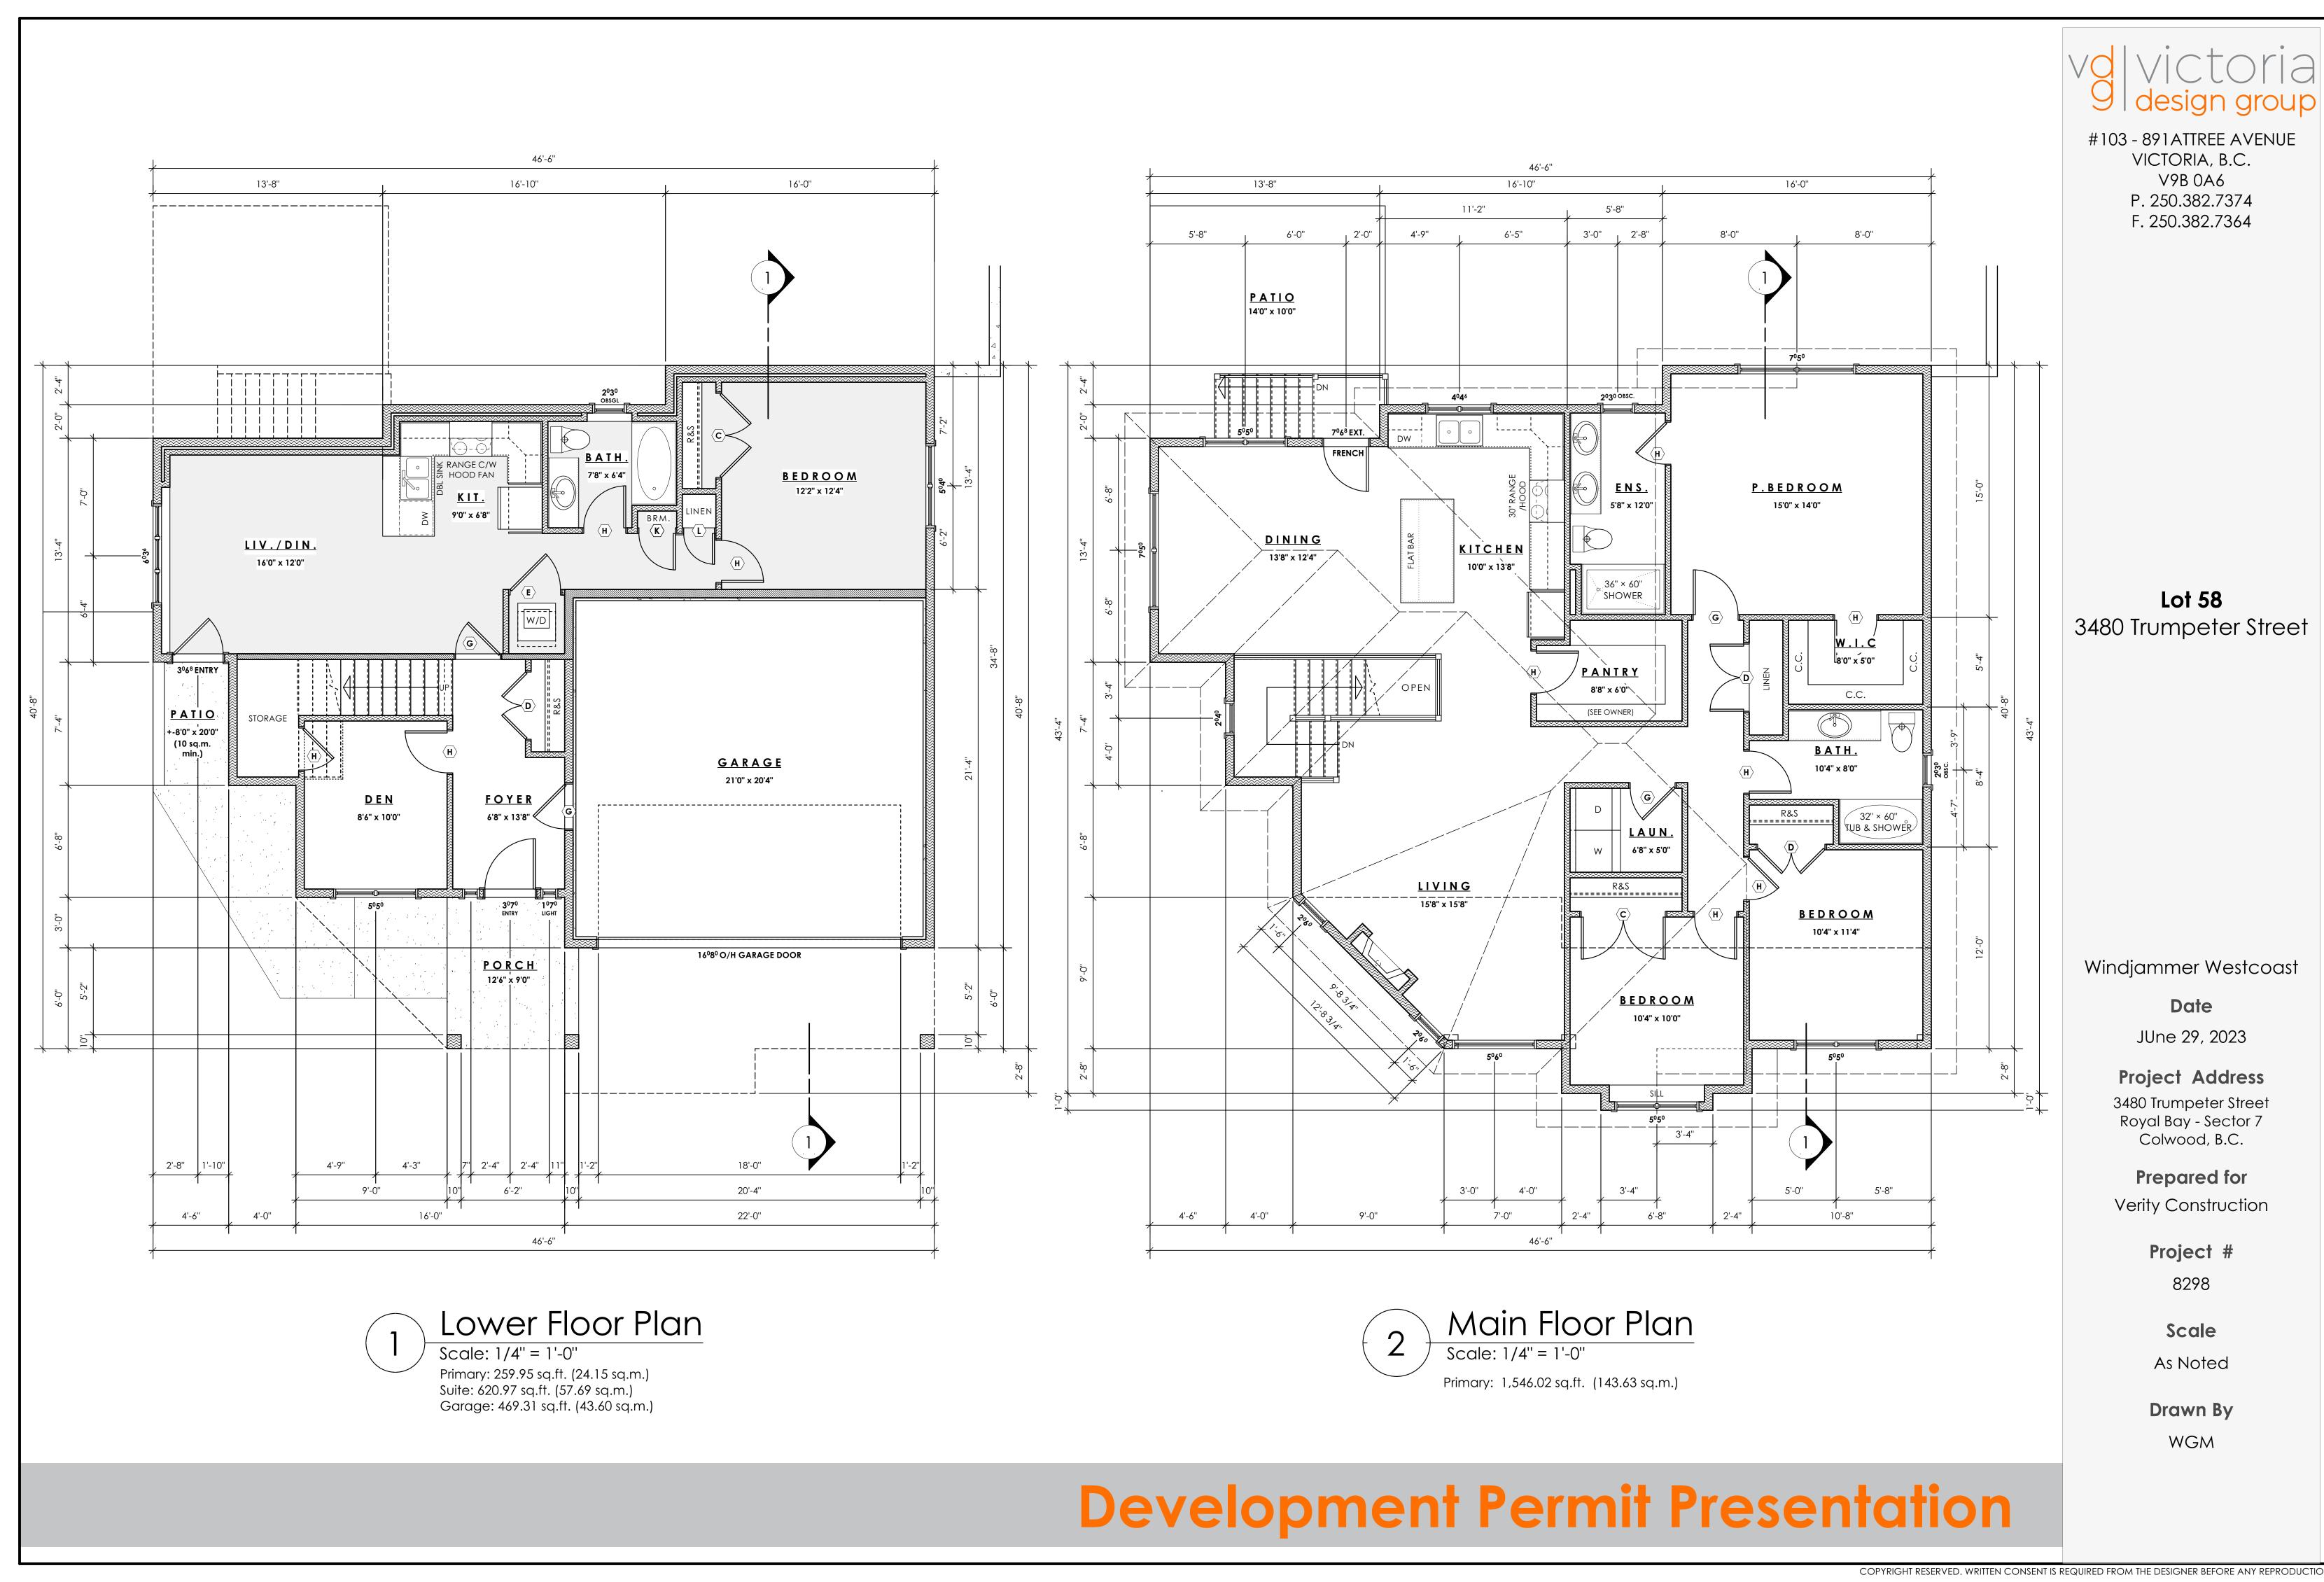
Scale

As Noted

Drawn By

WGM



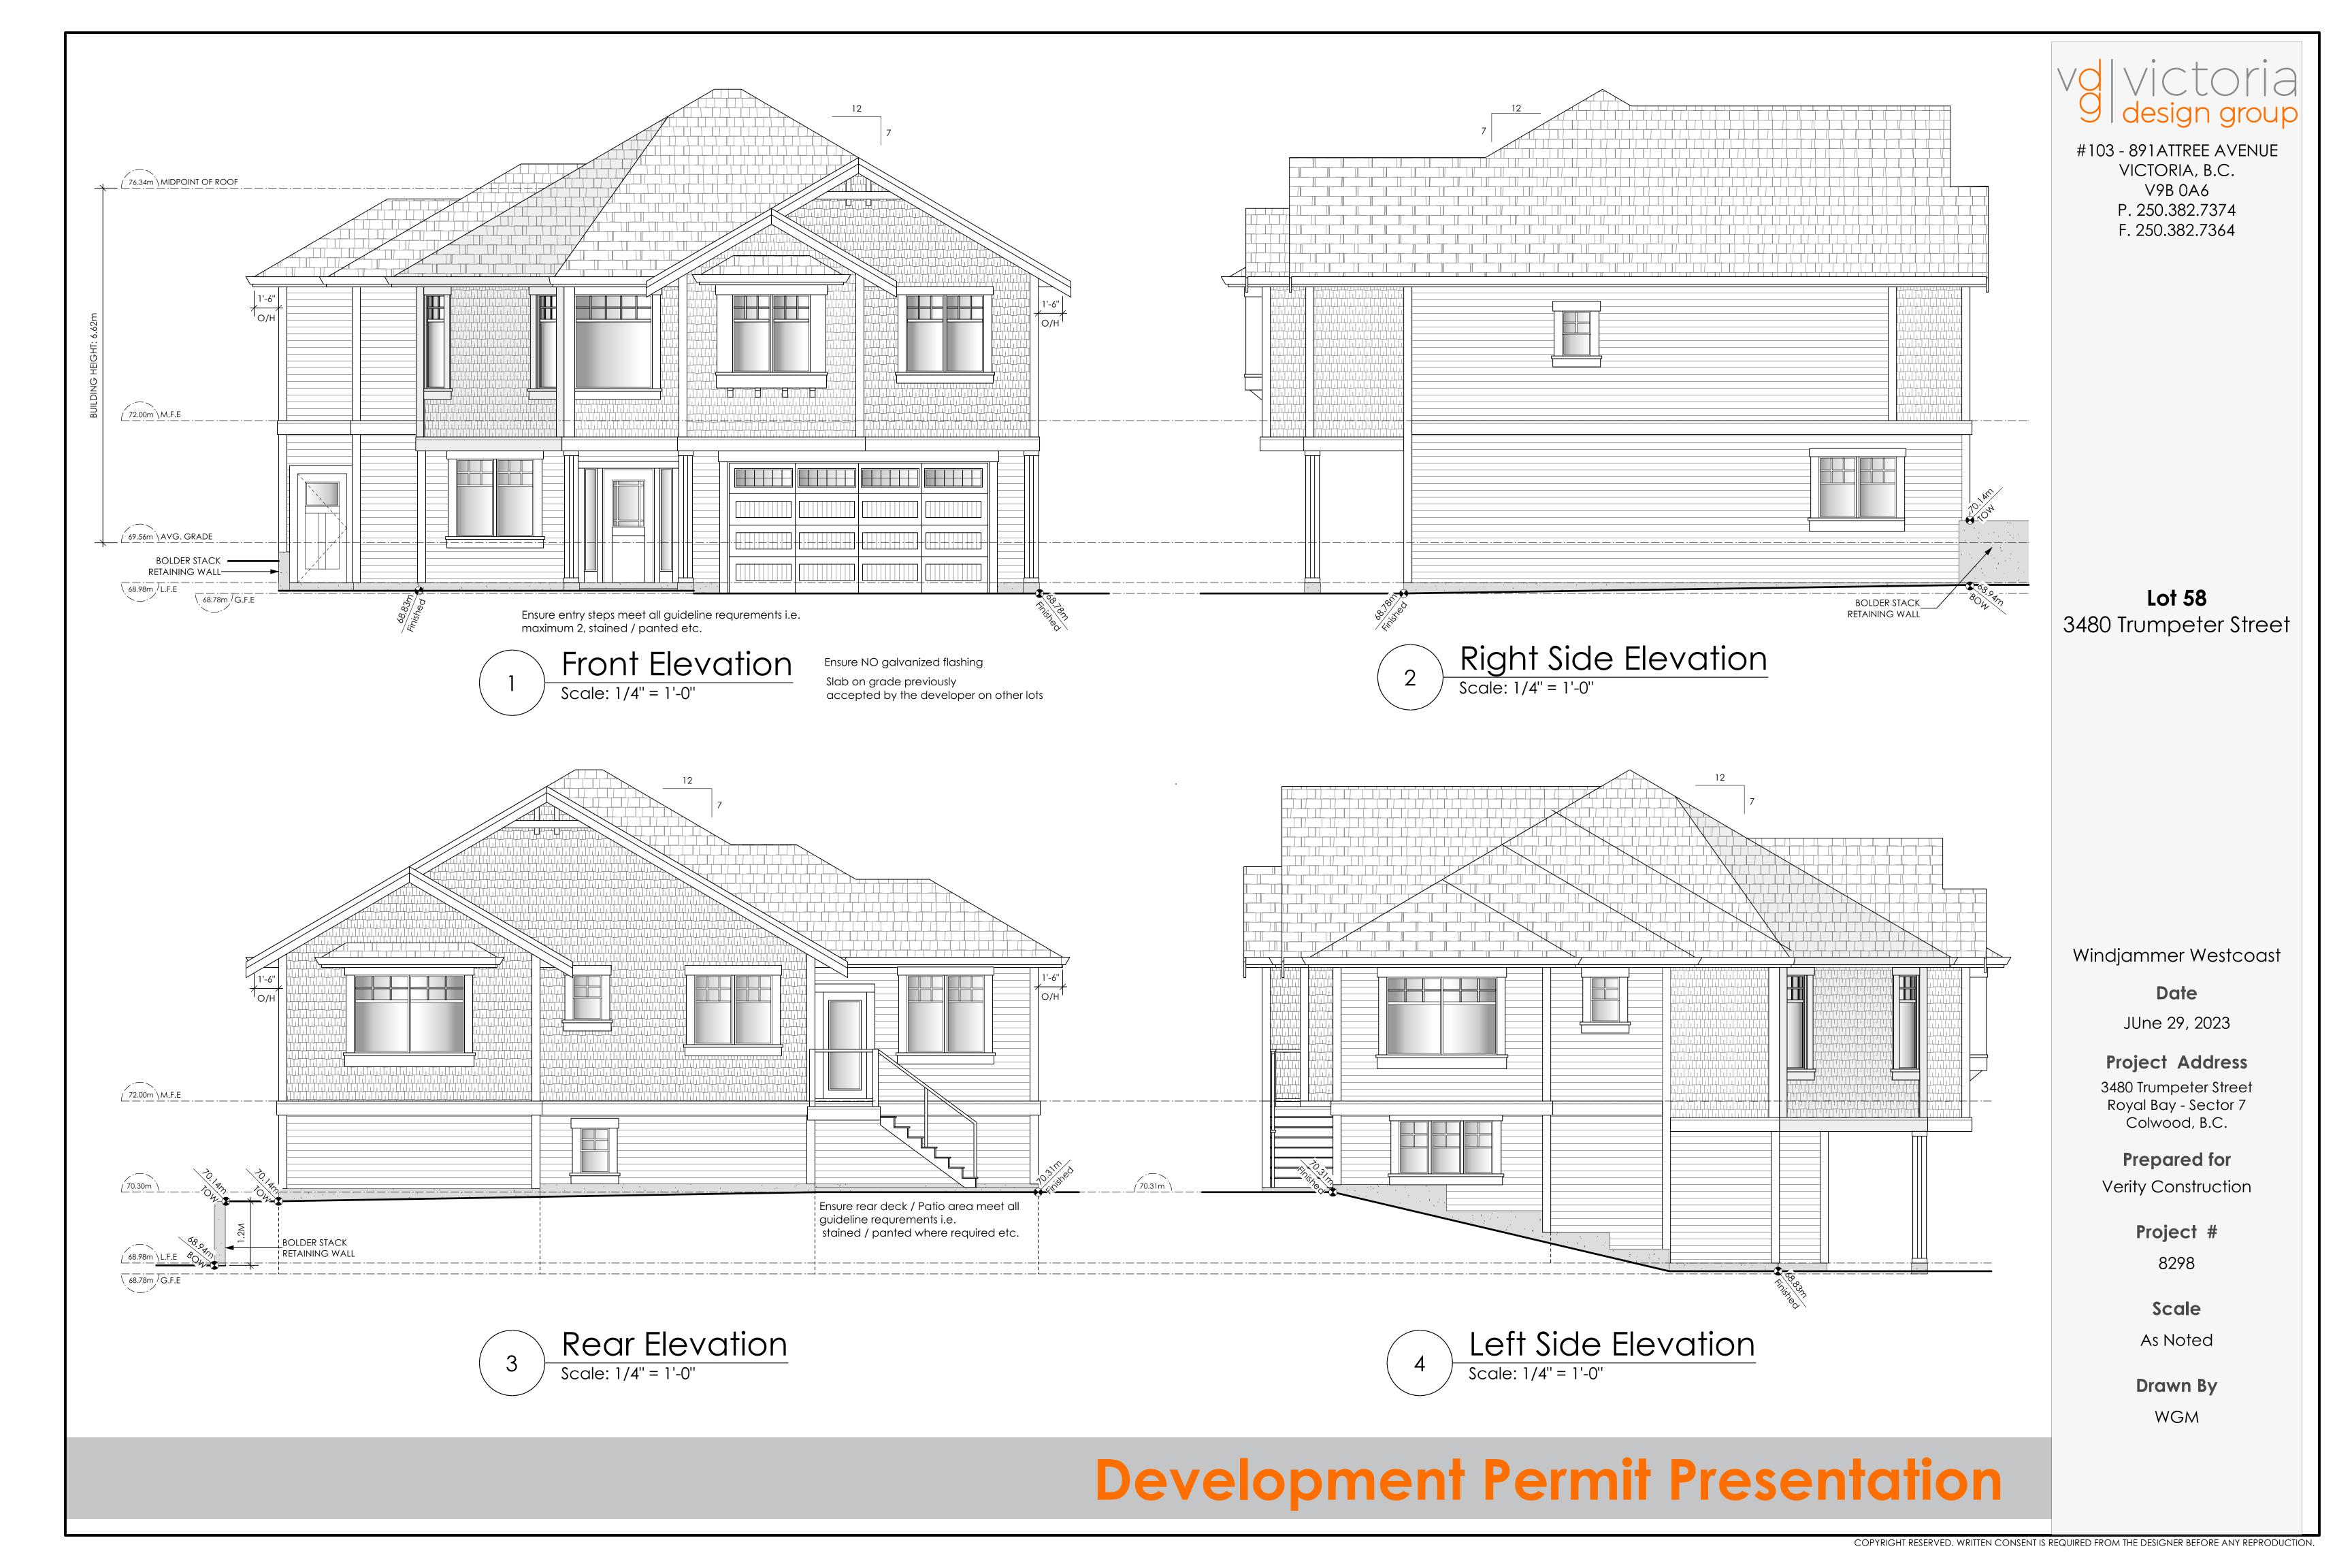





V9B 0A6 P. 250.382.7374 F. 250.382.7364

**Lot 58** 3480 Trumpeter Street

Windjammer Westcoast

Date

## **Project Address**


3480 Trumpeter Street Colwood, B.C.

Verity Construction

8298

WGM

Development Permit Presentation

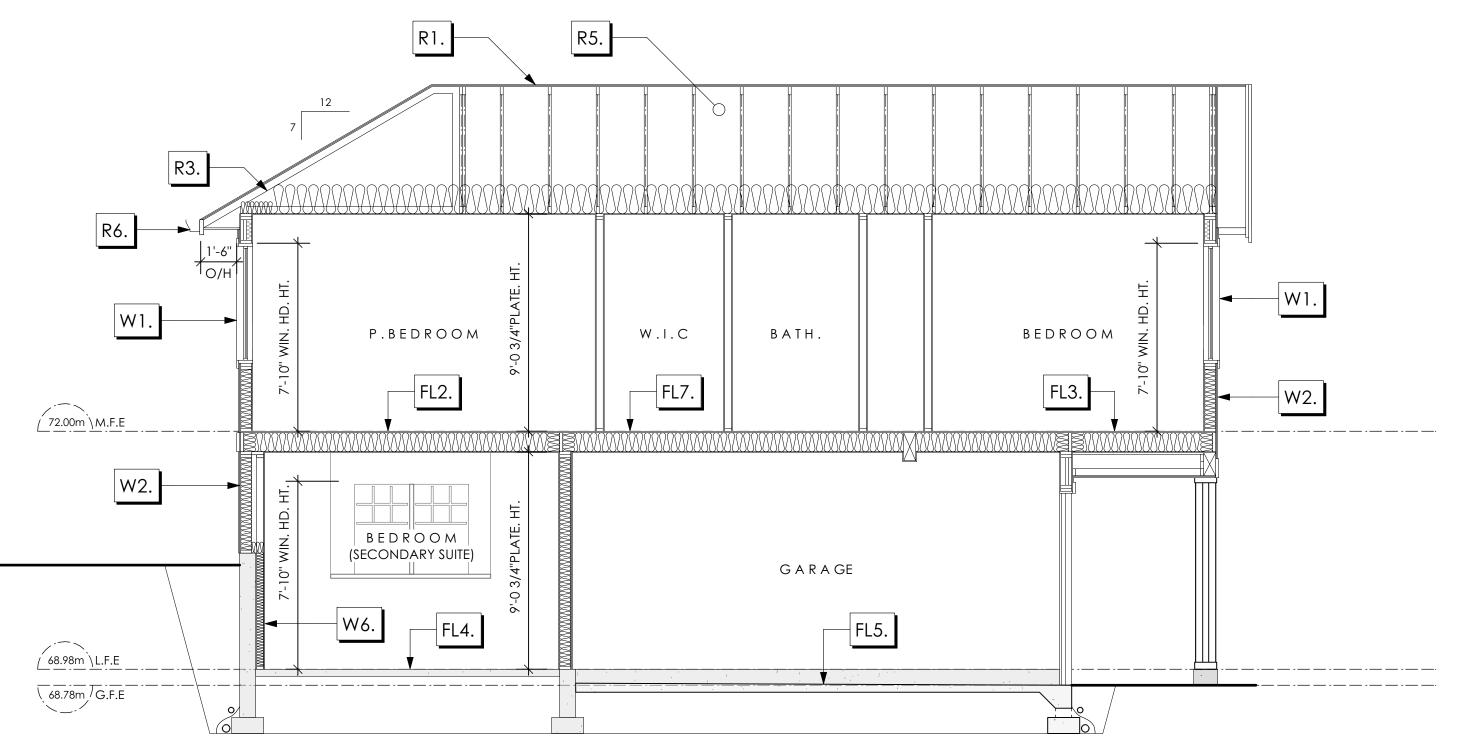

# Section A-A

# <u>Section Notes</u>

R1. LAMINATED ASPHALT SHINGLES ON 7/16" ORIENTED STRAND BOARD C/W "H" CLIPS WD TRUSSES (DESIGNED BY MANUF.) R-40 FIBRE GLAS BATT INSULATION OR 14 1/2" FIBRE GLASS LOOSE FILL INSULATION 6 MIL POLY'N V.B. 5/8" GYPSUM BOARD

R2. LAMINATED ASPHALT SHINGLES ON 7/16" ORIENTED STRAND BOARD C/W "H" CLIPS WD TRUSSES (DESIGNED BY MANUF.) 1/2" ORIENTED STRAND BOARD VENTED SOFFIT

R3. PROVIDE 2 1/2" (63MM) CLEAR BETWEEN R-20 INSULATION AND SHEATHING. (MIN. R-20 @ ROOF-WALL CONNECTION FOR 4'-0" (1.2M) AROUND PERIMETER OF BUILDING. AIR VENTILATION BAFFLES TO BE INSTALLED WHERE REQUIRED IN AS PER BCBC 9.19.)

R4. EAVE PROTECTION CONT. UP ROOF SLOPE FOR 12" PAST EXTERIOR WALL.

R5. PROVIDE 1 SQ.FT. ATTIC VENT PER 300 SQ.FT. OF INSULATED AREA MIN. 25% OF REQUIRED TO BE @ TOP AND BOTTOM (TO COMPLY WI. B.C. BLDG. CODE 9.19.1)

R6. PRE-FIN. FASCIA GUTTER 2×8 FASCIA BD. 2×4 SUB. FASCIA BD. VENTED SOFFIT (SEE CONTRACTOR)

R7. PRE-FIN. FASCIA GUTTER 2×8 FASCIA BD. 2×4 SUB. FASCIA BD. 1/2" ORIENTED STRAND BOARD VENTED SOFFIT (SEE CONTRACTOR)

## **FLOORS**

FL1. FINISHED FLOORING ON 11/16" ORIENTED STRAND BOARD (FASTENED & GLUED TO FLOOR STRUCT, BELOW) ON 2×10 FLOOR JOISTS @ 16" OR 12" O/C C/W 2×2 X-BRIDGING @ 7.0' O/C (MAX) 1/2" GYPSUM BOARD

FL2. B.C. BUILDING CODE (TABLE-9.10.3.1.B) RATED FLOOR ASSEMBLY F8D FINISHED FLOORING ON 11/16" ORIENTED STRAND BOARD (FASTENED & GLUED TO FLOOR STRUCT. BELOW) ON 2×10 FLOOR JOISTS @ 16" OR 12" O/C C/W 2×2 X-BRIDGING @ 7.0' O/C (MAX) R-31 INSULATION RESILIENT METAL CHANNELS @ 24" O/C

1 LAYERS 5/8" X-TYPE GYPSUM BOARD

TO ALL SUSPENDED FLOOR AREAS

(NOT IN SECTION)

30 MINUTE F.R.R., 50 S.T.C.

FL3. FINISHED FLOORING ON 11/16" ORIENTED STRAND BOARD (FASTENED & GLUED TO FLOOR STRUCT. BELOW) ON 2×10 FLOOR JOISTS @ 16" OR 12" O/C C/W 2×2 X-BRIDGING @ 7.0' O/C (MAX) PROVIDE R-31 F/G BATT INSULATION IN JOIST CAVITY C/W BUILDING WRAP VENTED SOFFIT (TO OWNERS SPEC'S)

FL4. FINISHED FLOORING ON 3 1/2" CONCRETE SLAB 6 MIL. POLY'N V.B. 6" COMPACTED GRAVEL OR SAND

FL5. 3 1/2" CONCRETE SLAB 6 MIL. POLY'N V.B. 6" COMPACTED GRAVEL OR SAND SLOPE TO DOORS 1"

FL6. DECKING MEMBRANE (TO COMPLY WITH CAN/CGSB 37.54) ON 11/16" ORIENTED STRAND BOARD 2×10 DECK JOISTS @ 16" O/C C/W (PROVIDE ADEQUATE MEMBRANE "UPSTAND" @ EXT. WALL.) (SLOPE JOISTS TO PROVIDE MIN.1:50 SLOPE)

FL7. FINISHED FLOORING ON 19/32" ORIENTED STRAND BOARD (NAILED & GLUED TO FLOOR STRUCT. BELOW) ON 2×10 FLOOR JOISTS @ 16" OR 12" O/C C/W 2×2 X-BRIDGING @ 7.0' O/C (MAX) R-31 INSULATION 5/8" X-TYPE GYPSUM BOARD (BETWEEN GARAGE AND LIVING SPACE)

## WALLS

W1. DOUBLE GLAZING ENERGY STAR LOW "E" RATING IN THERMAL BREAK FRAMES 2/2"X10" LINTEL OVER (@ bearing walls only) (TYPICAL, wi. 2 1/2" XPS insulation) FLASHING OVER @ EXTERIOR (glazing in all exterior doors & within 3 ft. of exterior doors to be shatterproof (SP)) WINDOW REQUIREMENTS DERIVED FROM CITY OF COLWOOD BUILDING BYLAW AND ARE TO BE USED TO SATISFY THE REQUIREMENTS OF AAMA/WDMA/CSA 101/I.S.2/A440, "NAFS": COLWOOD, CLASS R - PG30 (220) A3, RATINGS MUST BE CLEARLY LABELED ON ALL

UNITS UPON INSTALLATION FOR INSPECTION. W2. CONC. FIBRE BOARD ON 9.5MM (3/8") AIR SPACE / STRAPPING 3/8"×2" BORATE TREATED PLYWOOD STRAPPING HOUSE WRAP (A.B.) (TYVEK OR EQ.) 7/16" ORIENTED STRAND BOARD SHEATHING 2×6 STUDS @ 16" O/C R-20 INSULATION

6 MIL. POLYETHYLENE VAPOUR BARRIER 1/2" GYPSUM BOARD W3. B.C. BUILDING CODE (TABLE 9.10.3.1.A)

RATED WALL ASSEMBLY W3c 1 LAYER 1/2" X-TYPE GYPSUM BOARD RESILIENT METAL CHANNELS @ 24" O/C 2×4 STUDS @ 16" O/C OR 2×6 STUDS @ 16" O/C (IF NOTED) C/W 3 1/2" FIBRE GLASS SOUND BATTS 1 LAYER 1/2" X-TYPE GYPSUM BOARD 45 MIN. F.R.R 43 S.T.C (BETWEEN PRIMARY LIVING & SECONDARY SUITE)

## W4. INTERIOR PARTITION 1/2" GYPSUM BOARD ON EACH SIDE OF 2×4 STUDS @ 16" O/C OR 2×6 STUDS @ 16" O/C (IF NOTED)

W5. 5/8" X-TYPE GYPSUM BOARD ON 2×6 STUDS @ 16" O/C C/W R-20 INSULATION 6 MIL. POLY'N V.B 1/2" GYPSUM BOARD (BETWEEN GARAGE & LIVING)

1/2" GYPSUM BOARD ON 6 MIL. POLY'N V.B. 2×4 STUDS @ 24" O/C C/W R-12 BATT INSULATION BUILDING WRAP OR 12.7MM (1/2") AIR SPACE (PROVIDE REQUIRED FIRE STOPS IN WALL ASSEMBLIES TO COMPLY WITH B.C. BLDG. CODE 9.10.16.)

## **FOUNDATION**

F1. DAMP PROOFING (WHERE REQUIRED) ON 8" THK. CONC. FOUNDATION WALL C/W 15 M BARS @ 24" O/C B/W

F2. 16"X 8" CONC. FOOTINGS C/W 2 (TWO) 15M BARS CONT. 3 IN. FROM BOTT. ON UNDISTURBED SOIL (SOLID BEARING)

F3. 4" PERIMETER DRAIN 3" TIGHT PIPE FOR RWL DRAIN ROCK

F4. ANCHOR BOLTS @ 4.0 FT. O/C MAX C/W SILL GASKETS

MAY VARY, VERIFY EXTENT ON SITE

F5. STEP DOWN TO GARAGE SLAB

(NOT IN SECTION)

JUne 29, 2023

Royal Bay - Sector 7

Prepared for

Project #


Scale As Noted

Drawn By

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#103 - 891 ATTREE AVENUE VICTORIA, B.C. V9B 0A6 P. 250.382.7374 F. 250.382.7364



**Lot 58**3480 Trumpeter Street

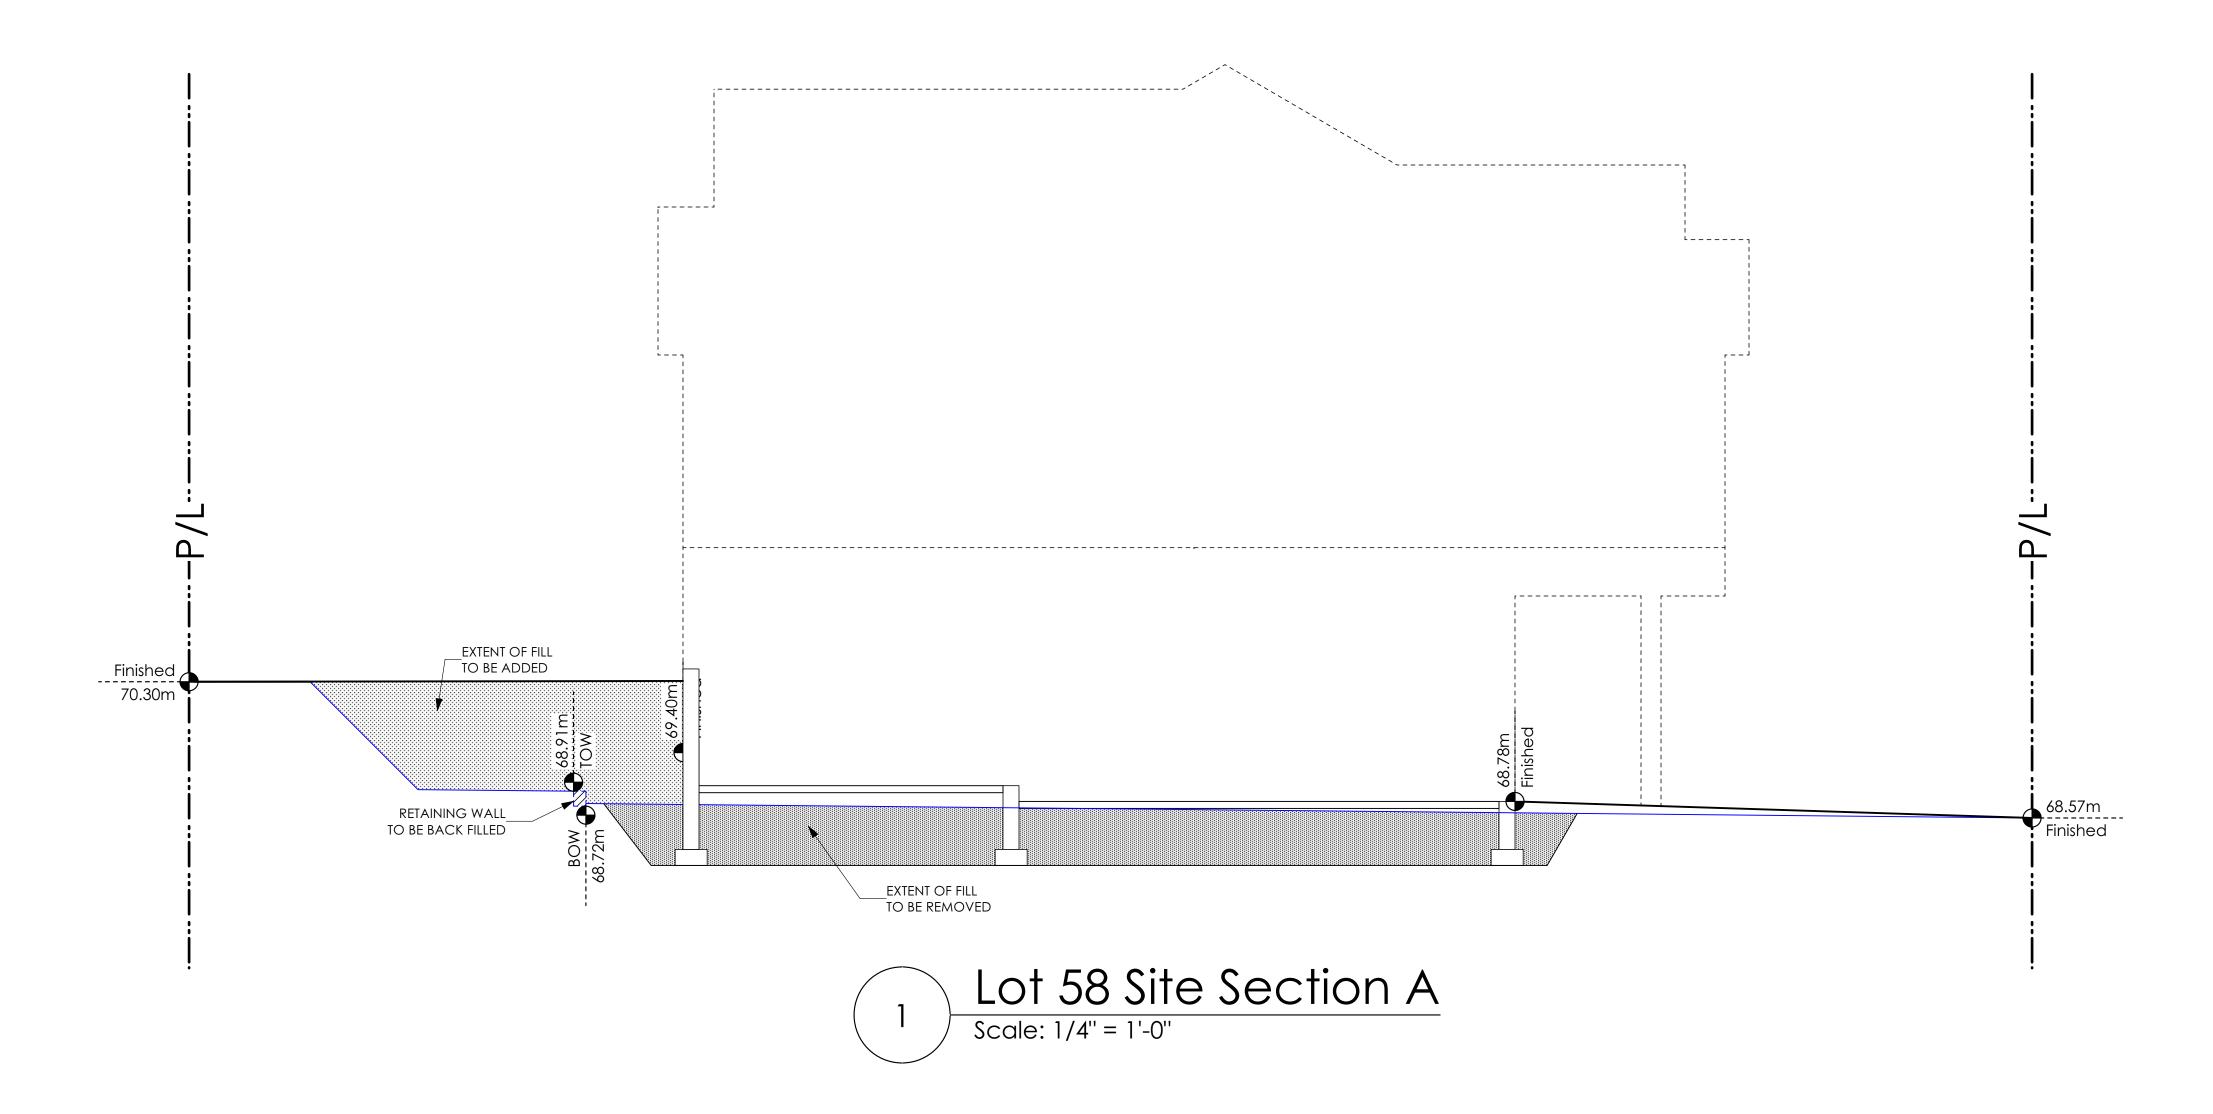Windjammer Westcoast

Date

JUne 29, 2023

# **Project Address**

3480 Trumpeter Street Royal Bay - Sector 7 Colwood, B.C.

# Prepared for

Verity Construction

Project #

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Scale


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**Lot 58**3480 Trumpeter Street

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# **Prepared for**

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Scale

As Noted


Drawn By

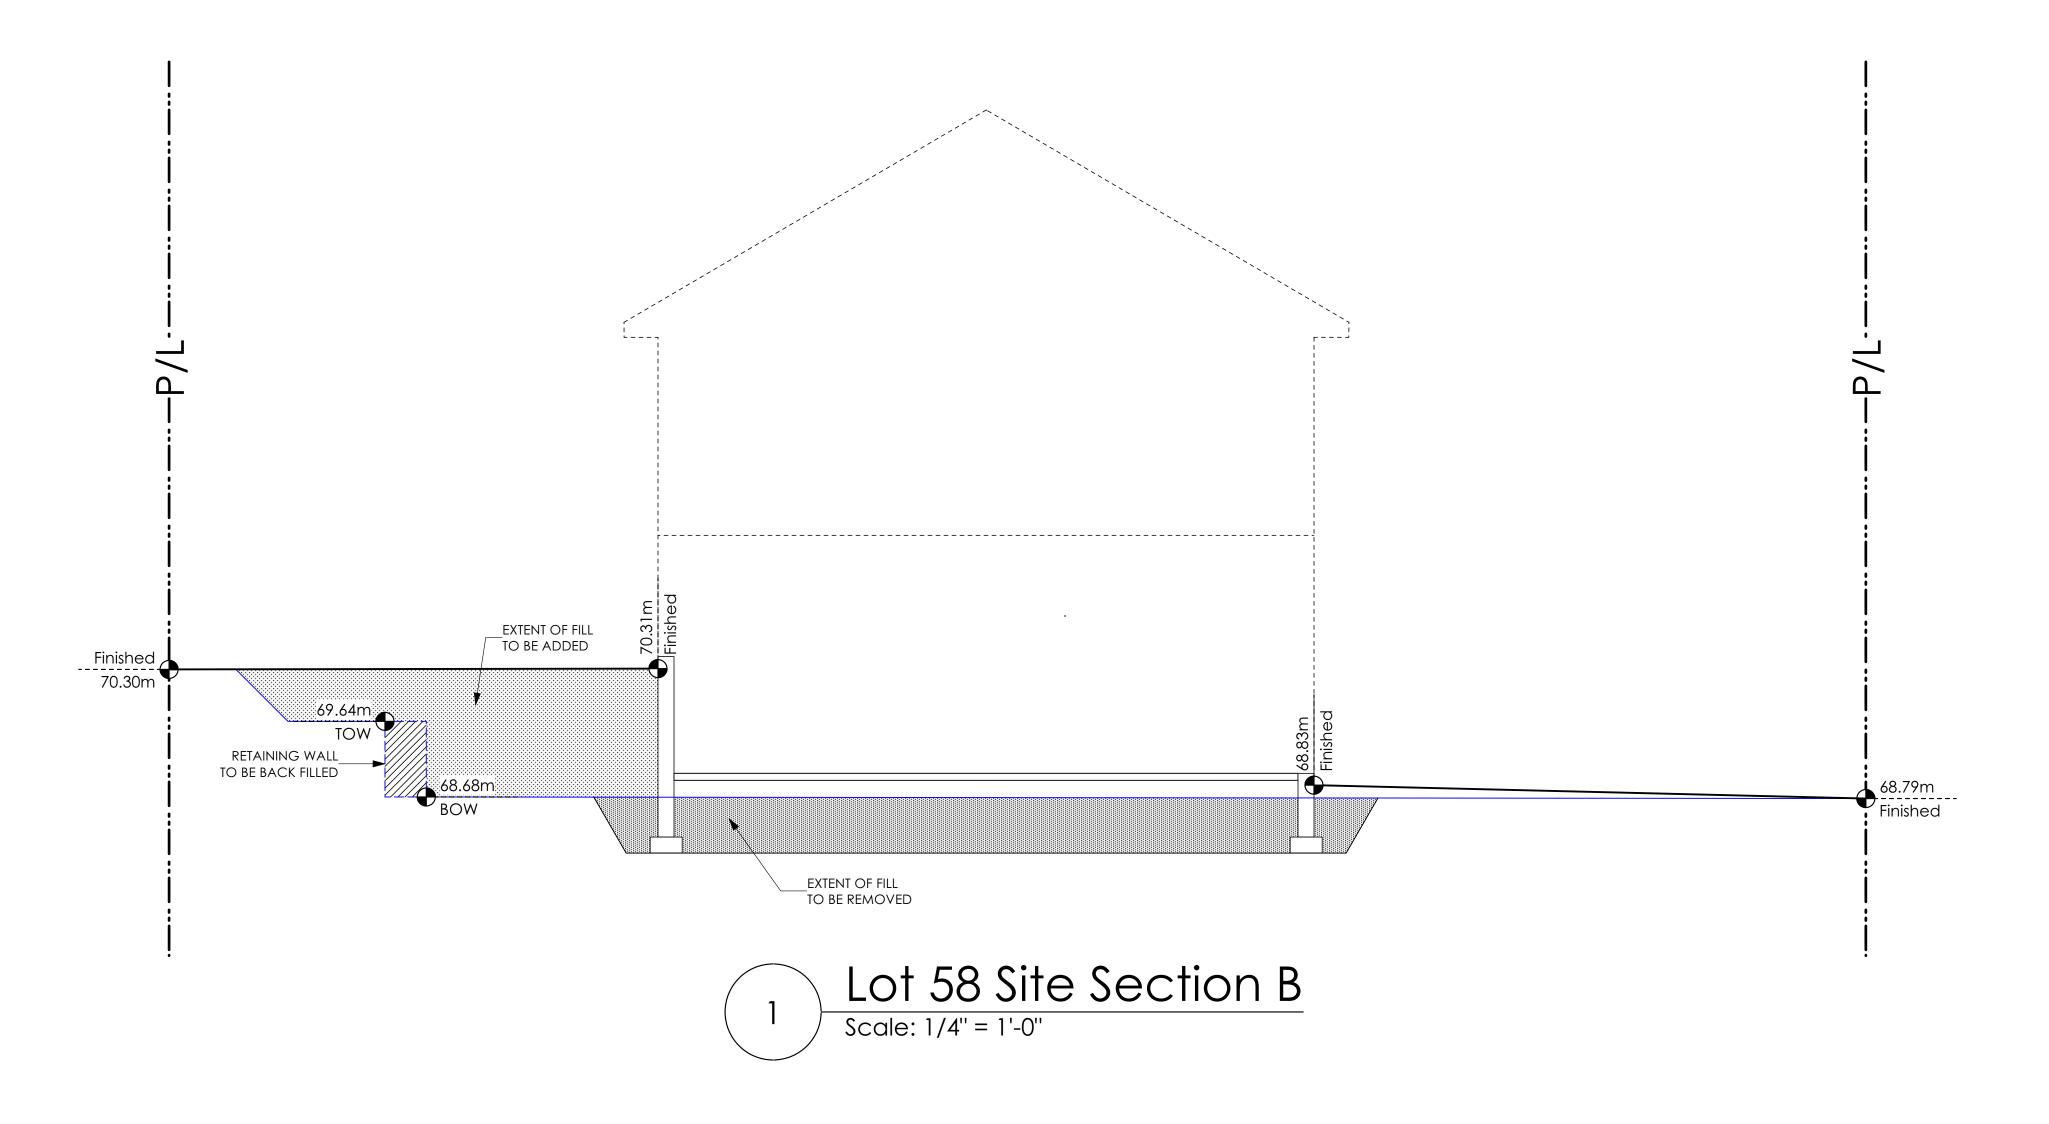WGM



"NOTE: In the interest of maintaining high standards, the developer reserves the right to modify plans, specifications and design without prior notice. Drawings contained within are artist renderings only. Sizes and dimensions are approximate and may vary with actual plan and survey. Exterior style may change pending municipal approval. Retaining wall location and types may vary and are subject to municipal, engineering or developer discretion. Subject to change without notice. Furniture as shown on plans are for layout purposes only and are not included in the sale.

|      | ITEM       | AREA (sf) | %    |
|------|------------|-----------|------|
| 643  | GARDEN BED | 241       | 9%   |
| 165A | GRAVEL     | 269       | 10%  |
| MA P | CONCRETE   | 867       | 33%  |
|      | SOD        | 1,240     | 48%  |
|      | TOTAL      | 2,617     | 100% |

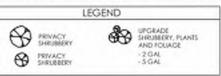




Typical Fence Detail Not To Scale THICK PROJUDIAL MAIL OF PERCENTIAL VICE

ADDITIONAL NOTES: PROPERTY TO BE IRRIGATED 6" PIPE FOR DRIVEWAY SLEEVES TO BE INSTALLED FOR CITY IRRIGATION

### KEY PLAN NOT TO SCALE

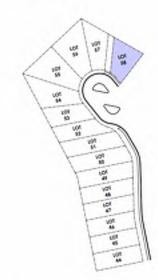



All hees and plants by the home-sweet to be

LINES

|    | MM/DD/YY | ISSUED/REVISED |
|----|----------|----------------|
| 01 | 01/24/23 | FOR APPROVAL   |
| 02 | 05/18/23 | FOR APPROVAL   |
|    |          |                |
|    |          |                |
|    |          |                |

ALL FENCING, RETAINING AND

PROJECT

DATE

LANDSCAPING PLAN LOT 58, 3480 TRUMPETER ST. **ROYAL BAY, SECTOR 7** CITY OF COLWOOD



CONSTRUCTION

QUALITY CONSTRUCTION. TRUSTED SERVICE.

106 - 1039 Langford Parkway Victoria, B.C. V9B 0A6


P: 250.474.1039 www.verityconstruction.ca

# GABLECTART HOMES BUILDING GRADE SLIP

| WSP | Project | No: | 201-08151-00 |
|-----|---------|-----|--------------|
|     | ,       |     |              |

Issue Date: \_

| MUNICIPAL  | P.I.D.  |
|--|---|
| ADDRESS 401 Rock Dove Place  | F-ILU.  |
| LOT 58   | PLAN  |
| BUILDER VERITY HOMES   | SUBDIVISION   |
| ADDRESS  | ROYAL BAY SECTOR 7  DEVELOPER   |
| REPRESENTATIVE PH.   | MEADOWS DEVELOPMENT LP CONSULTANT   |
|  | WSP CANADA INC  |
| PROPOSED BUILDING GRADES   | PLAN  |
| ALL ELEVATIONS ARE METRIC GEODETIC +   | LOT: PLAN:  |
| MAIN FLOOR ELEVATION 72.00 JOIST   |   |
| FRONT ELEV_ 68.83 REAR ELEV_ 69.57/68.94 DEPTH (FINISHED GRADE)  |   |
| FINISHED GRADE AT GARAGE 68.78   | RETAINING WALL  |
| NO NO  | 70.37   |
| HEADROOM   | 70.3  |
|  |   |
| ACTUAL TOP OF FOOTING <u>not provided</u> ELEVATION (ATF)  |   |
| LOWEST PERMITTED TOP OF not provided FLOOR SLAE FOOTING ELEVATION (LTF)  | 58  |
| (BOTTOM OF BASEMENT SLAB FROST WALLS ARE REQUIRED.)  | 58 88 88 86 9.19 FGFE 68.99 68 88 88 88 88 88 88 88 88 88 88 88 88  |
| 050,4050 500,500 500,500 500,500 500,500   | MSE   65.65<br>  MSE   65.65<br>  S   65.30<br>  D   66.22  |
| SERVICES FRONT REAR CENTER REFER SIZE<br>TO PLAN (mm)  | BF BF   |
| WATER 19   | 889   |
| SANITARY 100   |   |
| STORM [  | TRUMPETER ST.   |
| COMMENTS YES NO  |   |
| DRAIN TO SUMP PUMP LIKELY REQUIRED (FOR BASEMENT IF INSTALLED)   | LEGEND  |
| SEWER TO SUMP PUMP LIKELY REQUIRED  (FOR BASEMENT IF INSTALLED)  | STREET  |
| SERVICES INSTALLED TO m INSIDE PROPERTY  | WAT.  |
| FOUNDATION SOIL BEARING INVESTIGATION  |   |
| CERTIFICATION REQUIRED   | SROW (SHOWN ON ABOVE PLAN)  PROPOSED FRONT CORNER ELEVATIONS  PROPOSED FRONT SIDE YARD GRADES   |
| GEOTECHNICAL RESTRICTIONS APPLY (SEE GEOTECHNICAL REPORT)  | PROPOSED FRONT SIDE YARD GRADES   |
| ENVIRONMENTAL RESTRICTIONS APPLY   |   |
| (SEE ENVIRONMENTAL REPORT)   | EG 49.90  EG 49.90  EG 49.90  EG 49.90  EG 49.90  EG 49.90  |
| UTILITY EASEMENTS AFFECT THIS LOT  | LFE/MFE 47.70 — LOWER/MAIN FLOOR ELEVATION  GFE 47.55 — GARAGE FLOOR ELEVATION  |
|  | MSE 52.20 — MINIMUM SANITARY SERVICABLE   |
|  | ELEVATION BY GRAVITY  S 49.12 (P)  D 49.12 (P)  - SAN SERVICE INV.  (P) DENOTES PLIME IS LIKELY REQUIRED.   |
|  | FOR BASEMENT IF INSTALLED   |
|  | STORM SERVICE INV. (P) DENOTES PUMP IS LIKELY REQUIRED FOR BASEMENT IF INSTALLED  |
|  | - PROPOSED REAR SIDE YARD GRADES  |
| WOTER  | _ LOT TYPE (L/LB/LBT)   |
| NOTES  | - PROPOSED REAR CORNER ELEVATIONS   |
| <ol> <li>IT IS THE RESPONSIBILITY OF THE BUILDER TO ENSURE THE FOOTINGS<br/>ARE PLACED ON A PROPER BASE THAT IS FREE FROM FROST,<br/>EXCESSIVE MOISTURE AND DELETERIOUS MATERIALS AND HAVE<br/>APPROPRIATE FROST PROTECTION WHEN COMPLETED.</li> </ol> |   |
| 2. THE INFORMATION CONTAINED HEREIN IS BASED ON THE APPROVED LOT GRADING PLAN FOR THIS SUBDIVISION. UN—AUTHORIZED DEVIATIONS WILL BE THE RESPONSIBILITY OF THE BUILDER TO  | I, THE BUILDER'S REPRESENTATIVE.  |
| ENSURE COMPLIANCE WITH ALL LOCAL BYLAWS.  3. OTHER NOTES:  | I, THE BUILDER'S REPRESENTATIVE,  CERTIFY THAT THE FINAL HOUSE PLANS PROVIDED IN THE BUILDING PERMIT  APPLICATION ARE THE SAME AS PROCESSED UNDER THIS GRADE SLIP AND  THAT I UNDERSTAND THE INFORMATION AND THE REQUIREMENTS CONTAINED |
| J. GIREK NOTES:  | HEREIN AND WILL BUILD ACCORDINGLY.  |
|  | ALITHODIZED DIMINED'S DEDDESCRITATIVE   |
|  | AUTHORIZED BUILDER'S REPRESENTATIVE DATE  THE INFORMATION CONTAINED HEREIN IS BASED ON THE APPROVED   |
|  | LOT GRADING PLAN FOR THIS SUBDIVISION, DATED  |

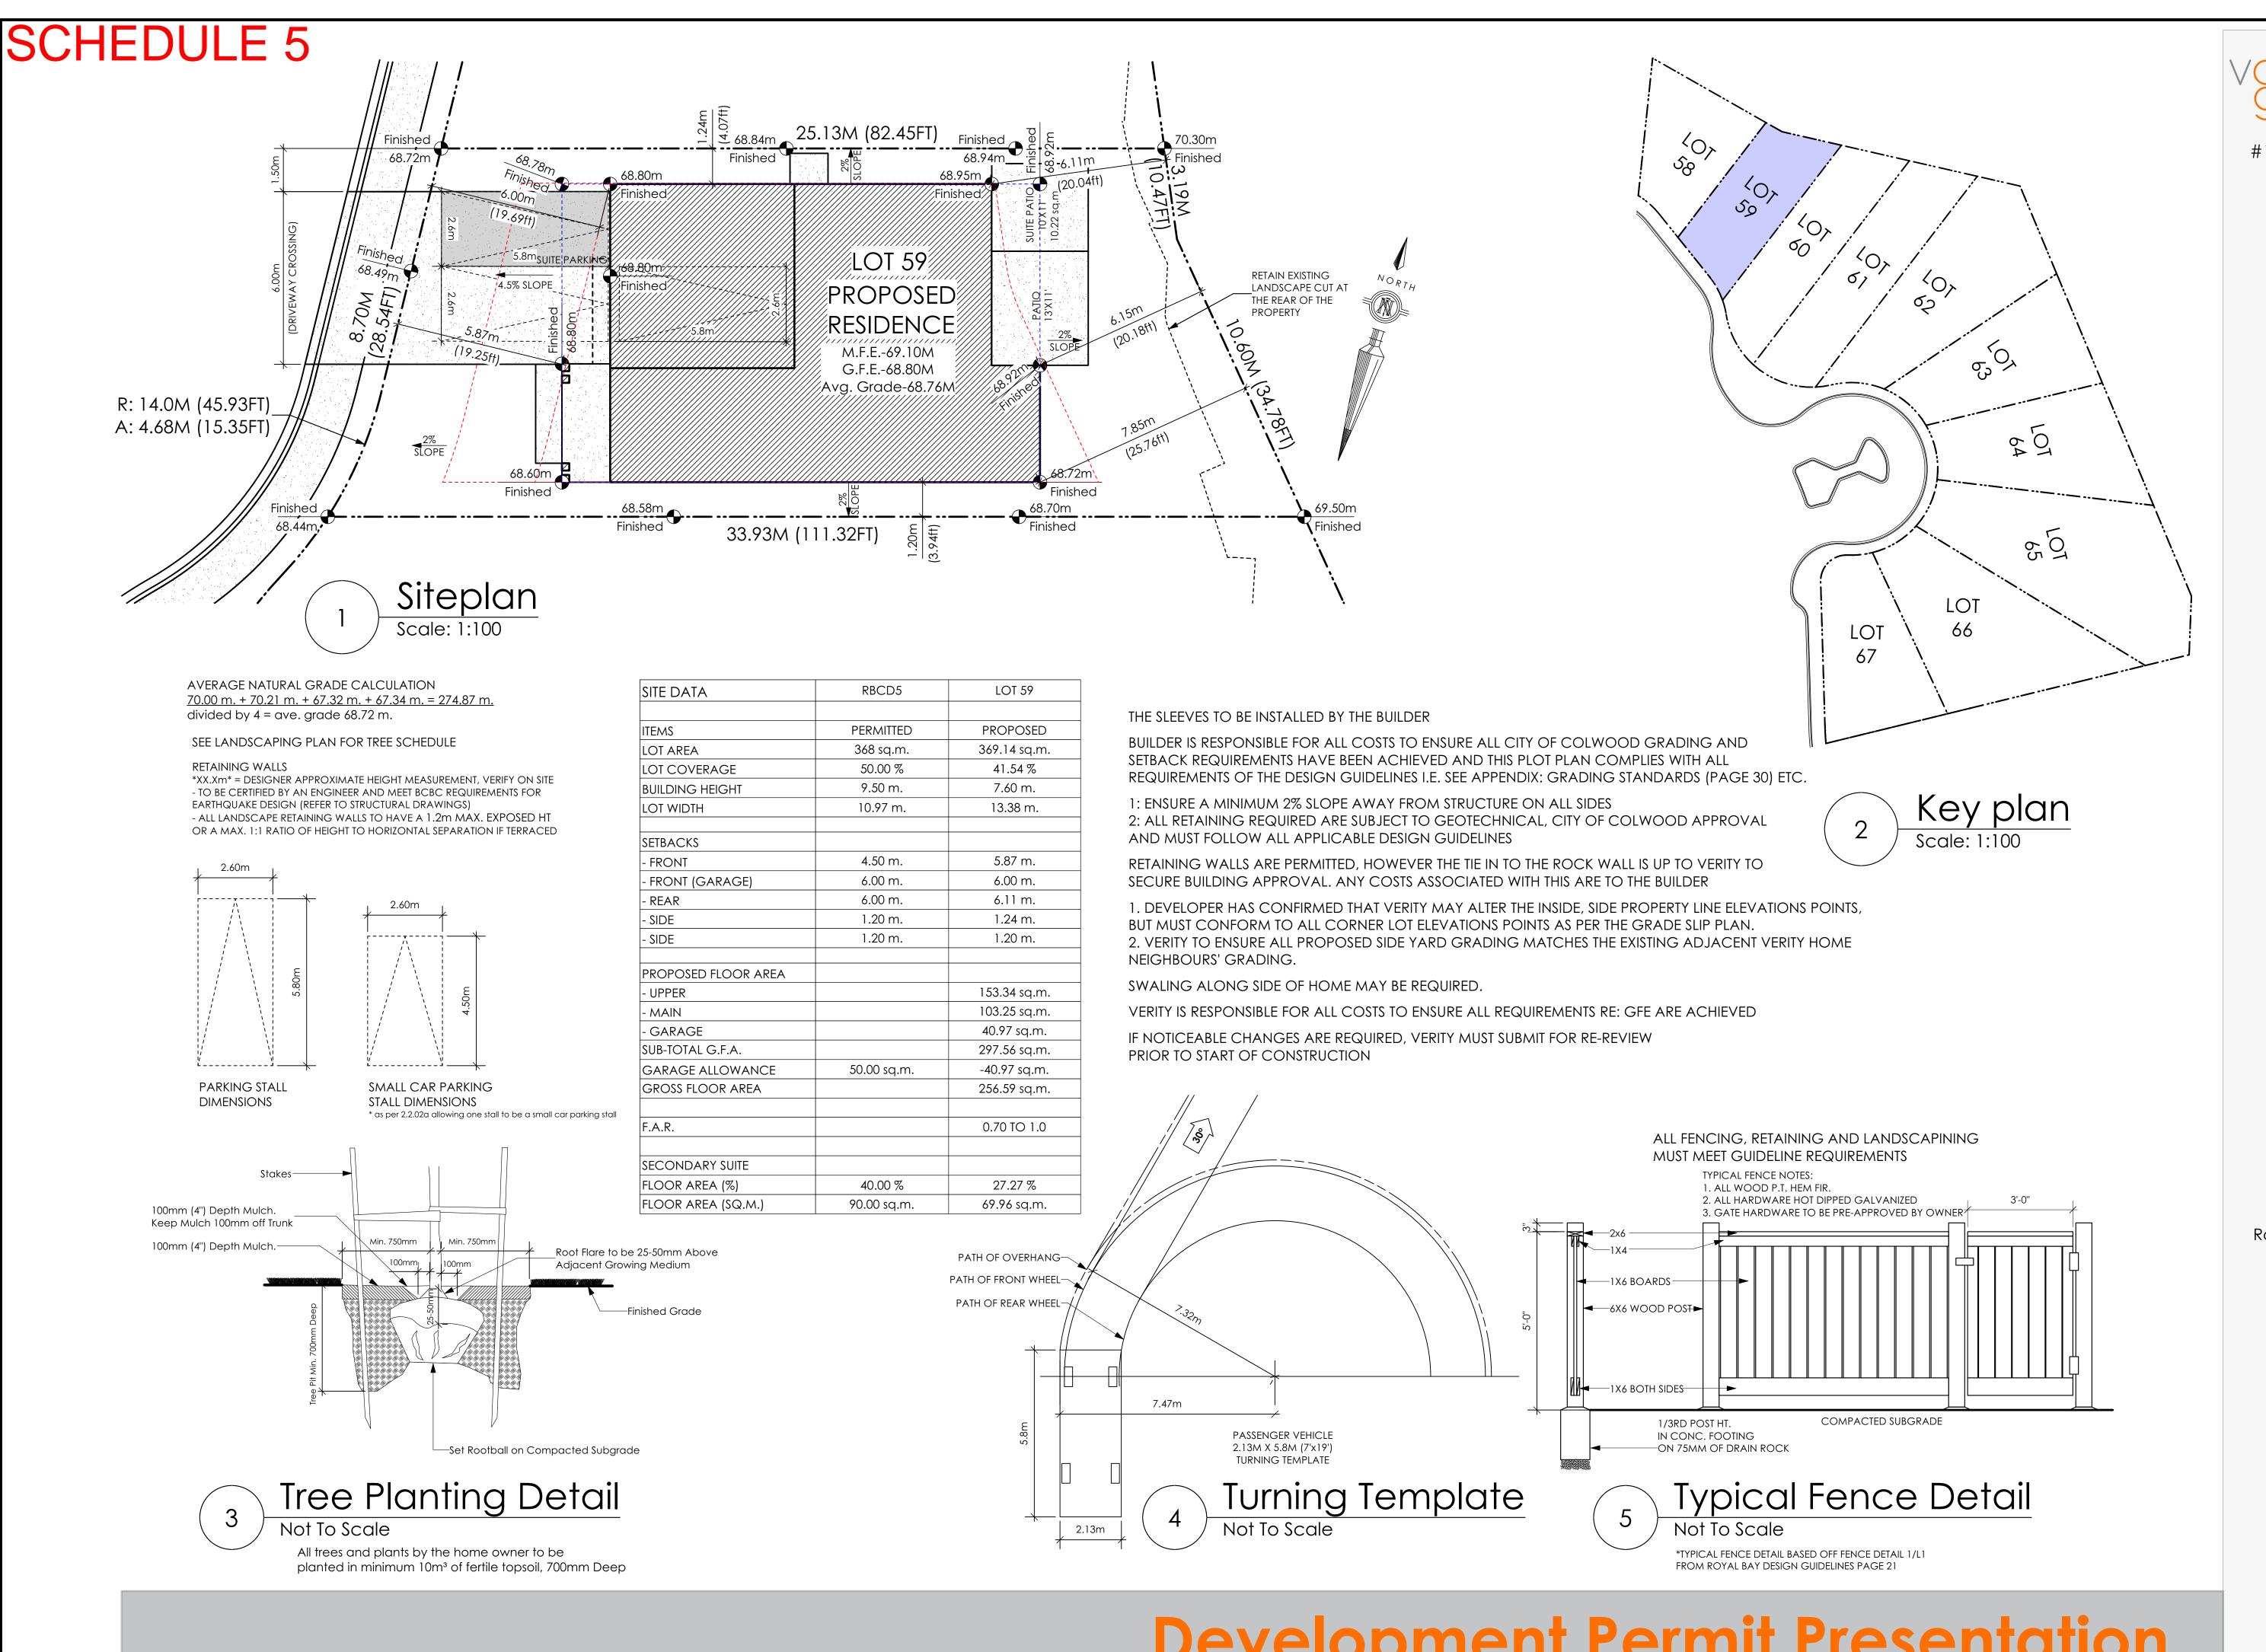

### #103 - 891ATTREE AVENUE VICTORIA, B.C. V9B 0A6 P. 250.382.7374 F. 250.382.7364

Galley Westcoast

Date

Mar. 31, 2023

## **Project Address**

3478 Trumpeter Street Royal Bay - Sector 7 Stage 2 Colwood, B.C. Prepared for

Verity Construction


Project #


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Scale

As Noted

Drawn By MRB



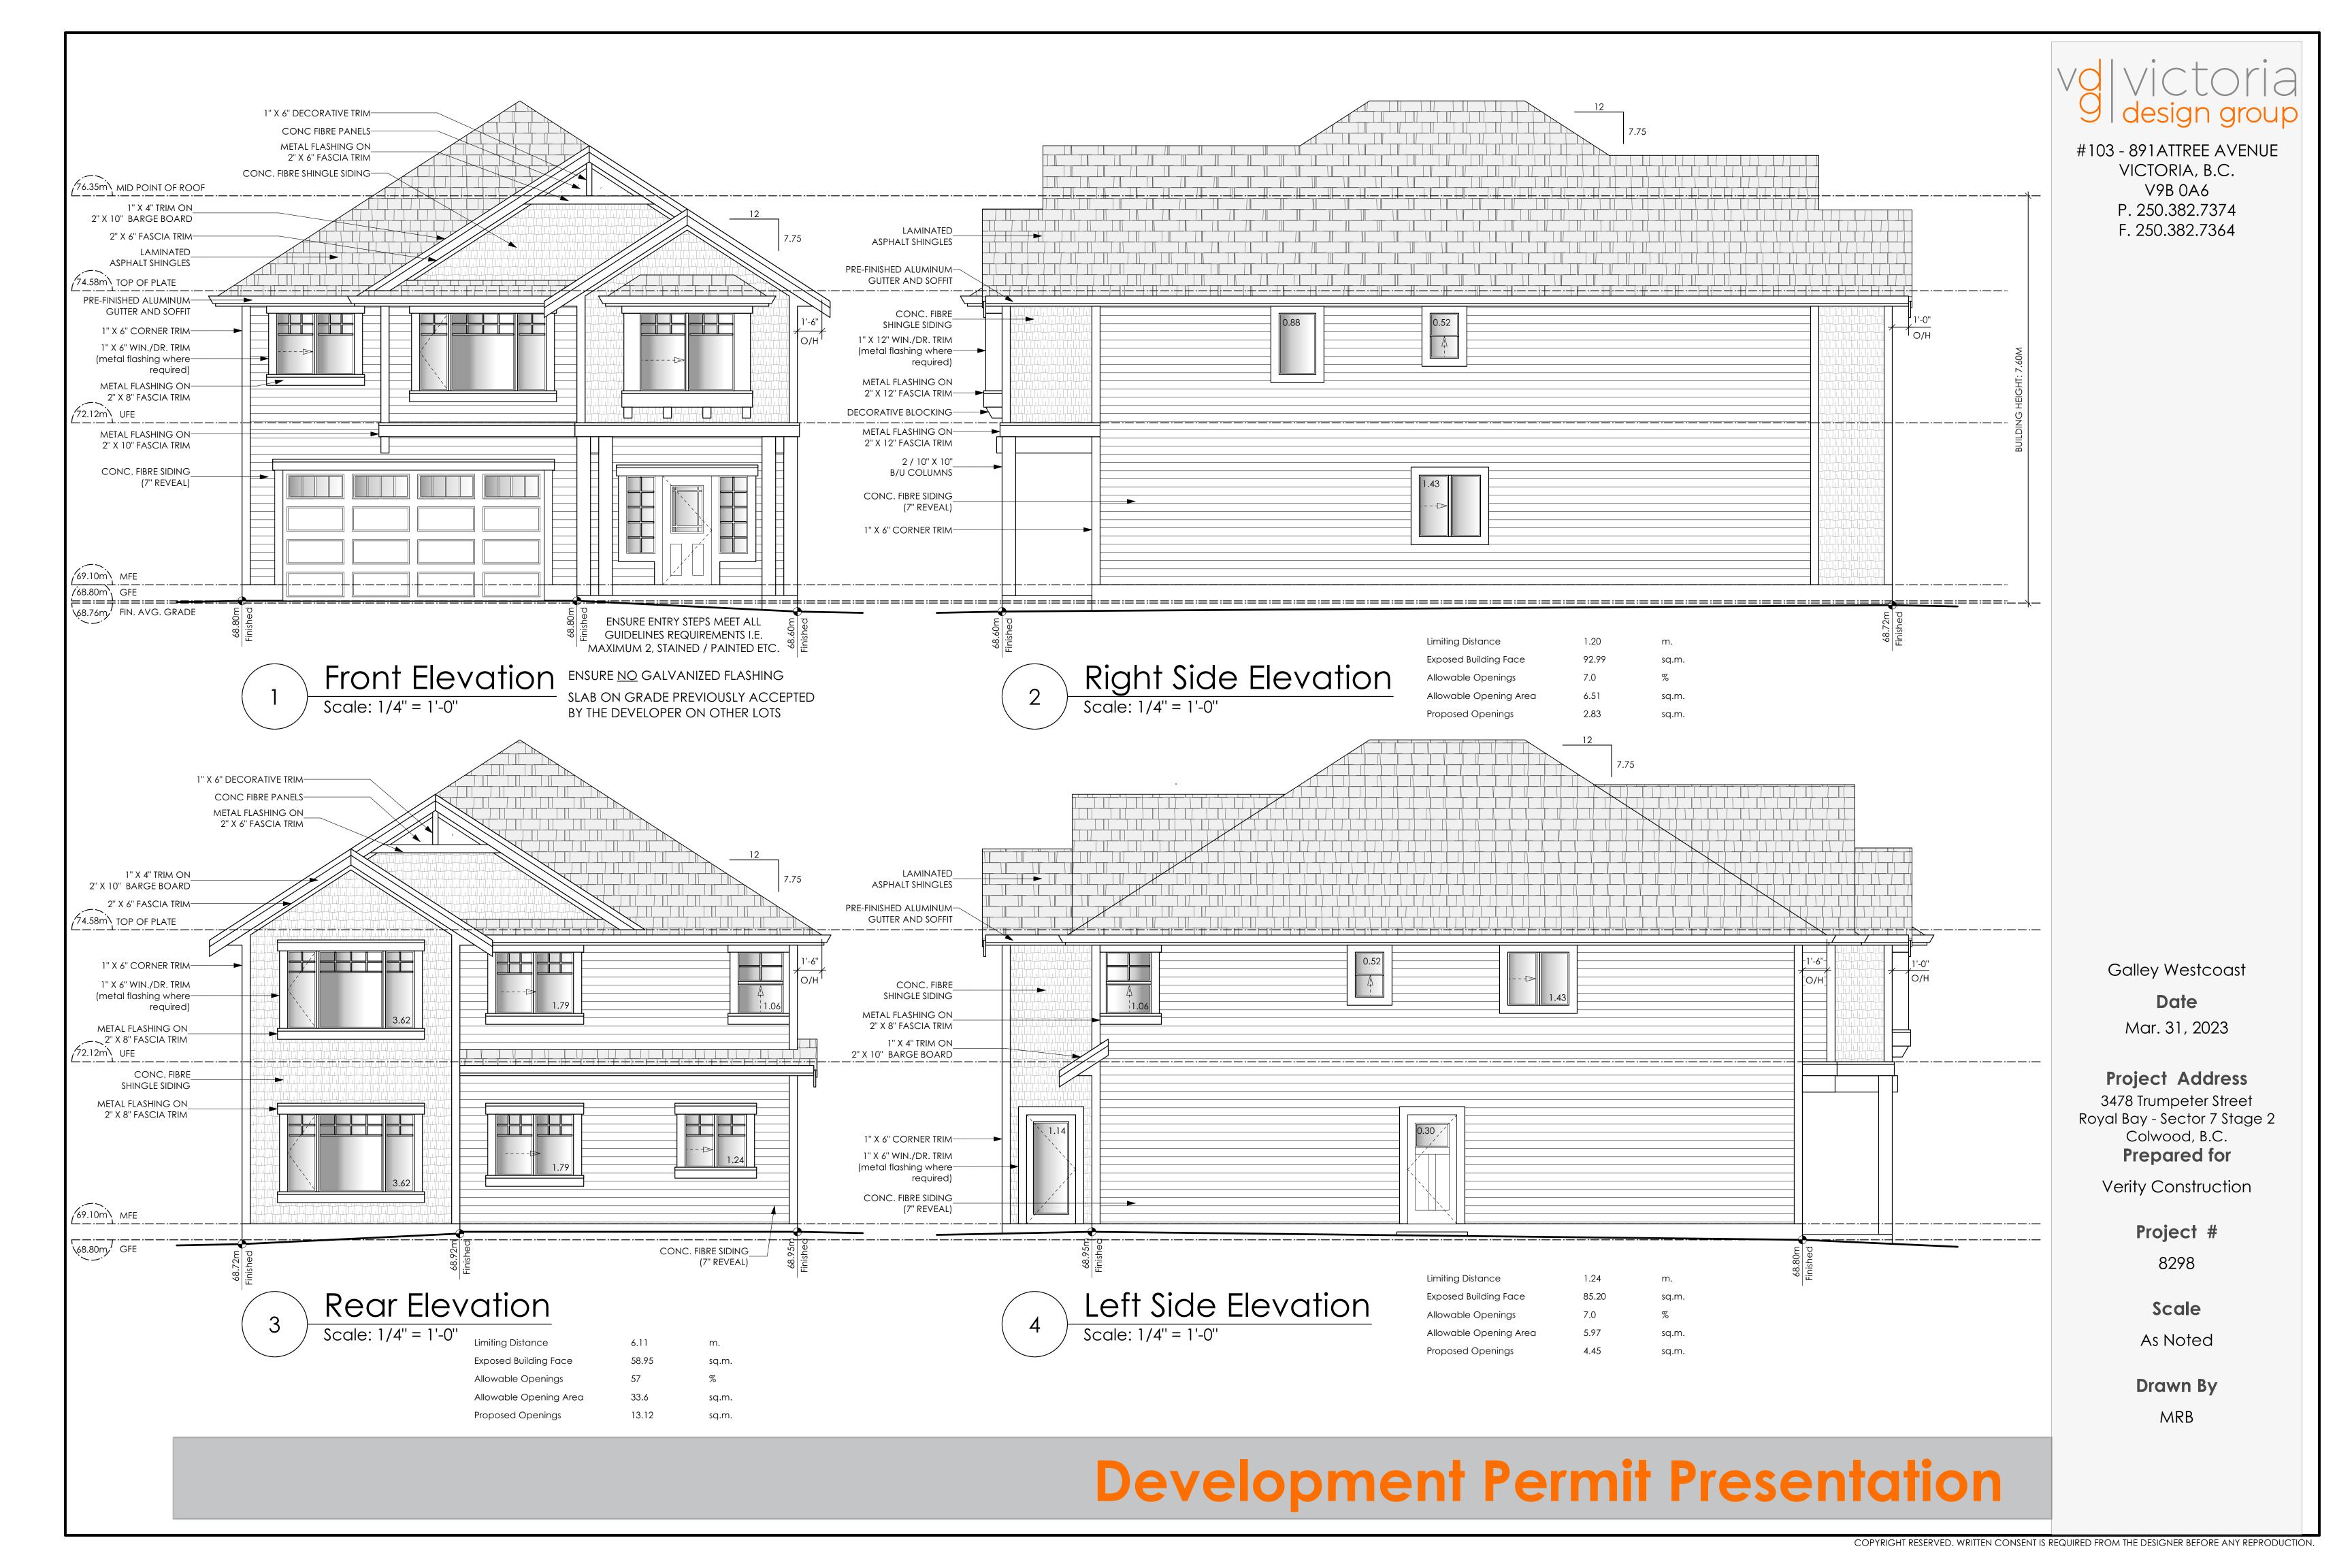
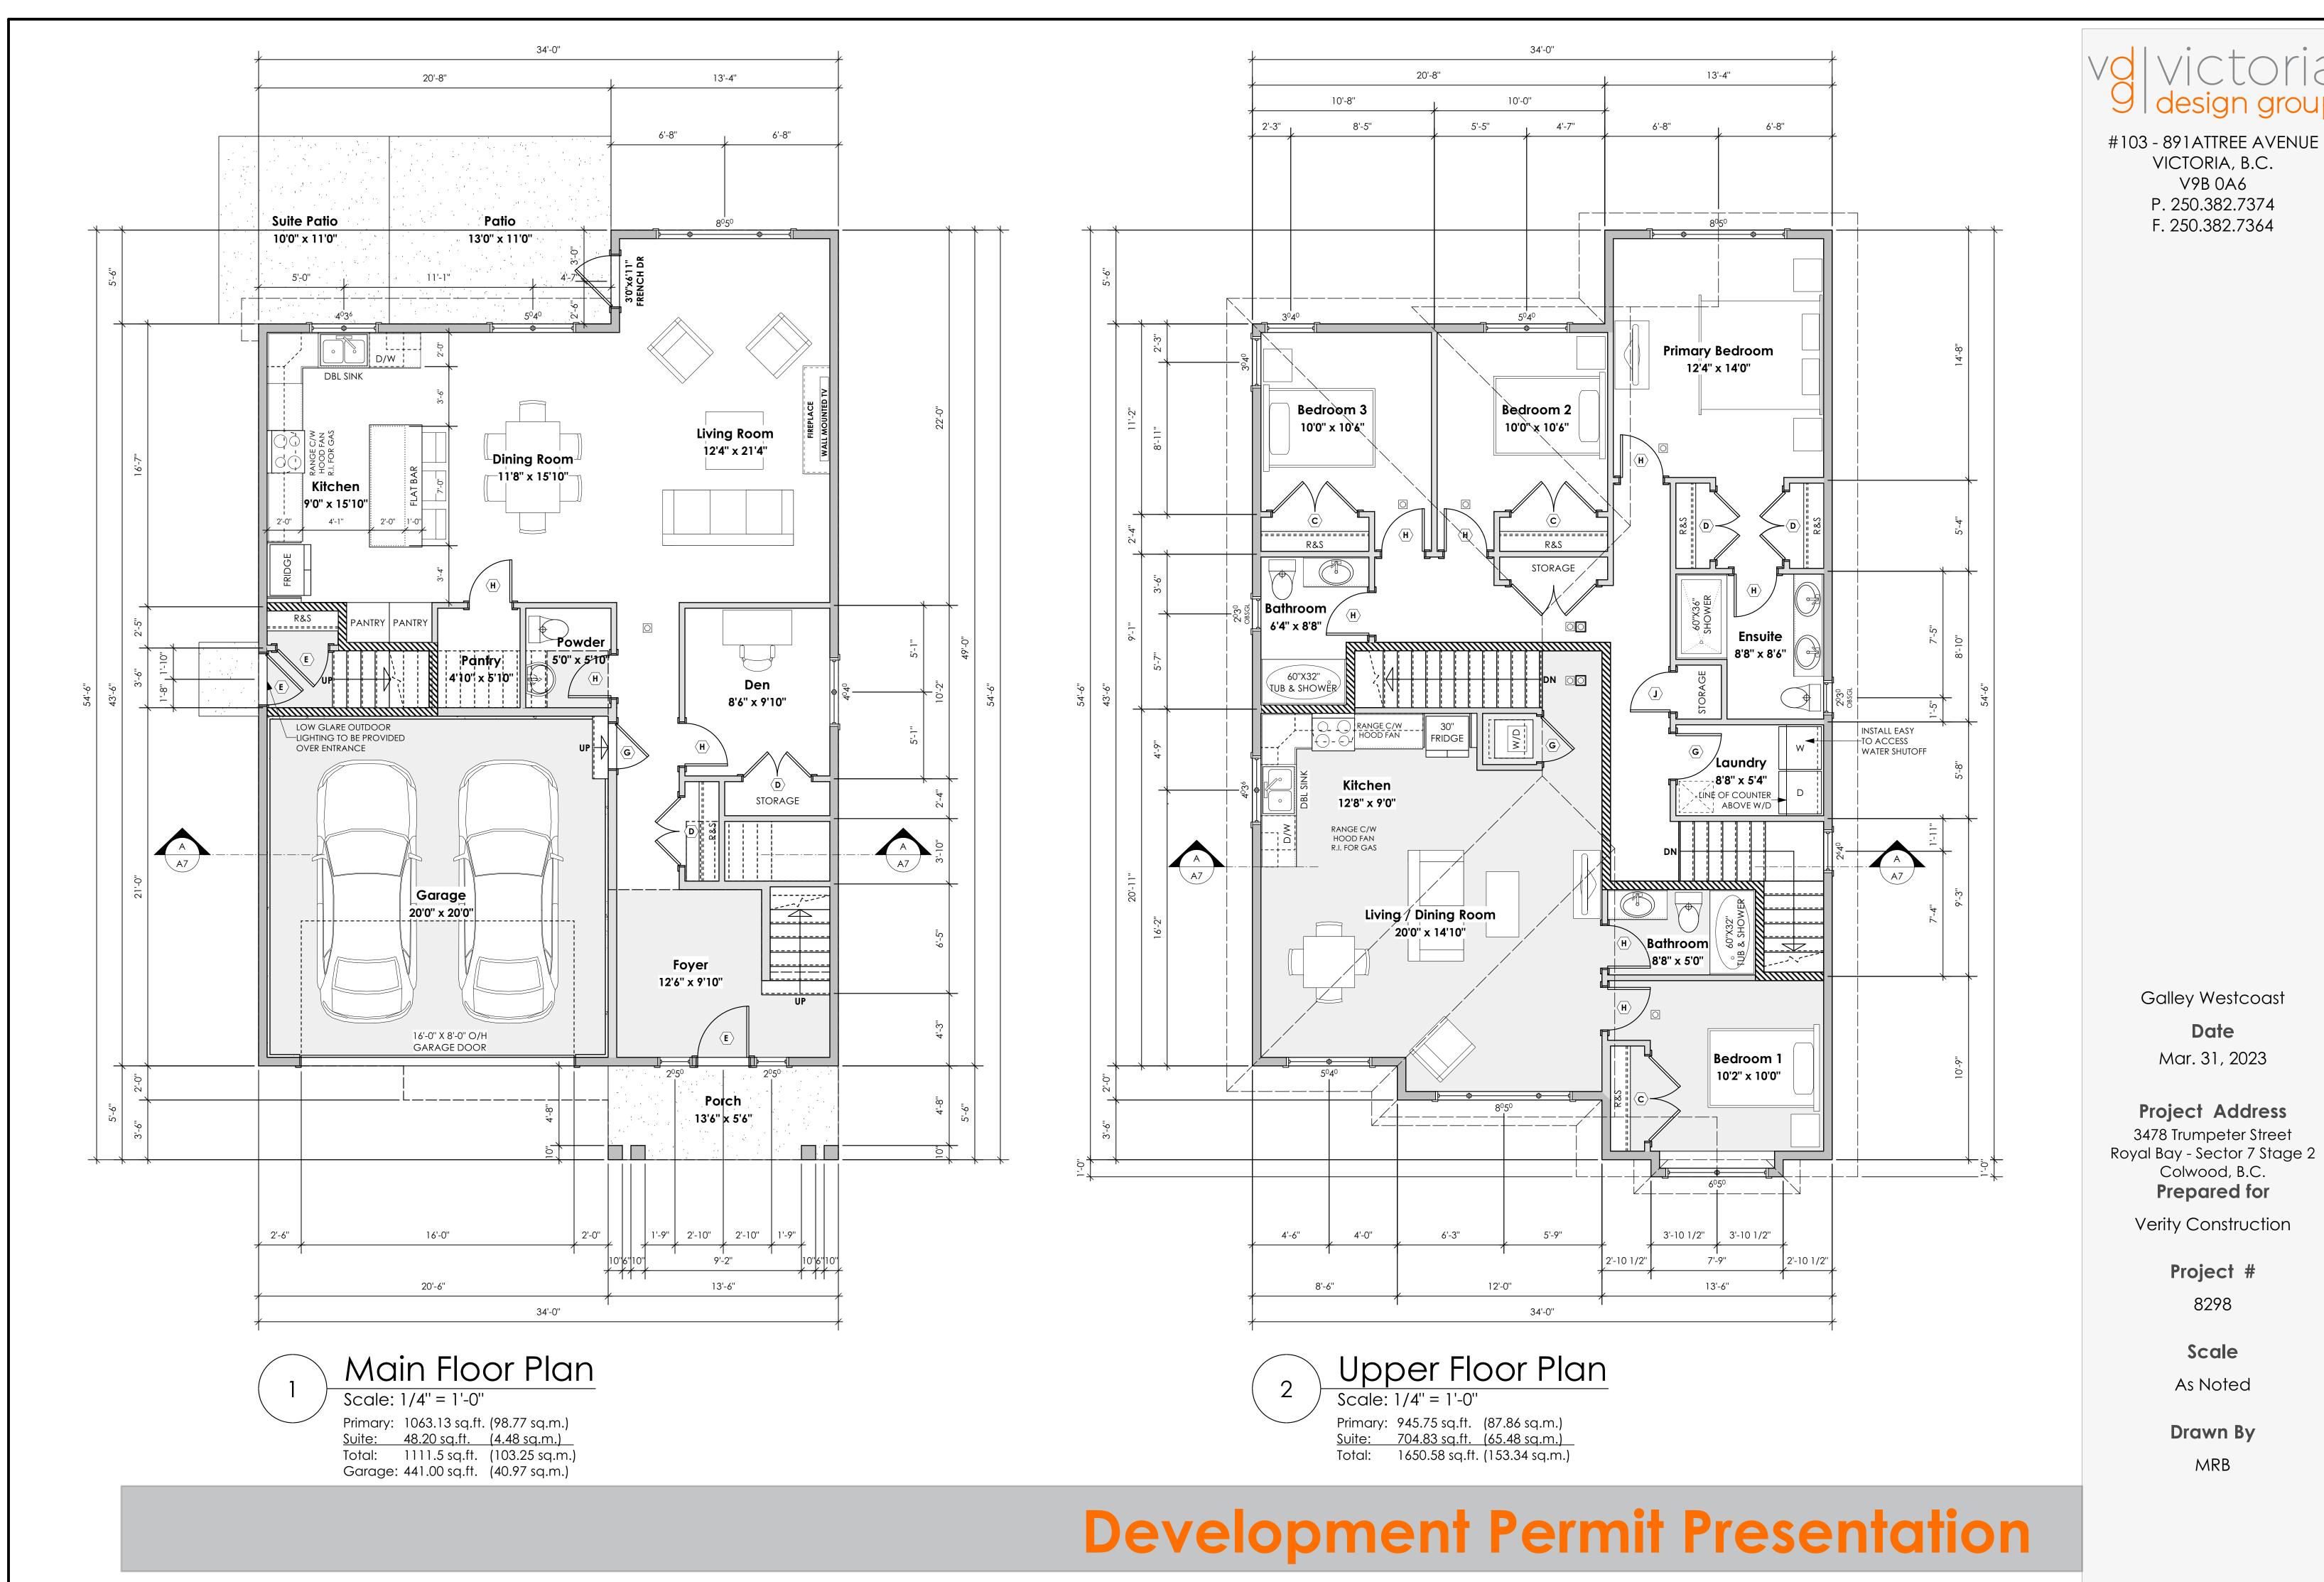
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VICTORIA, B.C.

V9B 0A6

P. 250.382.7374

F. 250.382.7364

Date

Mar. 31, 2023

Colwood, B.C.

Prepared for

Project #


8298

Scale

As Noted

Drawn By

MRB

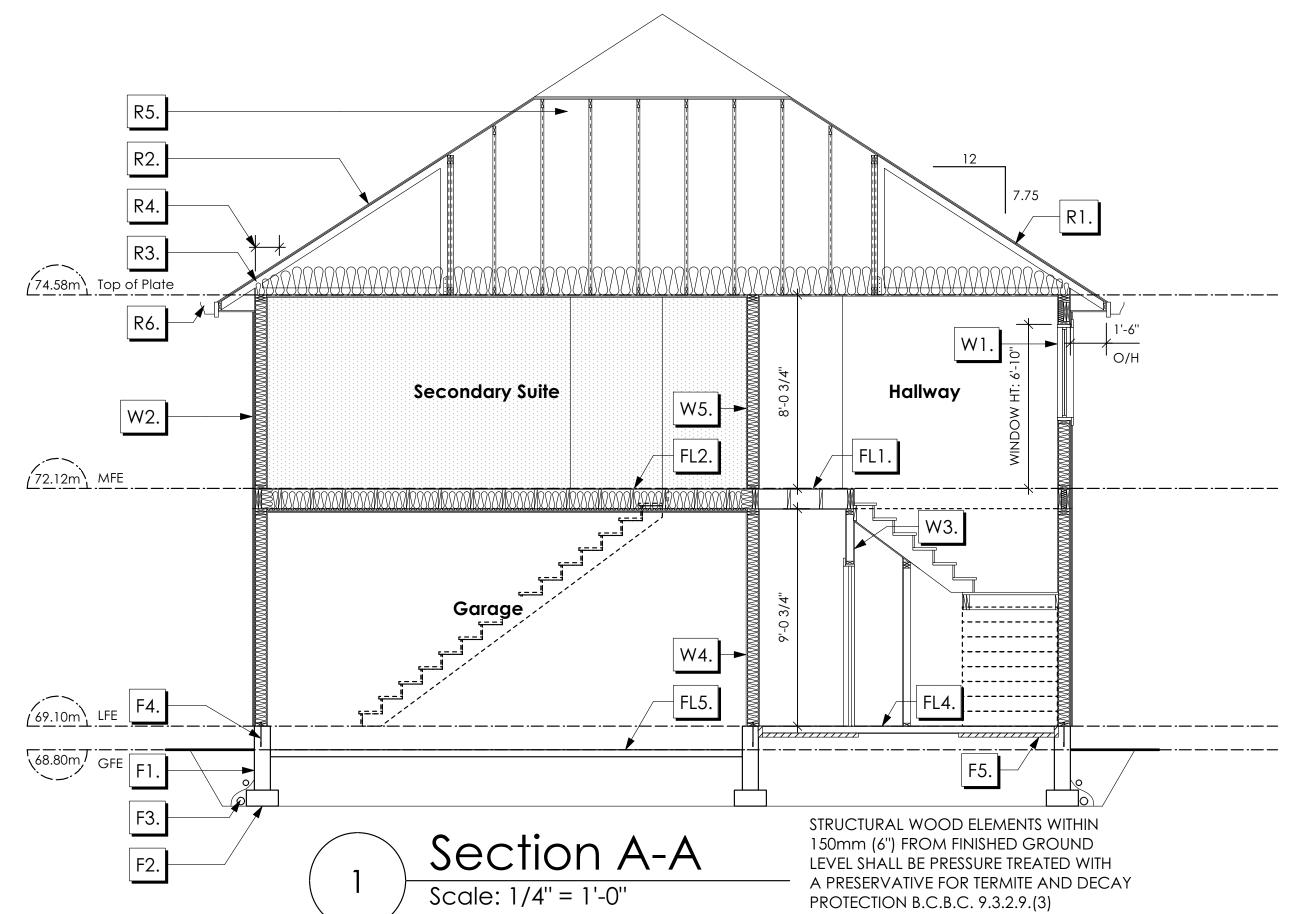

## FLOORS

R1. LAMINATED ASPHALT SHINGLES ON
7/16" ORIENTED STRAND BOARD
WD TRUSSES (DESIGNED BY MANUF.)
R-40 FIBRE GLASS BATT INSULATION OR
14 1/2" FIBRE GLASS LOOSE FILL INSULATION
(ALLOW FOR SETTLING)
6 MIL POLY'N V.B.
5/8" GYPSUM BOARD

**ROOFS** 

R2. B.C. BUILDING CODE (TABLE-9.10.3.1.B)
RATED FLOOR ASSEMBLY R1
LAMINATED ASPHALT SHINGLES ON
7/16" ORIENTED STRAND BOARD
WD TRUSSES (DESIGNED BY MANUF.)
R-40 FIBRE GLASS BATT INSULATION OR
14 1/2" FIBRE GLASS LOOSE FILL INSULATION
(ALLOW FOR SETTLING)
6 MIL POLY'N V.B.
X TYPE 5/8" GYPSUM BOARD

R3. PROVIDE 2 1/2" (63MM) CLEAR BETWEEN R-20 INSULATION AND SHEATHING.
(MIN. R-20 @ ROOF-WALL CONNECTION FOR 4'-0" (1.2M) AROUND PERIMETER OF BUILDING. AIR VENTILATION BAFFLES TO BE INSTALLED WHERE REQUIRED IN AS PER BCBC 9.19.)

R4. EAVE PROTECTION
CONT. UP ROOF SLOPE FOR 12"
PAST EXTERIOR WALL.

45 MINUTE F.R.R.

R5. PROVIDE 1 SQ.FT. ATTIC VENT PER
300 SQ.FT. OF INSULATED AREA MIN.
25% OF REQUIRED TO BE @ TOP AND BOTTOM
(TO COMPLY WI. B.C. BLDG. CODE 9.19.1)

R6. PRE-FIN. FASCIA GUTTER
2×8 FASCIA BD.
2×4 SUB. FASCIA BD.
1/2" PLYWOOD
VENTED SOFFIT
(SEE CONTRACTOR)

# FL1. FINISHED FLOORING ON 19/32" ORIENTED STRAND BOARD (NAILED & GLUED TO FLOOR STRUCT. BELOW) ON 2×10 FLOOR JOISTS @ 16" OR 12" O/C C/W 2×2 X-BRIDGING @ 7.0' O/C (MAX)

1/2" GYPSUM BOARD

30 MINUTE F.R.R., 50 S.T.C.

FL2. B.C. BUILDING CODE (TABLE-9.10.3.1.B)
RATED FLOOR ASSEMBLY F8D
FINISHED FLOORING ON
19/32" ORIENTED STRAND BOARD
(FASTENED & GLUED TO FLOOR STRUCT. BELOW) ON
2×10 FLOOR JOISTS @ 16" OR 12" O/C
C/W 2×2 X-BRIDGING @ 7.0' O/C (MAX)
R-31 INSULATION
6 MIL POLY'N V.B. (when located above garage)
RESILIENT METAL CHANNELS @ 24" O/C
1 LAYERS 5/8" X-TYPE GYPSUM BOARD

FL3. FINISHED FLOORING ON

19/32" ORIENTED STRAND BOARD
(NAILED & GLUED TO FLOOR STRUCT. BELOW) ON

2×10 FLOOR JOISTS @ 16" OR 12" O/C

C/W 2×2 X-BRIDGING @ 7.0' O/C (MAX)

PROVIDE R-31 F/G BATT INSULATION IN

JOIST CAVITY

BUILDING WRAP

VENTED SOFFIT (TO OWNERS SPEC'S)

TO ALL SUSPENDED FLOOR AREAS
(NOT SHOWN IN SECTION)

FL4. FINISHED FLOORING ON
3 1/2" CONCRETE SLAB
6 MIL. POLY'N V.B.
6" COMPACTED GRAVEL OR SAND

FL5. 3 1/2" CONCRETE SLAB
6 MIL. POLY'N V.B.
6" COMPACTED GRAVEL OR SAND
SLOPE TO DOORS 1"

### **FOUNDATION WALLS**

F1. DAMP PROOFING (WHERE REQUIRED) ON 8" THK. CONC. FOUNDATION WALL C/W 15 M BARS @ 24" O/C B/W

F2. 16"X 8" CONC. FOOTINGS

C/W 2 (TWO) 15M BARS CONT. 3 IN. FROM BOTT.

ON UNDISTURBED SOIL (SOLID BEARING)

F3. 4" PERIMETER DRAIN
3" TIGHT PIPE FOR RWL
DRAIN ROCK

4. ANCHOR BOLTS @ 4.0 FT. O/C MAX C/W SILL GASKETS

UNDER SLAB INSULATION
2 1/2" (RSI 2.15) EXTRUDED POLYSTYRENE
RIGID INSULATION 4'-0" (1.2M)
CONT. AROUND PERIMETER UNDER
SLAB INSTALLED HORIZONTALLY
(VERIFY WITH MUNICIPALITY DEPTH OF FROST LINE)

## WALLS

W1. DOUBLE GLAZING
ENERGY STAR LOW "E" RATING IN
THERMAL BREAK FRAMES
2/2"X10" LINTEL OVER (@ BEARING WALLS ONLY)
(TYPICAL, WI. 2 1/2" XPS INSULATION)
FLASHING OVER @ EXTERIOR
(GLAZING IN ALL EXTERIOR DOORS & WITHIN 3 FT.
OF EXTERIOR DOORS TO BE SHATTERPROOF (SP))
WINDOW REQUIREMENTS DERIVED FROM BCBC
TABLE C-5 AS PER BCBC 9.7.4.3. AND ARE TO BE
USED TO SATISFY THE REQUIREMENTS OF
AAMA/WDMA/CSA 101/I.S.2/A440, "NAFS":
COLWOOD, CLASS R, DP 1440, PG 30, WATER RESIST. 220, A2,
RATINGS MUST BE CLEARLY LABELED ON ALL
WINDOW UNITS UPON INSTALLATION FOR INSPECTION.

W2. CONC. FIBRE BOARD ON
9.5MM (3/8") AIR SPACE / STRAPPING
3/8"×2" BORATE TREATED PLYWOOD STRAPPING
BUILDING WRAP on
7/16" ORIENTED STRAND BOARD SHEATHING
2×6 STUDS @ 16" O/C
R-20 INSULATION
6 MIL. POLYETHYLENE VAPOUR BARRIER
1/2" GYPSUM BOARD

W3. INTERIOR PARTITION
1/2" GYPSUM BOARD ON EACH SIDE
OF 2×4 STUDS @ 16" O/C OR
2×6 STUDS @ 16" O/C (IF NOTED)

W4. 5/8" X-TYPE GYPSUM BOARD ON 2×6 STUDS @ 16" O/C C/W R-20 INSULATION 6 MIL. POLY'N V.B 1/2" GYPSUM BOARD (BETWEEN GARAGE & LIVING)

(REFER TO DETAILS ON D1)

W5. B.C. BUILDING CODE (TABLE 9.10.3.1.A)
RATED WALL ASSEMBLY W3C
1 LAYER 1/2" X-TYPE GYPSUM BOARD ON
EACH SIDE OF 2×4 STUDS @ 16" O/C OR
2×6 STUDS @ 16" O/C (IF NOTED)
RESILIENT METAL CHANNELS ON ONE SIDE
@ 400mm OR 600mm O.C. C/W
3 1/2" FIBRE GLASS SOUND BATTS
FRICTION FITTED AND SOLID FILLED
45 MIN. F.R.R., 43 S.T.C.
(BETWEEN PRIMARY LIVING & SECONDARY SUITE)

## VO VICTORIA 9 design group

#103 - 891 ATTREE AVENUE VICTORIA, B.C. V9B 0A6 P. 250.382.7374 F. 250.382.7364

Galley Westcoast

Date

Mar. 31, 2023

Project Address
3478 Trumpeter Street
Royal Bay - Sector 7 Stage 2
Colwood, B.C.
Prepared for

Verity Construction

Project #

8298

Scale

As Noted


Drawn By

MRB

#### ALL FENCING, RETAINING AND LANDSCAPING MUST MEET THE GUIDELINE REQUIREMENTS

ALL RETAINING WALLS ARE TO BE STAND ALONE STRUCTURES (THEY MUST TERMINATE AT PROPERTY LINE) AND MUST NOT CONNECT TO RETAINING WALLS LOCATED ON ADJACENT PRIVATE PROPERTIES "NOTE: In the interest of maintaining high standards, the developer reserves the right to modify plans, specifications and design without prior notice. Drawings contained within are artist renderings only. Sizes and dimensions are approximate and may vary with actual plan and survey. Exterior style may change pending municipal approval. Retaining wall location and types may vary and are subject to municipal, engineering or developer discretion. Subject to change without notice. Furniture as shown on plans are for layout purposes only and are not included in the sale.

|   | ITEM       | AREA (sf) | %    |
|---|------------|-----------|------|
|   | GARDEN BEI | 394       | 16%  |
|   | GRAVEL     | 364       | 15%  |
|   | CONCRETE   | 826       | 34%  |
|   | SOD        | 836       | 35%  |
| 1 | TOTAL      | 2,420     | 100% |

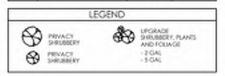

#### KEY PLAN NOT TO SCALE







Typical Fence Detail

TOPICAL PRICE DETAIL SASE OF FENCIONIES US I PROMISSION, SAY DESCRICTABLE MADE IN

#### ADDITIONAL NOTES:

PROPERTY TO BE IRRIGATED 6" PIPE FOR DRIVEWAY SLEEVES TO BE INSTALLED FOR CITY IRRIGATION LINES



Not To Scale

When and parish by the home came to be particular retirement to the particular retirement to the particular retirement to the of before located. Follows Date



ESTIMATED LOCATION OF REAR FENCING - SUBJECT

TO CHANGE ACCORDING TO ACTUAL SITE CONDITIONS

|    | MM/DD/YY | ISSUED/REVISED |   |
|----|----------|----------------|---|
| 01 | 03/09/23 | FOR APPROVAL   |   |
|    |          |                |   |
|    |          |                | П |
|    |          |                |   |
|    |          |                | _ |

PRIVACY SHRUBBERY

PLANTS AND FOLIAGE TO SCREEN PARKING

PLANTS AND FOLIAGE TO SCREEN PARKING AND PROPERTY

> DATE PROJECT

LOT 59 PROPOSED

RESIDENCE

LANDSCAPING PLAN LOT 59, 3478 TRUMPETER ST. ROYAL BAY, SECTOR 7 CITY OF COLWOOD

SUITE PARO

16:22 sq.m.

FARO



CONSTRUCTION

QUALITY CONSTRUCTION. TRUSTED SERVICE.

106 - 1039 Langford Parkway Victoria, B.C. V9B 0A6 P: 250.474.1039 www.verityconstruction.ca

| WSP | Project | No: | 201-08151-00 |
|-----|---------|-----|--------------|
|     | ,       |     |              |

C. Hume - March 23/23

| GABLECTART HOMES BILLIDING   | WSP Project No: 201-08151-00   |
|--|--|
| BUILDING   | GRADE SLIP Issue Date:   |
| MUNICIPAL ADDRESS 408 Rock Dove Place  | P.I.D.   |
| LOT 59   | PLAN   |
| BUILDER VERITY HOMES   | SUBDIVISION  |
| ADDRESS  | ROYAL BAY SECTOR 7  DEVELOPER  |
| REPRESENTATIVE PH.   | MEADOWS DEVELOPMENT LP  CONSULTANT   |
| PROPOSED BUILDING GRADES   | PLAN   |
| ALL ELEVATIONS ARE METRIC GEODETIC +   | <br>LOT:59 PLAN:   |
| MAIN FLOOR ELEVATION 69.10 JOIST   | TRUMPETER ST.  |
| FRONT ELEV_ 68.80/68.60 REAR ELEV_ 68.95/68.92/68.72 DEPTH (FINISHED GRADE)  |  |
| FINISHED GRADE AT GARAGE 68.80   |  |
| 300M   | 68.49  |
|  | (88.72)  |
| ACTUAL TOP OF FOOTING  | (8)<br>(9)<br>(9)<br>(59)  |
| LOWEST PERMITTED TOP OF not provided FLOOR SLAB  | <u>*</u>   |
| FOOTING ELEVATION (LTF) (BOTTOM OF BASEMENT SLAB FROST WALLS ARE REQUIRED.)  | GF: 68.80<br>MSE: 65.56<br>S 64.94<br>D 66.08  |
| SERVICES FRONT REAR CENTER REFER SIZE  | O BF   |
| TO PLAN (mm)  WATER 19   | <u> </u>   |
| SANITARY   | (a) (a) (b) (c) (c) (c) (c) (c) (c) (c) (c) (c) (c   |
| STORM  | 4  |
|  |  |
| COMMENTS YES NO  DRAIN TO SUMP PUMP LIKELY REQUIRED  |  |
| (FOR BASEMENT IF INSTALLED)  | <u>LEGEND</u>  |
| SEWER TO SUMP PUMP LIKELY REQUIRED  (FOR BASEMENT IF INSTALLED)  | STREET   |
| SERVICES INSTALLED TO m INSIDE PROPERTY  | ZY L'Y SERVICE LOCATION  |
| FOUNDATION SOIL BEARING INVESTIGATION CERTIFICATION REQUIRED   | SROW (SHOWN ON ABOVE PLAN)   |
| GEOTECHNICAL RESTRICTIONS APPLY (SEE GEOTECHNICAL REPORT)  | - PROPOSED FRONT CORNER ELEVATIONS - PROPOSED FRONT SIDE YARD GRADES |
| ENVIRONMENTAL RESTRICTIONS APPLY (SEE ENVIRONMENTAL REPORT)  | L# 6 L# 6 L# 6 L# 6 LEGAL LOT NUMBER   |
|  | EG 49.90 - EXISTING GROUND ELEVATION - LOWER/MAIN FLOOR ELEVATION  |
| UTILITY EASEMENTS AFFECT THIS LOT  | GFE 47.55 — GARAGE FLOOR ELEVATION   |
|  | MSE 52.20 — MINIMUM SANITARY SERVICABLE ELEVATION BY GRAVITY  S 49.12 (P) — SAN SERVICE INV.   |
|  | D 49.12 (P) (P) DENOTES PUMP IS LIKELY REQUIRED FOR BASEMENT IF INSTALLED  |
|  | - STORM SERVICE INV. (P) DENOTES PUMP IS LIKELY REQUIRED FOR BASEMENT IF INSTALLED   |
|  | - PROPOSED REAR SIDE YARD GRADES   |
| NOTES  | - LOT TYPE (L/LB/LBT) - PROPOSED REAR CORNER ELEVATIONS  |
| IT IS THE RESPONSIBILITY OF THE BUILDER TO ENSURE THE FOOTINGS     ARE PLACED ON A PROPER BASE THAT IS FREE FROM FROST,     EXCESSIVE MOISTURE AND DELETERIOUS MATERIALS AND HAVE     APPROPRIATE FROST PROTECTION WHEN COMPLETED. | LANE/LOT - PROPOSED REAR CORNER ELEVATIONS   |
| THE INFORMATION CONTAINED HEREIN IS BASED ON THE APPROVED  |  |
| 2. THE INFORMATION CONTAINED HEREIN IS BASED ON THE APPROVED  LOT GRADING PLAN FOR THIS SUBDIVISION. UN—AUTHORIZED  DEVIATIONS WILL BE THE RESPONSIBILITY OF THE BUILDER TO  ENSURE COMPLIANCE WITH ALL LOCAL BYLAWS.              | I, THE BUILDER'S REPRESENTATIVE,,  |
| 3. OTHER NOTES:  | CERTIFY THAT THE FINAL HOUSE PLANS PROVIDED IN THE BUILDING PERMIT<br>APPLICATION ARE THE SAME AS PROCESSED UNDER THIS GRADE SLIP AND<br>THAT I UNDERSTAND THE INFORMATION AND THE REQUIREMENTS CONTAINED                                      |
|  | HEREIN AND WILL BUILD ACCORDINGLY.   |
|  | AUTHORIZED BUILDER'S REPRESENTATIVE DATE   |
|  | THE INFORMATION CONTAINED HEREIN IS BASED ON THE APPROVED LOT GRADING PLAN FOR THIS SUBDIVISION, DATED   |

## SCHEDULE 6

SECTOR 7 - LOT 60


| SITE DATA               | RBCD5 MEDIUM ONE FAMILY |              |  |  |
|-------------------------|-------------------------|--------------|--|--|
| ITEMS                   | PERMITTED               | PROPOSED     |  |  |
| LOT AREA                | 368                     | 440.40 sq.m. |  |  |
| LOT COVERAGE            | 50.00 %                 | 36.45 %      |  |  |
| BUILDING HEIGHT         | 9.50 m.                 | - m.         |  |  |
| LOT WIDTH               | 10.97 m.                | 11.00 m.     |  |  |
| SETBACKS                |                         |              |  |  |
| - FRONT                 | 3.00 m.                 | 5.56 m.      |  |  |
| - FRONT (GARAGE)        | 6.00 m.                 | 6.05 m.      |  |  |
| - REAR                  | 6.00 m.                 | 9.67 m.      |  |  |
| - SIDE                  | 1.20 m.                 | 1.20 m.      |  |  |
| - SIDE                  | 1.20 m.                 | 1.21 m.      |  |  |
| PROPOSED FLOOR AREA     |                         |              |  |  |
| - UPPER                 |                         | 139.95 sq.m. |  |  |
| - MAIN                  |                         | 100.87 sq.m. |  |  |
| - GARAGE                |                         | 46.25 sq.m.  |  |  |
| SUB-TOTAL G.F.A.        |                         | 287.07 sq.m. |  |  |
| GARAGE ALLOWANCE        | 50.00 sq.m.             | -46.20 sq.m. |  |  |
| GROSS FLOOR AREA        |                         | 240.87 sq.m. |  |  |
| F.A.R.                  |                         | 0.55 TO 1.0  |  |  |
| SECONDARY SUITE         |                         |              |  |  |
| SECONDARY SUITE (%)     | 40.00 %                 | 24.80 %      |  |  |
| SECONDARY SUITE (SQ.M.) | 90.00 sq.m.             | 59.73 sq.m.  |  |  |

AVERAGE NATURAL GRADE CALCULATION 68.51 m. + 68.47 m. + 68.73 m. + 68.60 m. = 274.31 m. divided by 4 = ave. grade 68.58 m.

#### SEE LANDSCAPING PLAN FOR TREE SCHEDULE

#### RETAINING WALLS

\*XX.Xm\* = DESIGNER APPROXIMATE HEIGHT MEASUREMENT, VERIFY ON SITE - TO BE CERTIFIED BY AN ENGINEER AND MEET BCBC REQUIREMENTS FOR EARTHQUAKE DESIGN (REFER TO STRUCTURAL DRAWINGS) - ALL LANDSCAPE RETAINING WALLS TO HAVE A 1.2m MAX. EXPOSED HT OR A MAX. 1:1 RATIO OF HEIGHT TO HORIZONTAL SEPARATION IF TERRACED

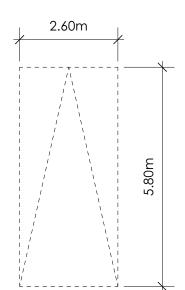

PARKING STALL DIMENSIONS

SMALL CAR PARKING STALL DIMENSIONS

 $^{\ast}$  as per 2.2.02a allowing one stall to be a small car parking stall

#### **STOP & READ**

RETAINING WALLS <u>MAY NOT</u> EXCEED 1.2m IN HEIGHT OR A 1:1 RATIO OF HEIGHT TO HORIZONTAL SEPARATION IF TERRACED


ALL FENCING, RETAINING AND LANDSCAPING MUST MEET THE GUIDELINE REQUIREMENTS

MAXIMUM PROJECTIONS / CANTILEVERS / OVERHANGS INTO SETBACKS ARE 0.65m IN YARDS OF LESS THAN 3.0m AND 1.0m IN YARDS OF 3.0m+.

THE WIDTH OF THE DRIVEWAY ACCESS (AT PROPERTY LINE - CROSSING THE CITY BOULEVARD) MAY NOT EXCEED 7.0m IN WIDTH

CONTRACTOR TO ENSURE A MINIMUM 2% SLOPE SIDE YARD SWALING (BOTH SIDES) MAY BE REQUIRED

ALL FENCING, RETAINING AND LANDSCAPINING MUST MEET GUIDELINE REQUIREMENTS

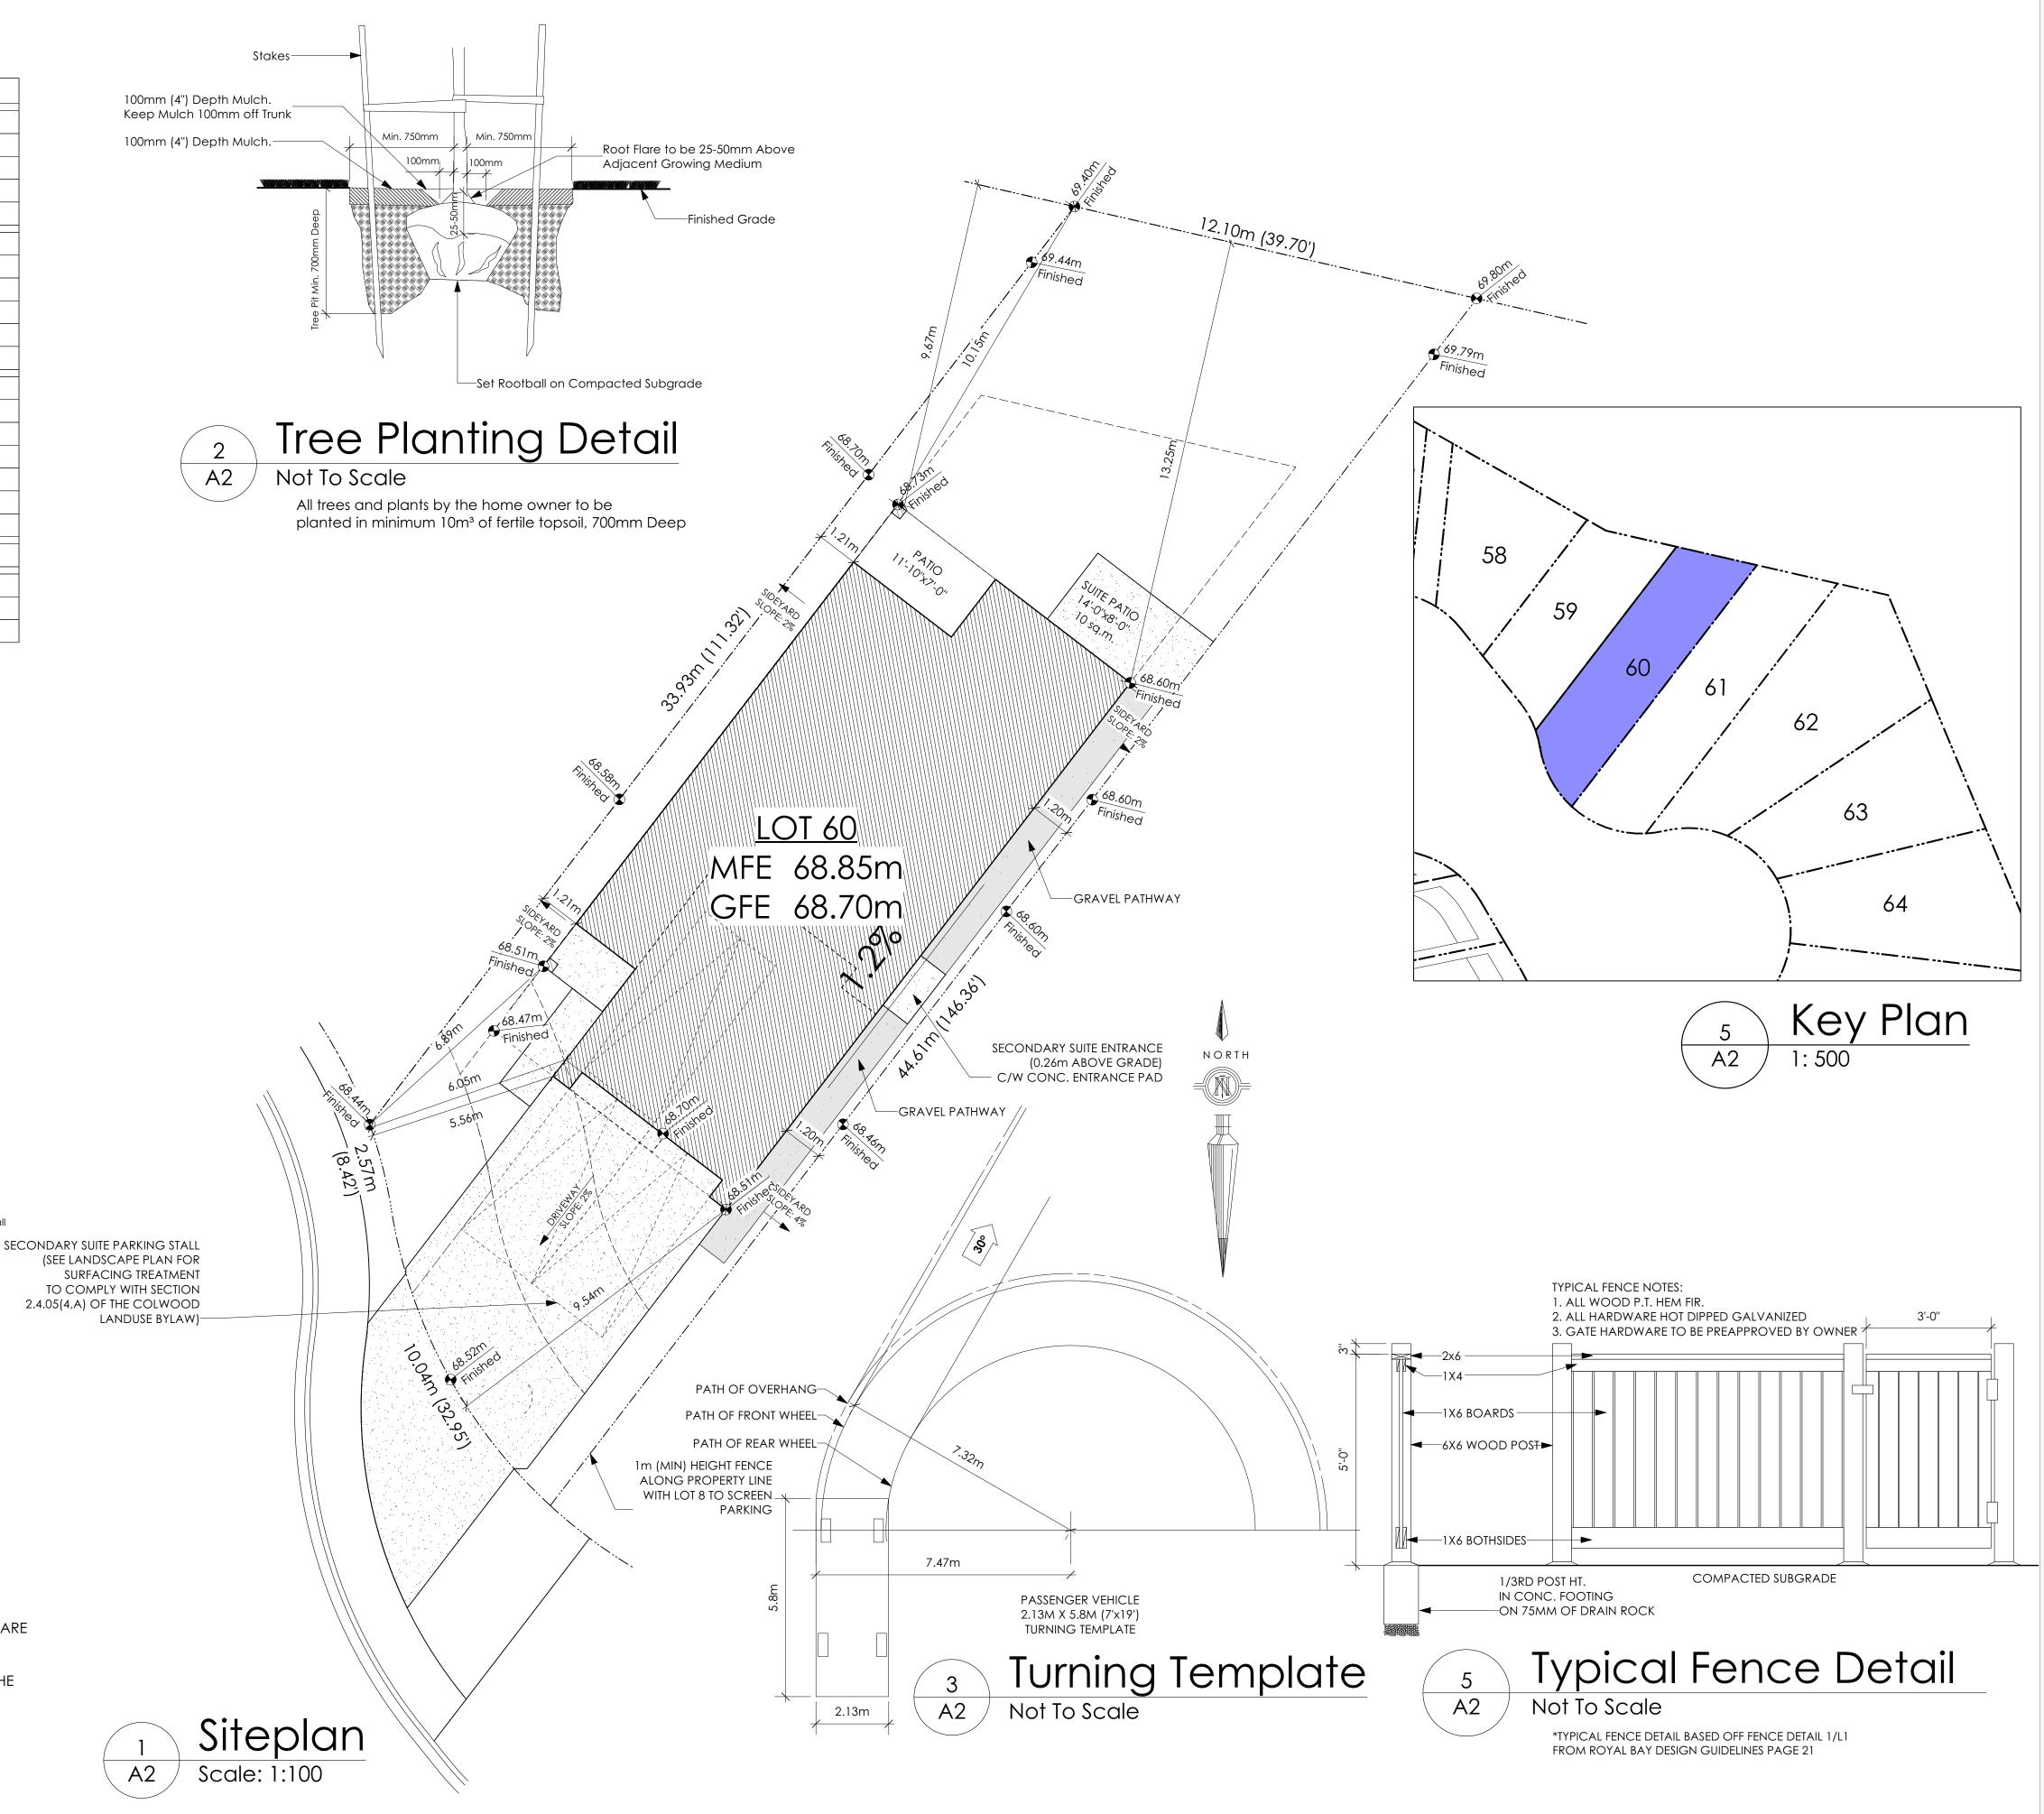

#103 - 891ATTREE AVENUE VICTORIA, B.C. V9B 0A6 P. 250.382.7374 F. 250.382.7364

THE PEARL (MODIFIED) TRADITIONAL

Date

Feb 22, 2023

**Project Address** 3476 TRUMPETER STREET Royal Bay - Sector 7 Colwood, B.C.

Prepared for

Verity Construction

Project #


8298-60


Scale


As Noted

Drawn By

MDK

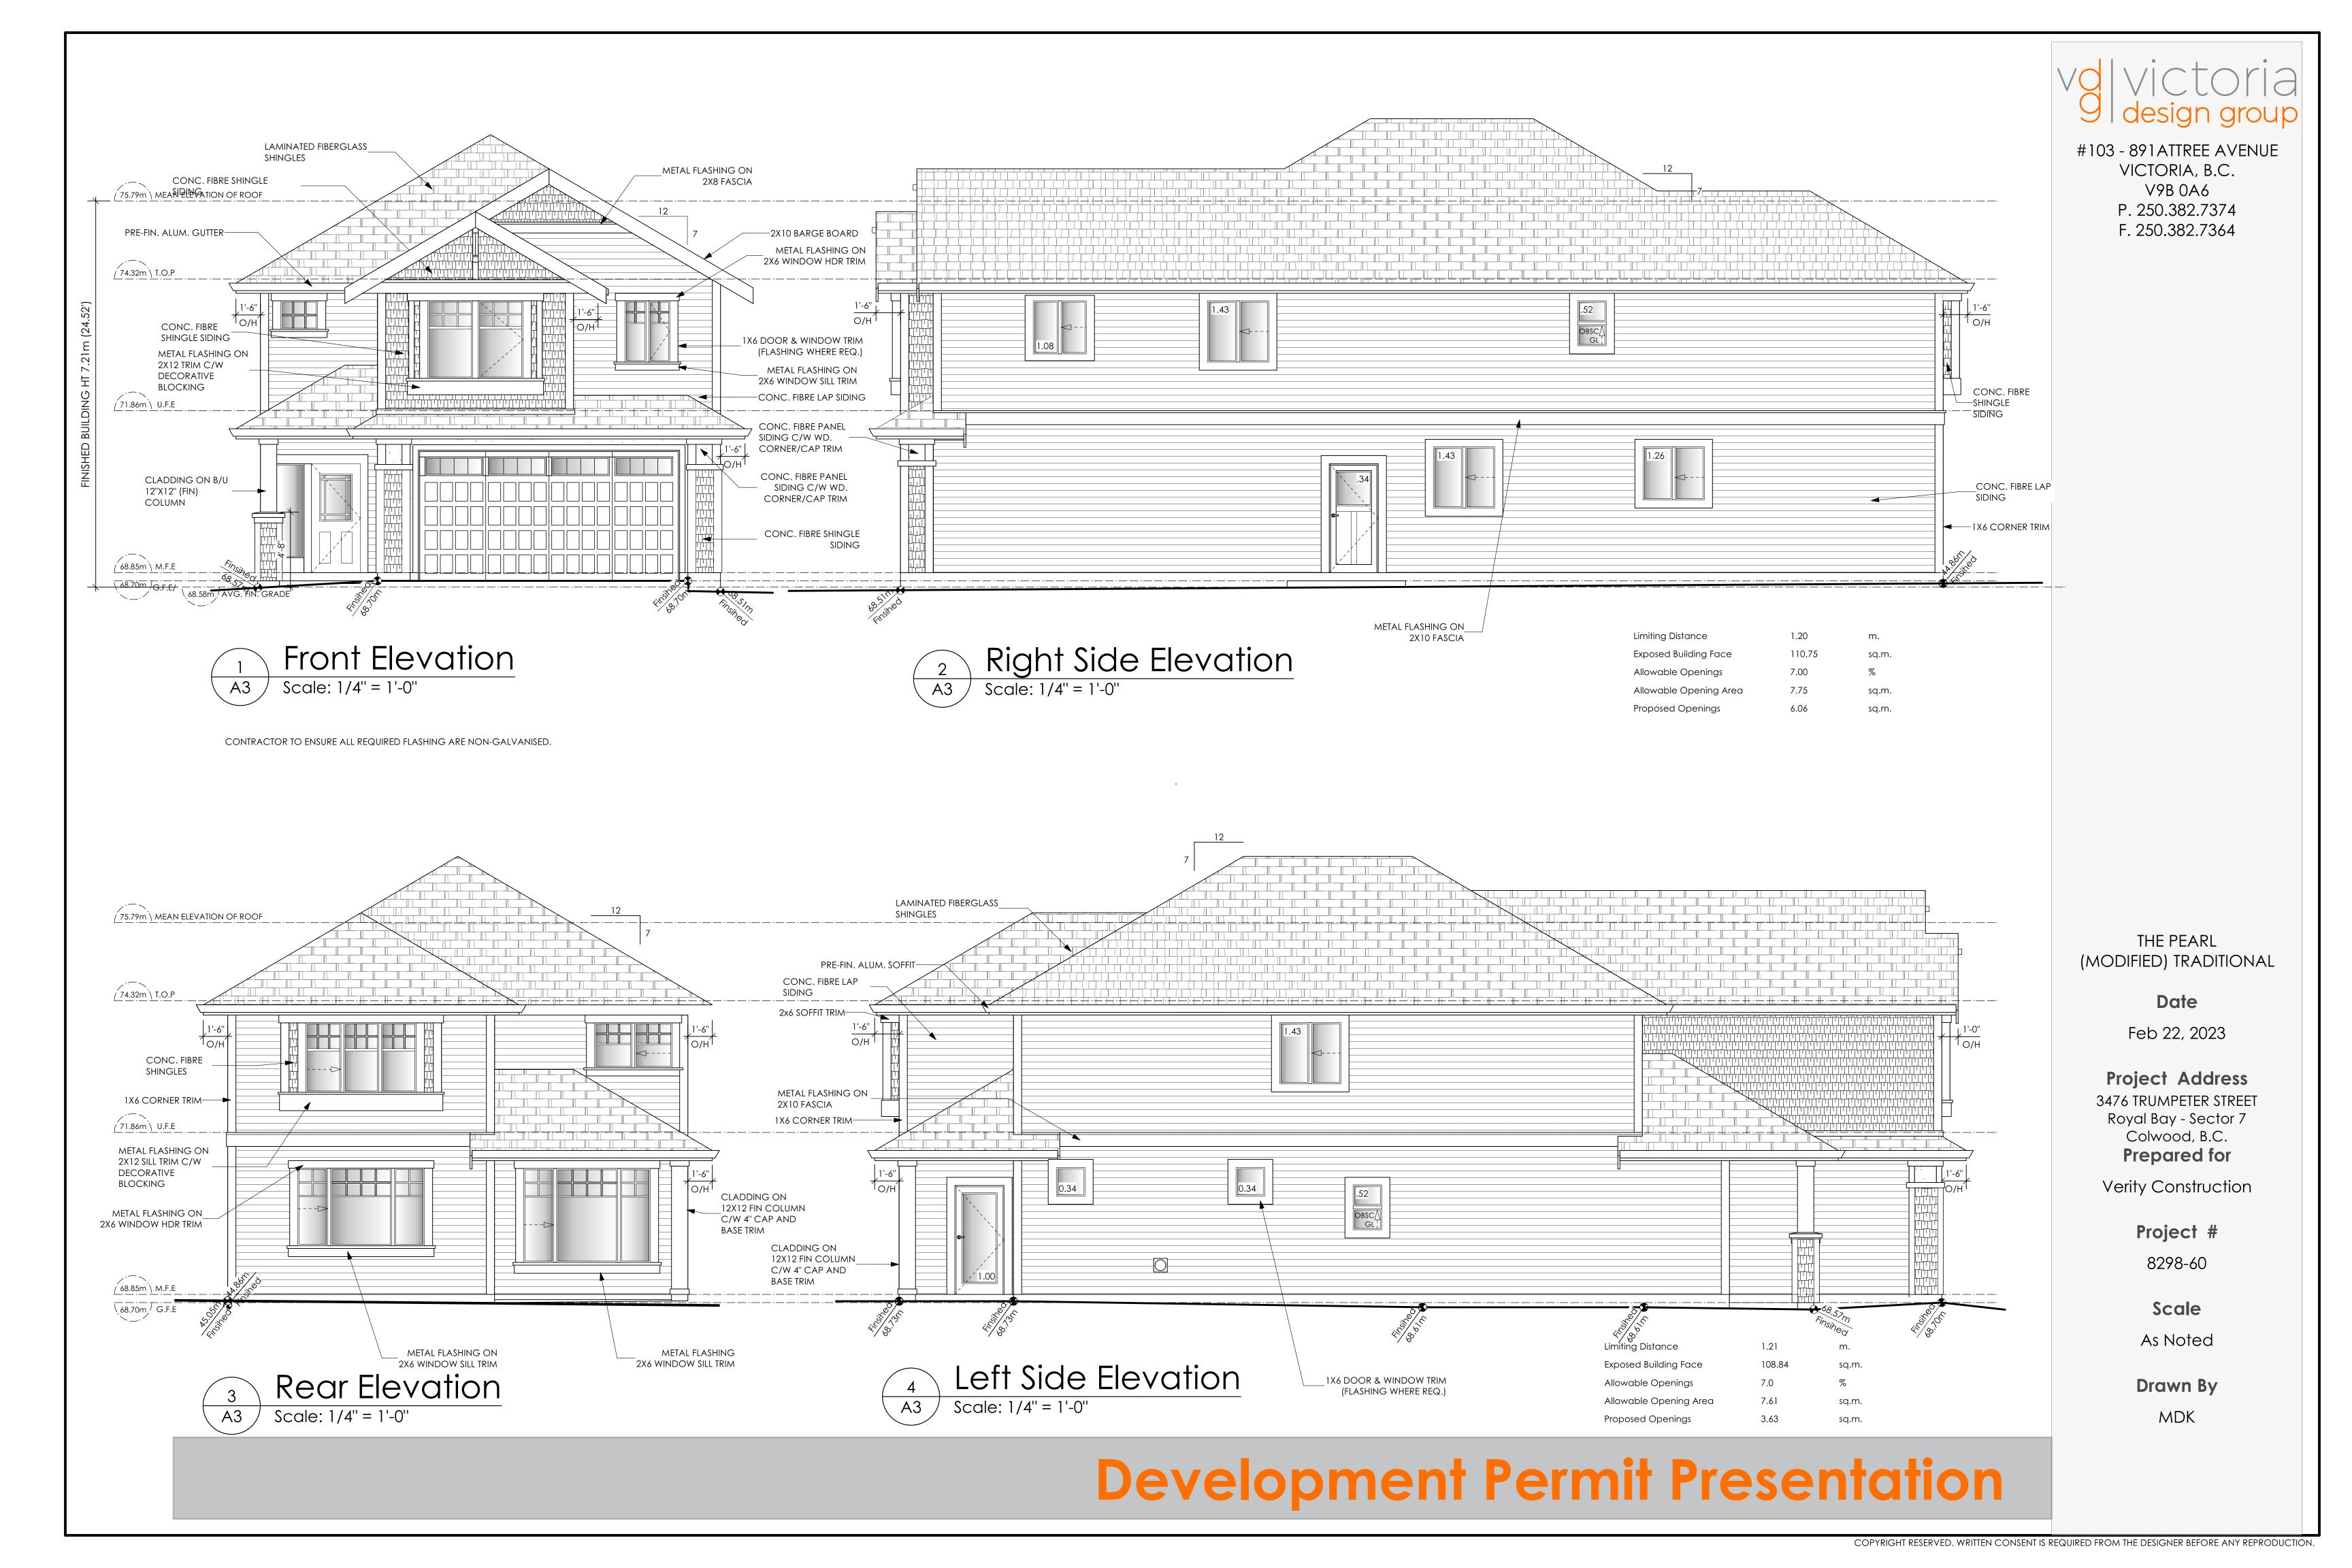

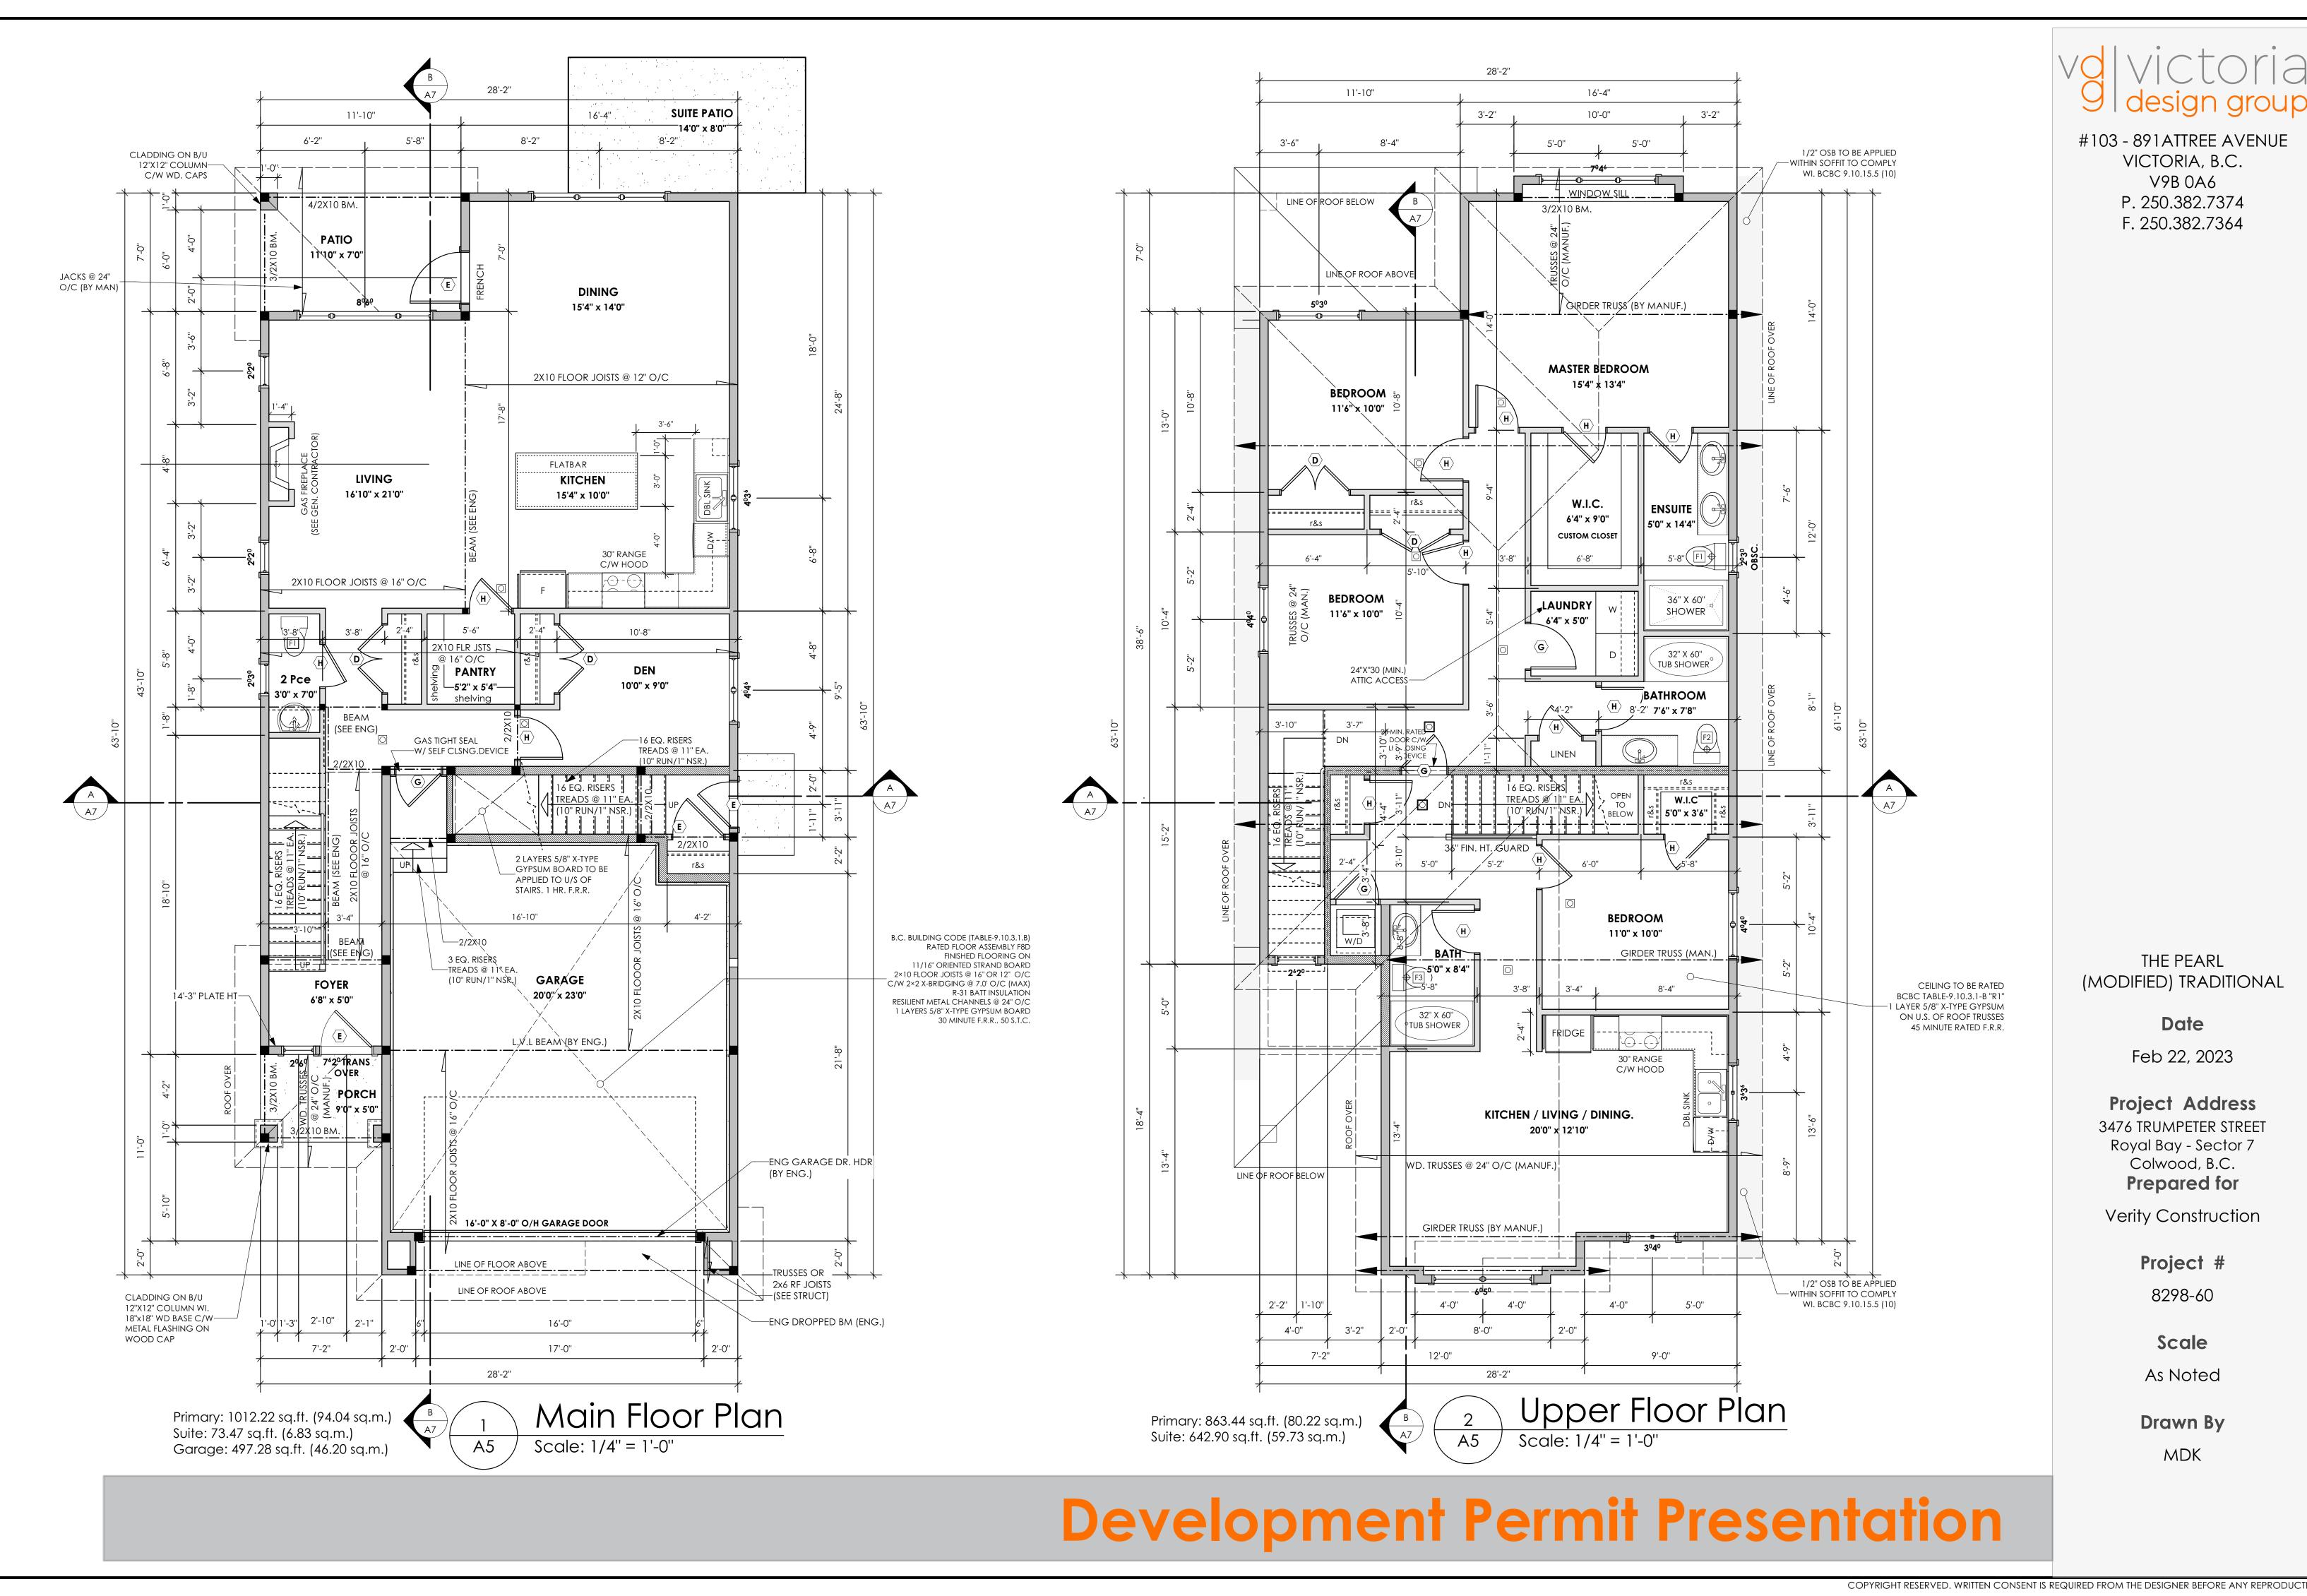

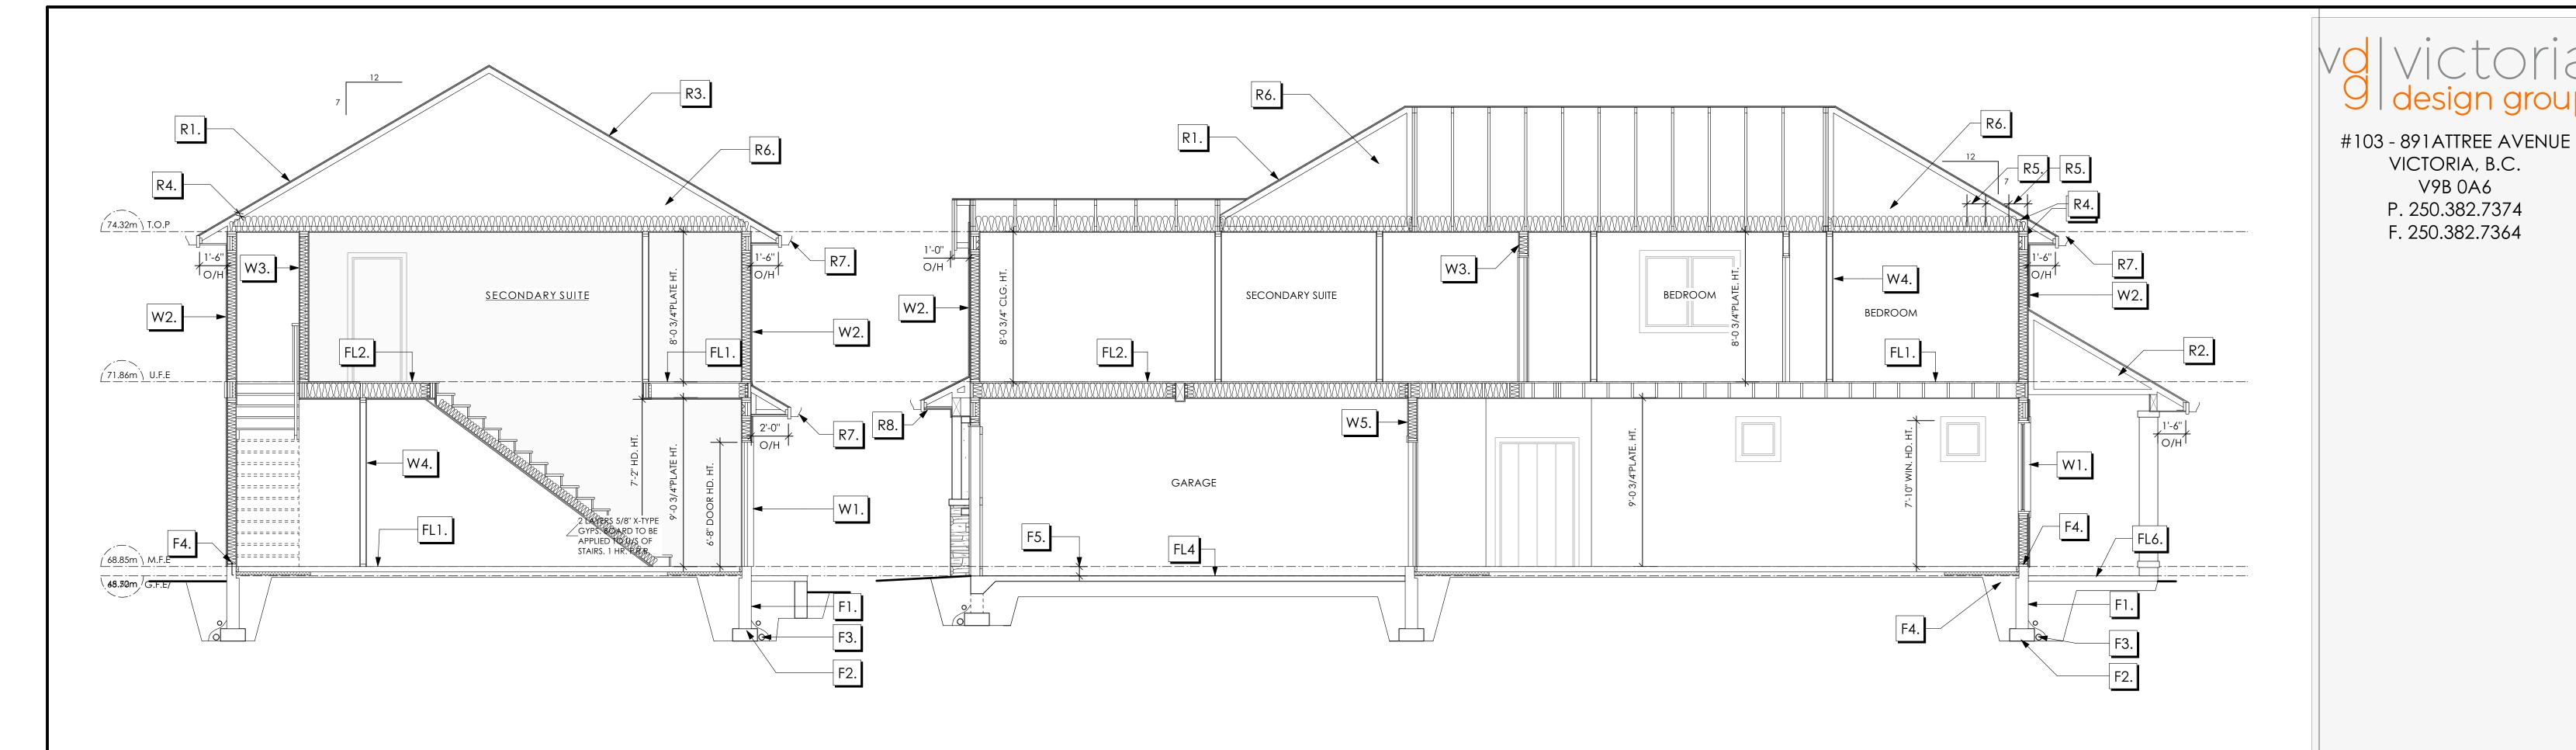

## Section A-A Scale: 1/4" = 1'-0"

### ROOFS

- LAMINATED ASPHALT SHINGLES ON 7/16" ORIENTED STRAND BOARD C/W "H" CLIPS WD TRUSSES (DESIGNED BY MANUF.) R-40 FIBRE GLAS BATT INSULATION OR 14 1/2" FIBRE GLASS LOOSE FILL INSULATION 6 MIL POLY'N V.B. 5/8" GYPSUM BOARD
- R2. LAMINATED ASPHALT SHINGLES ON 7/16" ORIENTED STRAND BOARD C/W "H" CLIPS 2x8 ROOF JOISTS @ 16" O/C VENTED SOFFIT
- R3. B.C. BUILDING CODE (TABLE-9.10.3.1.B) RATED ROOF ASSEMBLY LAMINATED ASPHALT SHINGLES ON 7/16" ORIENTED STRAND BOARD C/W "H" CLIPS FL3. FINISHED FLOORING ON WD TRUSSES (DESIGNED BY MANUF.) R-40 FIBRE GLAS BATT INSULATION OR 14 1/2" FIBRE GLASS LOOSE FILL INSULATION 6 MIL POLY'N V.B. 5/8" X-TYPE GYPSUM BOARD 45 MINUTE RATED F.R.R.
- R4. PROVIDE 2 1/2" (63MM) CLEAR BETWEEN R-20 INSULATION AND SHEATHING. (MIN. R-20 @ ROOF-WALL CONNECTION FOR 4'-0" (1.2M) AROUND PERIMETER OF BUILDING. FL4. 3 1/2" CONCRETE SLAB AIR VENTILATION BAFFLES TO BE INSTALLED WHERE REQUIRED IN AS PER BCBC 9.19.)
- R5. EAVE PROTECTION CONT. UP ROOF SLOPE FOR 12" PAST EXTERIOR WALL.
- PROVIDE 1 SQ.FT. ATTIC VENT PER 300 SQ.FT. OF INSULATED AREA MIN. 25% OF REQUIRED TO BE @ TOP AND BOTTOM (TO COMPLY WI. B.C. BLDG. CODE 9.19.1)
- R7. PRE-FIN. FASCIA GUTTER 2×8 FASCIA BD. 2×4 SUB. FASCIA BD. VENTED SOFFIT (SEE CONTRACTOR)
- R8. PRE-FIN. FASCIA GUTTER 2×8 FASCIA BD. 2×4 SUB. FASCIA BD. 1/2" ORIENTED STRAND BOARD VENTED SOFFIT (SEE CONTRACTOR)

## **Section Notes**

## **FLOORS**

- FL1. 3 1/2" CONCRETE SLAB 6 MIL. POLY'N V.B. 6" COMPACTED GRAVEL OR SAND
- FL2. B.C. BUILDING CODE (TABLE-9.10.3.1.B) RATED FLOOR ASSEMBLY F8D FINISHED FLOORING ON 11/16" ORIENTED STRAND BOARD (FASTENED & GLUED TO FLOOR STRUCT. BELOW) ON 2×10 FLOOR JOISTS @ 16" OR 12" O/C C/W 2×2 X-BRIDGING @ 7.0' O/C (MAX) R-31 INSULATION RESILIENT METAL CHANNELS @ 24" O/C 1 LAYERS 5/8" X-TYPE GYPSUM BOARD 30 MINUTE F.R.R., 50 S.T.C.
- 11/16" ORIENTED STRAND BOARD (FASTENED & GLUED TO FLOOR STRUCT. BELOW) ON 2×10 FLOOR JOISTS @ 16" OR 12" O/C C/W 2×2 X-BRIDGING @ 7.0' O/C (MAX) PROVIDE R-31 F/G BATT INSULATION IN JOIST CAVITY C/W BUILDING WRAP VENTED SOFFIT (TO OWNERS SPEC'S) TO ALL SUSPENDED FLOOR AREAS
- 6 MIL. POLY'N V.B. 6" COMPACTED GRAVEL OR SAND SLOPE TO DOORS 1"

## Section B-B Scale: 1/4" = 1'-0"

## WALLS

- W1. DOUBLE GLAZING ENERGY STAR LOW "E" RATING IN THERMAL BREAK FRAMES 2/2"X10" LINTEL OVER (@ bearing walls only) (TYPICAL, wi. 2 1/2" XPS insulation) FLASHING OVER @ EXTERIOR (glazing in all exterior doors & within 3 ft. of exterior doors to be shatterproof (SP)) WINDOW REQUIREMENTS DERIVED FROM CITY OF COLWOOD BUILDING BYLAW AND ARE TO BE USED TO SATISFY THE REQUIREMENTS OF AAMA/WDMA/CSA 101/I.S.2/A440, "NAFS": COLWOOD, CLASS R - PG30 (220) A3, RATINGS MUST BE CLEARLY LABELED ON ALL UNITS UPON INSTALLATION FOR INSPECTION
- W2. CONC. FIBRE BOARD ON 9.5MM (3/8") AIR SPACE / STRAPPING 3/8"×2" BORATE TREATED PLYWOOD STRAPPING HOUSE WRAP (A.B.) (TYVEK OR EQ.) 7/16" ORIENTED STRAND BOARD SHEATHING 2×6 STUDS @ 16" O/C R-20 INSULATION 6 MIL. POLYETHYLENE VAPOUR BARRIER 1/2" GYPSUM BOARD
- W3. B.C. BUILDING CODE (TABLE 9.10.3.1.A) RATED WALL ASSEMBLY W3c 1 LAYER 1/2" X-TYPE GYPSUM BOARD RESILIENT METAL CHANNELS @ 24" O/C 2×4 STUDS @ 16" O/C OR 2×6 STUDS @ 16" O/C (IF NOTED) C/W 3 1/2" FIBRE GLASS SOUND BATTS 1 LAYER 1/2" X-TYPE GYPSUM BOARD 45 MIN. F.R.R 43 S.T.C (BETWEEN PRIMARY LIVING & SECONDARY SUITE)

- W4. INTERIOR PARTITION 1/2" GYPSUM BOARD ON EACH SIDE OF 2×4 STUDS @ 16" O/C OR 2×6 STUDS @ 16" O/C (IF NOTED)
- W5. 5/8" X-TYPE GYPSUM BOARD ON 2×6 STUDS @ 16" O/C C/W R-20 INSULATION 6 MIL. POLY'N V.B 1/2" GYPSUM BOARD (BETWEEN GARAGE & LIVING)
- W6. 1/2" GYPSUM BOARD ON 6 MIL. POLY'N V.B. 2×4 STUDS @ 24" O/C C/W R-12 BATT INSULATION BUILDING WRAP OR 12.7MM (1/2") AIR SPACE (PROVIDE REQUIRED FIRE STOPS IN WALL ASSEMBLIES TO COMPLY WITH B.C. BLDG. CODE 9.10.16.)

#### FOUNDATION

- F1. DAMP PROOFING (WHERE REQUIRED) ON 8" THK. CONC. FOUNDATION WALL C/W 15 M BARS @ 24" O/C B/W
- F2. 16"X 8" CONC. FOOTINGS C/W 2 (TWO) 15M BARS CONT. 3 IN. FROM BOTT. ON UNDISTURBED SOIL (SOLID BEARING)
- F3. 4" PERIMETER DRAIN 3" TIGHT PIPE FOR RWL DRAIN ROCK
- F4. ANCHOR BOLTS @ 4.0 FT. O/C MAX C/W SILL GASKETS
- F5. STEP DOWN TO GARAGE SLAB MAY VARY, VERIFY EXTENT ON SITE
- F6. UNDER SLAB INSULATION 2 1/2" (RSI 2.15) EXTRUDED POLYSTYRENE RIGID INSULATION 4'-0" (1.2M) CONT. AROUND PERIMETER UNDER SLAB INSTALLED HORIZONTALLY (VERIFY WITH MUNICIPALITY DEPTH OF FROST LINE)

ALL STRUCTURE TO BE VERIFIED OR DESIGNED BY A STRUCTURAL ENGINEER. STRUCTURAL ENGINEER TO LOCATE AND DESIGN REQUIRED EXTERIOR AND INTERIOR WALL BRACING TO RESIST LATERAL LOADS IN COMPLIANCE WITH B.C. BUILDING CODE 2012 9.23.13. AND SUPPLY DETAILS IF REQUIRED

THE PEARL

(MODIFIED) TRADITIONAL

VICTORIA, B.C.

V9B 0A6

P. 250.382.7374

F. 250.382.7364

Date

Feb 22, 2023

**Project Address** 

3476 TRUMPETER STREET Royal Bay - Sector 7 Colwood, B.C. Prepared for

Verity Construction


Project #

8298-60

Scale

As Noted

Drawn By MDK

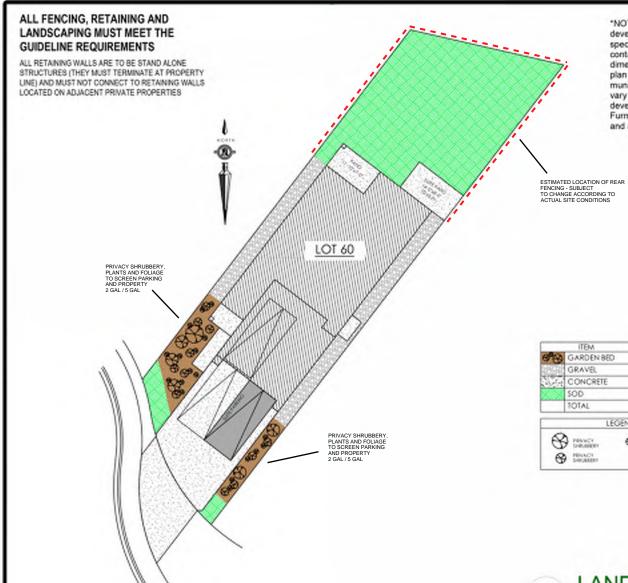


"NOTE: In the interest of maintaining high standards, the developer reserves the right to modify plans, specifications and design without prior notice. Drawings contained within are artist renderings only. Sizes and dimensions are approximate and may vary with actual plan and survey. Exterior style may change pending municipal approval. Retaining wall location and types may vary and are subject to municipal, engineering or developer discretion. Subject to change without notice. Furniture as shown on plans are for layout purposes only and are not included in the sale.


ITEM AREA (sf) GARDEN BED 10% 299 GRAVEL 416 13% CONCRETE 931 29% SOD 48% 1.506 TOTAL 3.152 100%

LEGEND PRIVACY DRAWN MO FORAGE PRINCY SHORE

> LANDSCAPE PLAN NOT TO SCALE

KEY PLAN NOT TO SCALE

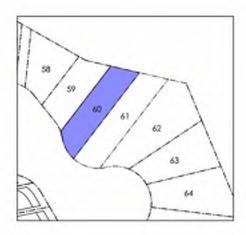

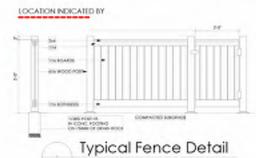

Not To Scale THICK PROJUDIAL MAIL OF PERCENTIAL VICE

ADDITIONAL NOTES: PROPERTY TO BE IRRIGATED 6" PIPE FOR DRIVEWAY SLEEVES TO BE INSTALLED FOR CITY IRRIGATION LINES



|    | MM/DD/YY | ISSUED/REVISED |  |
|----|----------|----------------|--|
| 01 | 03/03/23 | FOR APPROVAL   |  |
|    |          |                |  |
|    |          |                |  |
|    |          |                |  |
|    |          |                |  |

DATE PROJECT

> LANDSCAPING PLAN LOT 60, 3476 TRUMPETER ST. **ROYAL BAY, SECTOR 7** CITY OF COLWOOD



CONSTRUCTION


QUALITY CONSTRUCTION. TRUSTED SERVICE.


106 - 1039 Langford Parkway Victoria, B.C. V9B 0A6


P: 250.474.1039 www.verityconstruction.ca


| WSP | Project | No: | 201-08151-00 |
|-----|---------|-----|--------------|
|     | ,       |     |              |

|  |                               |            | Issue Date:  |
|--|-------------------------------|------------|--|
| MUNICIPAL<br>ADDRESS 3476 Trumpeter Street   |                               |            | P.I.D.   |
| LOT 60   |                               |            | PLAN   |
| VERITY HOMES   |                               |            | SUBDIVISION PAY SECTOR 7   |
| ADDRESS  |                               |            | ROYAL BAY SECTOR 7  DEVELOPER  MEADOWS DEVELOPMENT LP  |
| REPRESENTATIVE   | PH.                           |            | CONSULTANT  WSP CANADA INC   |
| PROPOSED BUILDING GRADES   |                               |            | PLAN   |
| ALL ELEVATIONS ARE METRIC GEODETIC +   |                               |            | LOT:60 PLAN:   |
| main floor elevation <u>68.85</u> (TOP OF JOISTS)  |                               | JOIST      |  |
| FRONT ELEV_68.51 REAR ELEV_68.73/68.60 (FINISHED GRADE)  | - 7777                        | DEPTH      | 69.8   |
| FINISHED GRADE AT GARAGE 68.70/68.51   |                               |            | 7 <del>4</del> 69.4  |
|  |                               | WOOM       |  |
|  |                               | (EADROOM   | <u>88</u>  |
| ACTUAL TOP OF FOOTING  |                               |            | (88.70   |
| ELEVATION (ATF)<br>LOWEST PERMITTED TOP OF <u>not provided</u>   | 1000                          | FLOOR SLAB | . <u>09</u> . <u>89</u>  |
| FOOTING ELEVATION (LTF)<br>(BOTTOM OF BASEMENT SLAB<br>FROST WALLS ARE REQUIRED.)  |                               |            | 60<br>89<br>EG 66.4<br>MFE 68.84   |
| SERVICES FRONT REAR CENTER   | REFER                         | SIZE       | GFE 68.64<br>MSE 65.23   |
|  | TO PLAN                       | (mm)       | S   64.66   G   F   G   G   G   G   G   G   G   G  |
|  |                               | 19         | 4 14   |
|  |                               | 100        |  |
| STORM  |                               | 100        | 66.52  |
| COMMENTS   | YES                           | NO         | TRUMPETER ST.  |
| DRAIN TO SUMP PUMP LIKELY REQUIRED (FOR BASEMENT IF INSTALLED)   |                               |            | LEGEND   |
| SEWER TO SUMP PUMP LIKELY REQUIRED (FOR BASEMENT IF INSTALLED)   |                               |            | STREET   |
| SERVICES INSTALLED TO m INSIDE PROPERTY  |                               |            | SAN.<br>  WAT.   |
| FOUNDATION SOIL BEARING INVESTIGATION CERTIFICATION REQUIRED   |                               |            | - SERVICE LOCATION (SHOWN ON ABOVE PLAN)   |
| GEOTECHNICAL RESTRICTIONS APPLY  |                               |            |  |
| (SEE GEOTECHNICAL REPORT)  |                               |            | PROPOSED FRONT CORNER ELEVATION - PROPOSED FRONT SIDE YARD GRADE STATE OF THE PROPOSED FRONT CORNER ELEVATION - PROPOSED FRONT SIDE YARD GRADE STATE OF THE PROPOSED FRONT CORNER ELEVATION - PROPOSED FRONT SIDE YARD GRADE STATE OF THE PROPOSED STATE STATE STATE OF THE PROPOSED STATE STATE STATE STATE STATE STATE STATE STATE STATE |
| (SEE ENVIRONMENTAL REPORT)   |                               |            | EG 49.90 C - EXISTING GROUND ELEVATION   |
| UTILITY EASEMENTS AFFECT THIS LOT  |                               |            | GFE 47.55  LFE/MFE 47.70  — LOWER/MAIN FLOOR ELEVATION  — GARAGE FLOOR ELEVATION   |
|  |                               |            | MSE 52.20 — MINIMUM SANITARY SERVICABLE ELEVATION BY GRAVITY   |
|  |                               |            | S 49.12 (P)  D 49.12 (P)  SAN SERVICE INV. (P) DENOTES PUMP IS LIKELY REQUI  |
|  |                               |            | FOR BASEMENT IF INSTALLED  FOR BASEMENT IF INSTALLED  STORM SERVICE INV.  (P) DENOTES PUMP IS LIKELY REQUI   |
|  |                               |            | FOR BASEMENT IF INSTALLED  |
|  |                               |            | L V S - LOT TYPE (L/LB/LBT)  |
| NOTES  |                               |            | - PROPOSED REAR CORNER ELEVATION LANE/LOT  |
| <ol> <li>IT IS THE RESPONSIBILITY OF THE BUILDER TO<br/>ARE PLACED ON A PROPER BASE THAT IS FRE<br/>EXCESSIVE MOISTURE AND DELETERIOUS MATERI<br/>APPROPRIATE FROST PROTECTION WHEN COMPL</li> </ol> | E FROM FROS<br>IALS AND HAV   | ST,        |  |
| 2. THE INFORMATION CONTAINED HEREIN IS BASED LOT GRADING PLAN FOR THIS SUBDIVISION. UN DEVIATIONS WILL BE THE RESPONSIBILITY OF THE ENSURE COMPLIANCE WITH ALL LOCAL BYLAWS.                         | N-AUTHORIZED<br>HE BUILDER TO |            | I, THE BUILDER'S REPRESENTATIVE,  CERTIFY THAT THE FINAL HOUSE PLANS PROVIDED IN THE BUILDING PER  |
| 3. OTHER NOTES:  |                               |            | APPLICATION ARE THE SAME AS PROCESSED UNDER THIS GRADE SLIP A THAT I UNDERSTAND THE INFORMATION AND THE REQUIREMENTS CONTA HEREIN AND WILL BUILD ACCORDINGLY.  |
|  |                               |            |  |

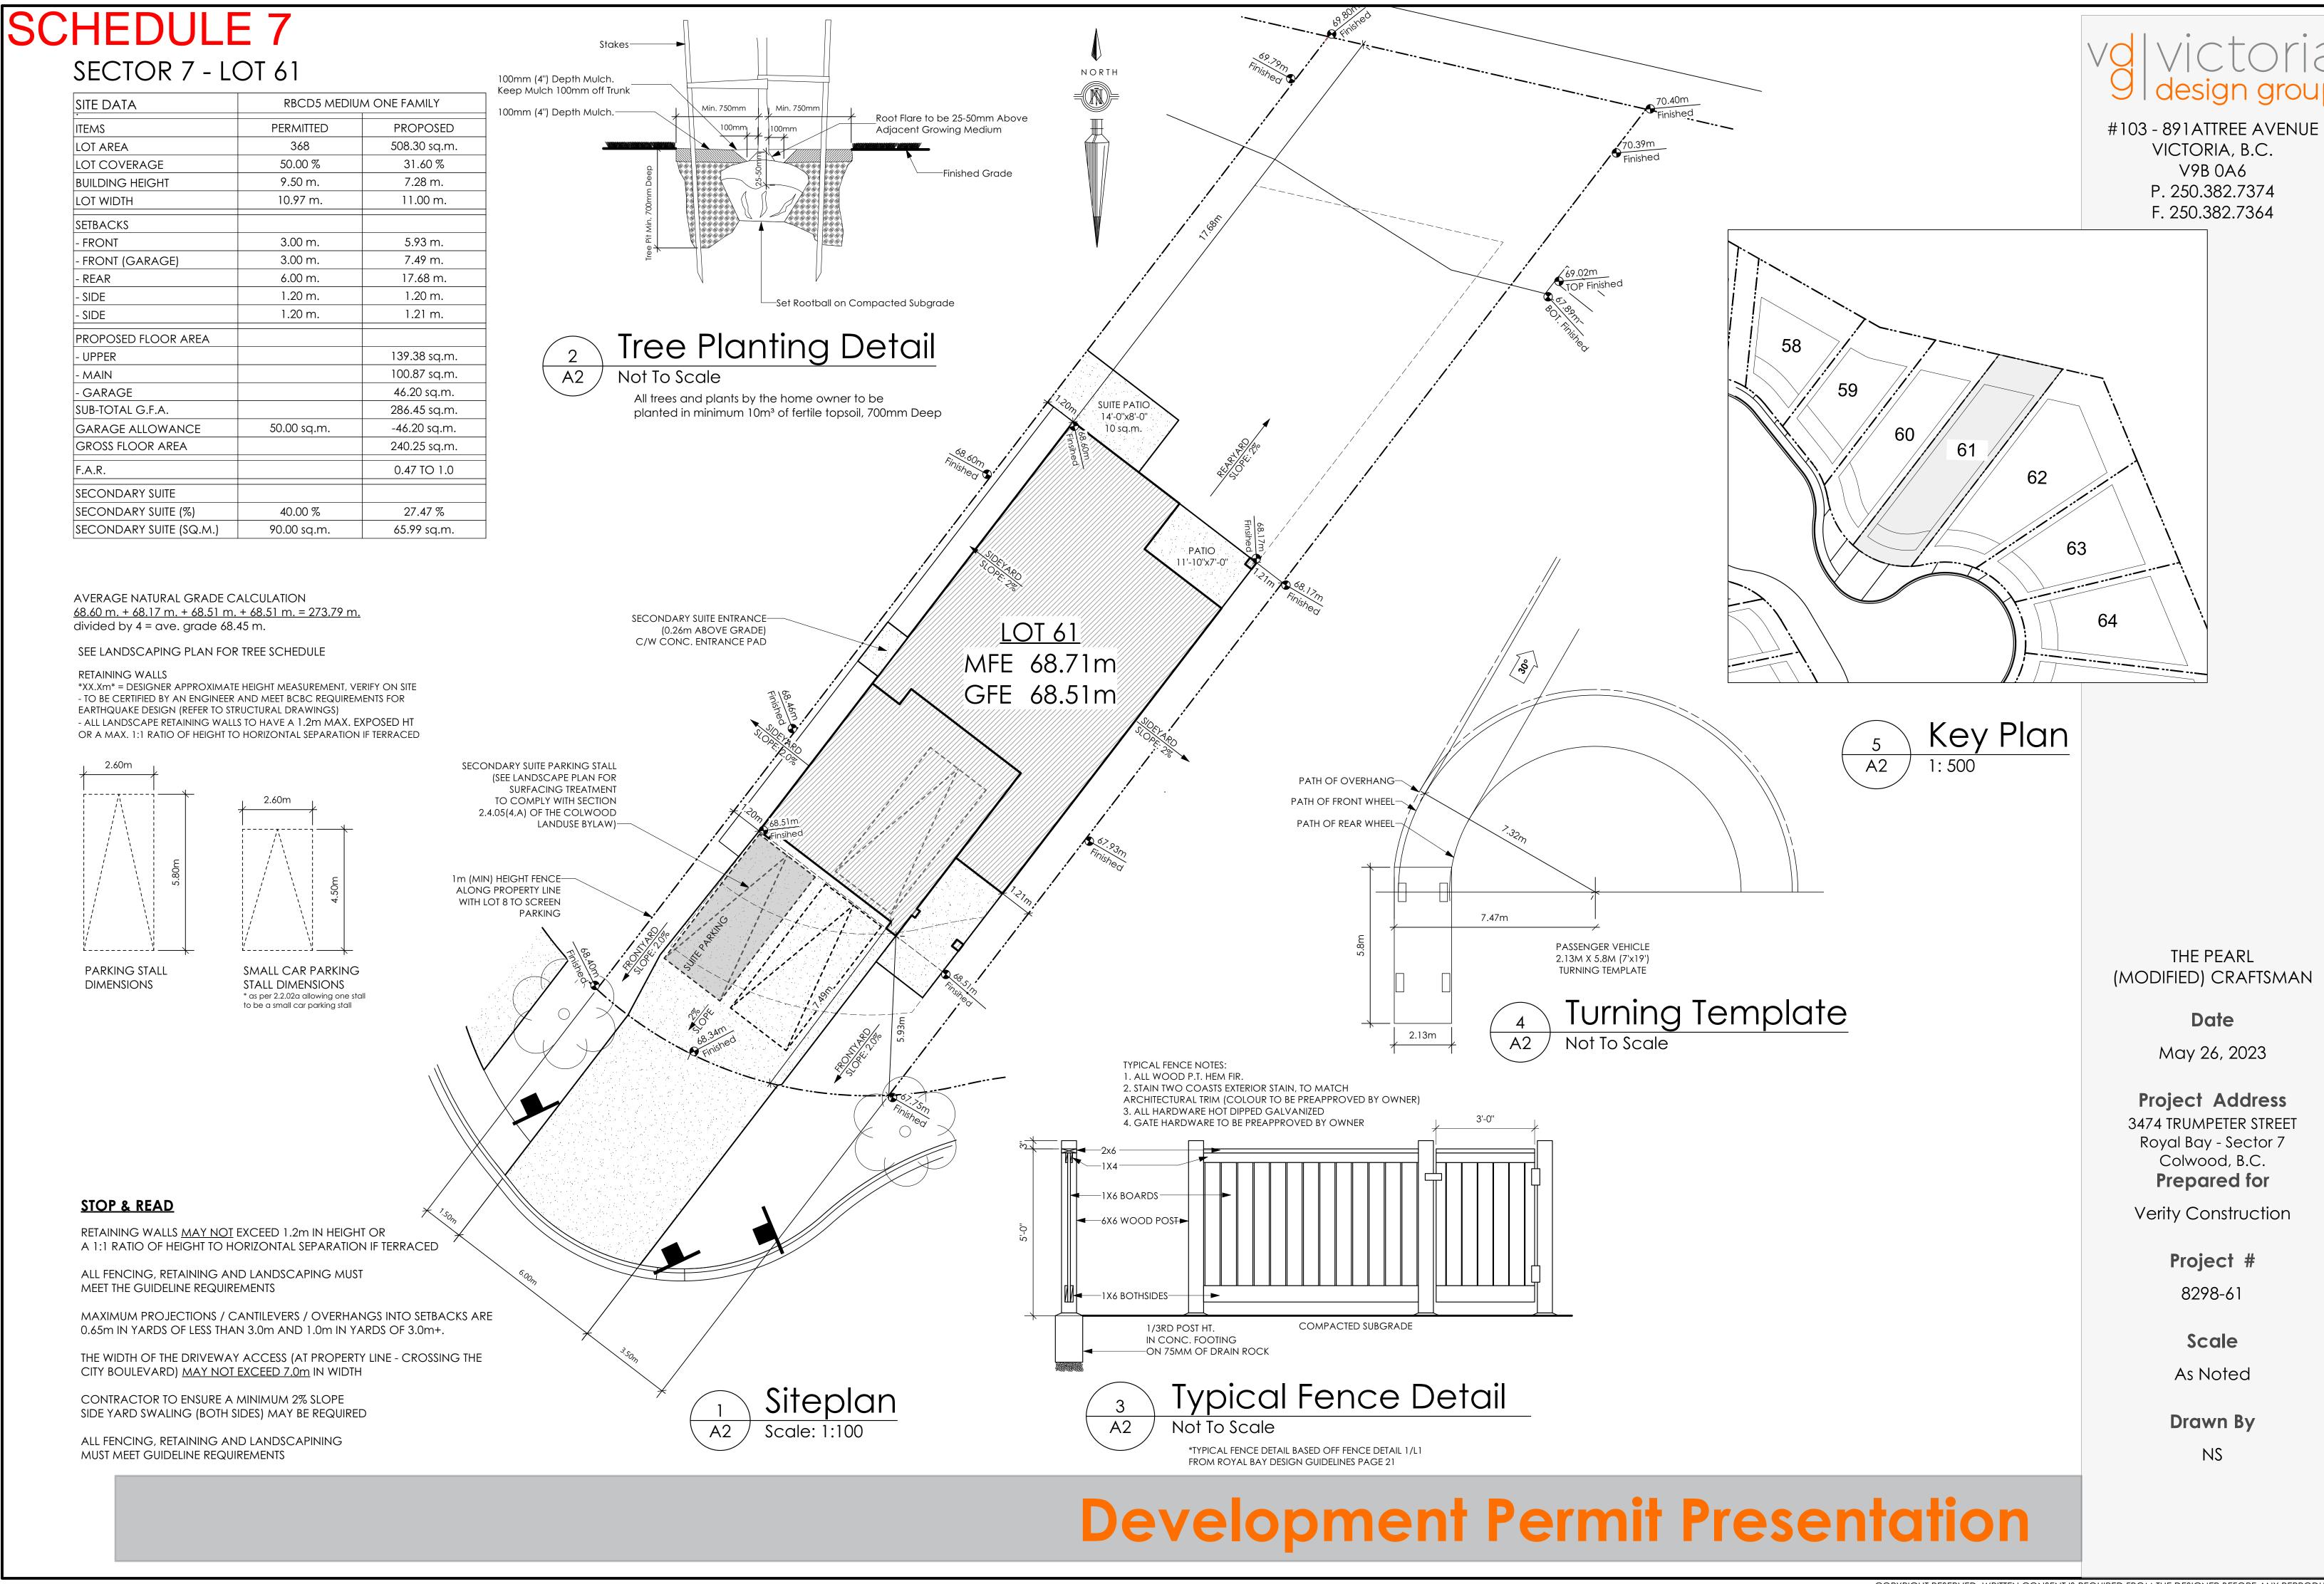

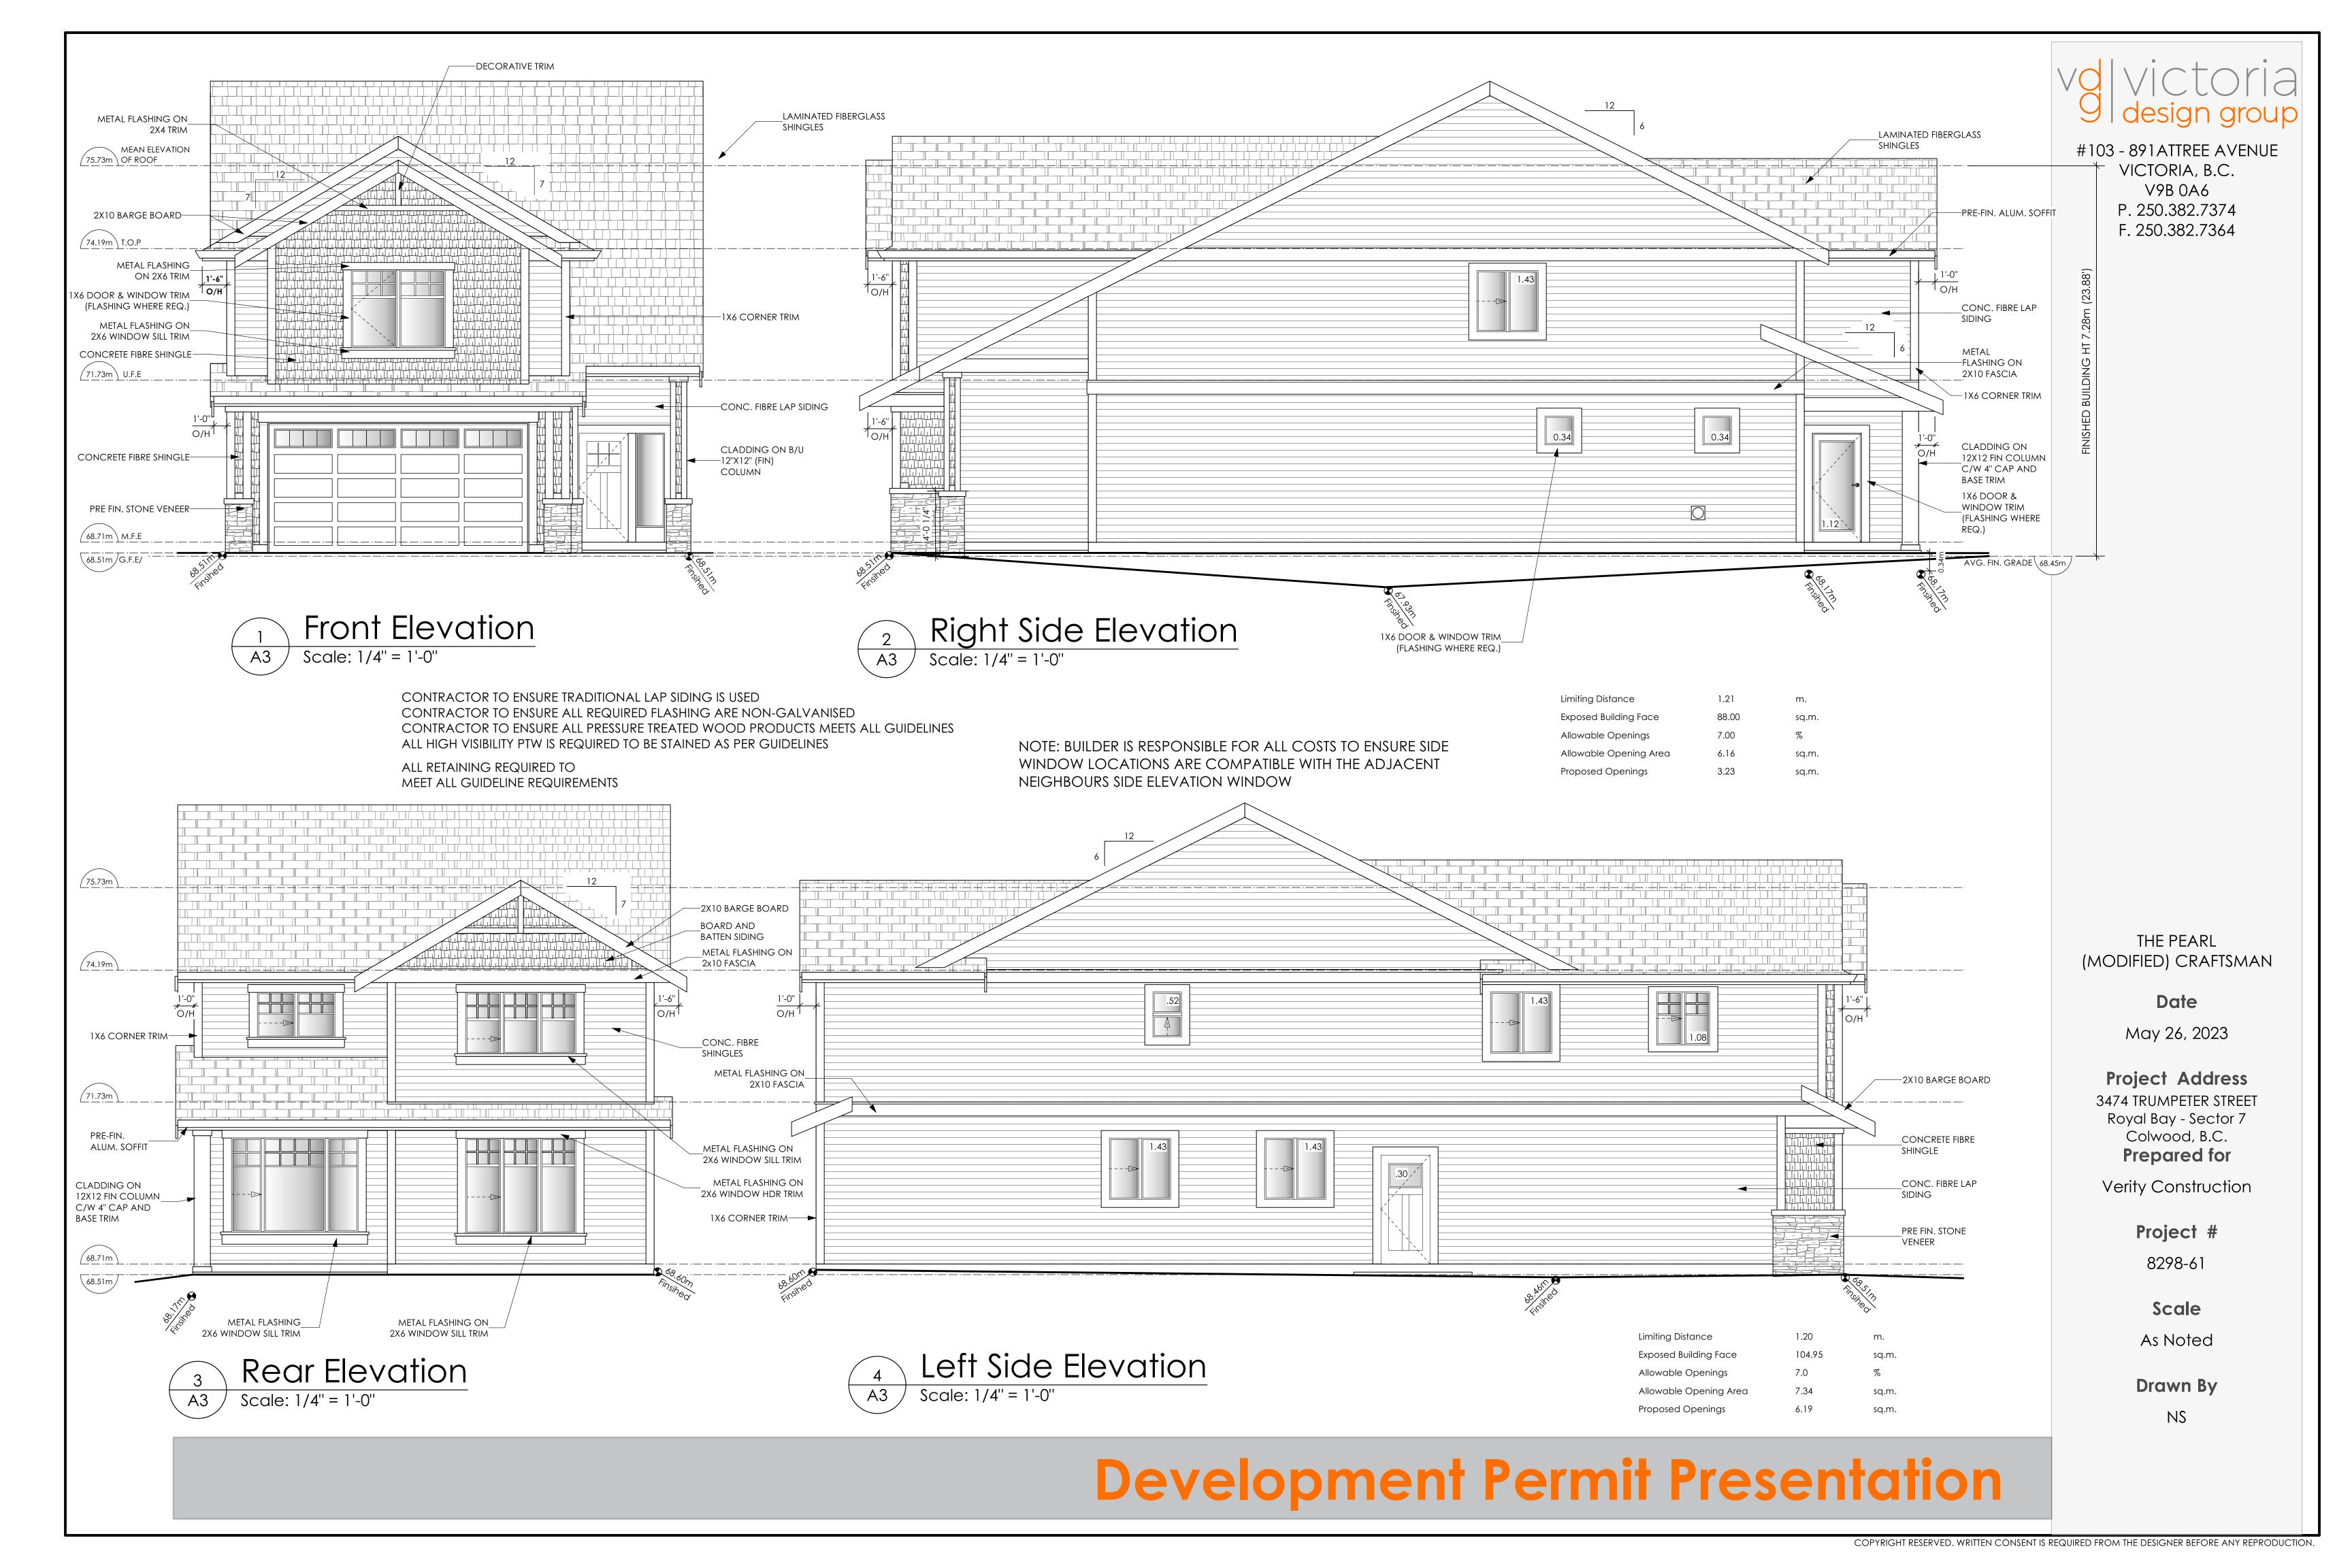

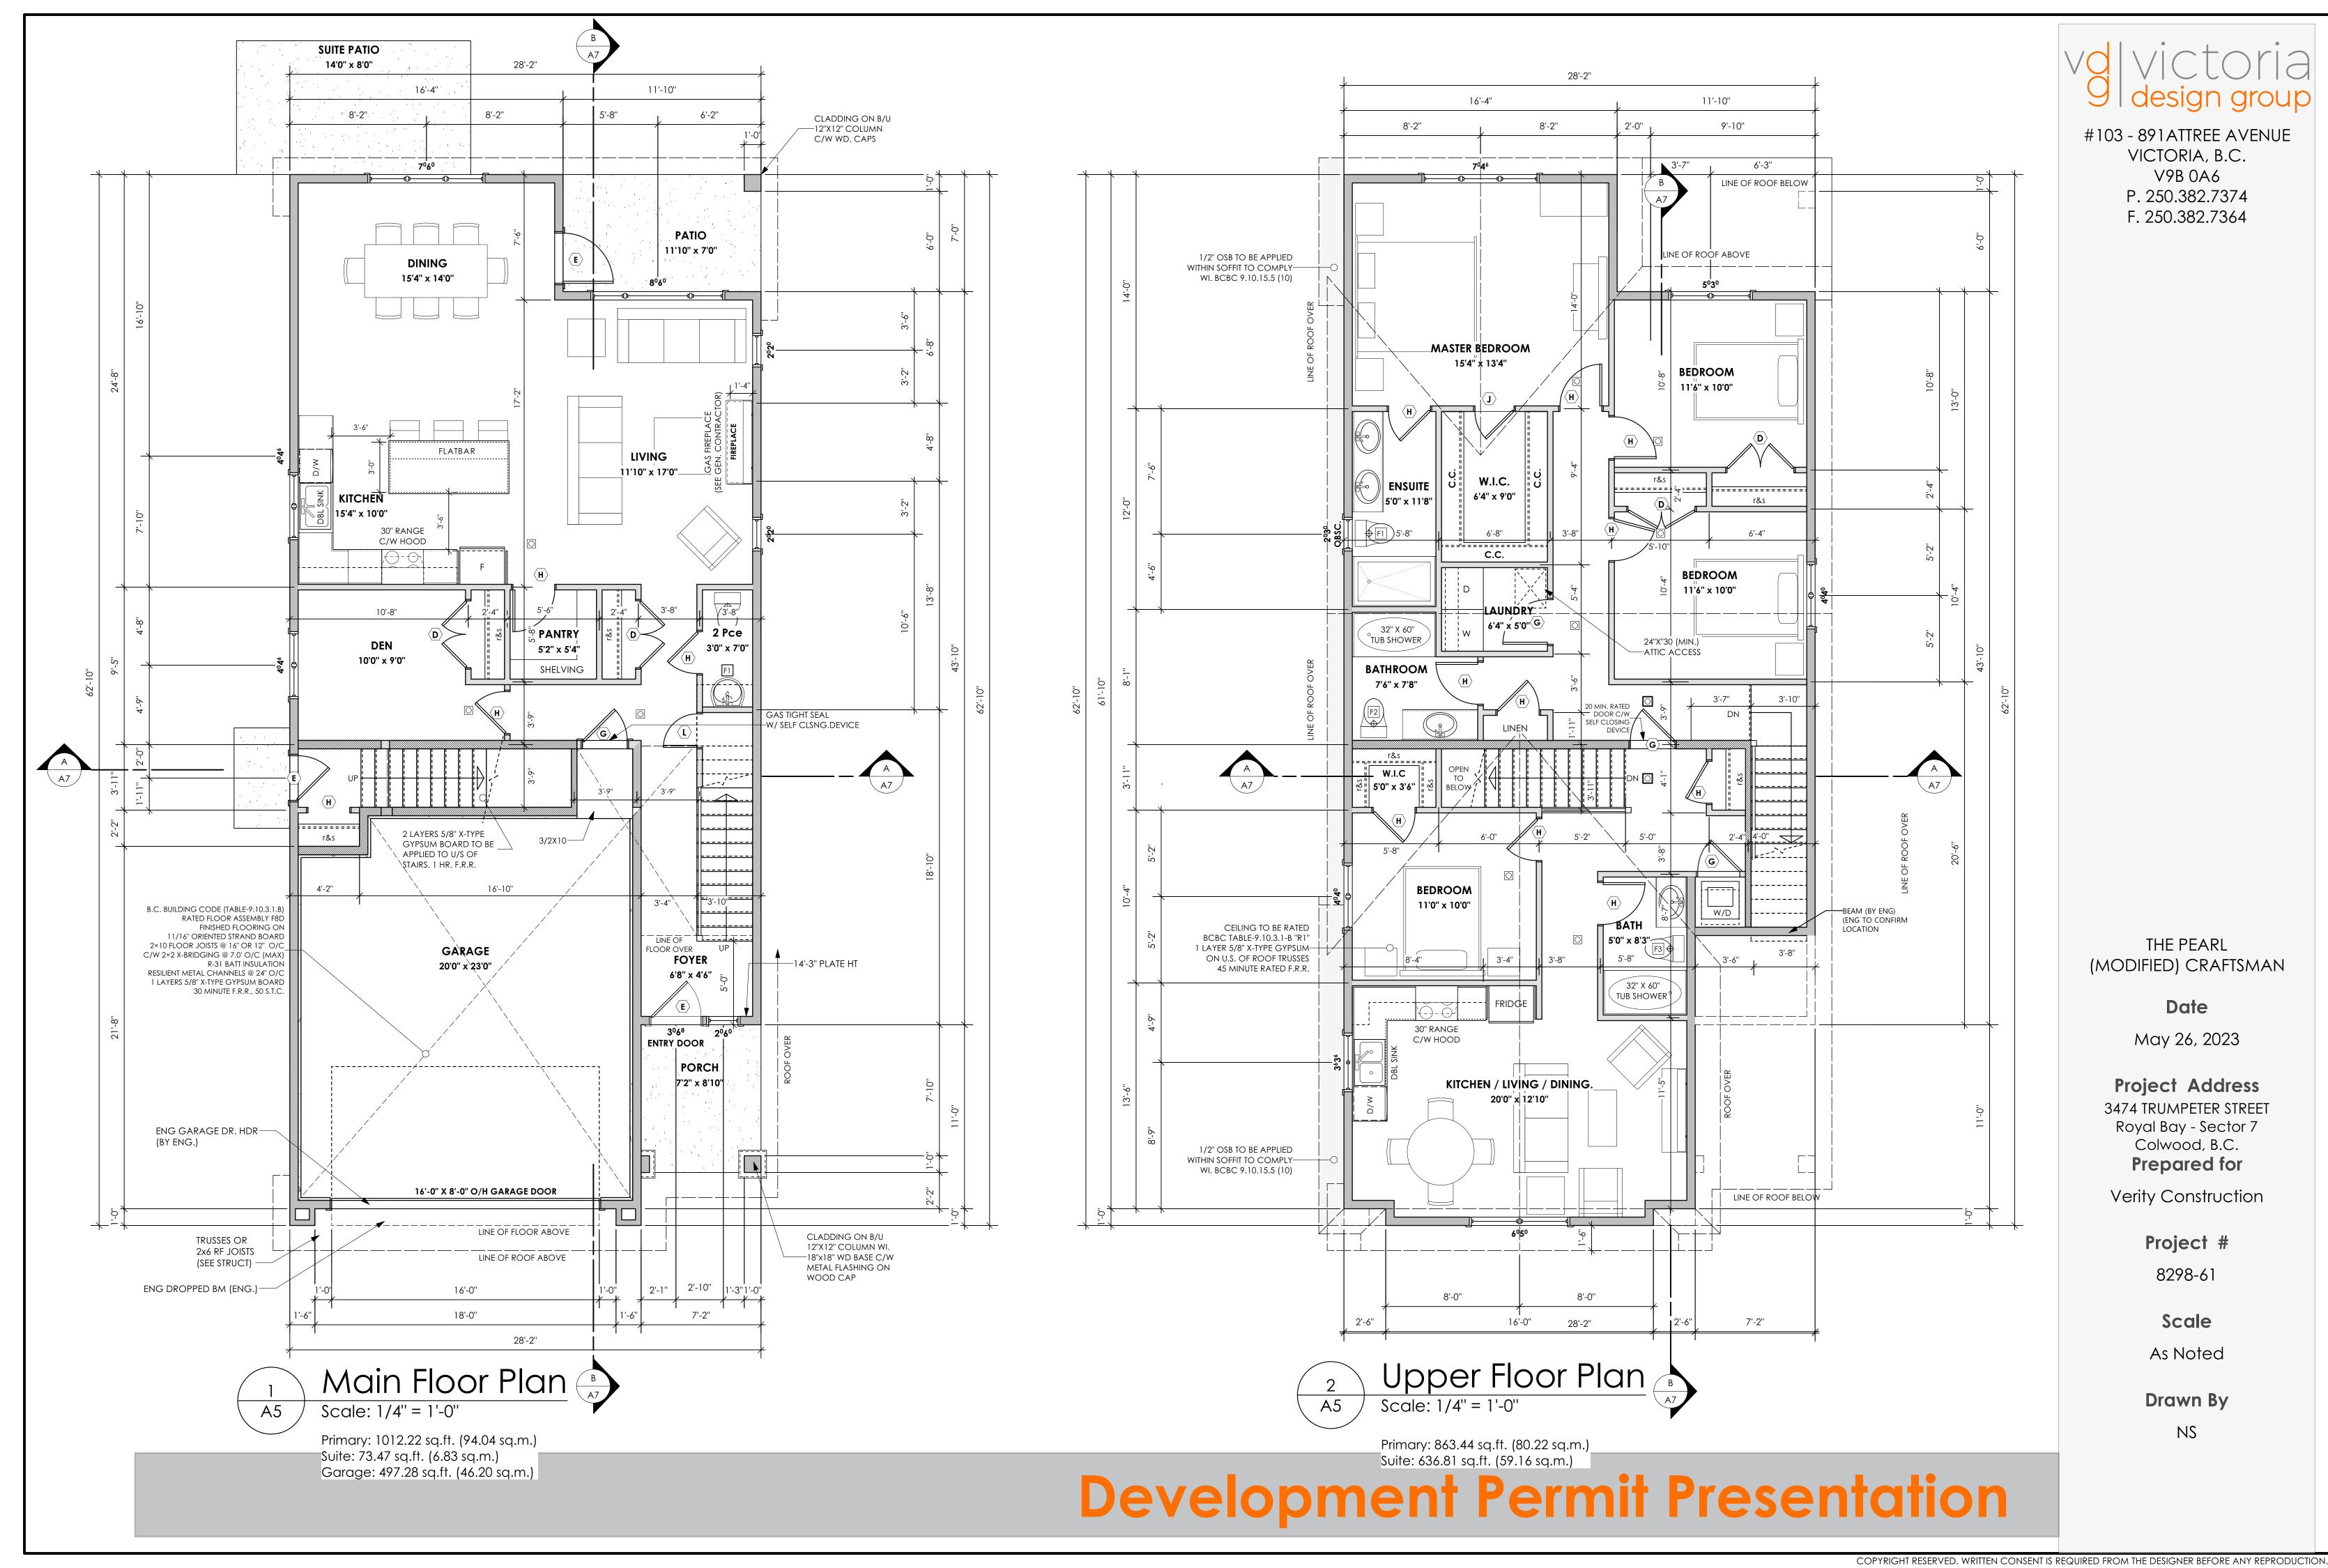

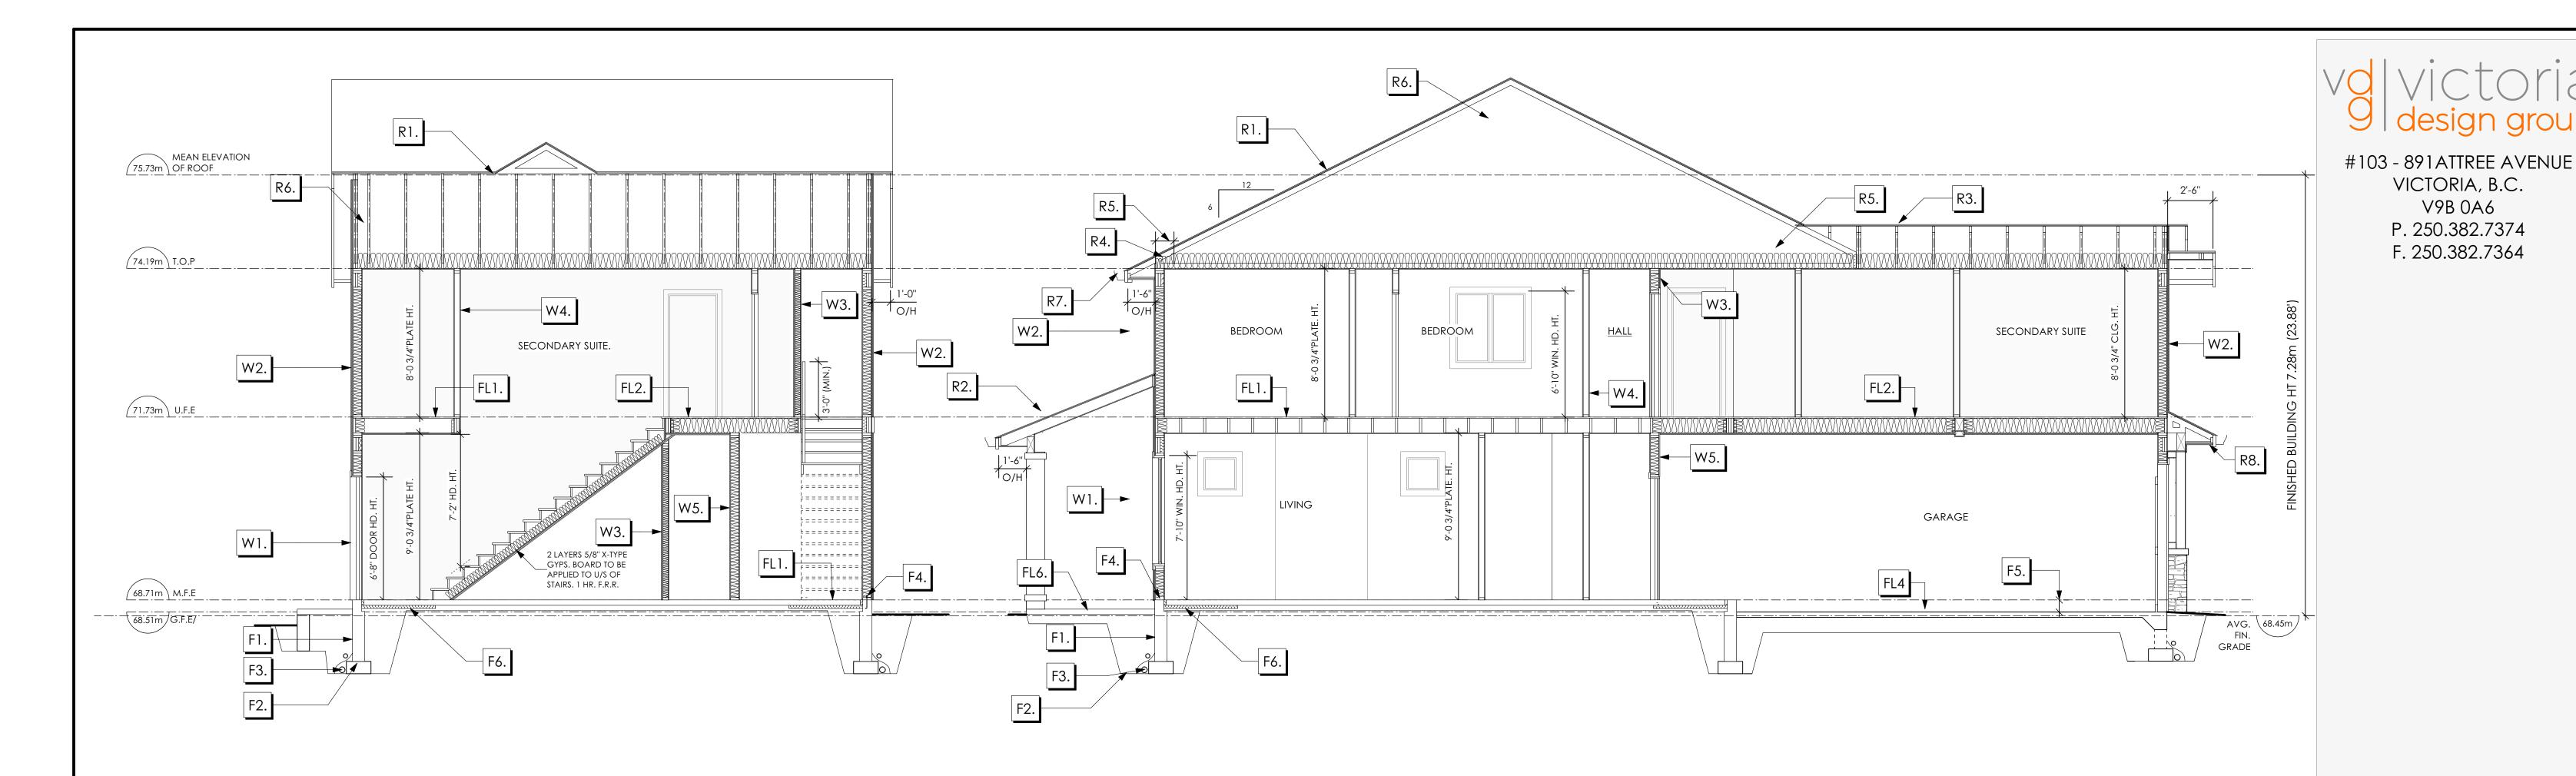

Section A-A Scale: 1/4" = 1'-0"

### ROOFS

- LAMINATED ASPHALT SHINGLES ON 7/16" ORIENTED STRAND BOARD C/W "H" CLIPS WD TRUSSES (DESIGNED BY MANUF.) R-40 FIBRE GLAS BATT INSULATION OR 14 1/2" FIBRE GLASS LOOSE FILL INSULATION 6 MIL POLY'N V.B. 5/8" GYPSUM BOARD
- LAMINATED ASPHALT SHINGLES ON 7/16" ORIENTED STRAND BOARD C/W "H" CLIPS 2x8 ROOF JOISTS @ 16" O/C VENTED SOFFIT
- R3. B.C. BUILDING CODE (TABLE-9.10.3.1.B) RATED ROOF ASSEMBLY LAMINATED ASPHALT SHINGLES ON 7/16" ORIENTED STRAND BOARD C/W "H" CLIPS FL3. FINISHED FLOORING ON WD TRUSSES (DESIGNED BY MANUF.) R-40 FIBRE GLAS BATT INSULATION OR 14 1/2" FIBRE GLASS LOOSE FILL INSULATION 6 MIL POLY'N V.B. 5/8" X-TYPE GYPSUM BOARD 45 MINUTE RATED F.R.R.
- R4. PROVIDE 2 1/2" (63MM) CLEAR BETWEEN R-20 INSULATION AND SHEATHING. (MIN. R-20 @ ROOF-WALL CONNECTION FOR 4'-0" (1.2M) AROUND PERIMETER OF BUILDING. FL4. 3 1/2" CONCRETE SLAB AIR VENTILATION BAFFLES TO BE INSTALLED WHERE REQUIRED IN AS PER BCBC 9.19.)
- R5. EAVE PROTECTION CONT. UP ROOF SLOPE FOR 12" PAST EXTERIOR WALL.
- R6. PROVIDE 1 SQ.FT. ATTIC VENT PER 300 SQ.FT. OF INSULATED AREA MIN. 25% OF REQUIRED TO BE @ TOP AND BOTTOM (TO COMPLY WI. B.C. BLDG. CODE 9.19.1)
- R7. PRE-FIN. FASCIA GUTTER 2×8 FASCIA BD. 2×4 SUB. FASCIA BD. VENTED SOFFIT (SEE CONTRACTOR)
- R8. PRE-FIN. FASCIA GUTTER 2×8 FASCIA BD. 2×4 SUB. FASCIA BD. 1/2" ORIENTED STRAND BOARD VENTED SOFFIT (SEE CONTRACTOR)

## **Section Notes**

### **FLOORS**

- FL1. 3 1/2" CONCRETE SLAB 6 MIL. POLY'N V.B. 6" COMPACTED GRAVEL OR SAND
- FL2. B.C. BUILDING CODE (TABLE-9.10.3.1.B) RATED FLOOR ASSEMBLY F8D FINISHED FLOORING ON 11/16" ORIENTED STRAND BOARD (FASTENED & GLUED TO FLOOR STRUCT. BELOW) ON 2×10 FLOOR JOISTS @ 16" OR 12" O/C C/W 2×2 X-BRIDGING @ 7.0' O/C (MAX) R-31 INSULATION RESILIENT METAL CHANNELS @ 24" O/C 1 LAYERS 5/8" X-TYPE GYPSUM BOARD 30 MINUTE F.R.R., 50 S.T.C.
- 11/16" ORIENTED STRAND BOARD (FASTENED & GLUED TO FLOOR STRUCT. BELOW) ON 2×10 FLOOR JOISTS @ 16" OR 12" O/C C/W 2×2 X-BRIDGING @ 7.0' O/C (MAX) PROVIDE R-31 F/G BATT INSULATION IN JOIST CAVITY C/W BUILDING WRAP VENTED SOFFIT (TO OWNERS SPEC'S) TO ALL SUSPENDED FLOOR AREAS
- 6 MIL. POLY'N V.B. 6" COMPACTED GRAVEL OR SAND SLOPE TO DOORS 1"

## Section B-B Scale: 1/4" = 1'-0"

#### WALLS

- W1. DOUBLE GLAZING ENERGY STAR LOW "E" RATING IN THERMAL BREAK FRAMES 2/2"X10" LINTEL OVER (@ bearing walls only) (TYPICAL, wi. 2 1/2" XPS insulation) FLASHING OVER @ EXTERIOR (glazing in all exterior doors & within 3 ft. of exterior doors to be shatterproof (SP)) WINDOW REQUIREMENTS DERIVED FROM CITY OF COLWOOD BUILDING BYLAW AND ARE TO BE USED TO SATISFY THE REQUIREMENTS OF AAMA/WDMA/CSA 101/I.S.2/A440, "NAFS": COLWOOD, CLASS R - PG30 (220) A3, RATINGS MUST BE CLEARLY LABELED ON ALL UNITS UPON INSTALLATION FOR INSPECTION.
- W2. CONC. FIBRE BOARD ON 9.5MM (3/8") AIR SPACE / STRAPPING 3/8"×2" BORATE TREATED PLYWOOD STRAPPING HOUSE WRAP (A.B.) (TYVEK OR EQ.) 7/16" ORIENTED STRAND BOARD SHEATHING 2×6 STUDS @ 16" O/C R-20 INSULATION 6 MIL. POLYETHYLENE VAPOUR BARRIER 1/2" GYPSUM BOARD
- W3. B.C. BUILDING CODE (TABLE 9.10.3.1.A) RATED WALL ASSEMBLY W3c 1 LAYER 1/2" X-TYPE GYPSUM BOARD RESILIENT METAL CHANNELS @ 24" O/C 2×4 STUDS @ 16" O/C OR 2×6 STUDS @ 16" O/C (IF NOTED) C/W 3 1/2" FIBRE GLASS SOUND BATTS 1 LAYER 1/2" X-TYPE GYPSUM BOARD 45 MIN. F.R.R 43 S.T.C (BETWEEN PRIMARY LIVING & SECONDARY SUITE)

#### W4. INTERIOR PARTITION 1/2" GYPSUM BOARD ON EACH SIDE OF 2×4 STUDS @ 16" O/C OR

- 2×6 STUDS @ 16" O/C (IF NOTED) W5. 5/8" X-TYPE GYPSUM BOARD ON 2×6 STUDS @ 16" O/C C/W R-20 INSULATION 6 MIL. POLY'N V.B 1/2" GYPSUM BOARD (BETWEEN GARAGE & LIVING)
- W6. 1/2" GYPSUM BOARD ON 6 MIL. POLY'N V.B. 2×4 STUDS @ 24" O/C C/W R-12 BATT INSULATION BUILDING WRAP OR 12.7MM (1/2") AIR SPACE (PROVIDE REQUIRED FIRE STOPS IN WALL ASSEMBLIES TO COMPLY WITH B.C. BLDG. CODE 9.10.16.)

#### FOUNDATION

- F1. DAMP PROOFING (WHERE REQUIRED) ON 8" THK. CONC. FOUNDATION WALL C/W 15 M BARS @ 24" O/C B/W
- F2. 16"X 8" CONC. FOOTINGS C/W 2 (TWO) 15M BARS CONT. 3 IN. FROM BOTT. ON UNDISTURBED SOIL (SOLID BEARING)
- F3. 4" PERIMETER DRAIN 3" TIGHT PIPE FOR RWL DRAIN ROCK
- F4. ANCHOR BOLTS @ 4.0 FT. O/C MAX C/W SILL GASKETS
- F5. STEP DOWN TO GARAGE SLAB MAY VARY, VERIFY EXTENT ON SITE
- F6. UNDER SLAB INSULATION 2 1/2" (RSI 2.15) EXTRUDED POLYSTYRENE RIGID INSULATION 4'-0" (1.2M) CONT. AROUND PERIMETER UNDER SLAB INSTALLED HORIZONTALLY (VERIFY WITH MUNICIPALITY DEPTH OF FROST LINE)

THE PEARL (MODIFIED) CRAFTSMAN

Date

May 26, 2023

**Project Address** 3474 TRUMPETER STREET Royal Bay - Sector 7 Colwood, B.C. Prepared for

Verity Construction


Project #

8298-61

Scale

As Noted

Drawn By NS

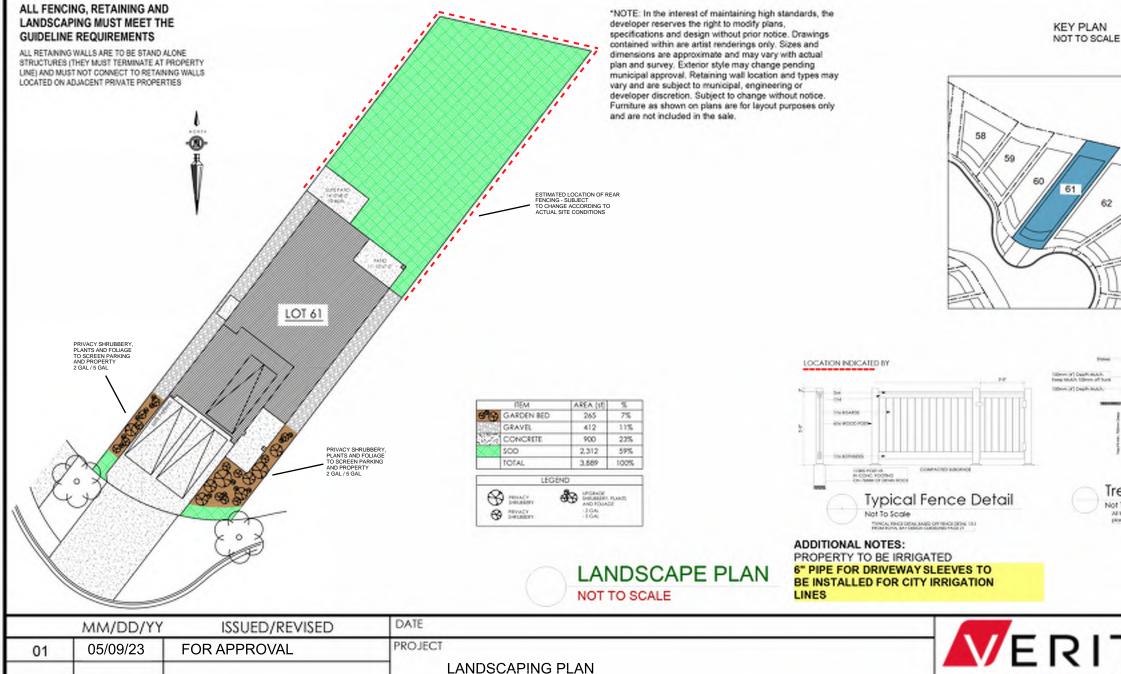

LOT 61, 3474 TRUMPETER ST.

ROYAL BAY, SECTOR 7 CITY OF COLWOOD

| TED        |                                    |               |
|------------|------------------------------------|---------------|
| LEEVES TO  |                                    |               |
| IRRIGATION |                                    |               |
|            |                                    |               |
| $\Delta$   | ERI                                | ΤY            |
|            | CONSTRU                            | CTION         |
|            | ONSTRUCTION, TRUS                  | STED SERVICE. |
|            | 9 Langford Parkway<br>S.C. V9B 0A6 | www.ve        |

63

Roof figure to be 25-80mm Albore Adjusted Dowing Medium

P: 250.474.1039

www.verityconstruction.ca


Tree Planting Detail

All hees and plants by the home-sweet to be

| WSP | Project | No: | 201-08151-00 |
|-----|---------|-----|--------------|
|     | ,       |     |              |

C. Hume - June 6/23

| GABLECTART HOMES BILLIDING   | WSP Project No: 201-08151-00  |
|--|---|
| BUILDING   | GRADE SLIP Issue Date:  |
| MUNICIPAL<br>ADDRESS   | P.I.D.  |
| LOT 61   | PLAN  |
| BUILDER VERITY HOMES   | SUBDIVISION ROYAL BAY SECTOR 7  |
| ADDRESS  | DEVELOPER  MEADOWS DEVELOPMENT LP   |
| REPRESENTATIVE PH.   | CONSULTANT  WSP CANADA INC  |
| PROPOSED BUILDING GRADES   | PLAN  |
| ALL ELEVATIONS ARE METRIC GEODETIC +   | LOT: 61 PLAN:   |
| MAIN FLOOR ELEVATION 68.71   |   |
| FRONT ELEV_ 68.51 (FINISHED GRADE) REAR ELEV_ 68.60/68.17 DEP  |   |
| FINISHED GRADE AT GARAGE 68.51   |   |
| HEADROOM   |   |
| HEAL   |   |
| ACTUAL TOP OF FOOTING  | 61<br>10<br>10<br>10<br>10<br>10<br>10<br>10<br>10<br>10<br>1   |
| LOWEST PERMITTED TOP OF not provided FLOOR | S   S   S   S   S   S   S   S   S   S   |
| (BOTTOM OF BASEMENT SLAB FROST WALLS ARE REQUIRED.)  | MSE 64.93<br>S 64.39  |
| SERVICES FRONT REAR CENTER REFER SIZE<br>TO PLAN (mm)  | (2) (3) (4) (4) (4) (4) (4) (4) (4) (4) (4) (4  |
| WATER   19   |   |
| SANITARY   |   |
| STORM 100  |   |
| COMMENTS YES NO  | 68.34   |
| DRAIN TO SUMP PUMP LIKELY REQUIRED (FOR BASEMENT IF INSTALLED)   | TRUMPETER ST.   |
| SEWER TO SUMP PUMP LIKELY REQUIRED   | <u>LEGEND</u><br>Street   |
| (FOR BASEMENT IF INSTALLED)  | A A T   |
| FOUNDATION SOIL BEARING INVESTIGATION CERTIFICATION REQUIRED   |   |
| GEOTECHNICAL RESTRICTIONS APPLY  | (က) SROW (က) ` ` ´  |
| (SEE GEOTECHNICAL REPORT)  | PROPOSED FRONT CORNER ELEVATIONS  PROPOSED FRONT SIDE YARD GRADES  L# 6  L# 6  L# 6   |
| (SEE ENVIRONMENTAL REPORT)   | (5) EG 49.90 (7) - EXISTING GROUND ELEVATION  |
| UTILITY EASEMENTS AFFECT THIS LOT  | LFE/MFE 47.70 - LOWER/MAIN FLOOR ELEVATION GFE 47.55 - GARAGE FLOOR ELEVATION   |
|  | MSE 52.20 — MINIMUM SANITARY SERVICABLE ELEVATION BY GRAVITY  |
|  | S 49.12 (P)  D 49.12 (P)  SAN SERVICE INV.  (P) DENOTES PUMP IS LIKELY REQUIRED FOR BASEMENT IF INSTALLED   |
|  | STORM SERVICE INV.  (P) DENOTES PUMP IS LIKELY REQUIRED   |
|  | FOR BASEMENT IF INSTALLED  PROPOSED REAR SIDE YARD GRADES   |
| NOTES  | L V W P P P P P P P P P P P P P P P P P P   |
| NOTES  1. IT IS THE RESPONSIBILITY OF THE BUILDER TO ENSURE THE FOOTINGS   | LANE/LOT - PROPOSED REAR CORNER ELEVATIONS  |
| ARE PLACED ON A PROPER BASE THAT IS FREE FROM FROST, EXCESSIVE MOISTURE AND DELETERIOUS MATERIALS AND HAVE APPROPRIATE FROST PROTECTION WHEN COMPLETED.  |   |
| <ol> <li>THE INFORMATION CONTAINED HEREIN IS BASED ON THE APPROVED<br/>LOT GRADING PLAN FOR THIS SUBDIVISION. UN—AUTHORIZED<br/>DEVIATIONS WILL BE THE RESPONSIBILITY OF THE BUILDER TO</li> </ol>   |   |
| ENSURE COMPLIANCE WITH ALL LOCAL BYLAWS.   | I, THE BUILDER'S REPRESENTATIVE, CERTIFY THAT THE FINAL HOUSE PLANS PROVIDED IN THE BUILDING PERMIT APPLICATION ARE THE SAME AS PROCESSED UNDER THIS GRADE SLIP AND |
| 3. OTHER NOTES:  | THAT I UNDERSTAND THE INFORMATION AND THE REQUIREMENTS CONTAINED HEREIN AND WILL BUILD ACCORDINGLY.   |
|  | AUTHORIZED BUILDER'S REPRESENTATIVE DATE  |
|  | THE INFORMATION CONTAINED HEREIN IS BASED ON THE APPROVED LOT GRADING PLAN FOR THIS SUBDIVISION, DATED  |

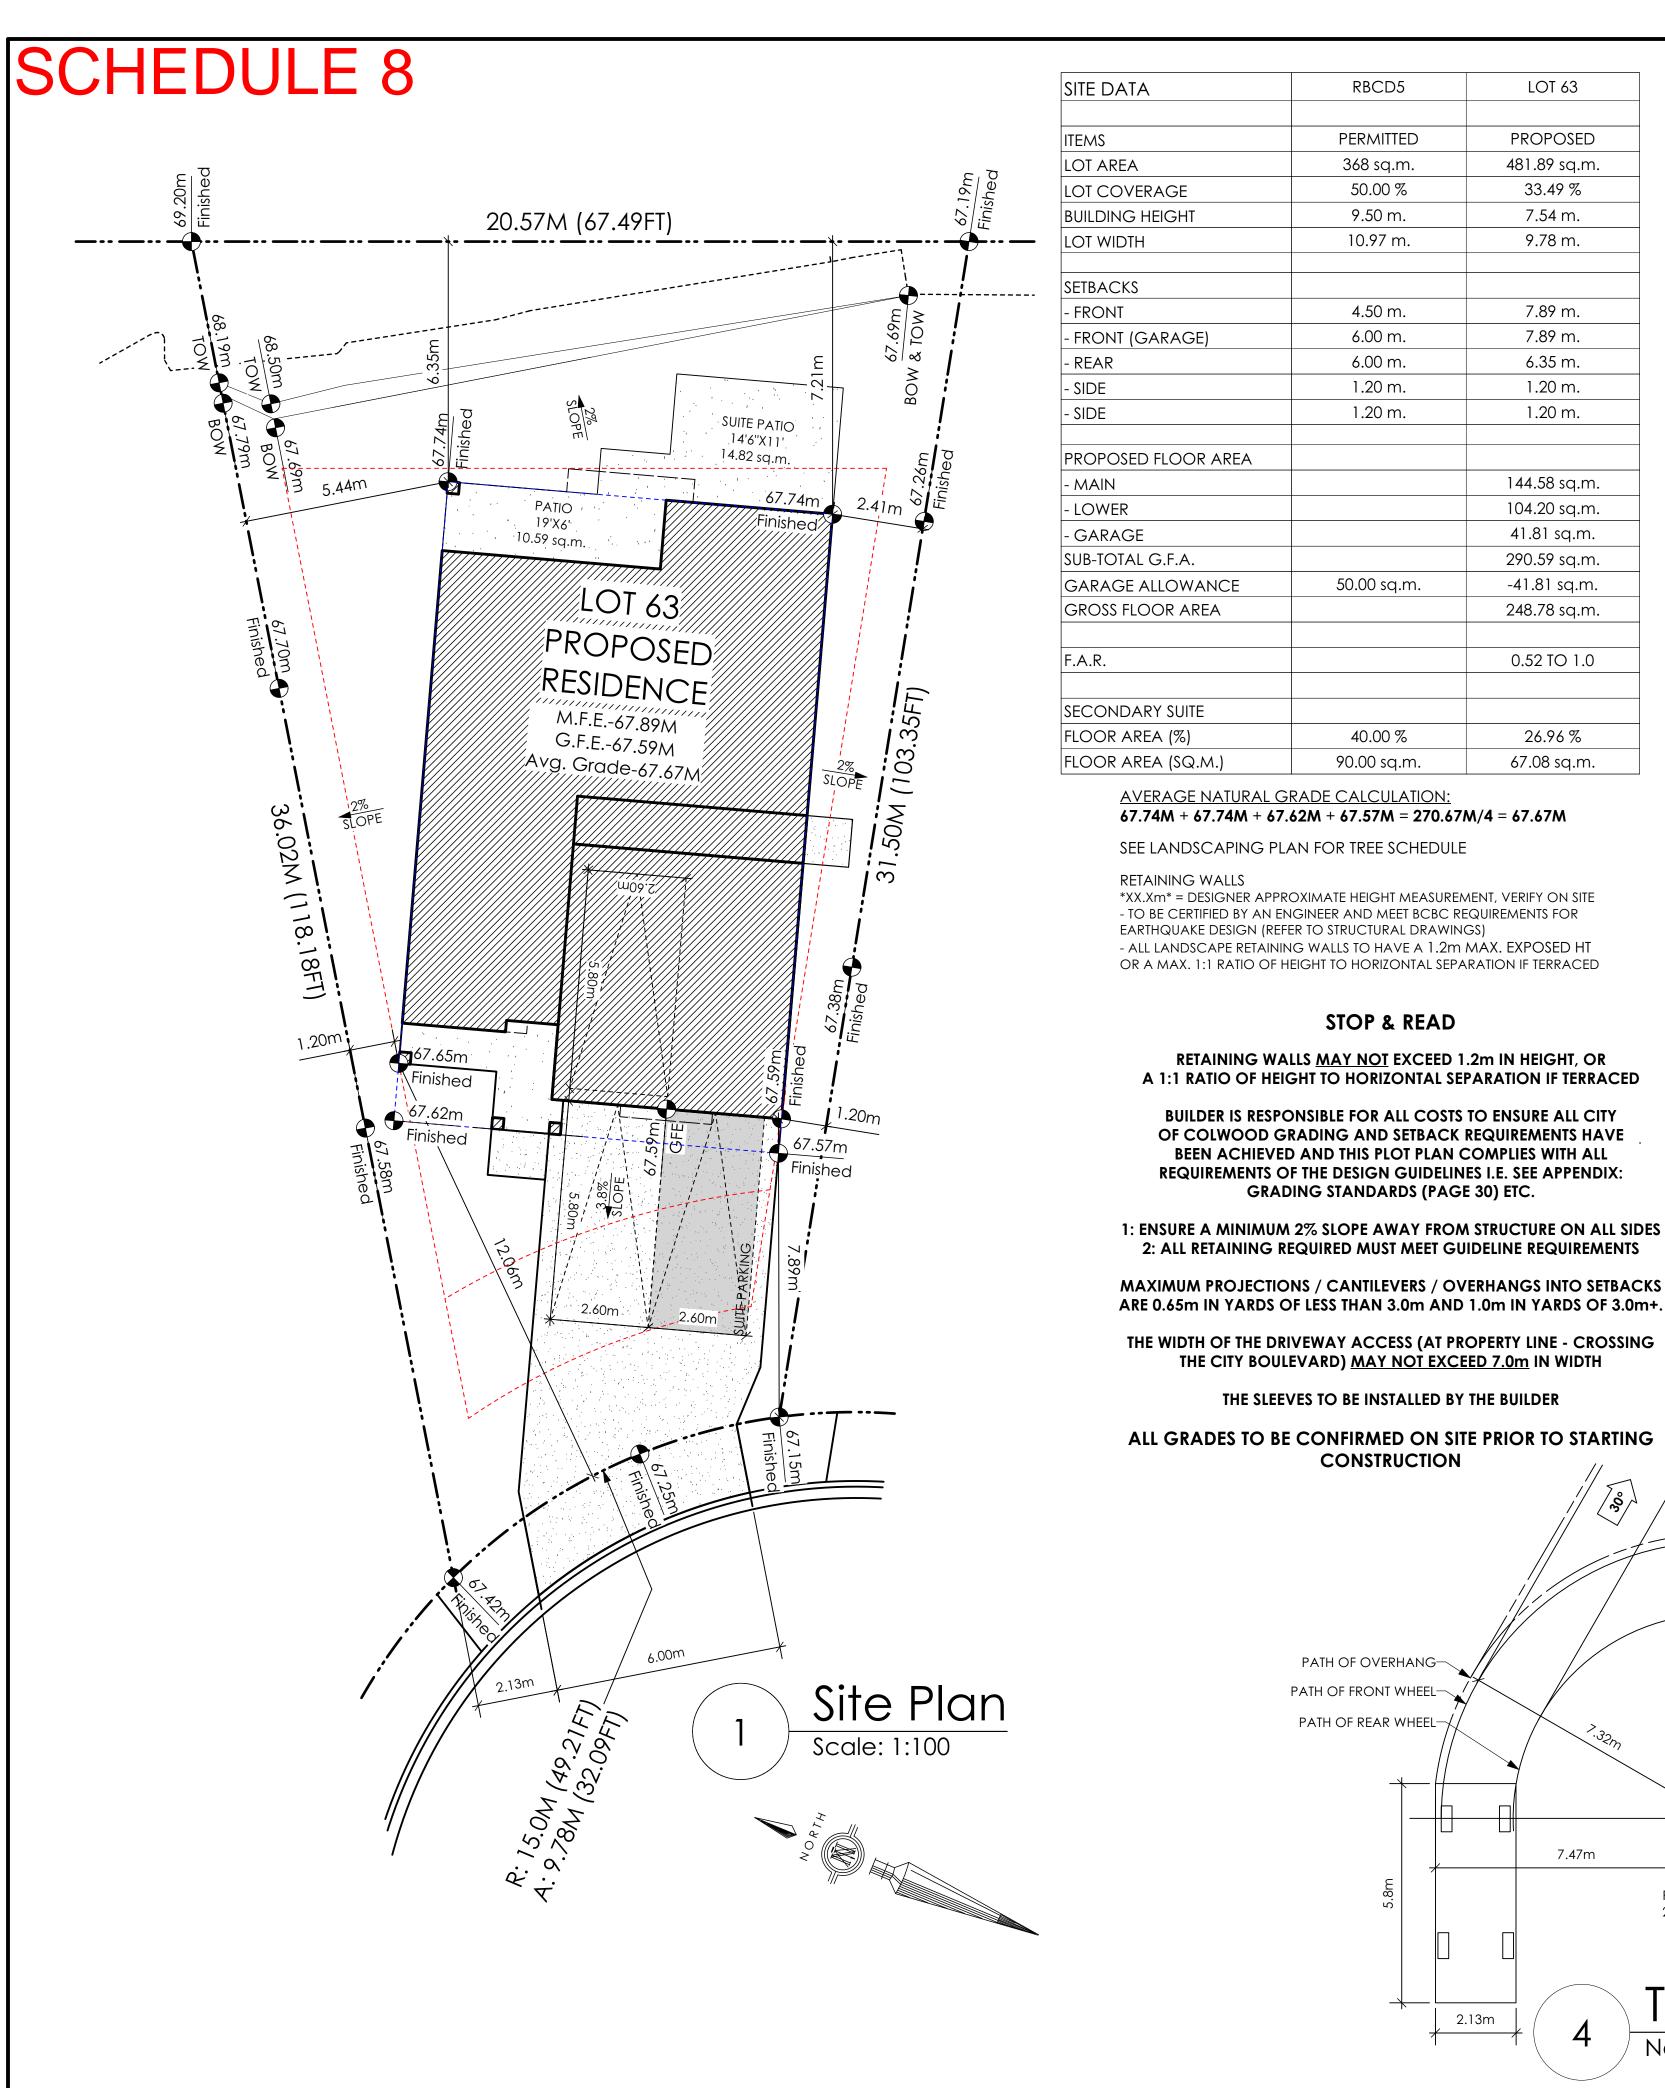

| SITE DATA           | RBCD5       | LOT 63       |
|---------------------|-------------|--------------|
|                     |             |              |
| ITEMS               | PERMITTED   | PROPOSED     |
| LOT AREA            | 368 sq.m.   | 481.89 sq.m. |
| LOT COVERAGE        | 50.00 %     | 33.49 %      |
| BUILDING HEIGHT     | 9.50 m.     | 7.54 m.      |
| LOT WIDTH           | 10.97 m.    | 9.78 m.      |
| SETBACKS            |             |              |
| - FRONT             | 4.50 m.     | 7.89 m.      |
| - FRONT (GARAGE)    | 6.00 m.     | 7.89 m.      |
| - REAR              | 6.00 m.     | 6.35 m.      |
| - SIDE              | 1.20 m.     | 1.20 m.      |
| - SIDE              | 1.20 m.     | 1.20 m.      |
| PROPOSED FLOOR AREA |             |              |
| - MAIN              |             | 144.58 sq.m. |
| - LOWER             |             | 104.20 sq.m. |
| - GARAGE            |             | 41.81 sq.m.  |
| SUB-TOTAL G.F.A.    |             | 290.59 sq.m. |
| GARAGE ALLOWANCE    | 50.00 sq.m. | -41.81 sq.m. |
| GROSS FLOOR AREA    |             | 248.78 sq.m. |
| F.A.R.              |             | 0.52 TO 1.0  |
| SECONDARY SUITE     |             |              |
| FLOOR AREA (%)      | 40.00 %     | 26.96 %      |
| FLOOR AREA (SQ.M.)  | 90.00 sq.m. | 67.08 sq.m.  |

**AVERAGE NATURAL GRADE CALCULATION:** 67.74M + 67.74M + 67.62M + 67.57M = 270.67M/4 = 67.67M

SEE LANDSCAPING PLAN FOR TREE SCHEDULE

RETAINING WALLS \*XX.Xm\* = DESIGNER APPROXIMATE HEIGHT MEASUREMENT, VERIFY ON SITE - TO BE CERTIFIED BY AN ENGINEER AND MEET BCBC REQUIREMENTS FOR EARTHQUAKE DESIGN (REFER TO STRUCTURAL DRAWINGS) - ALL LANDSCAPE RETAINING WALLS TO HAVE A 1.2m MAX. EXPOSED HT OR A MAX. 1:1 RATIO OF HEIGHT TO HORIZONTAL SEPARATION IF TERRACED

#### STOP & READ

RETAINING WALLS <u>MAY NOT</u> EXCEED 1.2m IN HEIGHT, OR A 1:1 RATIO OF HEIGHT TO HORIZONTAL SEPARATION IF TERRACED

BUILDER IS RESPONSIBLE FOR ALL COSTS TO ENSURE ALL CITY OF COLWOOD GRADING AND SETBACK REQUIREMENTS HAVE BEEN ACHIEVED AND THIS PLOT PLAN COMPLIES WITH ALL **REQUIREMENTS OF THE DESIGN GUIDELINES I.E. SEE APPENDIX:** 


1: ENSURE A MINIMUM 2% SLOPE AWAY FROM STRUCTURE ON ALL SIDES 2: ALL RETAINING REQUIRED MUST MEET GUIDELINE REQUIREMENTS

ARE 0.65m IN YARDS OF LESS THAN 3.0m AND 1.0m IN YARDS OF 3.0m+.

THE WIDTH OF THE DRIVEWAY ACCESS (AT PROPERTY LINE - CROSSING THE CITY BOULEVARD) MAY NOT EXCEED 7.0m IN WIDTH


#### THE SLEEVES TO BE INSTALLED BY THE BUILDER


ALL GRADES TO BE CONFIRMED ON SITE PRIOR TO STARTING

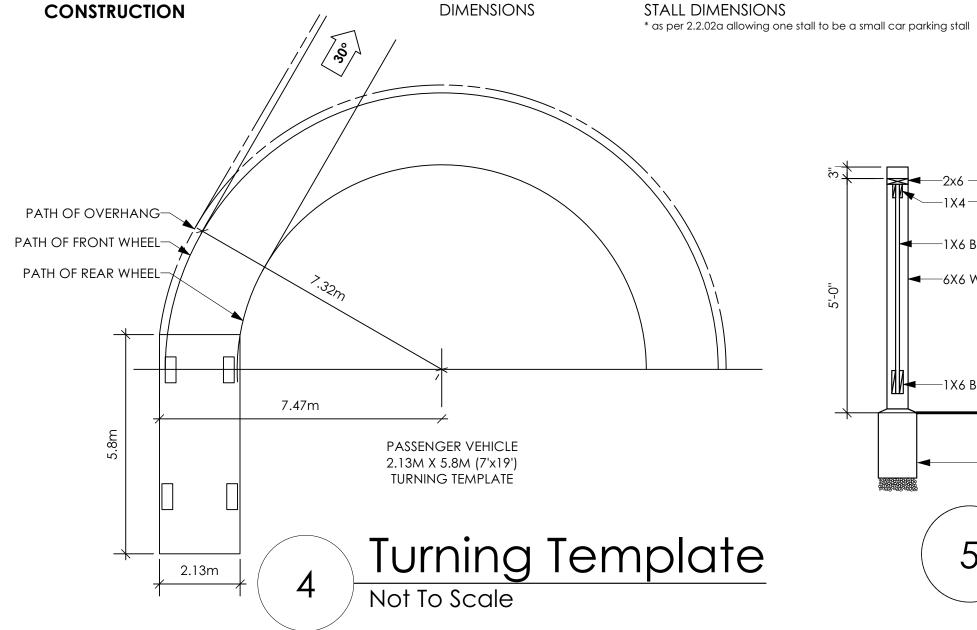

PARKING STALL

SMALL CAR PARKING

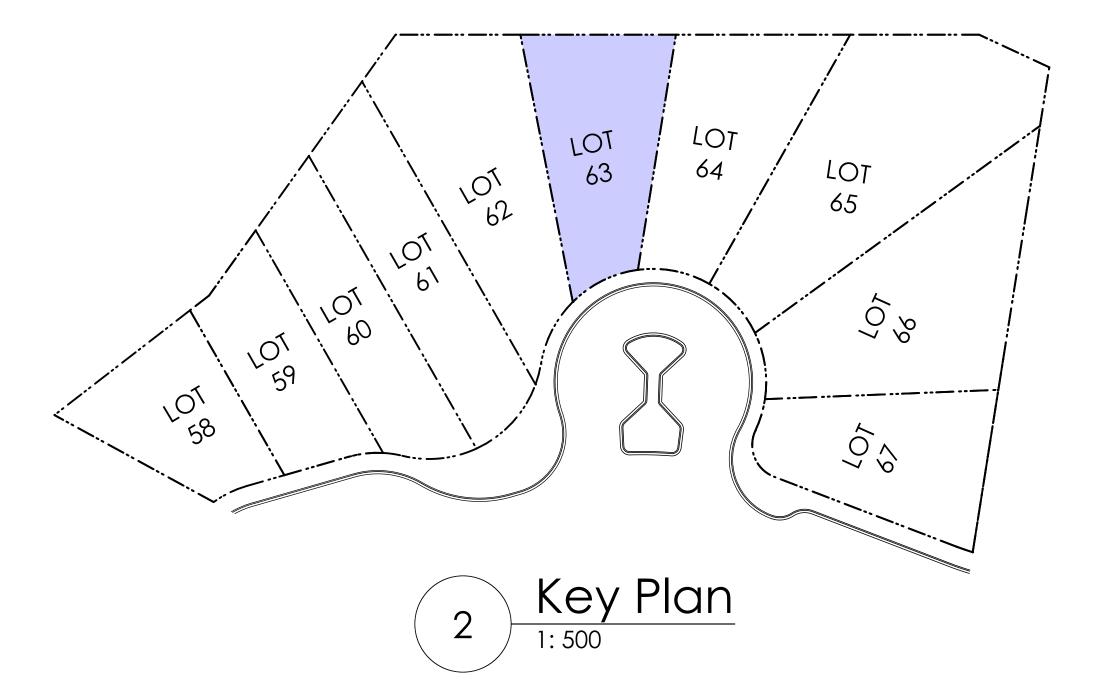

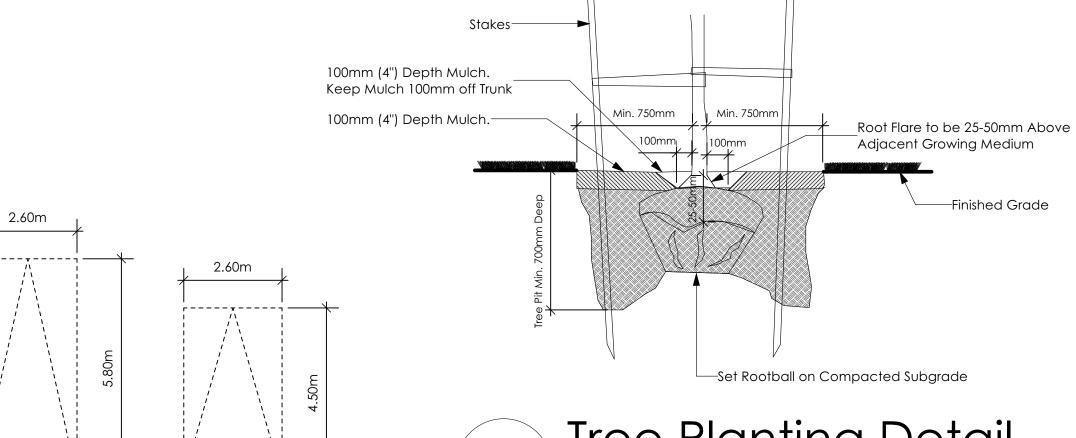

Tree Planting Detail

2. STAIN TWO COASTS EXTERIOR STAIN, TO MATCH

1. ALL WOOD P.T. HEM FIR.

All trees and plants by the home owner to be planted in minimum 10m³ of fertile topsoil, 700mm Deep TYPICAL FENCE NOTES:

ARCHITECTURAL TRIM (COLOUR TO BE PREAPPROVED BY OWNER) 3. ALL HARDWARE HOT DIPPED GALVANIZED 4. GATE HARDWARE TO BE PREAPPROVED BY OWNER -1X6 BOARDS-6X6 WOOD POST► —1X6 BOTHSIDES— COMPACTED SUBGRADE 1/3RD POST HT. IN CONC. FOOTING ON 75MM OF DRAIN ROCK

> Typical Fence Detail Not To Scale

\*TYPICAL FENCE DETAIL BASED OFF FENCE DETAIL 1/L1 FROM ROYAL BAY DESIGN GUIDELINES PAGE 21

#103 - 891ATTREE AVENUE VICTORIA, B.C. V9B 0A6 P. 250.382.7374 F. 250.382.7364

'FLEMMING' CRAFTSMAN

Date

Apr. 10, 2023

**Project Address** Royal Bay Sector 7 Verity Construction

3470 Trumpeter Street Lot 63


Colwood, B.C.


Prepared for Verity Construction


> Project # 8298-63

Scale Not to Scale

Drawn By MRB

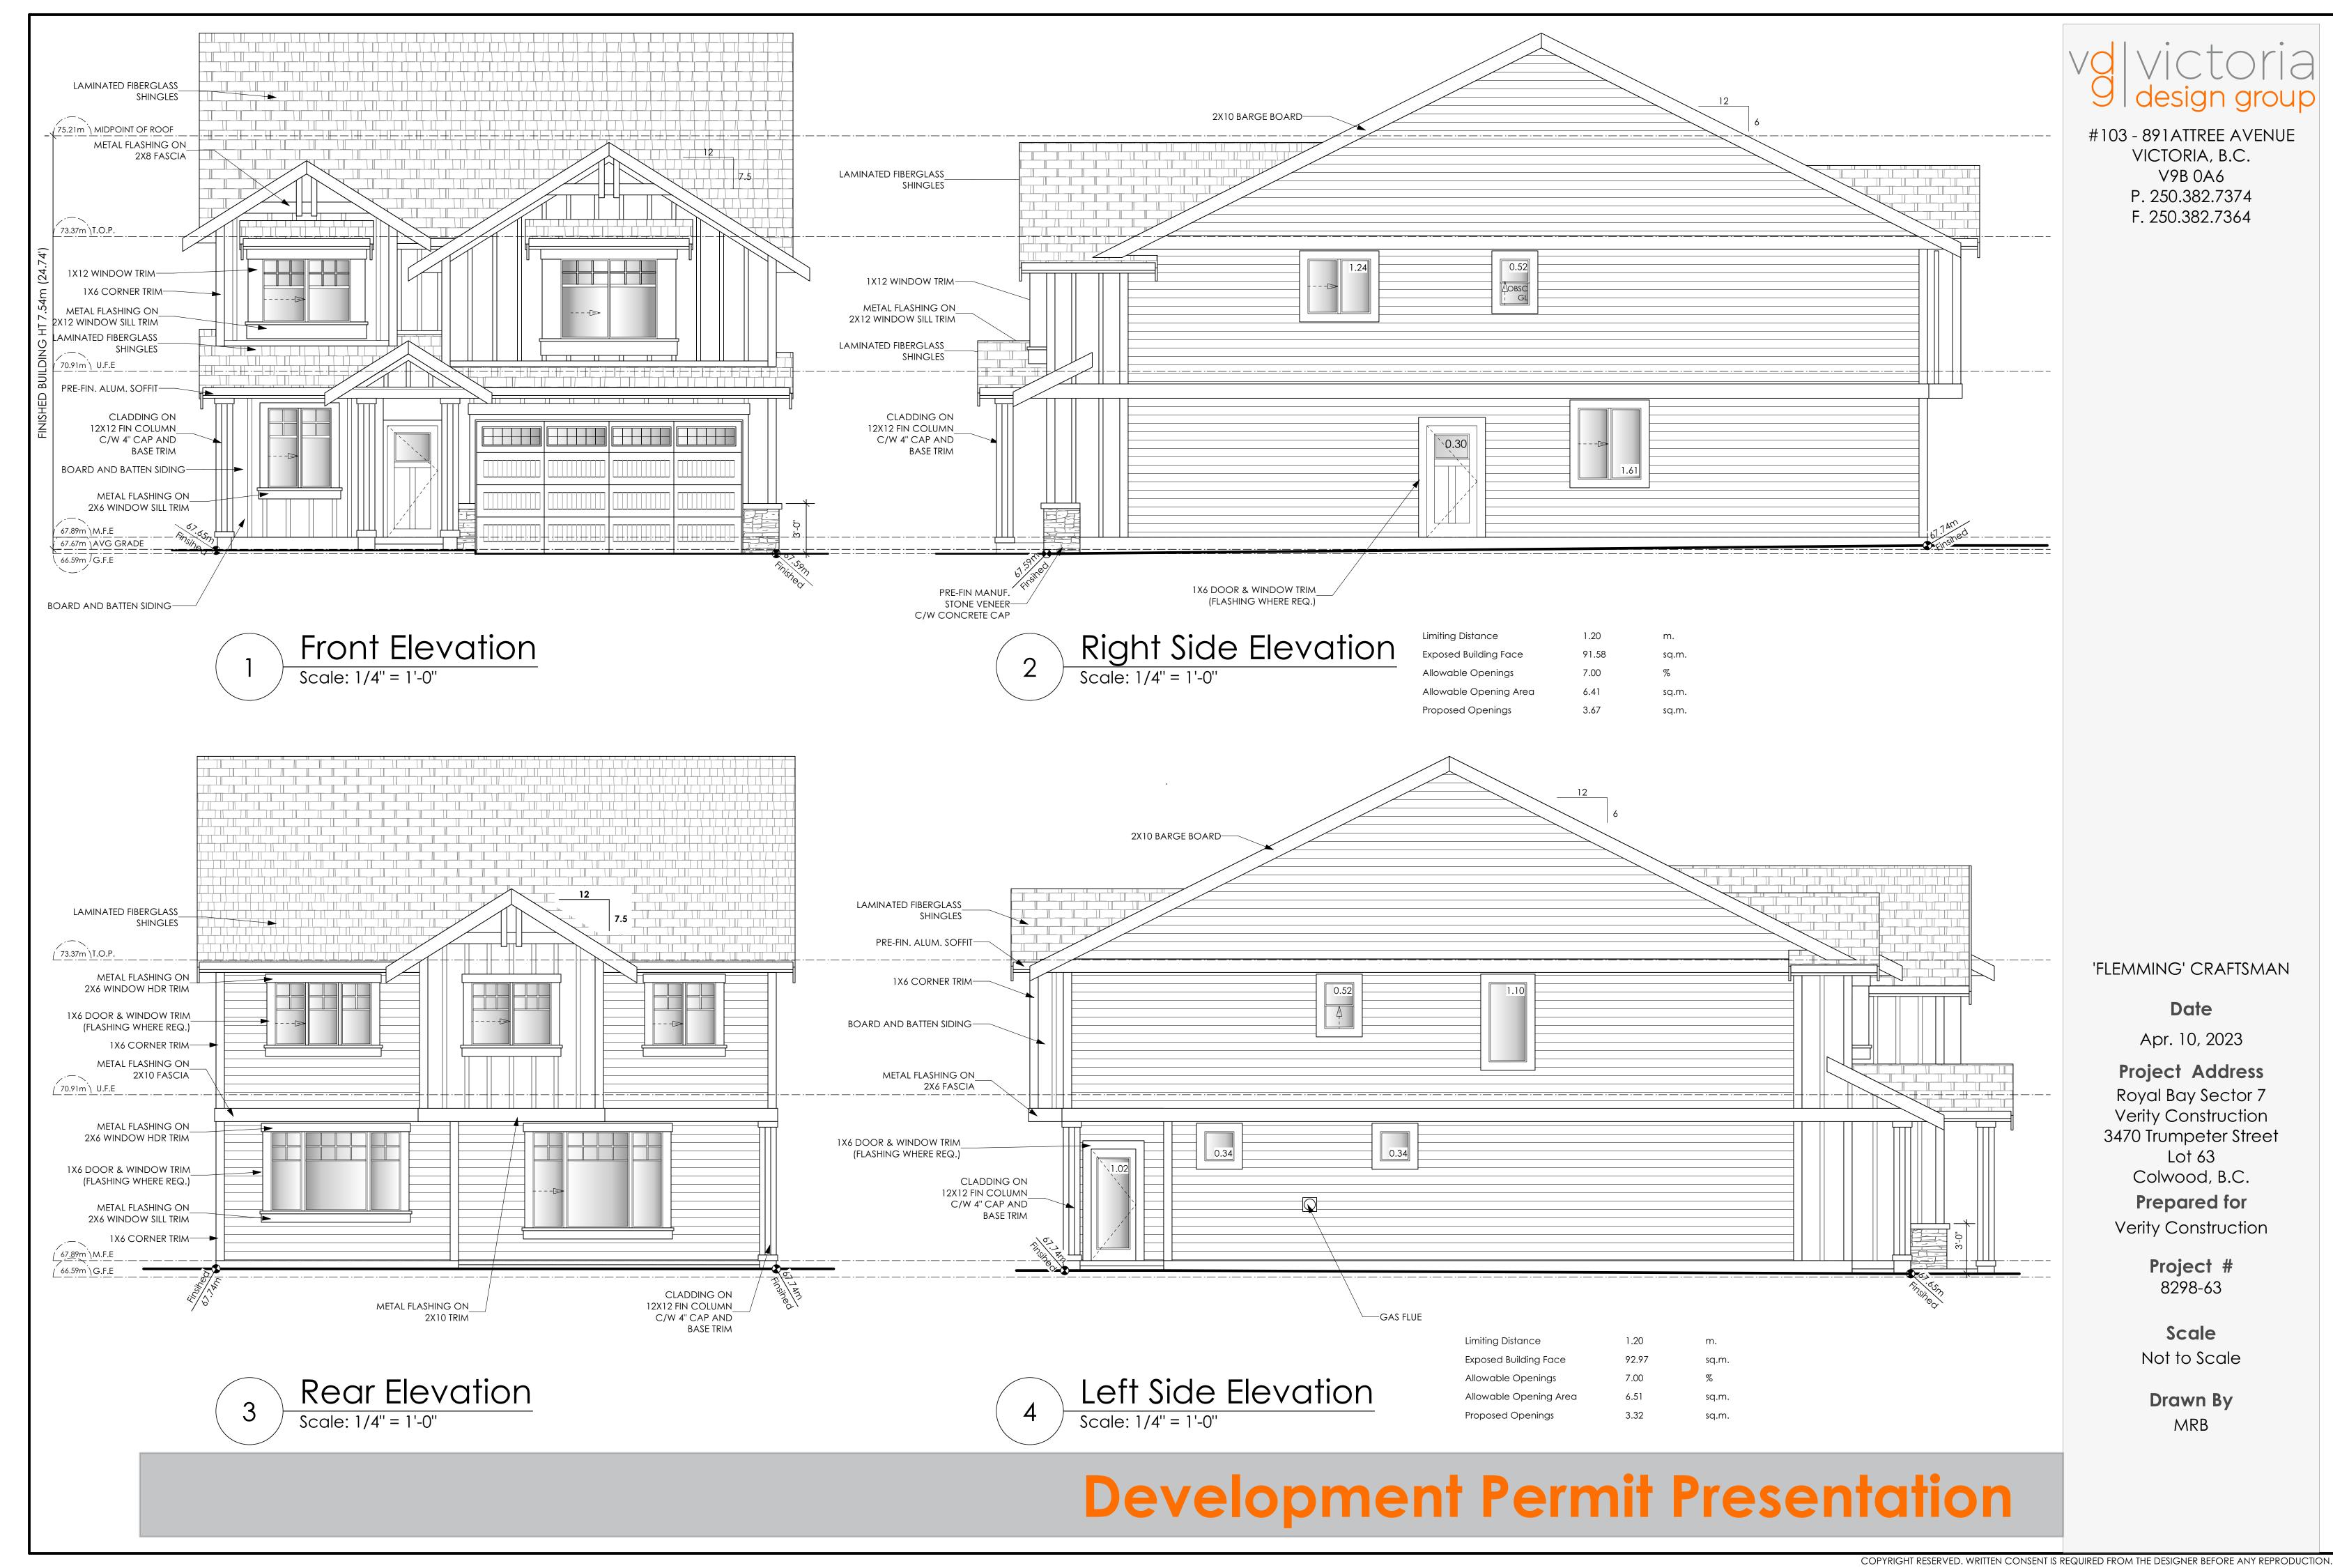

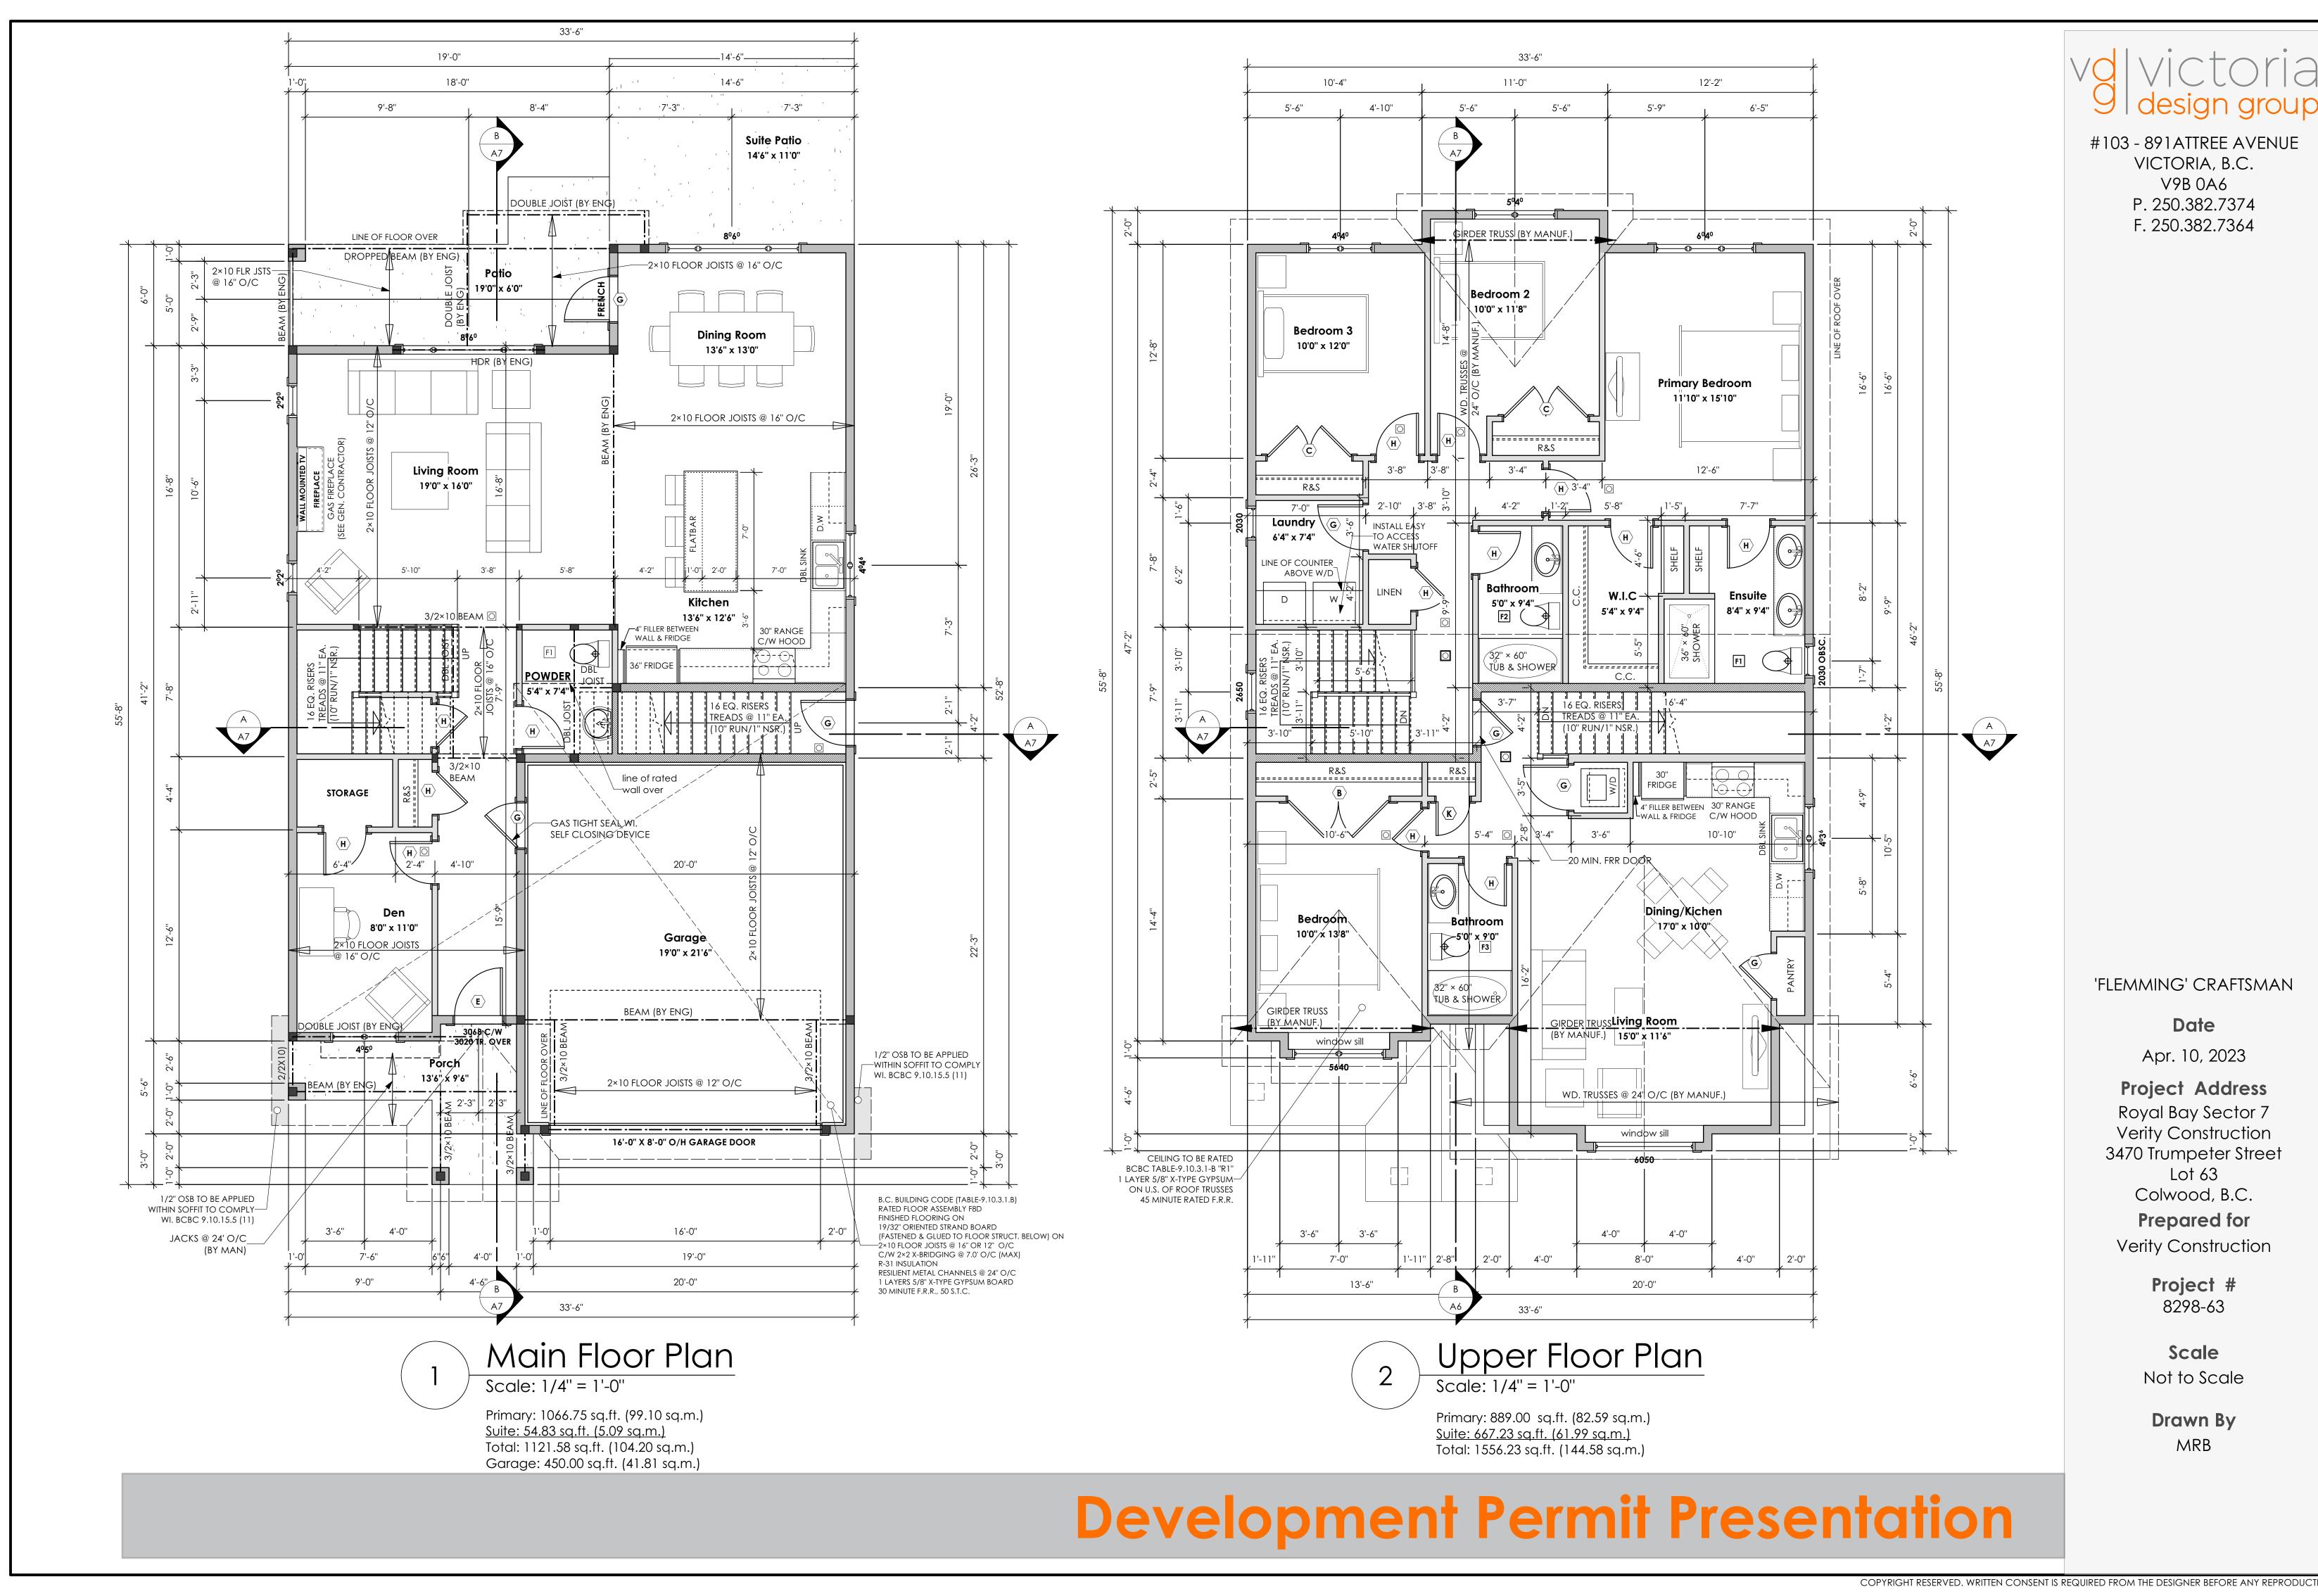

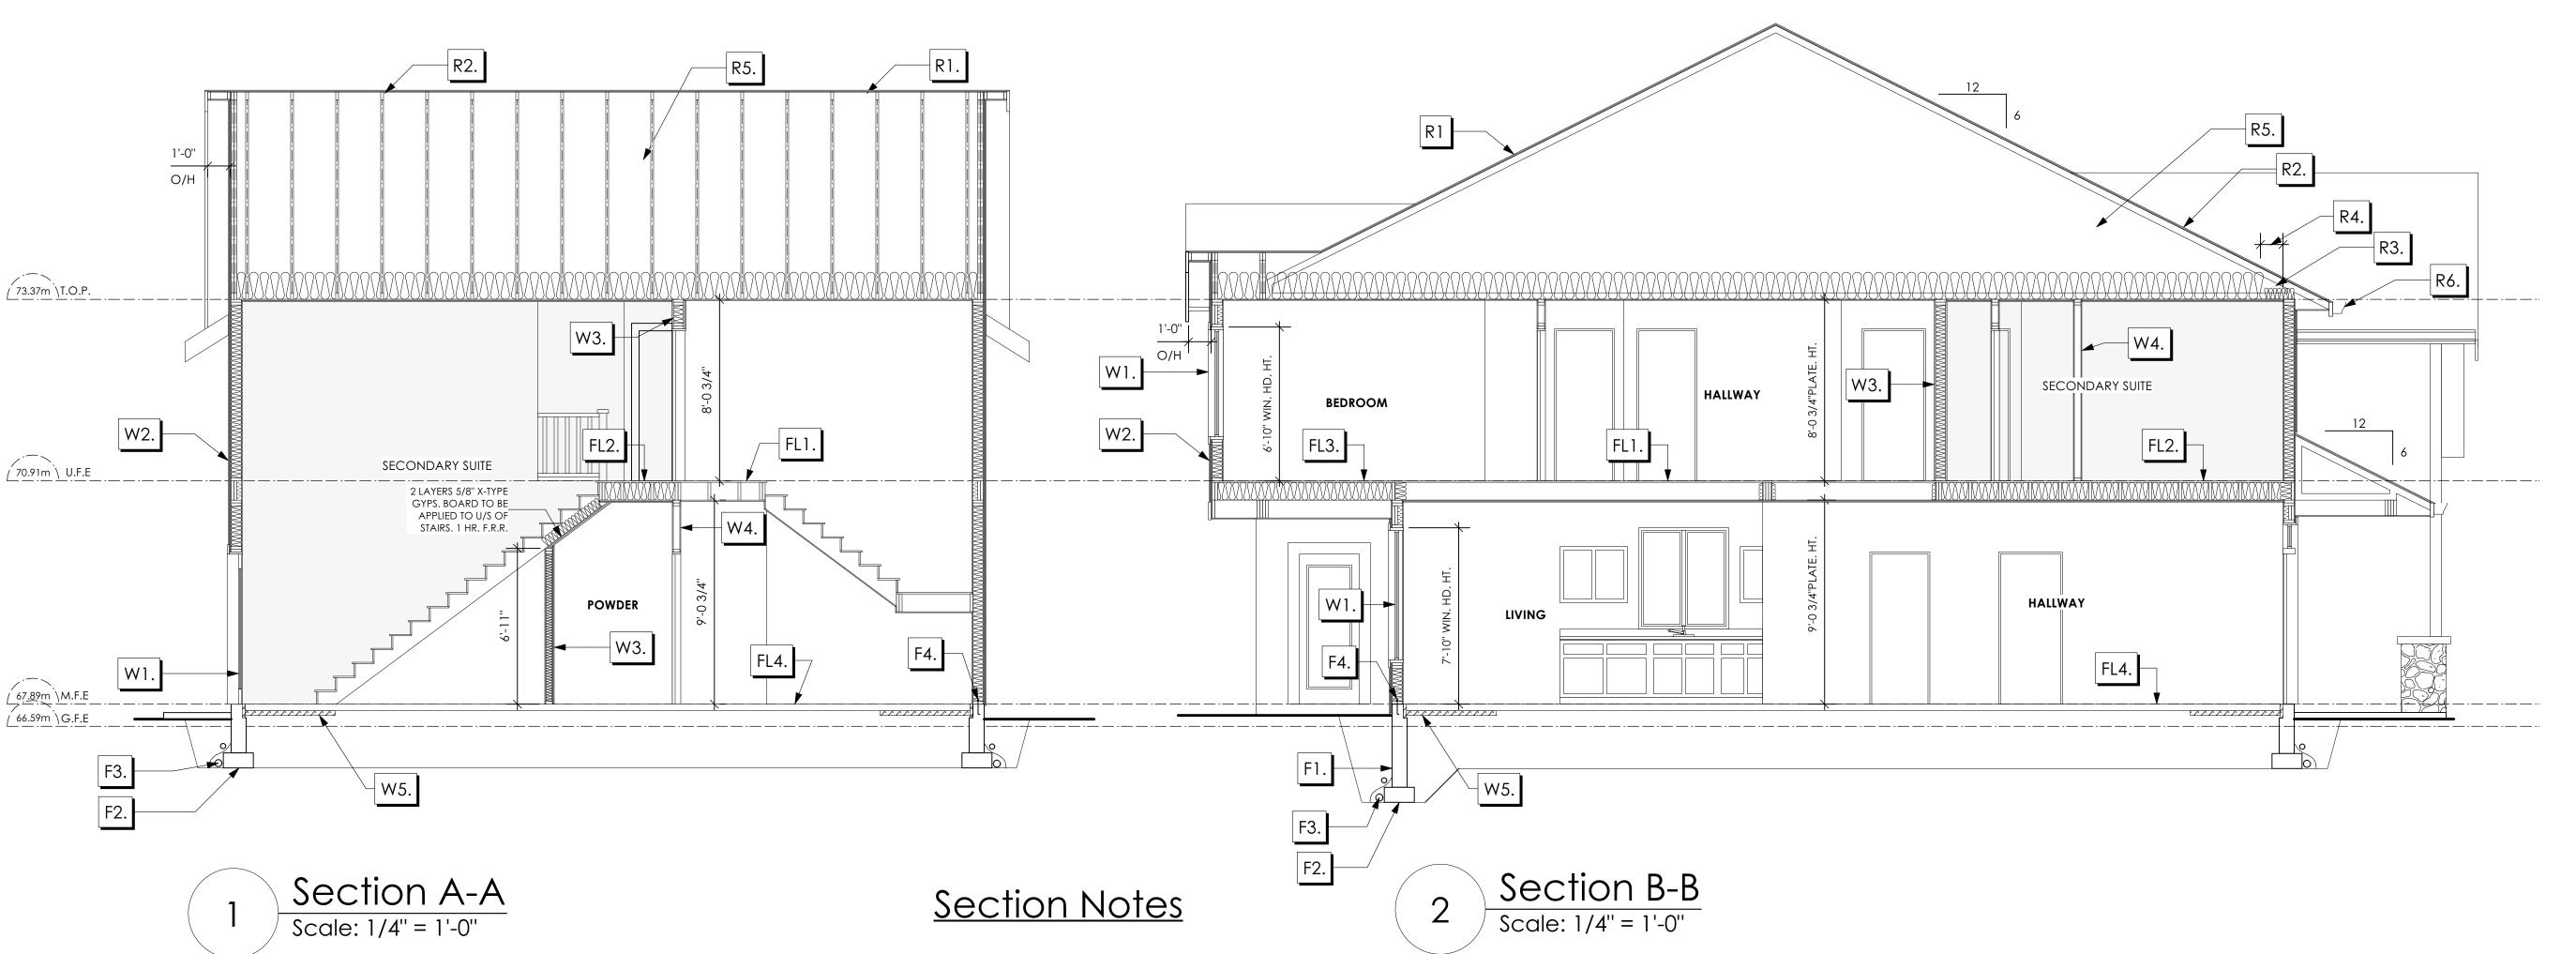

**WALLS** 

(TYPICAL, WI. 2 1/2" XPS INSULATION)

(GLAZING IN ALL EXTERIOR DOORS & WITHIN 3 FT.

OF EXTERIOR DOORS TO BE SHATTERPROOF (SP))

WINDOW REQUIREMENTS DERIVED FROM BCBC

TABLE C-5 AS PER BCBC 9.7.4.3. AND ARE TO BE

USED TO SATISFY THE REQUIREMENTS OF

COLWOOD, CLASS R, DP 1440, PG 30,

WINDOW UNITS UPON INSTALLATION

9.5MM (3/8") AIR SPACE / STRAPPING

6 MIL. POLYETHYLENE VAPOUR BARRIER

1 LAYER 1/2" X-TYPE GYPSUM BOARD ON

RESILIENT METAL CHANNELS ON ONE SIDE

(BETWEEN PRIMARY LIVING & SECONDARY SUITE)

EACH SIDE OF 2×4 STUDS @ 16" O/C OR

W3. B.C. BUILDING CODE (TABLE 9.10.3.1.A)

2×6 STUDS @ 16" O/C (IF NOTED)

@ 400mm OR 600mm O.C. C/W 3 1/2" FIBRE GLASS SOUND BATTS

FRICTION FITTED AND SOLID FILLED

45 MIN. F.R.R., 43 S.T.C.

RATED WALL ASSEMBLY W3c

HOUSE WRAP (A.B.) (TYVEK OR EQ.)

3/8"×2" BORATE TREATED PLYWOOD STRAPPING

7/16" ORIENTED STRAND BOARD SHEATHING

AAMA/WDMA/CSA 101/I.S.2/A440, "NAFS":

RATINGS MUST BE CLEARLY LABELED ON ALL

FLASHING OVER @ EXTERIOR

WATER RESIST. 220, A2,

FOR INSPECTION.

W2. CONC. FIBRE BOARD ON

2×6 STUDS @ 16" O/C

1/2" GYPSUM BOARD

R-20 INSULATION

W1. DOUBLE GLAZING

FL1. FINISHED FLOORING ON 19/32" ORIENTED STRAND BOARD (FASTENED & GLUED TO FLOOR STRUCT. BELOW) ON 2×10 FLOOR JOISTS @ 16" OR 12" O/C C/W 2×2 X-BRIDGING @ 7.0' O/C (MAX)

FL2. B.C. BUILDING CODE (TABLE-9.10.3.1.B) RATED FLOOR ASSEMBLY F8D FINISHED FLOORING ON 19/32" ORIENTED STRAND BOARD 7/16" ORIENTED STRAND BOARD C/W "H" CLIPS 2×10 FLOOR JOISTS @ 16" OR 12" O/C C/W 2×2 X-BRIDGING @ 7.0' O/C (MAX) R-31 INSULATION RESILIENT METAL CHANNELS @ 24" O/C 1 LAYERS 5/8" X-TYPE GYPSUM BOARD

**FLOORS** 

R3. PROVIDE 2 1/2" (63MM) CLEAR BETWEEN FL3. FINISHED FLOORING ON R-20 INSULATION AND SHEATHING. 19/32" ORIENTED STRAND BOARD (MIN. R-20 @ ROOF-WALL CONNECTION FOR 2×10 FLOOR JOISTS @ 16" OR 12" O/C 4'-0" (1.2M) AROUND PERIMETER OF BUILDING. AIR VENTILATION BAFFLES TO BE INSTALLED C/W 2×2 X-BRIDGING @ 7.0' O/C (MAX) PROVIDE R-31 F/G BATT INSULATION IN WHERE REQUIRED IN AS PER BCBC 9.19.) JOIST CAVITY C/W BUILDING WRAP R4. EAVE PROTECTION CONT. UP ROOF SLOPE FOR 12"

R5. PROVIDE 1 SQ.FT. ATTIC VENT PER FL4. FINISHED FLOORING 300 SQ.FT. OF INSULATED AREA MIN. 3 1/2" CONCRETE SLAB 25% OF REQUIRED TO BE @ TOP AND BOTTOM 6 MIL. POLY'N V.B. (TO COMPLY WI. B.C. BLDG. CODE 9.19.1)

R6. PRE-FIN. FASCIA GUTTER 2×8 FASCIA BD. 2×4 SUB. FASCIA BD. **VENTED SOFFIT** (SEE CONTRACTOR)

R7. PRE-FIN. FASCIA GUTTER 2×8 FASCIA BD. 2×4 SUB. FASCIA BD. 1/2" ORIENTED STRAND BOARD **VENTED SOFFIT** (SEE CONTRACTOR)

**ROOFS** 

6 MIL POLY'N V.B.

6 MIL POLY'N V.B.

5/8" GYPSUM BOARD

R1. LAMINATED ASPHALT SHINGLES ON

WD TRUSSES (DESIGNED BY MANUF.)

R2. B.C. BUILDING CODE (TABLE-9.10.3.1.B)

LAMINATED ASPHALT SHINGLES ON

WD TRUSSES (DESIGNED BY MANUF.)

R-40 FIBRE GLAS BATT INSULATION OR

14 1/2" FIBRE GLASS LOOSE FILL INSULATION

RATED ROOF ASSEMBLY R1

5/8" X-TYPE GYPSUM BOARD

45 MINUTE RATED F.R.R.

PAST EXTERIOR WALL.

R-40 FIBRE GLAS BATT INSULATION OR

14 1/2" FIBRE GLASS LOOSE FILL INSULATION

7/16" ORIENTED STRAND BOARD C/W "H" CLIPS 1/2" GYPSUM BOARD

> (FASTENED & GLUED TO FLOOR STRUCT. BELOW) ON 30 MINUTE F.R.R., 50 S.T.C.

(FASTENED & GLUED TO FLOOR STRUCT. BELOW) ON VENTED SOFFIT (TO OWNERS SPEC'S) TO ALL SUSPENDED FLOOR AREAS

6" COMPACTED GRAVEL OR SAND FL5. 3 1/2" CONCRETE SLAB 6 MIL. POLY'N V.B.

6" COMPACTED GRAVEL OR SAND

SLOPE TO DOORS 1" (NOT IN SECTION) FL6. DECKING MEMBRANE (TO COMPLY WITH CAN/CGSB 37.54) ON 19/32" ORIENTED STRAND BOARD 2×10 DECK JOISTS @ 16" O/C C/W (PROVIDE ADEQUATE MEMBRANE

(SLOPE JOISTS TO PROVIDE MIN. 1:50 SLOPE)

"UPSTAND" @ EXT. WALL.)

W4. INTERIOR PARTITION ENERGY STAR LOW "E" RATING IN 1/2" GYPSUM BOARD ON EACH SIDE THERMAL BREAK FRAMES OF 2×4 STUDS @ 16" O/C OR 2/2"X10" LINTEL OVER (@ BEARING WALLS ONLY) 2×6 STUDS @ 16" O/C (IF NOTED)

> W5. 5/8" X-TYPE GYPSUM BOARD ON 2×6 STUDS @ 16" O/C C/W R-20 INSULATION 6 MIL. POLY'N V.B 1/2" GYPSUM BOARD (BETWEEN GARAGE & LIVING) (NOT SHOWN IN SECTION)

**FOUNDATION** 

F1. DAMP PROOFING (WHERE REQUIRED) ON C/W 15 M BARS @ 24" O/C B/W

F2. 16"X 8" CONC. FOOTINGS C/W 2 (TWO) 15M BARS CONT. 3 IN. FROM BOTT. ON UNDISTURBED SOIL (SOLID BEARING)

F3. 4" PERIMETER DRAIN 3" TIGHT PIPE FOR RWL DRAIN ROCK

F4. ANCHOR BOLTS @ 4.0 FT. O/C MAX C/W SILL GASKETS

F5. UNDER SLAB INSULATION 2 1/2" (RSI 2.15) EXTRUDED POLYSTYRENE RIGID INSULATION 4'-0" (1.2M) CONT. AROUND PERIMETER UNDER SLAB INSTALLED HORIZONTALLY (VERIFY WITH MUNICIPALITY DEPTH OF FROST LINE)

STEP DOWN TO GARAGE SLAB MAY VARY, VERIFY EXTENT ON SITE (NOT IN SECTION)

'FLEMMING' CRAFTSMAN

#103 - 891ATTREE AVENUE

VICTORIA, B.C.

V9B 0A6

P. 250.382.7374

F. 250.382.7364

Date

Apr. 10, 2023

**Project Address** Royal Bay Sector 7 Verity Construction 3470 Trumpeter Street


Lot 63 Colwood, B.C.

Prepared for Verity Construction

> Project # 8298-63

Scale Not to Scale

Drawn By MRB

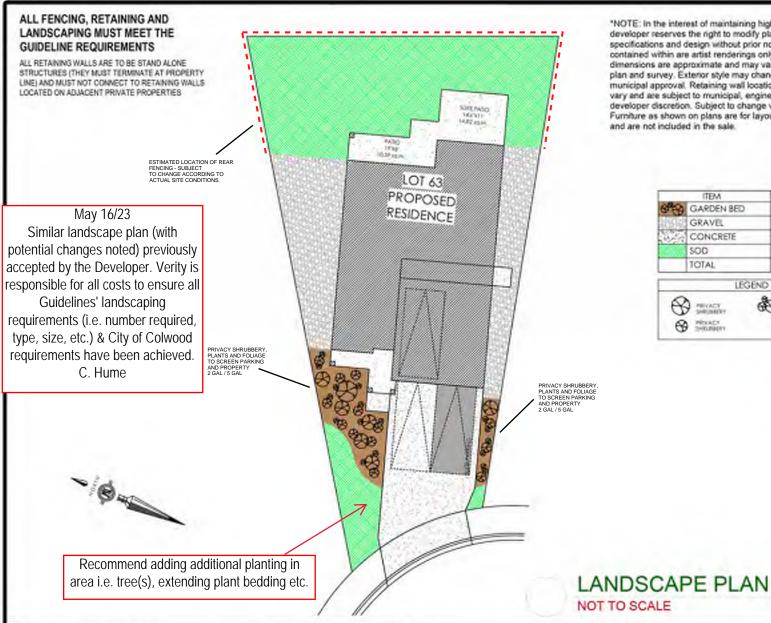



"NOTE: In the interest of maintaining high standards, the developer reserves the right to modify plans, specifications and design without prior notice. Drawings contained within are artist renderings only. Sizes and dimensions are approximate and may vary with actual plan and survey. Exterior style may change pending municipal approval. Retaining wall location and types may vary and are subject to municipal, engineering or developer discretion. Subject to change without notice. Furniture as shown on plans are for layout purposes only and are not included in the sale.

|       | ITEM       | AREA (st) | %    |
|-------|------------|-----------|------|
| 0 (9) | GARDEN BED | 313       | 9%   |
| 1999  | GRAVEL     | 756       | 21%  |
| N-N   | CONCRETE   | 1,019     | 28%  |
|       | SOD        | 1,528     | 42%  |
|       | TOTAL      | 3,616     | 100% |



KEY PLAN NOT TO SCALE

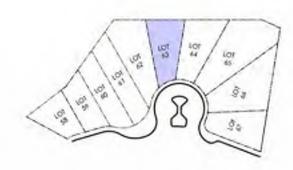

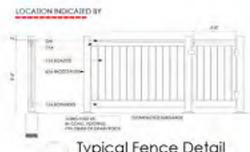

Typical Fence Detail Not To Scale

THE RESIDENCE WAS DESCRIBED TO SELECT THE RESIDENCE OF THE PARTY OF TH

COMPANDAMENTAL Fluid Name In the 20-00-violation Adjacent Converge Medium

Tree Planting Detail

All trees and plant by the total currer to be

#### ADDITIONAL NOTES:

PROPERTY TO BE IRRIGATED 6" PIPE FOR DRIVEWAY SLEEVES TO BE INSTALLED FOR CITY IRRIGATION LINES

| MM/DD/YY |    |          | ISSUED/REVISED |  |
|----------|----|----------|----------------|--|
|          | 01 | 04/21/23 | FOR APPROVAL   |  |
|          |    |          |                |  |
|          |    |          |                |  |
|          |    |          |                |  |
| Т        |    |          |                |  |

PROJECT

DATE

LANDSCAPING PLAN LOT 63, 3470 TRUMPETER ST. **ROYAL BAY, SECTOR 7** CITY OF COLWOOD



QUALITY CONSTRUCTION. TRUSTED SERVICE

106 - 1039 Langford Parkway Victoria, B.C. V9B 0A6

P: 250.474.1039 www.verityconstruction.ca


### GABLECTART HOMES

### **BUILDING GRADE SLIP**


| WSP | Project | No: | 201-08151-00 |
|-----|---------|-----|--------------|
|     | ,       |     |              |


C. Hume May 16/23


| BUILDING (  | SKADE SLIP Issue Date:  |
|---|---|
| MUNICIPAL ADDRESS 3470 Trumpeter Street   | P.I.D.  |
| LOT 63  | PLAN  |
| VERITY HOMES  | SUBDIVISION  ROYAL BAY SECTOR 7   |
| ADDRESS   | DEVELOPER  MEADOWS DEVELOPMENT LP   |
| REPRESENTATIVE PH.  | CONSULTANT WSP CANADA INC   |
| PROPOSED BUILDING GRADES  ALL ELEVATIONS ARE METRIC GEODETIC +  MAIN FLOOR ELEVATION 67.89  (TOP OF JOISTS)  FRONT ELEV_67.65 REAR ELEV_67.74  (FINISHED GRADE) (FINISHED GRADE)  FINISHED GRADE AT GARAGE 67.59  ACTUAL TOP OF FOOTING not provided ELEVATION (ATF)  LOWEST PERMITTED TOP OF not provided FOOTING ELEVATION (JEVAN CONTING ELEVATION OF BASEMENT SLAB FROST WALLS ARE REQUIRED.)  SERVICES FRONT REAR CENTER REFER SIZE TO PLAN (mm)                 | PLAN  LOT: 63 PLAN:  RETAINING WALL  DEVELOPERS SWALE  63   |
| WATER   | ROAD B  |
| DRAIN TO SUMP PUMP LIKELY REQUIRED  (FOR BASEMENT IF INSTALLED)   | STREET  SROW  SROW  L# 6  EG 49.90  LFE/MFE 47.70  GFE 47.55  MSE 52.20  S 49.12 (P)  D 49.12 (P)  L 49.12 (P)  L 50.03  L 60.03  L 70.03  L 70.03 |
| NOTES  1. IT IS THE RESPONSIBILITY OF THE BUILDER TO ENSURE THE FOOTINGS ARE PLACED ON A PROPER BASE THAT IS FREE FROM FROST, EXCESSIVE MOISTURE AND DELETERIOUS MATERIALS AND HAVE APPROPRIATE FROST PROTECTION WHEN COMPLETED.  2. THE INFORMATION CONTAINED HEREIN IS BASED ON THE APPROVED LOT GRADING PLAN FOR THIS SUBDIVISION. UN—AUTHORIZED DEVIATIONS WILL BE THE RESPONSIBILITY OF THE BUILDER TO ENSURE COMPLIANCE WITH ALL LOCAL BYLAWS.  3. OTHER NOTES: | I, THE BUILDER'S REPRESENTATIVE, CERTIFY THAT THE FINAL HOUSE PLANS PROVIDED IN THE BUILDING PERMIT APPLICATION ARE THE SAME AS PROCESSED UNDER THIS GRADE SLIP AND THAT I UNDERSTAND THE INFORMATION AND THE REQUIREMENTS CONTAINED HEREIN AND WILL BUILD ACCORDINGLY.  AUTHORIZED BUILDER'S REPRESENTATIVE  THE INFORMATION CONTAINED HEREIN IS BASED ON THE APPROVED LOT GRADING PLAN FOR THIS SUBDIVISION, DATED  |

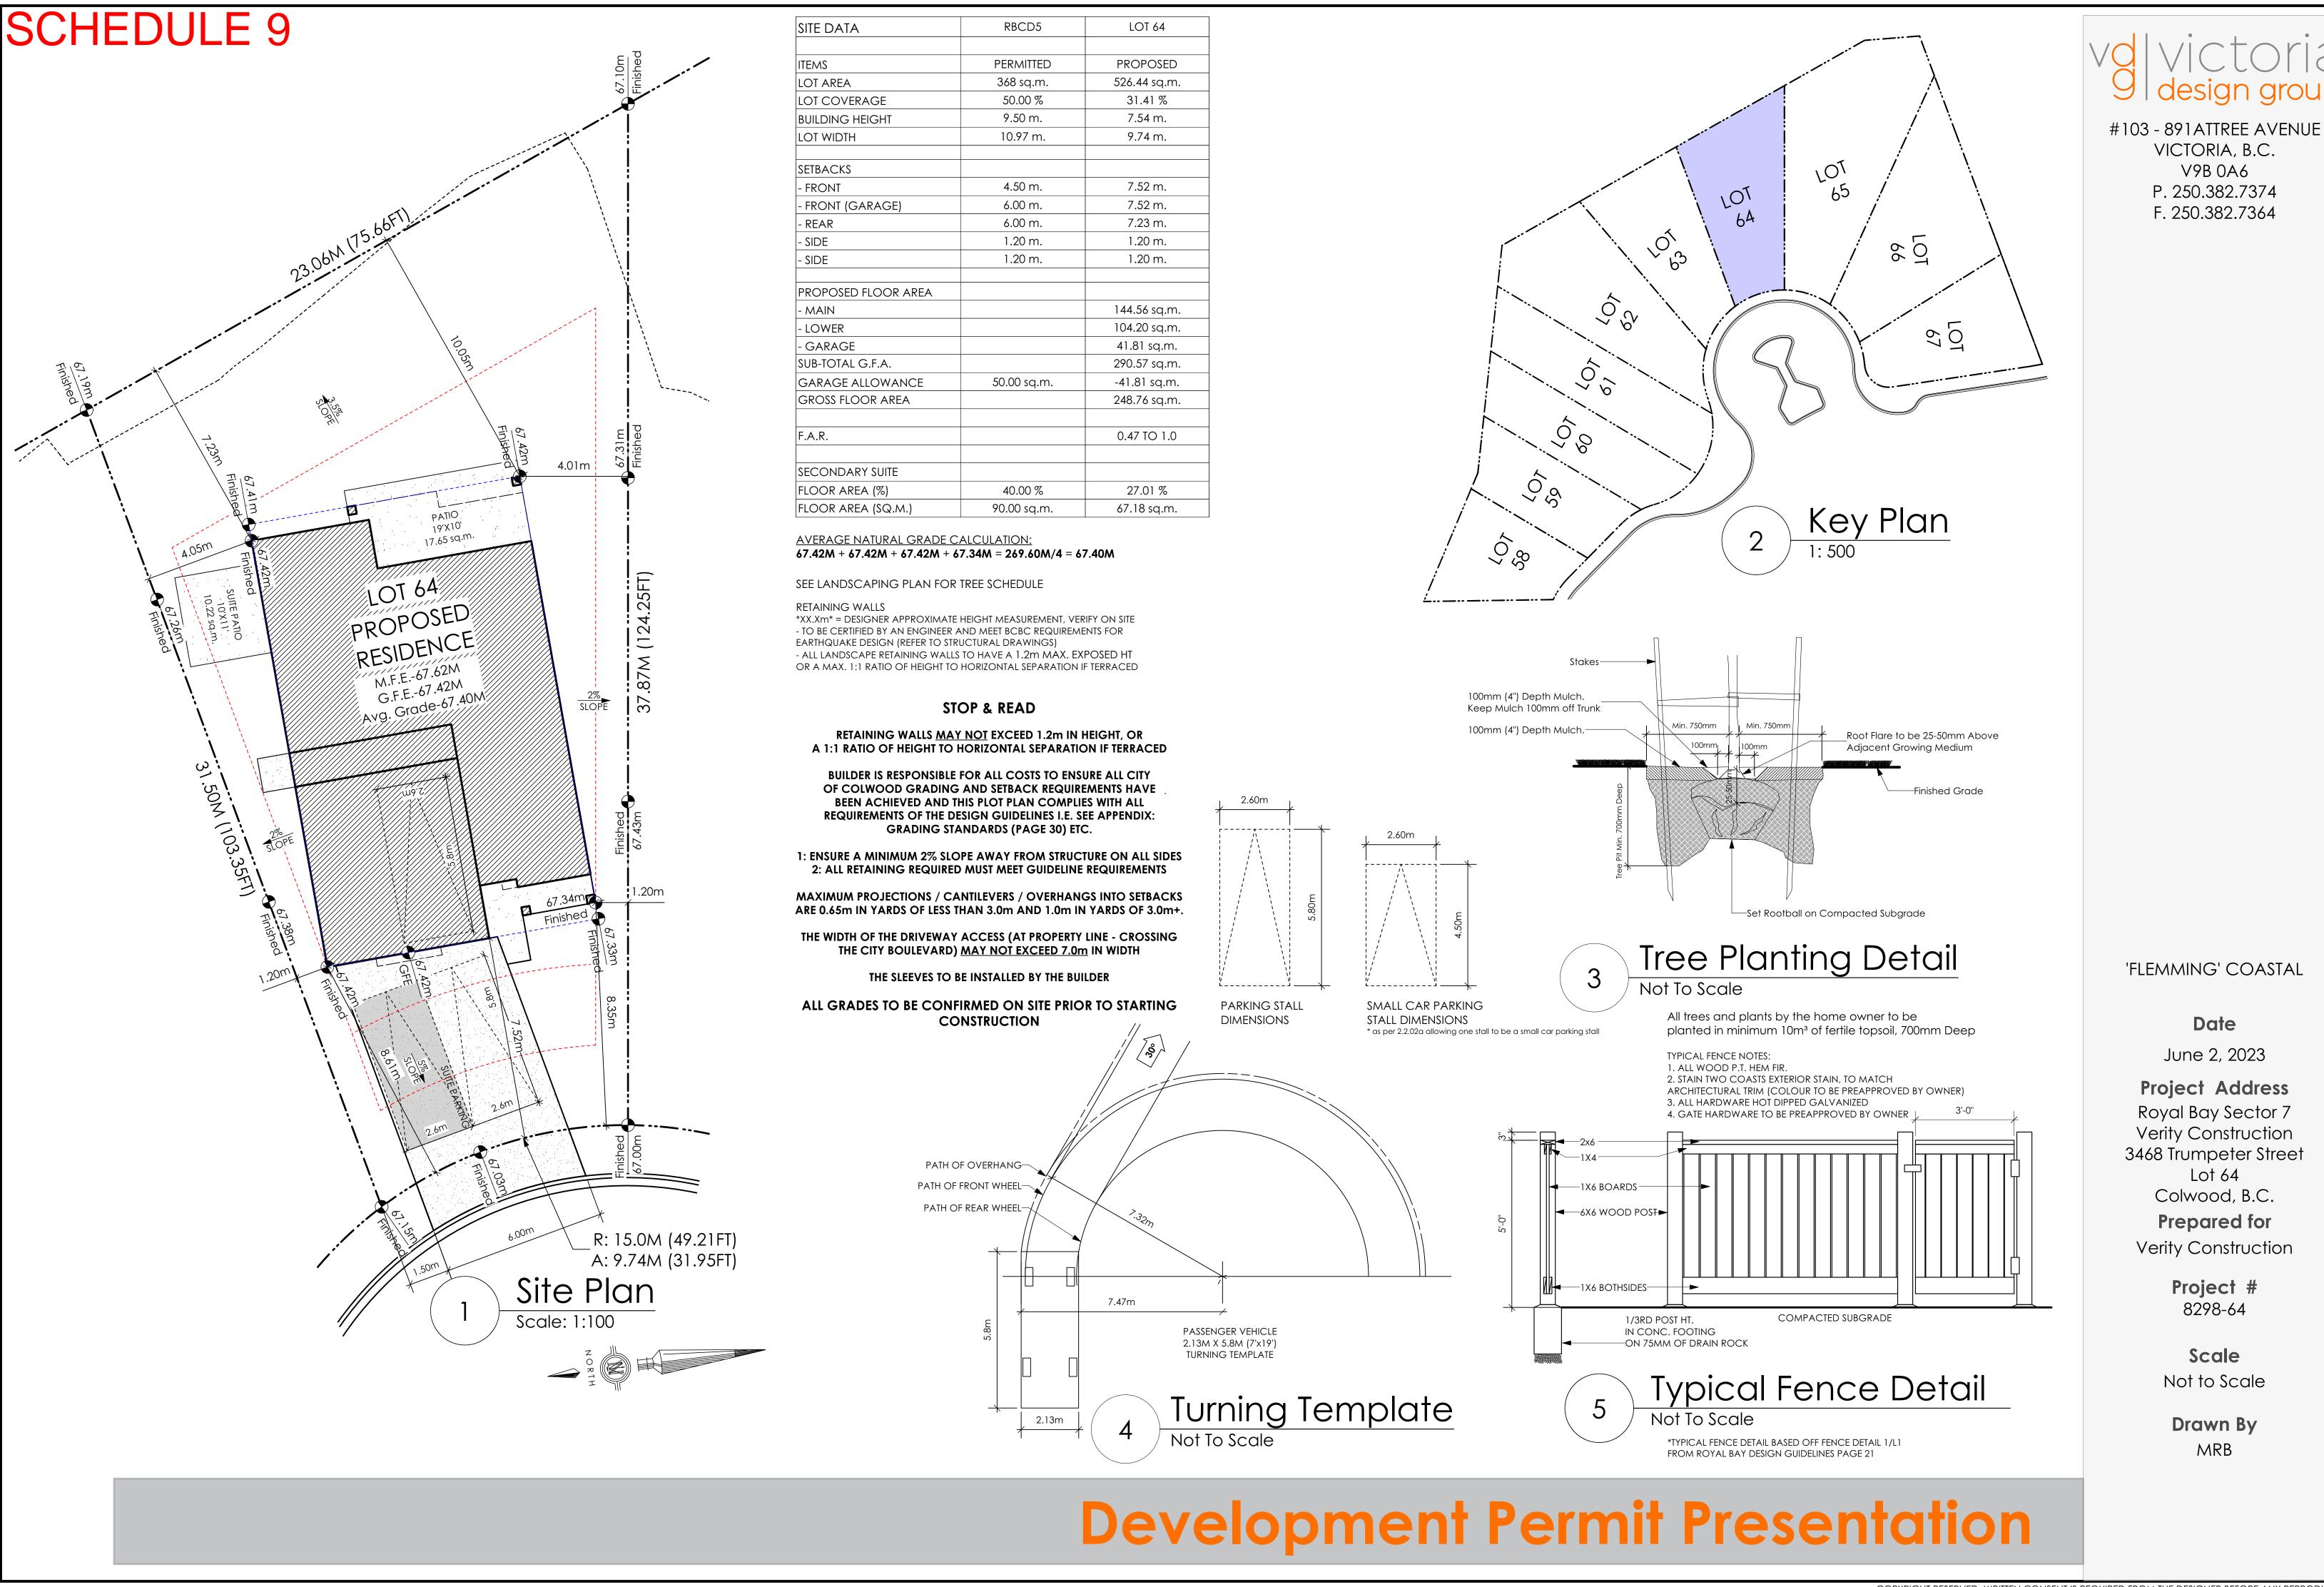

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Scale: 1/4" = 1'-0"

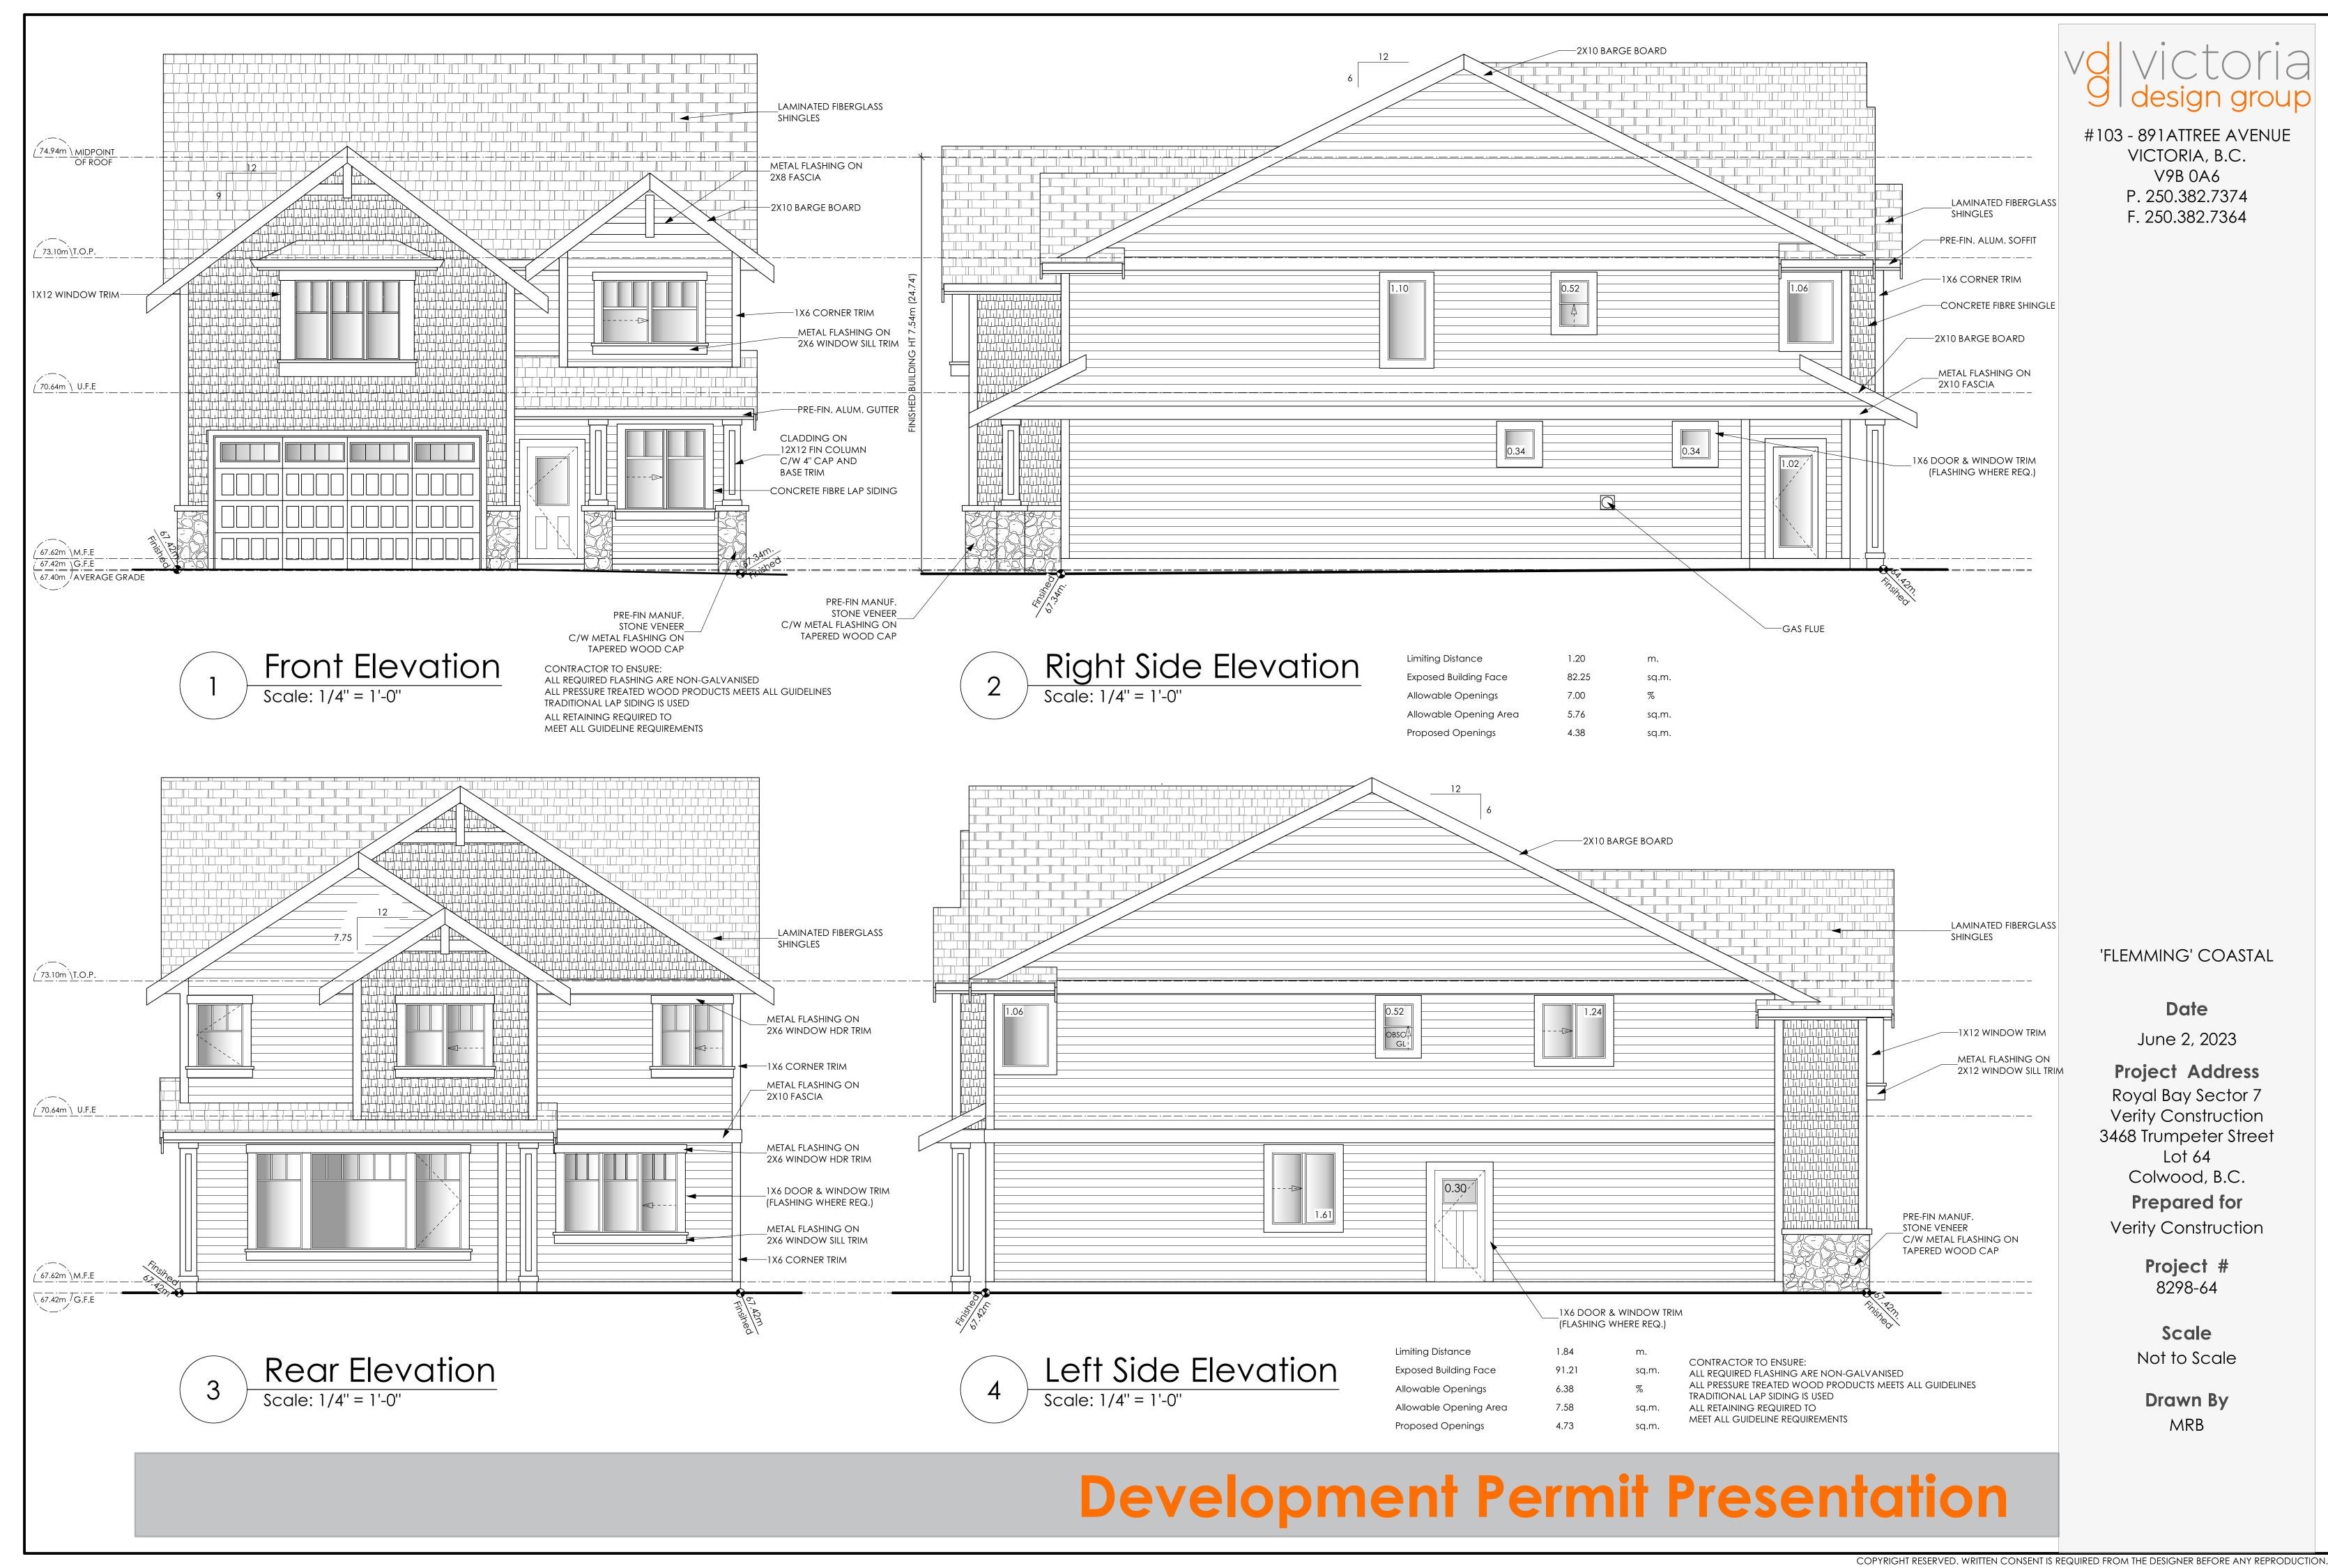1/2" GYPSUM BOARD ON EACH SIDE

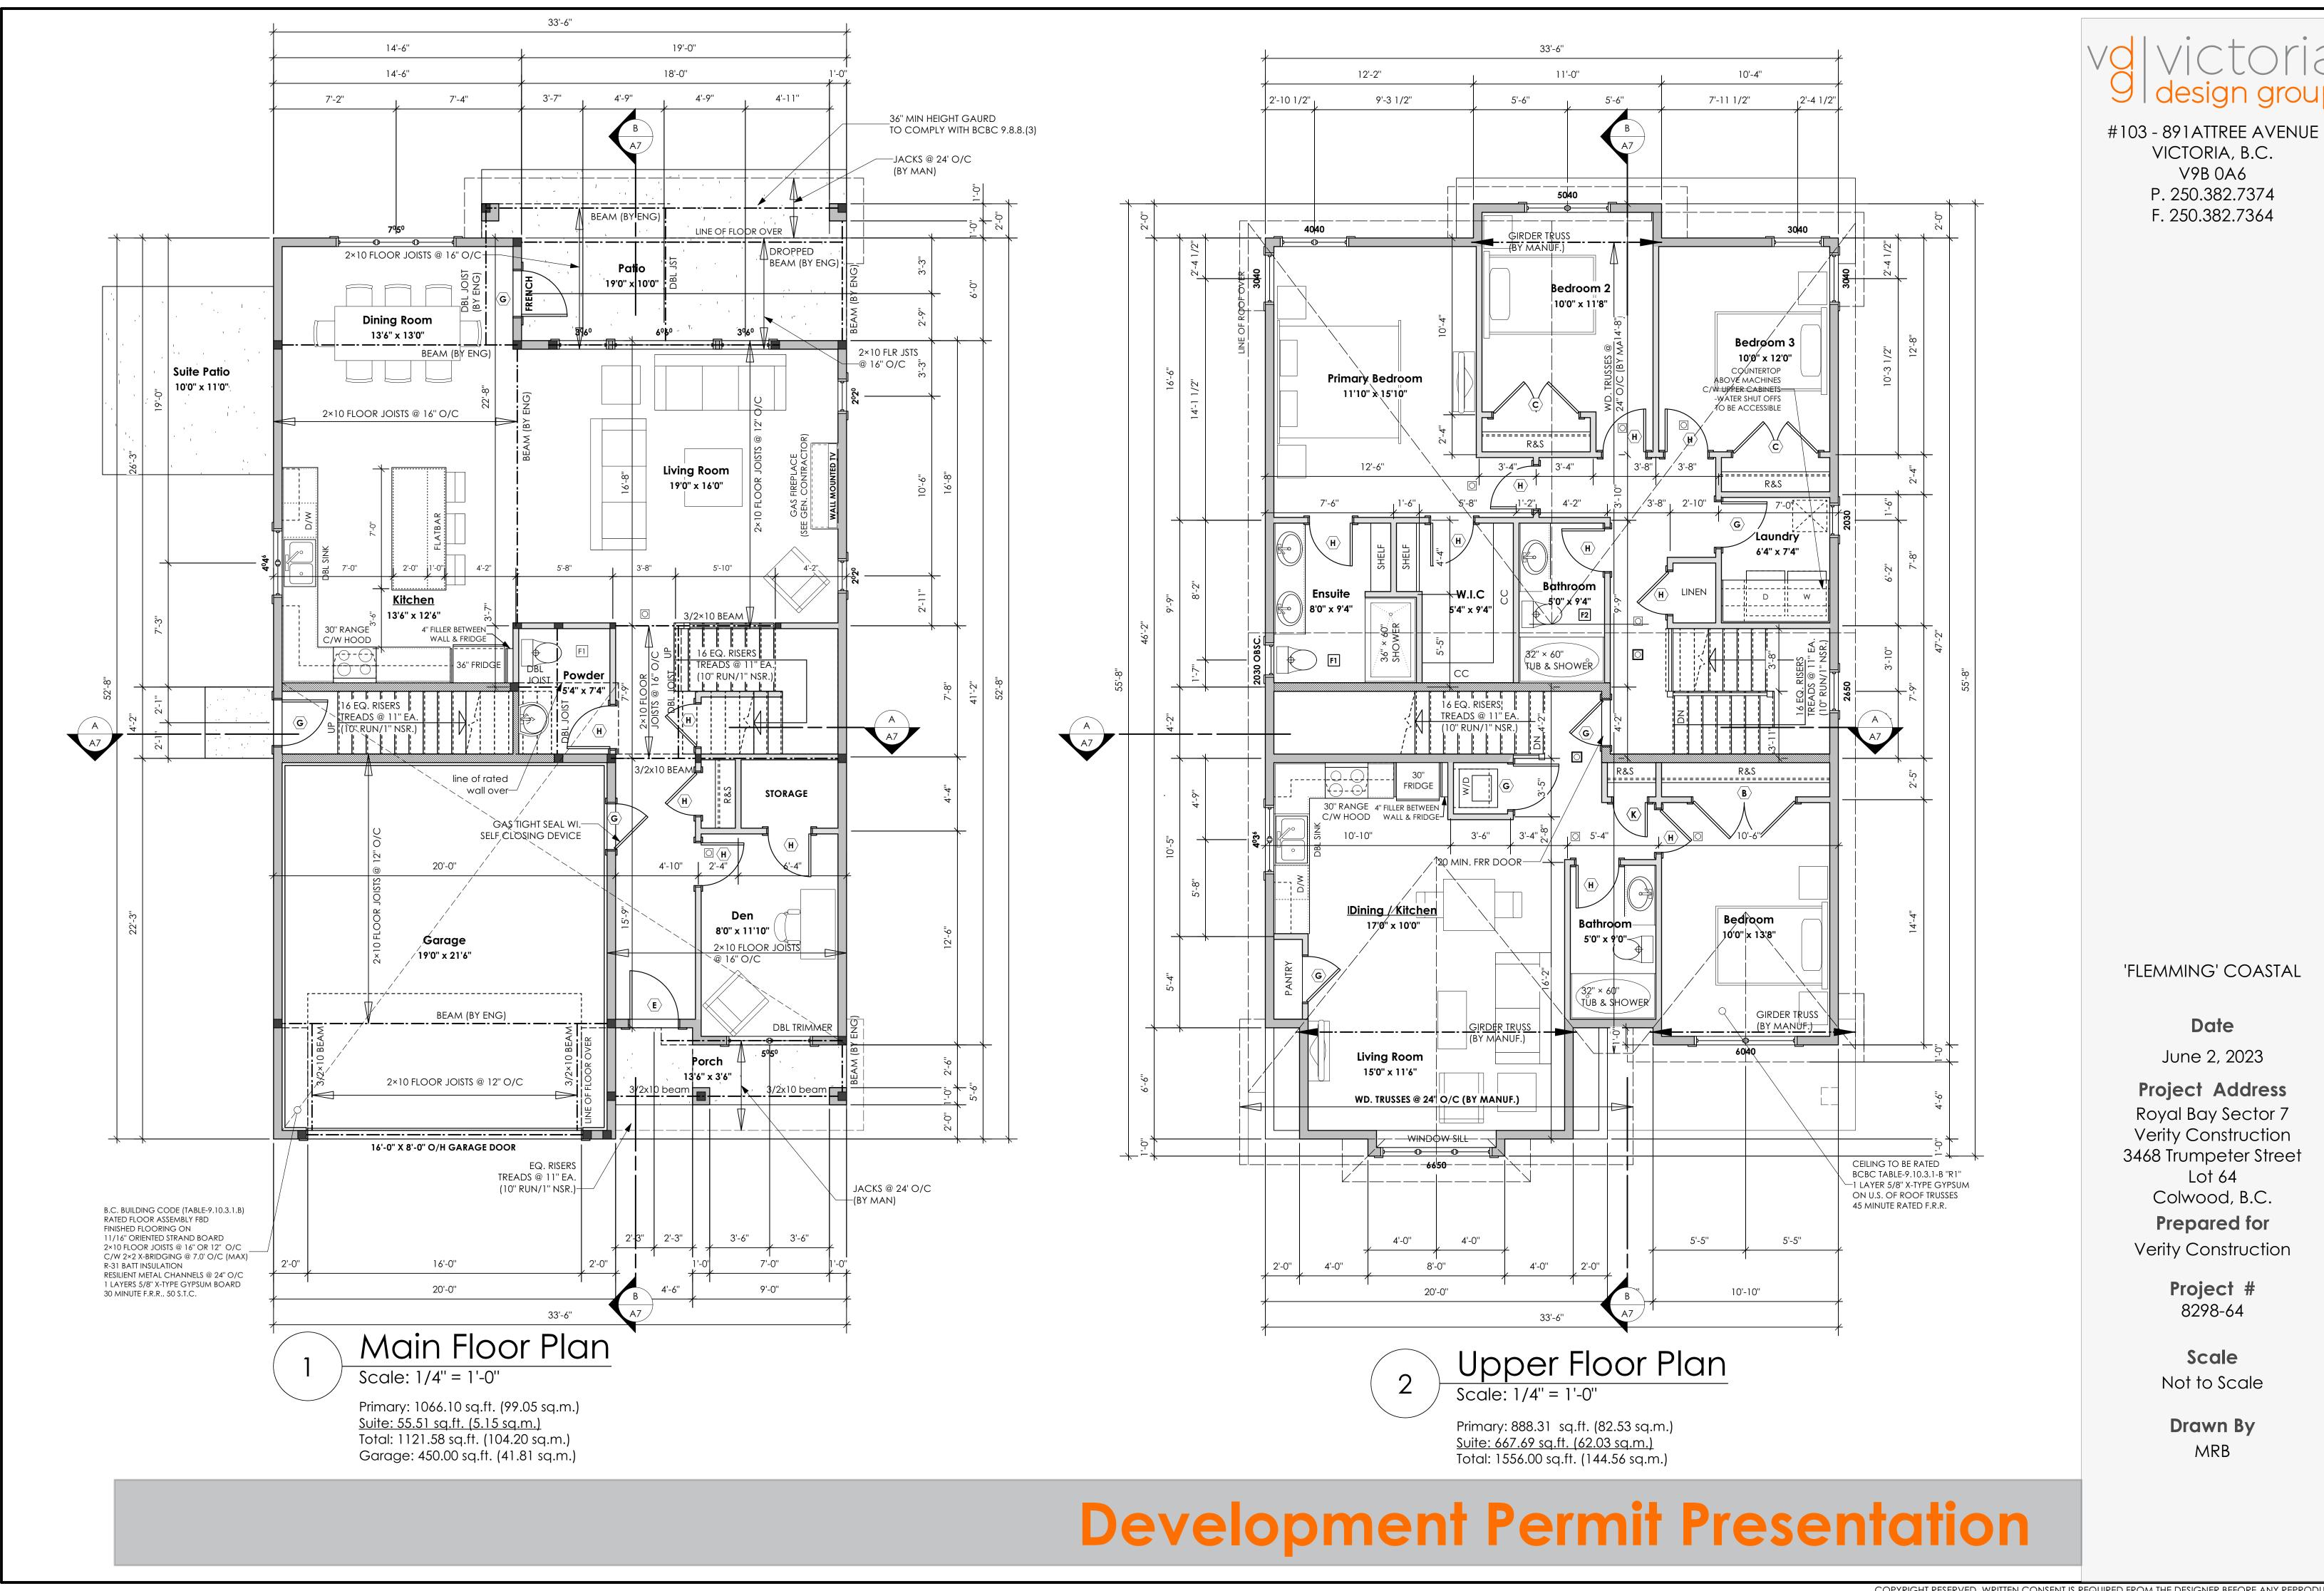OF 2×4 STUDS @ 16" O/C OR

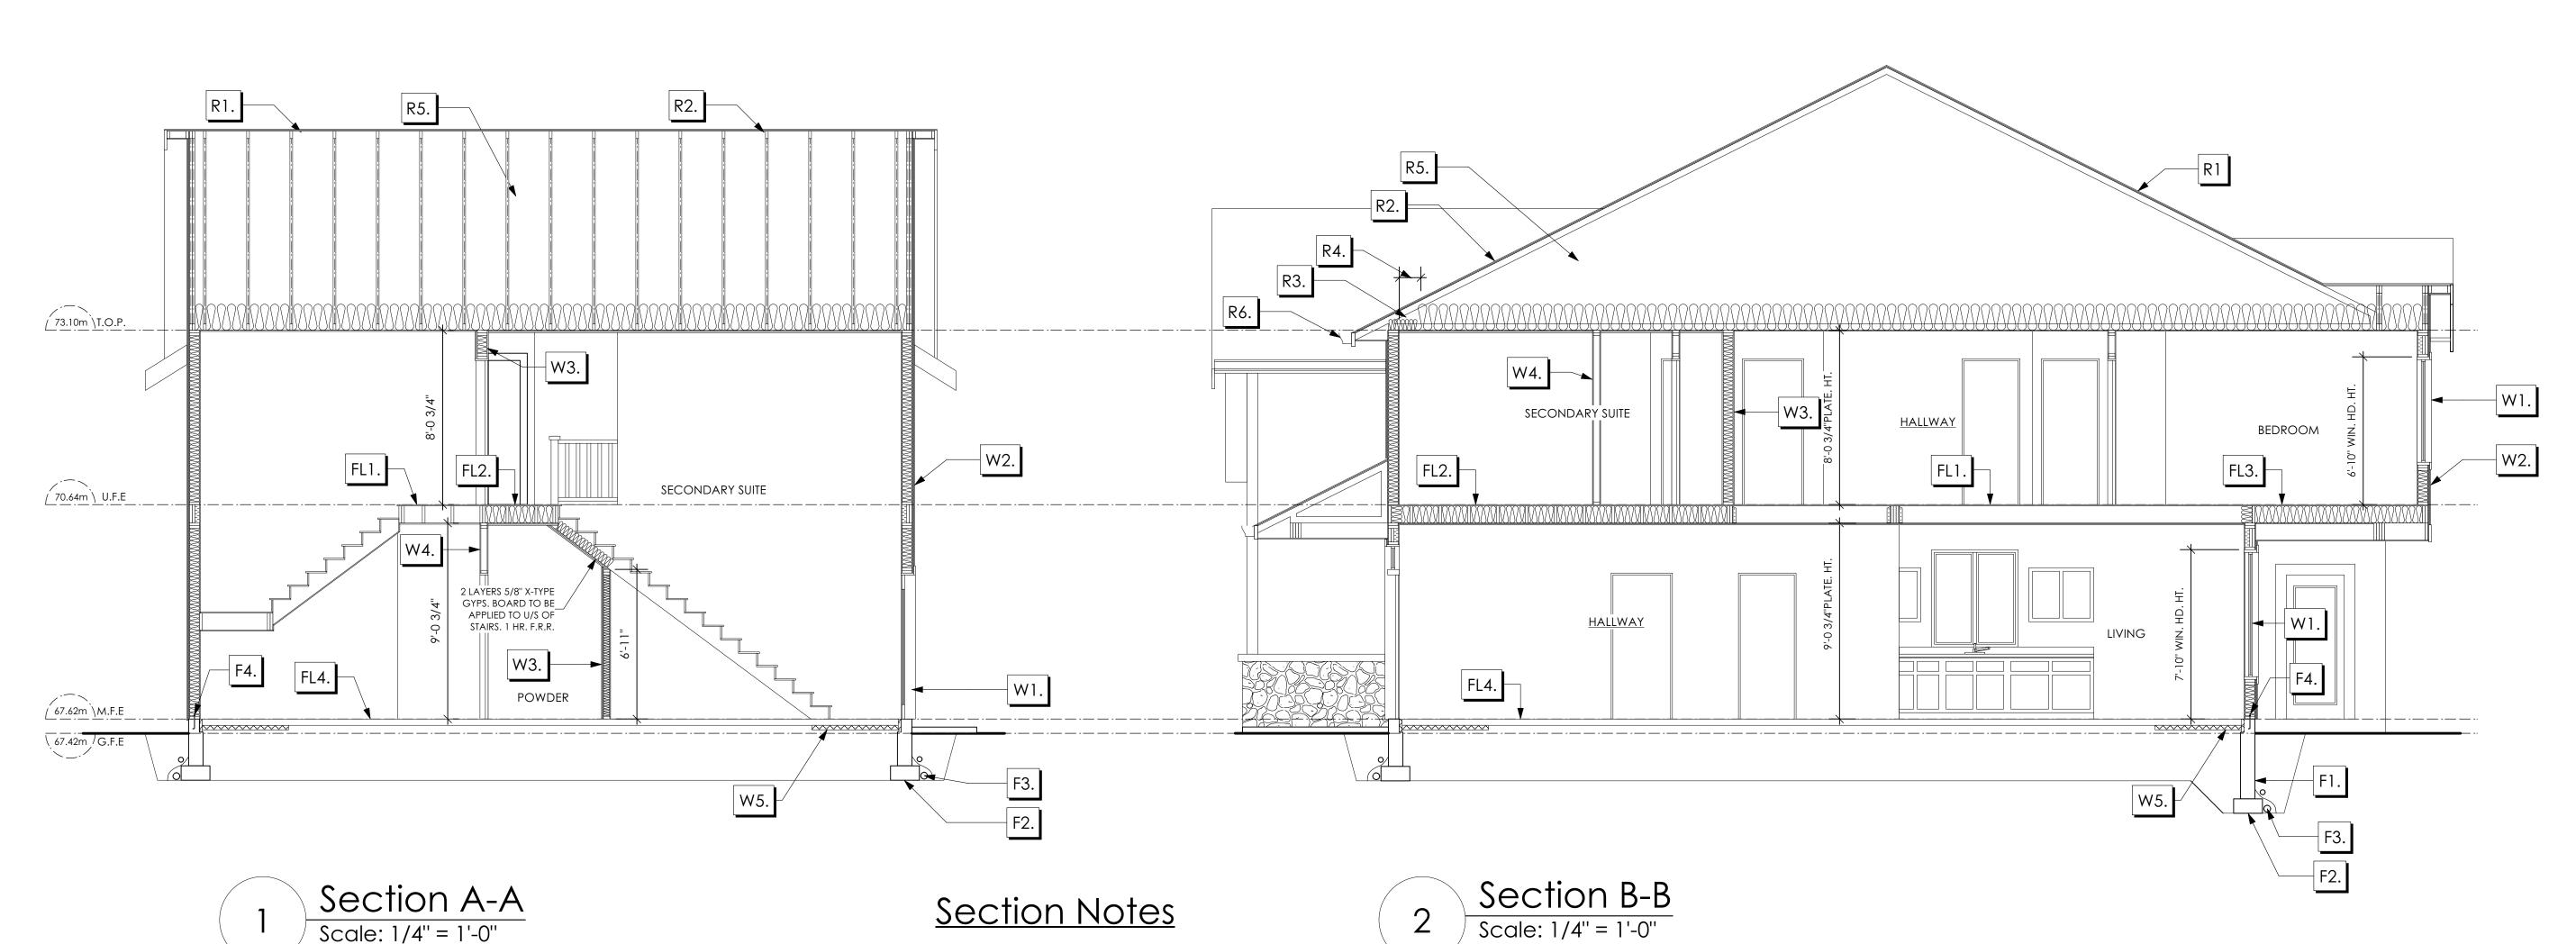W5. 5/8" X-TYPE GYPSUM BOARD ON

2×6 STUDS @ 16" O/C C/W

(NOT SHOWN IN SECTION)

2×6 STUDS @ 16" O/C (IF NOTED)

(BETWEEN GARAGE & LIVING)

W4. INTERIOR PARTITION

R-20 INSULATION

6 MIL. POLY'N V.B

1/2" GYPSUM BOARD

#### $R \cap \cap F$

- R1. LAMINATED ASPHALT SHINGLES ON
  7/16" ORIENTED STRAND BOARD C/W "H" CLIPS
  WD TRUSSES (DESIGNED BY MANUF.)
  R-40 FIBRE GLAS BATT INSULATION OR
  14 1/2" FIBRE GLASS LOOSE FILL INSULATION
  6 MIL POLY'N V.B.
  5/8" GYPSUM BOARD
- R2. B.C. BUILDING CODE (TABLE-9.10.3.1.B)
  RATED ROOF ASSEMBLY R1
  LAMINATED ASPHALT SHINGLES ON
  7/16" ORIENTED STRAND BOARD C/W "H" CLIPS
  WD TRUSSES (DESIGNED BY MANUF.)
  R-40 FIBRE GLAS BATT INSULATION OR
  14 1/2" FIBRE GLASS LOOSE FILL INSULATION
  6 MIL POLY'N V.B.
  5/8" X-TYPE GYPSUM BOARD
  45 MINUTE RATED F.R.R.
- R3. PROVIDE 2 1/2" (63MM) CLEAR BETWEEN R-20 INSULATION AND SHEATHING.
  (MIN. R-20 @ ROOF-WALL CONNECTION FOR 4'-0" (1.2M) AROUND PERIMETER OF BUILDING. AIR VENTILATION BAFFLES TO BE INSTALLED WHERE REQUIRED IN AS PER BCBC 9.19.)
- R4. EAVE PROTECTION
  CONT. UP ROOF SLOPE FOR 12"
  PAST EXTERIOR WALL.
- R5. PROVIDE 1 SQ.FT. ATTIC VENT PER
  300 SQ.FT. OF INSULATED AREA MIN.
  25% OF REQUIRED TO BE @ TOP AND BOTTOM
  (TO COMPLY WI. B.C. BLDG. CODE 9.19.1)
- R6. PRE-FIN. FASCIA GUTTER
  2×8 FASCIA BD.
  2×4 SUB. FASCIA BD.
  VENTED SOFFIT
  (SEE CONTRACTOR)
- R7. PRE-FIN. FASCIA GUTTER
  2×8 FASCIA BD.
  2×4 SUB. FASCIA BD.
  1/2" ORIENTED STRAND BOARD
  VENTED SOFFIT
  (SEE CONTRACTOR)

#### <u>FLOORS</u>

- FL1. FINISHED FLOORING ON
  19/32" ORIENTED STRAND BOARD
  (FASTENED & GLUED TO FLOOR STRUCT. BELOW) ON
  2×10 FLOOR JOISTS @ 16" OR 12" O/C
  C/W 2×2 X-BRIDGING @ 7.0' O/C (MAX)
  1/2" GYPSUM BOARD
- FL2. B.C. BUILDING CODE (TABLE-9.10.3.1.B)
  RATED FLOOR ASSEMBLY F8D
  FINISHED FLOORING ON
  19/32" ORIENTED STRAND BOARD
  (FASTENED & GLUED TO FLOOR STRUCT. BELOW) ON
  2×10 FLOOR JOISTS @ 16" OR 12" O/C
  C/W 2×2 X-BRIDGING @ 7.0' O/C (MAX)
  R-31 INSULATION
  RESILIENT METAL CHANNELS @ 24" O/C
  1 LAYERS 5/8" X-TYPE GYPSUM BOARD
  30 MINUTE F.R.R., 50 S.T.C.
- FL3. FINISHED FLOORING ON
  19/32" ORIENTED STRAND BOARD
  (FASTENED & GLUED TO FLOOR STRUCT. BELOW) ON
  2×10 FLOOR JOISTS @ 16" OR 12" O/C
  C/W 2×2 X-BRIDGING @ 7.0' O/C (MAX)
  PROVIDE R-31 F/G BATT INSULATION IN
  JOIST CAVITY C/W
  BUILDING WRAP
  VENTED SOFFIT (TO OWNERS SPEC'S)
  TO ALL SUSPENDED FLOOR AREAS
- FL4. FINISHED FLOORING
  3 1/2" CONCRETE SLAB
  6 MIL. POLY'N V.B.
  6" COMPACTED GRAVEL OR SAND
- FL5. 3 1/2" CONCRETE SLAB
  6 MIL. POLY'N V.B.
  6" COMPACTED GRAVEL OR SAND
  SLOPE TO DOORS 1"
  (NOT IN SECTION)

  FL6. DECKING MEMBRANE
- FL6. DECKING MEMBRANE
  (TO COMPLY WITH CAN/CGSB 37.54) ON
  19/32" ORIENTED STRAND BOARD
  2×10 DECK JOISTS @ 16" O/C C/W
  (PROVIDE ADEQUATE MEMBRANE
  "UPSTAND" @ EXT. WALL.)
  (SLOPE JOISTS TO PROVIDE MIN.1:50 SLOPE)

#### <u>WALLS</u>

- W1. DOUBLE GLAZING ENERGY STAR LOW "E" RATING IN THERMAL BREAK FRAMES 2/2"X10" LINTEL OVER (@ BEARING WALLS ONLY) (TYPICAL, WI. 2 1/2" XPS INSULATION) FLASHING OVER @ EXTERIOR (GLAZING IN ALL EXTERIOR DOORS & WITHIN 3 FT. OF EXTERIOR DOORS TO BE SHATTERPROOF (SP)) WINDOW REQUIREMENTS DERIVED FROM BCBC TABLE C-5 AS PER BCBC 9.7.4.3. AND ARE TO BE USED TO SATISFY THE REQUIREMENTS OF AAMA/WDMA/CSA 101/I.S.2/A440, "NAFS": COLWOOD, CLASS R, DP 1440, PG 30, WATER RESIST. 220, A2, RATINGS MUST BE CLEARLY LABELED ON ALL WINDOW UNITS UPON INSTALLATION FOR INSPECTION.
- W2. CONC. FIBRE BOARD ON
  9.5MM (3/8") AIR SPACE / STRAPPING
  3/8"×2" BORATE TREATED PLYWOOD STRAPPING
  HOUSE WRAP (A.B.) (TYVEK OR EQ.)
  7/16" ORIENTED STRAND BOARD SHEATHING
  2×6 STUDS @ 16" O/C
  R-20 INSULATION
  6 MIL. POLYETHYLENE VAPOUR BARRIER
  1/2" GYPSUM BOARD
- W3. B.C. BUILDING CODE (TABLE 9.10.3.1.A)
  RATED WALL ASSEMBLY W3C
  1 LAYER 1/2" X-TYPE GYPSUM BOARD ON
  EACH SIDE OF 2×4 STUDS @ 16" O/C OR
  2×6 STUDS @ 16" O/C (IF NOTED)
  RESILIENT METAL CHANNELS ON ONE SIDE
  @ 400mm OR 600mm O.C. C/W
  3 1/2" FIBRE GLASS SOUND BATTS
  FRICTION FITTED AND SOLID FILLED
  45 MIN. F.R.R., 43 S.T.C.
  (BETWEEN PRIMARY LIVING & SECONDARY SUITE)

### **FOUNDATION**

- F1. DAMP PROOFING (WHERE REQUIRED) ON 8" THK. CONC. FOUNDATION WALL C/W 15 M BARS @ 24" O/C B/W
- F2. 16"X 8" CONC. FOOTINGS C/W 2 (TWO) 15M BARS CONT. 3 IN. FROM BOTT. ON UNDISTURBED SOIL (SOLID BEARING)
- F3. 4" PERIMETER DRAIN 3" TIGHT PIPE FOR RWL DRAIN ROCK
- F4. ANCHOR BOLTS @ 4.0 FT. O/C MAX C/W SILL GASKETS
- F5. UNDER SLAB INSULATION
  2 1/2" (RSI 2.15) EXTRUDED POLYSTYRENE
  RIGID INSULATION 4'-0" (1.2M)
  CONT. AROUND PERIMETER UNDER
  SLAB INSTALLED HORIZONTALLY
  (VERIFY WITH MUNICIPALITY DEPTH OF FROST LINE)
- F6. STEP DOWN TO GARAGE SLAB MAY VARY, VERIFY EXTENT ON SITE (NOT IN SECTION)

# volvictoria 9 design group

#103 - 891 ATTREE AVENUE VICTORIA, B.C. V9B 0A6 P. 250.382.7374 F. 250.382.7364

'FLEMMING' COASTAL

Date

June 2, 2023

Project Address
Royal Bay Sector 7
Verity Construction
3468 Trumpeter Street
Lot 64


Colwood, B.C. **Prepared for** 

Verity Construction

**Project #** 8298-64

**Scale**Not to Scale

Drawn By
MRB

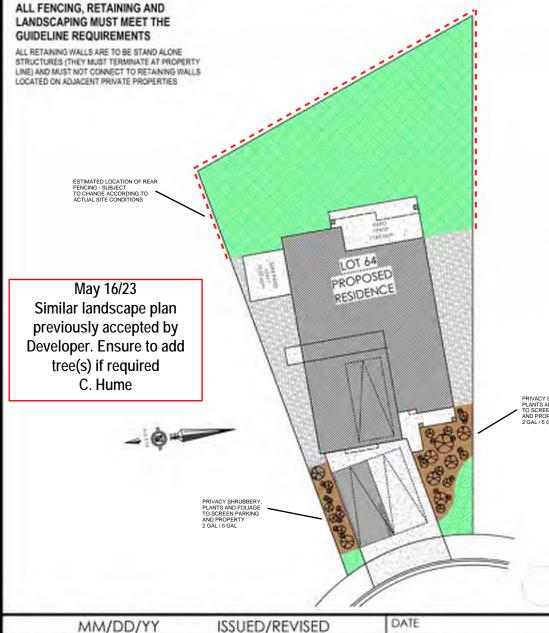

\*NOTE: In the interest of maintaining high standards, the developer reserves the right to modify plans, specifications and design without prior notice. Drawings contained within are artist renderings only. Sizes and dimensions are approximate and may vary with actual plan and survey. Exterior style may change pending municipal approval. Retaining wall location and types may vary and are subject to municipal, engineering or developer discretion. Subject to change without notice. Furniture as shown on plans are for layout purposes only and are not included in the sale.

| ITEM.   |            | AREA (st) | - %  |
|---------|------------|-----------|------|
| 6       | GARDEN BED | 336       | 875  |
| KELYV.  | GRAVEL     | 650       | 16%  |
| Marie P | CONCRETE   | 908       | 22%  |
|         | SOD        | 2,200     | 54%  |
|         | TOTAL      | 4,094     | 100% |

| LEGEND |   |   |  |
|--------|---|---|--|
|        | * | UPCRACE<br>GROWNEY FLANZS<br>AND TOUNGE<br>-2 CAL<br>-5 CAL |  |

PRIVACY SHRUBBERY, PLANTS AND FOLIAGE TO SCREEN PARKING

ALL FENCING, RETAINING AND LANDSCAPING MUST MEET THE **GUIDELINE REQUIREMENTS** i.e. metal fence where required etc.

WWW. BODDS Hold


LOCATION INDICATED BY

Typical Fence Detail Not To Scale

THE RESIDENCE AND DESCRIPTION OF THE RESIDENCE AND THE RESIDENCE A ADDITIONAL NOTES:

PROPERTY TO BE IRRIGATED 6" PIPE FOR DRIVEWAY SLEEVES TO BE INSTALLED FOR CITY IRRIGATION LINES

#### KEY PLAN NOT TO SCALE

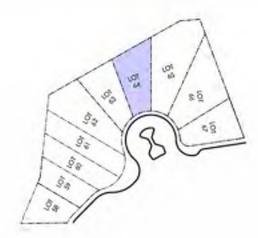

COMPANDAMENTAL



All trees and plank by the home owner to be

#### LANDSCAPE PLAN

#### NOT TO SCALE

## FOR APPROVAL 04/21/23 01

PROJECT

LANDSCAPING PLAN LOT 64, 3468 TRUMPETER ST. **ROYAL BAY, SECTOR 7** CITY OF COLWOOD



CONSTRUCTION

QUALITY CONSTRUCTION. TRUSTED SERVICE

106 - 1039 Langford Parkway Victoria, B.C. V9B 0A6

P: 250.474.1039 www.verityconstruction.ca

Food Name In the 30-00 min ratio Adjacent Convertig Medium

### GABLECTAST HOMES

#### **BUILDING GRADE SLIP**

| WSP | Project | No: | 201-08151-00 |
|-----|---------|-----|--------------|
|     | ,       |     |              |

C. Hume - June 14/23

|   |                                  | Issue Date:  |
|---|----------------------------------|--|
| MUNICIPAL ADDRESS 3468 Trumpeter Street   |                                  | P.I.D.   |
| LOT   |                                  | PLAN   |
| BUILDER   |                                  | SUBDIVISION  |
| VERITY HOMES  ADDRESS   |                                  | ROYAL BAY SECTOR 7 DEVELOPER   |
| REPRESENTATIVE  | PH.                              | MEADOWS DEVELOPMENT LP CONSULTANT  |
|   |                                  | WSP CANADA INC   |
| PROPOSED BUILDING GRADES  ALL ELEVATIONS ARE METRIC GEODETIC +  | <b>Y</b> //                      | PLAN LOT: 64 PLAN:   |
| MAIN FLOOR ELEVATION67.62   |                                  | [  |
| (TOP OF JOISTS)  FRONT FLEV 67.34 REAR FLEV 67.42   | JOIST<br>DEPTI                   |  |
| FRONT ELEV. 67.34 REAR ELEV. 67.42 (FINISHED GRADE)   |                                  |  |
| FINISHED GRADE AT GARAGE 67.42  | N                                |  |
|   | <br>                             |  |
|   | HEA                              |  |
| ACTUAL TOP OF FOOTING not provided ELEVATION (ATF)  |                                  | . 64   |
| LOWEST PERMITTED TOP OF   | FLOOR SLA                        |  |
| (BOTTOM OF BASEMENT SLAB<br>FROST WALLS ARE REQUIRED.)  |                                  | GFE 67.44<br>MSE 64.36<br>S 163.87   |
| SERVICES FRONT REAR CENTER  | REFER SIZE                       | D [64.88]<br>BFT   |
| WATER   | TO PLAN (mm)                     |  |
| SANITARY  | 100                              | (a) (a) (a) (b) (c) (c) (d) (d) (d) (d) (d) (d) (d) (d) (d) (d   |
| STORM   | 100                              | 5 ROAD B   |
|   |                                  |  |
| COMMENTS  | YES NO                           |  |
| DRAIN TO SUMP PUMP LIKELY REQUIRED (FOR BASEMENT IF INSTALLED)  |                                  | LEGEND   |
| SEWER TO SUMP PUMP LIKELY REQUIRED (FOR BASEMENT IF INSTALLED)  |                                  | STREET   |
| SERVICES INSTALLED TO m INSIDE PROPERTY .   |                                  |  |
| FOUNDATION SOIL BEARING INVESTIGATION CERTIFICATION REQUIRED  |                                  | SROW (SHOWN ON ABOVE PLAN)   |
| GEOTECHNICAL RESTRICTIONS APPLY   |                                  |  |
| (SEE GEOTECHNICAL REPORT)   |                                  | L# 6  L# 6  L# 6  L# 6   |
| (SEE ENVIRONMENTAL REPORT)  |                                  | $\begin{bmatrix} 1.0 \\ 0.0 \end{bmatrix}$ EG 49.90 $\begin{bmatrix} 0.0 \\ 0.0 \end{bmatrix}$ — EXISTING GROUND ELEVATION   |
| UTILITY EASEMENTS AFFECT THIS LOT   |                                  | LFE/MFE 47.70 - LOWER/MAIN FLOOR ELEVATION GFE 47.55 - GARAGE FLOOR ELEVATION  |
|   |                                  | MSE 52.20 — MINIMUM SANITARY SERVICABLE ELEVATION BY GRAVITY   |
|   |                                  | S 49.12 (P) D 49.12 (P) S 49.12 (P) D 5 49.12 (P) D 6 10 10 10 10 10 10 10 10 10 10 10 10 10   |
|   |                                  | FOR BASEMENT IF INSTALLED  STORM SERVICE INV.  |
|   |                                  | (P) DENOTES PUMP IS LIKELY REQUIRED FOR BASEMENT IF INSTALLED  |
|   |                                  | PROPOSED REAR SIDE YARD GRADES    Control of the co |
| NOTES   |                                  | - LOT TYPE (L/LB/LBT)  |
| <ol> <li>IT IS THE RESPONSIBILITY OF THE BUILDER TO<br/>ARE PLACED ON A PROPER BASE THAT IS FRE<br/>EXCESSIVE MOISTURE AND DELETERIOUS MATER<br/>APPROPRIATE FROST PROTECTION WHEN COMPL</li> </ol> | EE FROM FROST,<br>RIALS AND HAVE | LANE/LOT   |
| THE INFORMATION CONTAINED HEREIN IS BASEL<br>LOT GRADING PLAN FOR THIS SUBDIVISION. UI  | O ON THE APPROVED                |  |
| DEVIATIONS WILL BE THE RESPONSIBILITY OF TI<br>ENSURE COMPLIANCE WITH ALL LOCAL BYLAWS  | HE BUILDER TO                    | I, THE BUILDER'S REPRESENTATIVE,  CERTIFY THAT THE FINAL HOUSE PLANS PROVIDED IN THE BUILDING PERMI  |
| 3. OTHER NOTES:   |                                  | APPLICATION ARE THE SAME AS PROCESSED UNDER THIS GRADE SLIP AND THAT I UNDERSTAND THE INFORMATION AND THE REQUIREMENTS CONTAINED HEREIN AND WILL BUILD ACCORDINGLY.  |
|   |                                  |  |
|   |                                  | AUTHORIZED BUILDER'S REPRESENTATIVE DAT  |
|   |                                  | THE INFORMATION CONTAINED HEREIN IS BASED ON THE APPROVED LOT GRADING PLAN FOR THIS SUBDIVISION, DATED   |