

CITY OF COLWOOD

3300 Wishart Road | Colwood | BC V9C 1R1 | 250-294-8153 planning@colwood.ca | www.colwood.ca

File: DP-23-001

DEVELOPMENT PERMIT DP-23-001

THIS PERMIT, issued May 4 2023 is,

ISSUED BY:

CITY OF COLWOOD, a municipality incorporated under the Local Government Act,

3300 Wishart Road, Victoria, BC, V9C 1R1

(the "City")

PURSUANT TO:

Section 490 of the Local Government Act, RSBC 2015, Chapter 1

ISSUED TO:

Verity Construction Ltd

106-1039 Langford Parkway

Victoria, BC V9B 0A6

(the "Permittee")

1. This Form and Character Development Permits applies to those lands within the City of Colwood described below, and any and all buildings, structures, and other development thereon:

Lots 49 – 51 & 53 – 54 PLAN EPP117070 SECTION 38 ESQUIMALT 3471, 3473, 3475, 3479 and 3481 Trumpeter Street

(the "Lands")

- 2. This Development Permit regulates the development and alterations of the Land, and supplements the "Colwood Land Use Bylaw, 1989" (Bylaw No. 151), to ensure the form & character considerations for 5 single family homes with secondary suites and associated site improvements are consistent with the guidelines for areas designated as "Neighbourhood Intensive Residential" in the City of Colwood Official Community Plan (Bylaw No. 1700).
- 3. This Development Permit is **NOT** a Building Permit or a subdivision approval.
- This Development Permit is issued subject to compliance with all of the bylaws of the City of Colwood that apply to the development of the Lands, except as specifically varied by Council or supplemented by this Permit, including DP-21-008.
- The Director of Development Services or their delegate may approve minor variations to the schedules attached to and forming part of this Development Permit, provided that such minor

variations are consistent with the overall intent of the original plans and do not alter the form and character of the development authorized by those plans.

- 6. If the Permittee does not substantially start the construction permitted by this Permit within 24 months of the date of this Permit, the Permit shall lapse and be of no further force and effect.
- 7. The development is to be constructed in accordance with the following plans and specifications, which are attached to and form as part of this permit:

Schedule 1	Geotechnical Report prepared by MGE Services Inc. revised May 5, 2023.
Schedule 2	Site Plan, Architectural Drawings, Elevation Drawings, Landscape Plan, and
	Grading Plan for 3471 Trumpeter Street dated December 22, 2022.
Schedule 3	Site Plan, Architectural Drawings, Elevation Drawings, Landscape Plan, and
	Grading Plan for 3473 Trumpeter Street dated December 22, 2022.
Schedule 4	Site Plan, Architectural Drawings, Elevation Drawings, Landscape Plan, and
	Grading Plan for 3475 Trumpeter Street dated April 27, 2023.
Schedule 5	Site Plan, Architectural Drawings, Elevation Drawings, Landscape Plan, and
	Grading Plan for 3479 Trumpeter Street dated April 21, 2023.
Schedule 6	Site Plan, Architectural Drawings, Elevation Drawings, Landscape Plan, and
	Grading Plan for 3481 Trumpeter Street dated March 15, 2023

8. This Development Permit authorizes land alterations for the construction of 5 single family homes with secondary suites along with any associated site works. The Land shall not be altered, nor any buildings or structures constructed, except in accordance with the following conditions:

FORM AND CHARACTER CONDITIONS

Building Features

- 8.1. The form and character of the buildings to be constructed on the Lands shall conform to the Site Plan, Architectural Drawings and Elevation Drawings prepared by Victoria Design Group (Schedules 2-6).
- 8.2. Within any group of three adjacent homes on the lands, no two houses shall have the same dwelling unit design.
- 8.3. Any future additions of telecommunications antennas or equipment to the exterior of the buildings and/or structures included in this Permit shall be architecturally integrated into the buildings and/or structures they are mounted on or screened from views so as not to be visually obtrusive, to the satisfaction of the Director of Development Services.
- 8.4. No future construction/installation of unenclosed or enclosed outdoor storage areas, and recycling/refuse collection and storage areas shall be undertaken without the issuance of a further Development Permit or amendment to this Permit.
- 8.5. All mechanical roof elements, including mechanical equipment, elevator housings, and vents shall be visually screened with sloped roofs or parapets, or other forms of solid screening to the satisfaction of the Director of Development Services.

Landscaping

8.6. The design and construction of the proposed landscaping shall be in substantial compliance with the Landscape Plan prepared by Verity Construction (Schedules 2-6).

Grading

- 8.7. Lot preparations shall be in compliance with the site-specific grading plan by Gablecraft Homes as part of Schedules 2-6.
- 8.8. All cut and fill expectations must be in substantial compliance with the Site Sections by Victoria Design Group as part of Schedules 2-6.
- 8.9. Recommendations from the geotechnical report (Schedule 1) must be followed.
- 8.10.Retaining walls are not to connect with neighbouring properties and be a maximum height of 1.2m.

ISSUED ON THIS Z DAY OF MAY, 2023.

YAZMIN HERNANDEZ

DIRECTOR OF DEVELOPMENT SERVICES

April 3, 2023 File: 23V-003

Schedule 1

Verity Construction Ltd. 106-1039 Langford Parkway

Victoria, BC

V9B 0A5

Attention:

Ms. Patricia Gomes

RE:

Proposed House Construction

Lots 49 to 54, Trumpeter Street (Sector 7, Royal Bay), Colwood

Geotechnical Assessment Report

INTRODUCTION

As requested by Verity Construction Ltd. (the Client), MGE Services Inc. (MGE) has carried out a geotechnical assessment for six lots within the residential subdivision at the above-referenced site. The site was developed as part of the Royal Bay subdivision in Colwood, BC. Review of the Geotechnical Assessment Report for the Sector 7 Subdivision where the subject lots are located (prepared by Thurber Engineering Ltd. (Thurber) dated February 4, 2022) was carried out as part of our site review. This geotechnical report has been prepared as part of the development permit application specifically for Lots 49 to 54 within Sector 7 at the Royal Bay subdivision in Colwood.

The Royal Bay subdivision is located within a former gravel pit within the Colwood Outwash deposit. The subgrade within the subject sites consist of well-graded, pit run sand and gravel that was placed as part of the gravel pit reclamation following closure in 2008. MGE conducted site walkover of the subject lots in March 2023, at which time the lots were prepared to the approximate footing grade, with slopes extending up at the rear of the site. Grading of the existing slopes was prepared by the developer of the Royal Bay subdivision, which is proposed to be altered by the Client to achieve the house designs prepared for Lots 49 to 54.

MGE has conducted visual review of the subject lots, as documented in the attached Table 1 – Site Photos. The lot layout is shown in the attached Comprehensive Site Plan provided by the Client, with cross sections of the final grading on Lots 52, 53 and 54 (where existing retaining walls are located or new retaining walls are proposed) also attached to this report. This geotechnical assessment has been prepared in support of the development permit application prepared by the Client for single family houses to be constructed on the six subject lots.

PROJECT / SITE CONDITIONS

The proposed development includes six detached, single family homes that will be constructed with slabon-grade foundations and with either full or partial step up backyards. Due to the grading, which slopes down from west to east, the houses are to be constructed with foundation walls increased to provide support for backyards that will be approx. 1m above the front yard elevations at the Lot 49 end of these EGBC Permit to Practice No. 1003085

Revised May 5, 2023

April 3, 2023 File: 23V-003

740 Cowper Street, Victoria, BC V9A 2E9 250-661-8335

MGEservices@shaw.ca

subject lots, grading up to approx. 3m above the front yard at Lot 54. It is understood that there will be retaining walls required between the house foundations at accommodate the grade changes between the front and rear yards of the subject lots. These walls are proposed to be stacked boulder walls constructed in tiers to a maximum height of 1.2m, as per City of Colwood requirements. Backfilling of the walls will be carried out with site-excavated pit run sand and gravel that is free-draining and suitable for positive drainage. A cross section schematic of the boulder wall is provided as Drawing 1.

Our review of open excavations onsite indicate that the lots are underlain by dense, native sand and gravel, which is consistent with the local geology mapping that shows the site to be within the Colwood Outwash deposit. The surface of the pit run sand and gravel has been disturbed since initial subdivision development and will require further site preparation, as per recommendations provided herein.

GEOTECHNICAL RECOMMENDATIONS

Based on our review of the subsurface conditions, the development of six single family houses is considered geotechnically appropriate. The native sand and gravel is considered suitable for providing bearing of the house foundations and associated retaining walls. It is recommended that building foundation design be based on a 100 kPa allowable bearing capacity, as determined by independent calculations. The sand and gravel subgrade is expected to require re-compaction, which is recommended to be carried out with a 10 tonne, steel drum, vibratory roller. MGE should be contacted to carry out review of the sand and gravel subgrade prior to foundation construction or structural filling, as needed by final grading.

If structural filling is required, the excavated sand and gravel material from the site is considered suitable for re-use based on past experience with the Colwood Outwash deposit. It is recommended that the sand and gravel is placed in maximum 300mm thickness lifts and thoroughly compacted with the vibratory roller. The extent of structural filling should be outside the building footprint or road alignment by at least the thickness of the fill, ie. a 1H:1V splay. As per the BC Building Code, MGE needs to carry out continuous monitoring of structural fill placement procedures to provide subgrade approval for the building foundations.

As discussed above, re-grading at the rear of the lots, specifically Lots 52 to 54 will be carried out following foundation construction and is shown in the Cross Sections attached to this report. New retaining wall construction will be necessary and is proposed to be limited to a maximum height of 1.2m to meet City of Colwood bylaw requirements. It is proposed to construct the retaining walls proposed on the site with stacked boulders, which are recommended to be sloped back at ½H:1V and oriented such that the long axis of the boulder extends back into the slope. Backfilling should be carried out with free-draining material, such as the sand and gravel observed onsite. MGE can provide further detail on retaining wall review as necessary. The attached Drawing 1 provides details on stacked boulder wall construction.

April 3, 2023 File: 23V-003

740 Cowper Street, Victoria, BC V9A 2E9 250-661-8335

MGEservices@shaw.ca

CLOSURE

Our geotechnical assessment of the project site and the proposed development indicates that the lands are considered safe and suitable for the use intended. MGE to carry out field reviews during site preparation to confirm the intent of our geotechnical recommendations is met.

This letter has been prepared exclusively for Verity Construction Ltd. in accordance with the January 3, 2023 contract between MGE and Verity Construction Ltd. No third party can rely on this report, except for the City of Colwood, which is considered to be an authorized user, subject to the terms and conditions under which the work was completed.

We trust this meets your current requirements and ask that you contact the undersigned if there are any questions or concerns.

Yours truly,

MGE Services Inc.

Per: Alec Morse, P.Eng.

Attach: Table 1 – Site Photos

Comprehensive Site Plan

Cross Sections – Lots 52, 53 & 54 Drawing 1 – Boulder Wall Schematic



Table 1 – Site Photos Project: Lots 49 – 54, Trumpeter Street, Royal Bay

Verity Construction Ltd. File: 23V-003



Apr. 1, 2023: Current condition of Lot 49, with pit run sand and gravel exposed as subgrade.



Apr. 1, 2023: Current condition of Lot 50, with pit run sand and gravel exposed as subgrade.



Apr. 1, 2023: Current condition of Lot 51, with pit run sand and gravel exposed as subgrade.



Apr. 1, 2023: Current condition of Lot 52, with pit run sand and gravel exposed as subgrade.




Apr. 1, 2023: Current condition of Lot 53, with pit run sand and gravel exposed as subgrade.



Apr. 1, 2023: Current condition of Lot 54, with pit run sand and gravel exposed as subgrade.



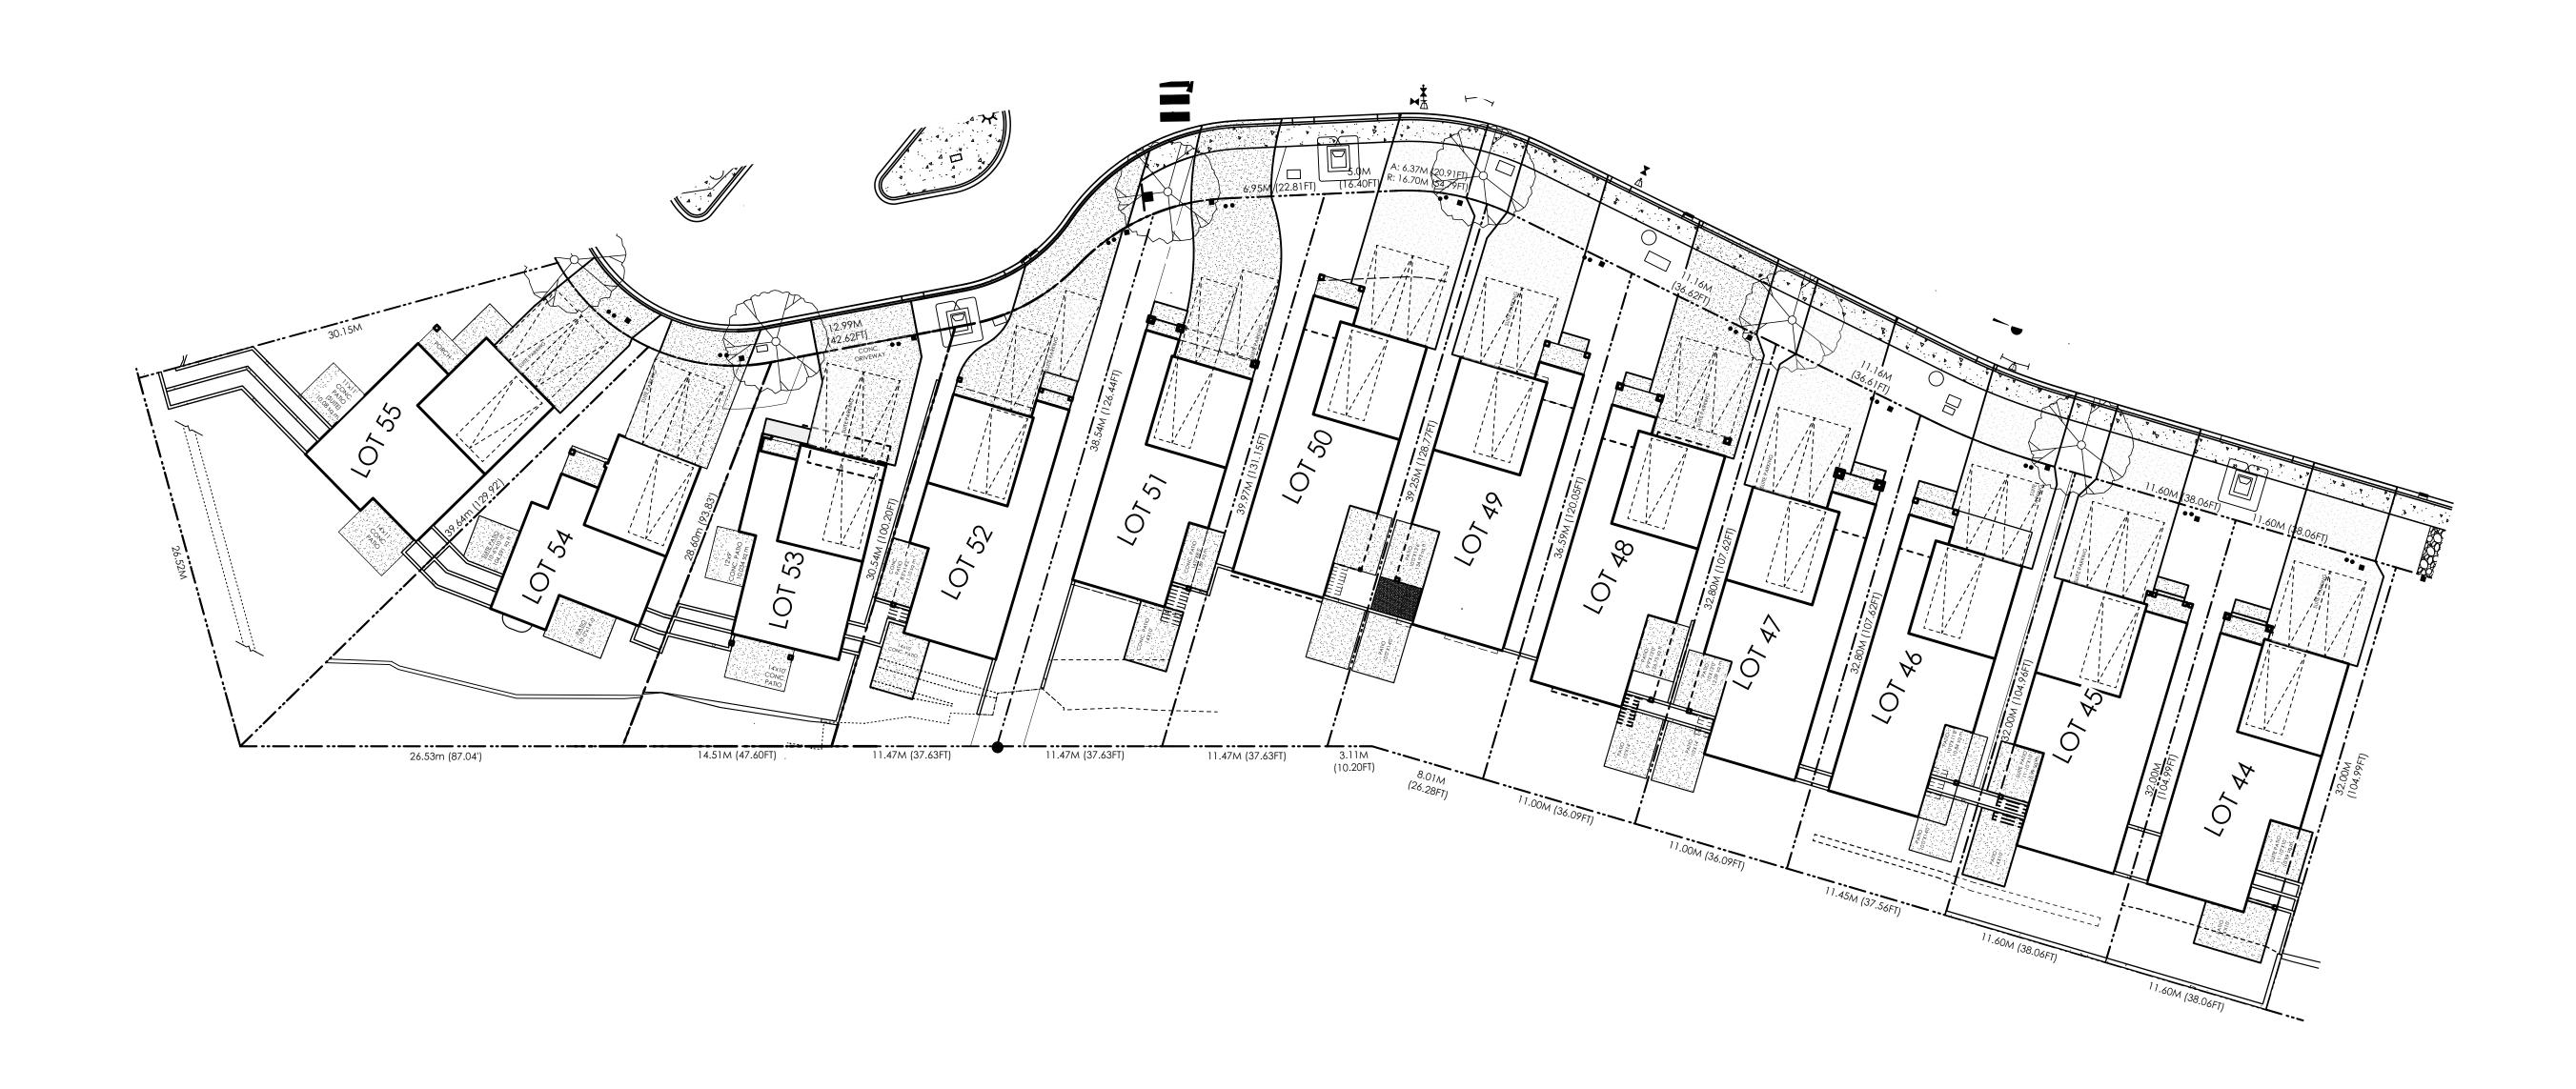

Date

May 2, 2023

Project Address

Royal Bay Sector 7 Colwood, B.C.

Prepared for

Verity Construction

Project

8298-Sector 7


Scale


1:250

Drawn By

MDK/MRB

Comprehensive Site Plan

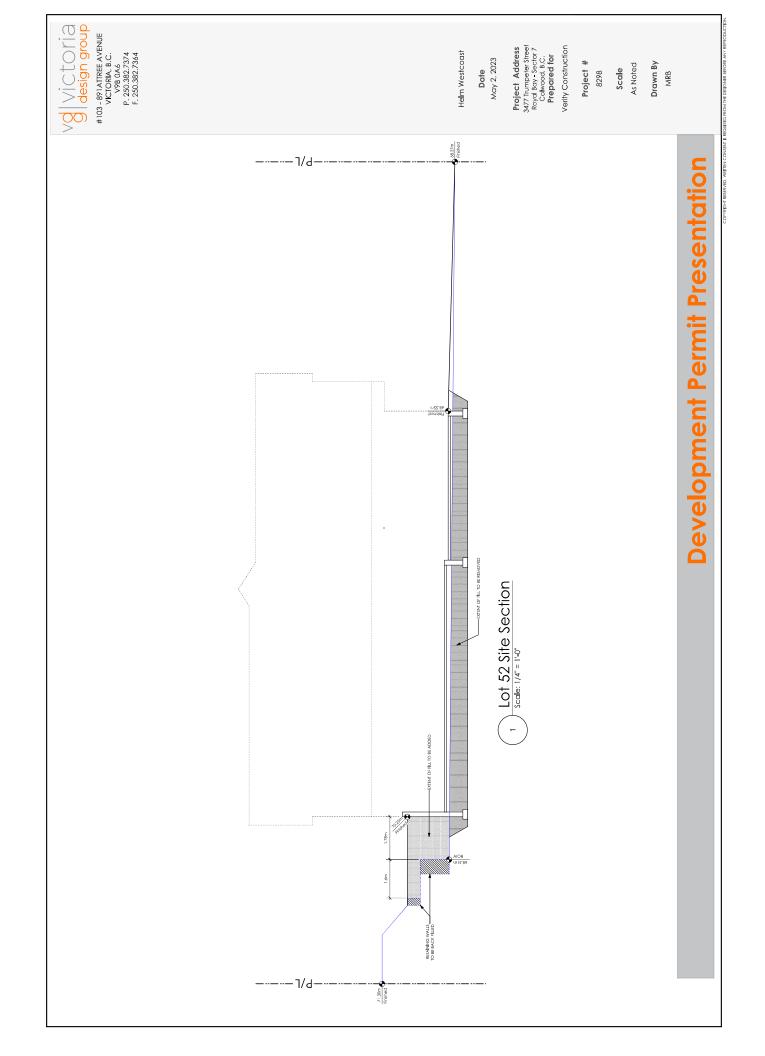

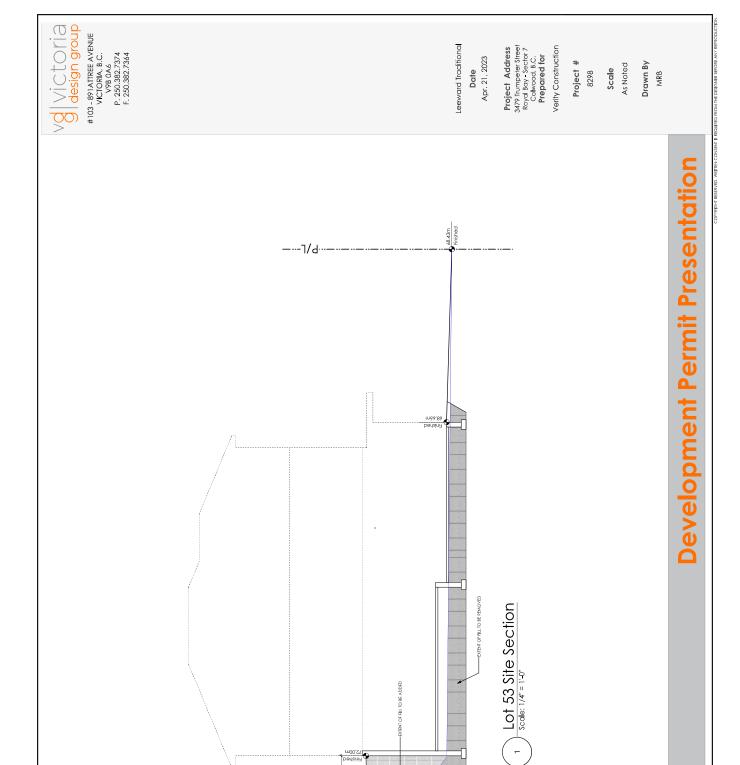

----1/d·---

72.98m Finished WO Gesign group
#103-891attree avenue
vyerora, B.C.
vyerosac, P. 250.382.7374
F. 250.382.7344 Project Address
348 Trumpeter Steet
Royal Bay - Sector 7
Cokwood, B.C.
Prepared for
Verity Construction GENOA WESTCOAST March 15, 2023 Drawn By MDK Project # As Noted 8298-54 Scale


3.71m


–1/d.


74.0m Finished

Development Permit Presentation

Lot 54 Site Section Scale: 1/4" = 1-5"

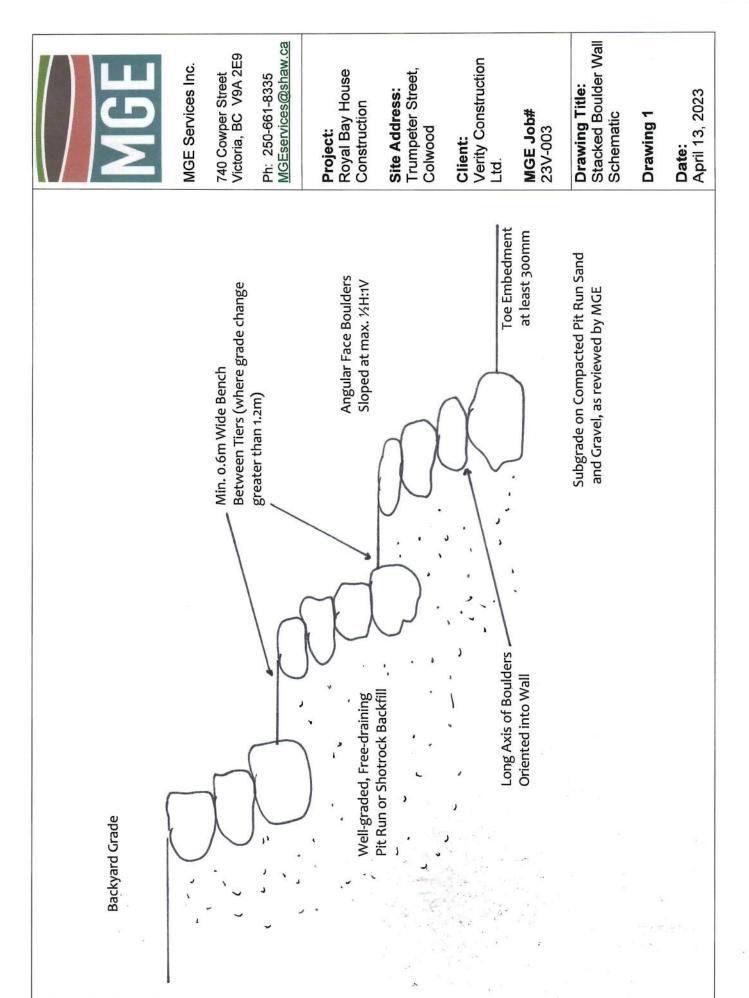

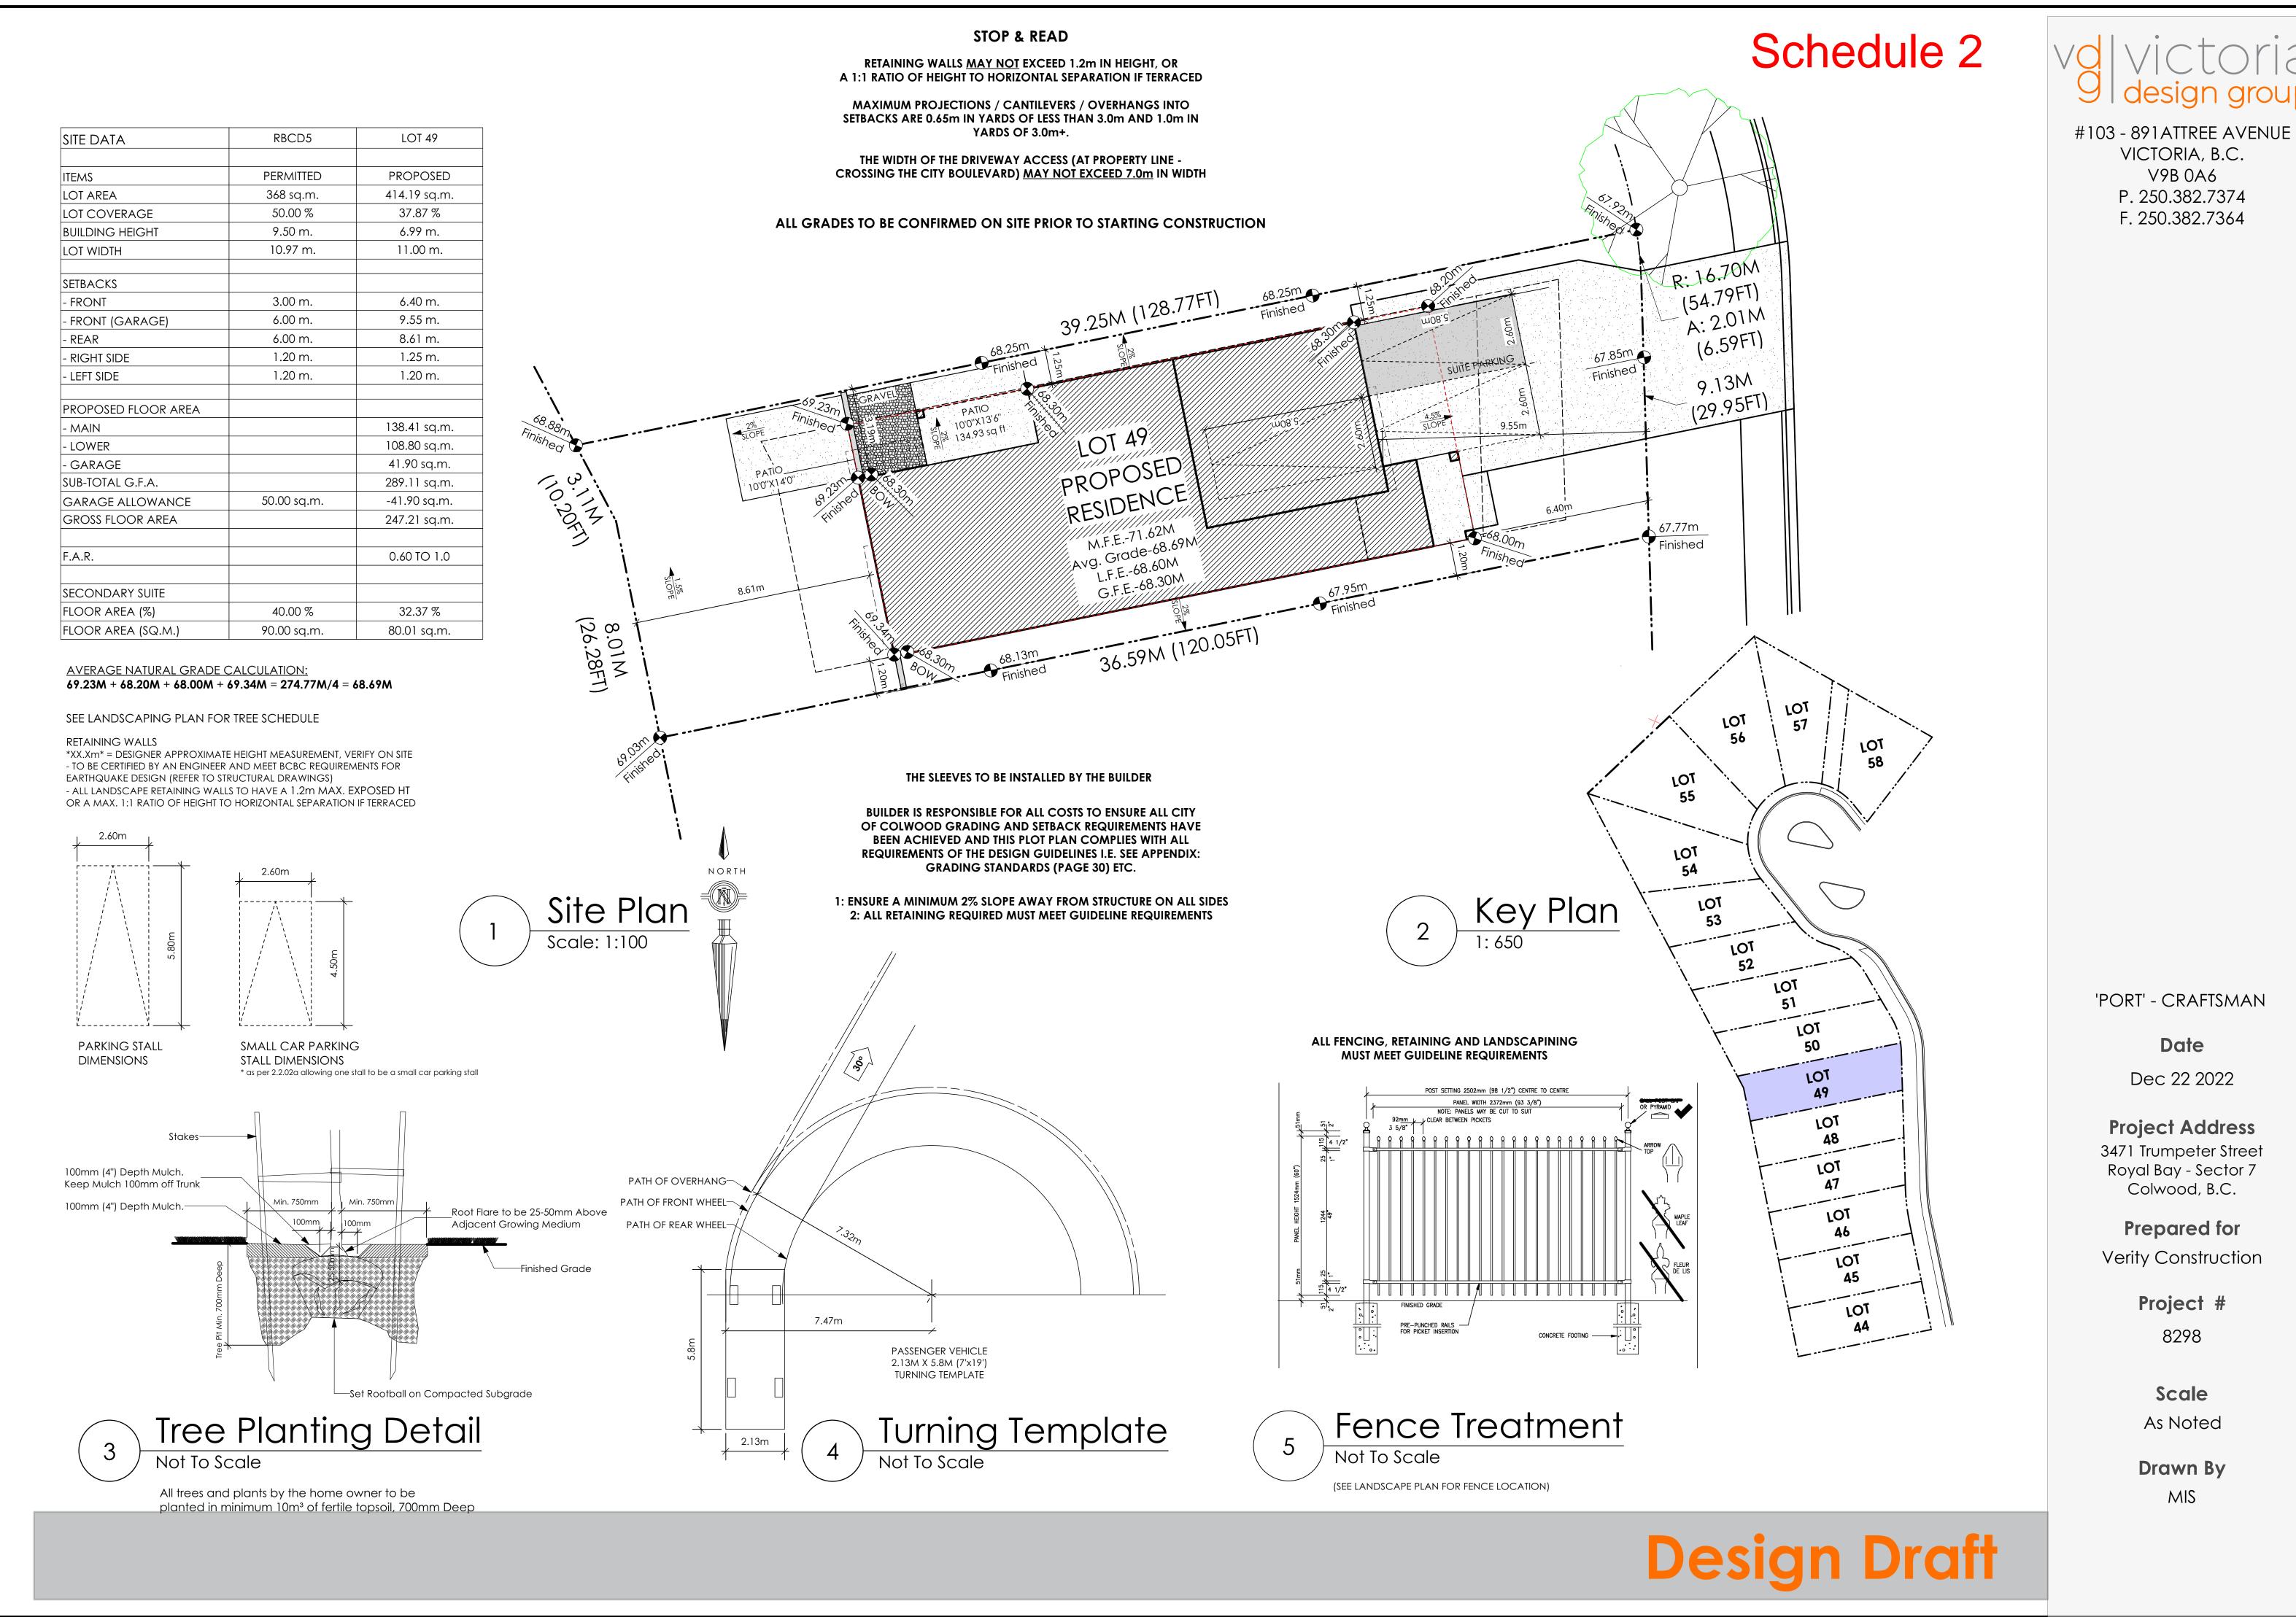

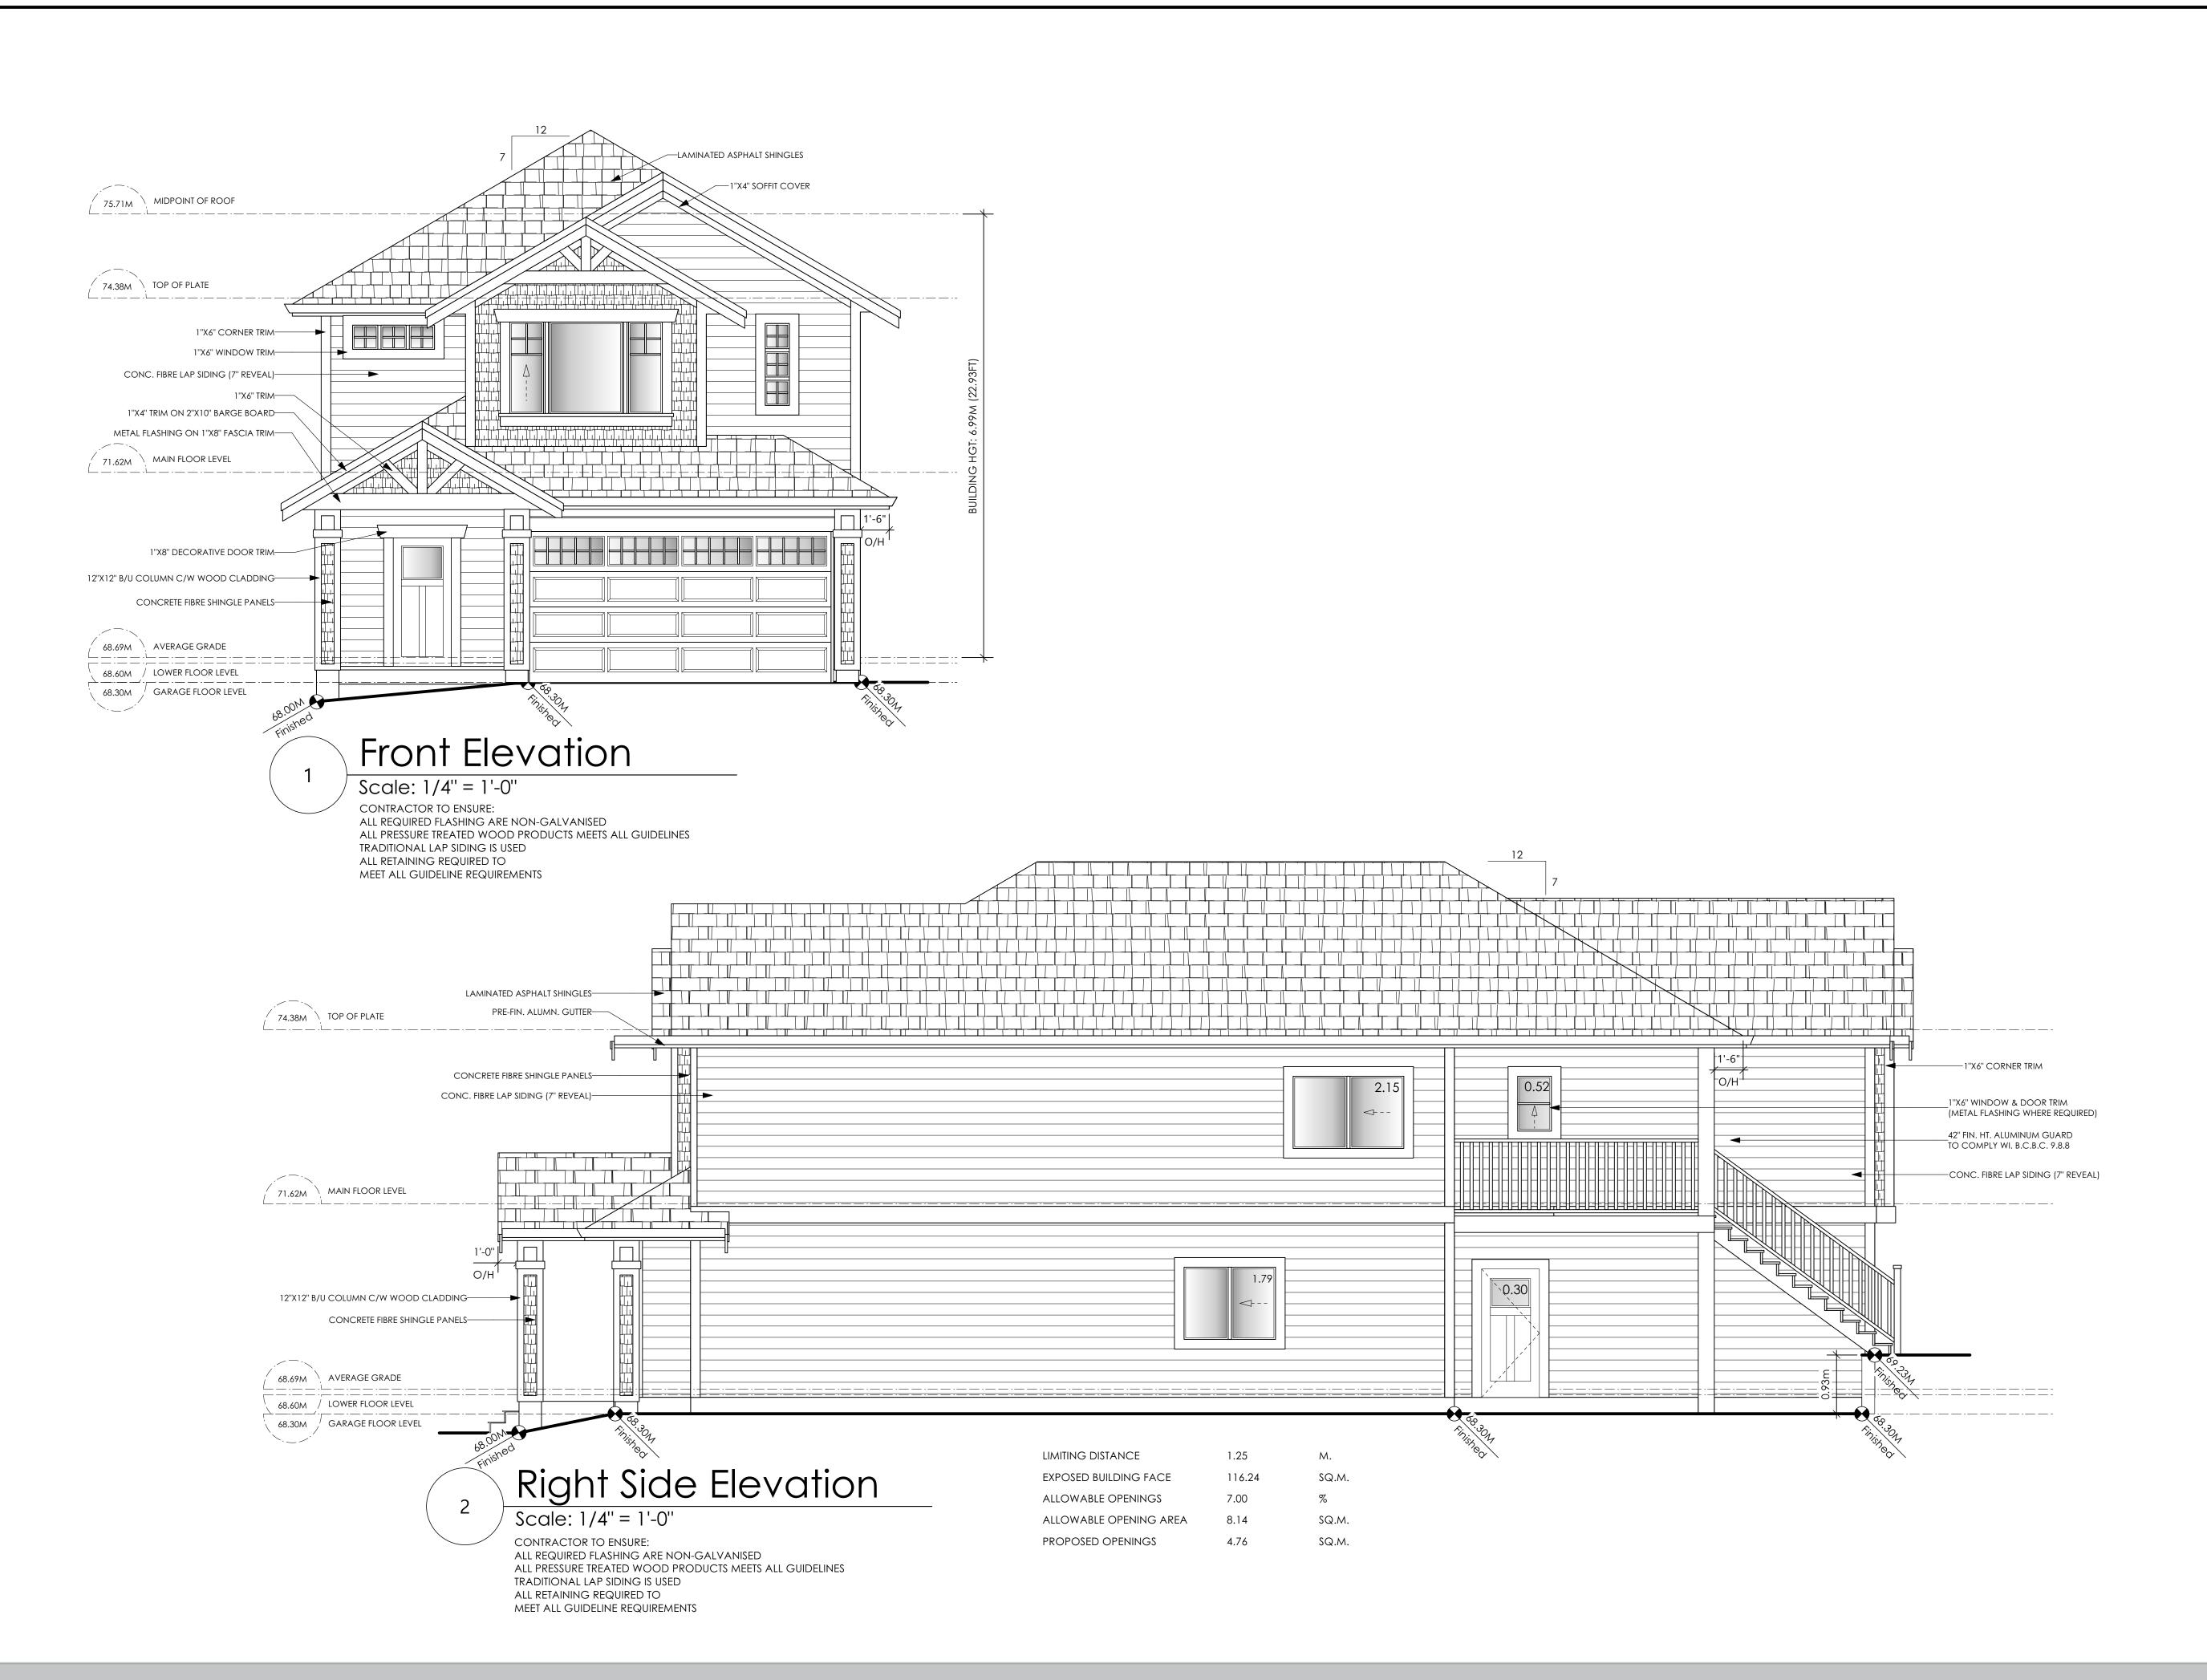



'PORT' - CRAFTSMAN

Date

Dec 22 2022

Project Address
3471 Trumpeter Street
Royal Bay - Sector 7
Colwood, B.C.

Prepared for Verity Construction

Project #


8298

ScaleAs Noted


Drawn By
MIS


Design Draft



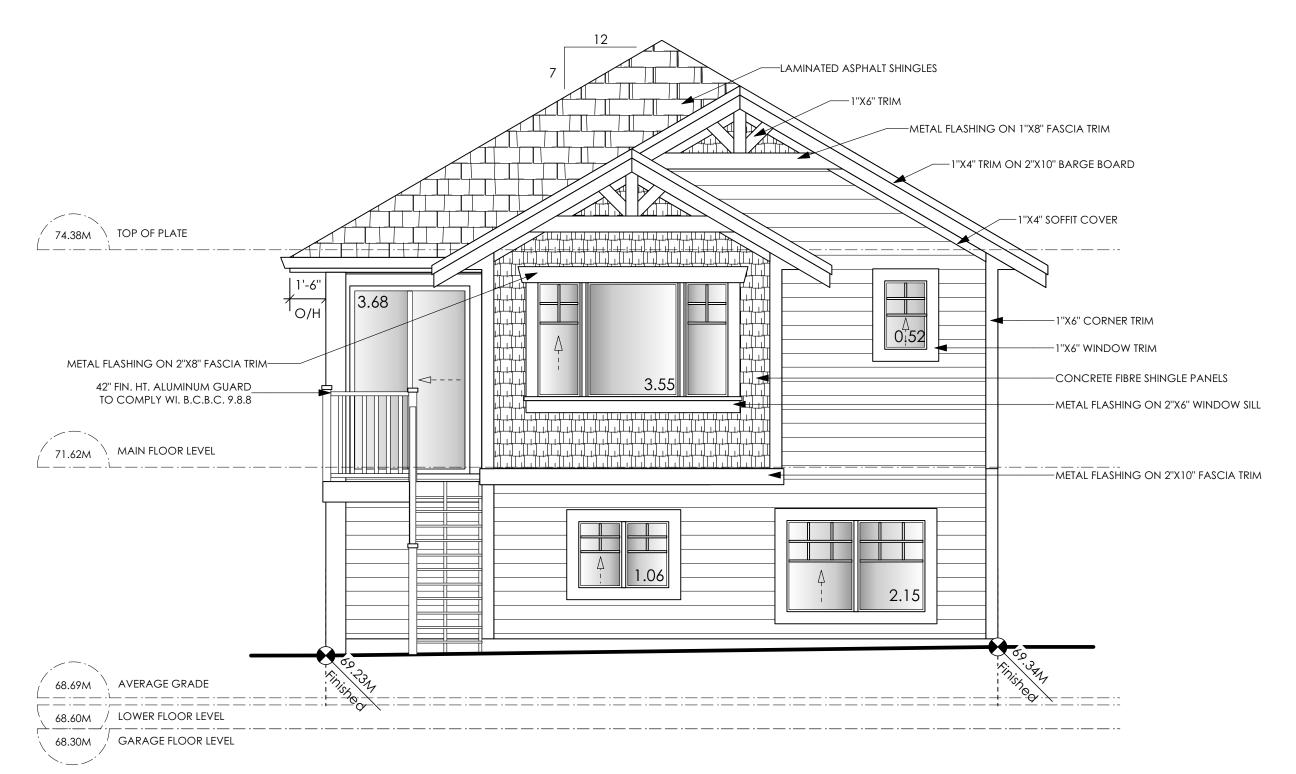

ALL RETAINING REQUIRED TO MEET ALL GUIDELINE REQUIREMENTS

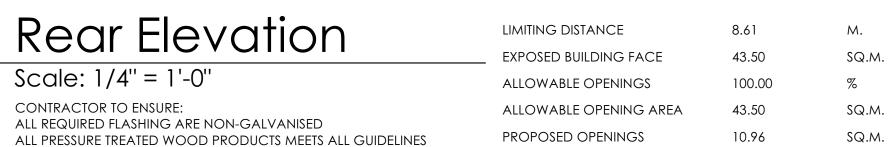

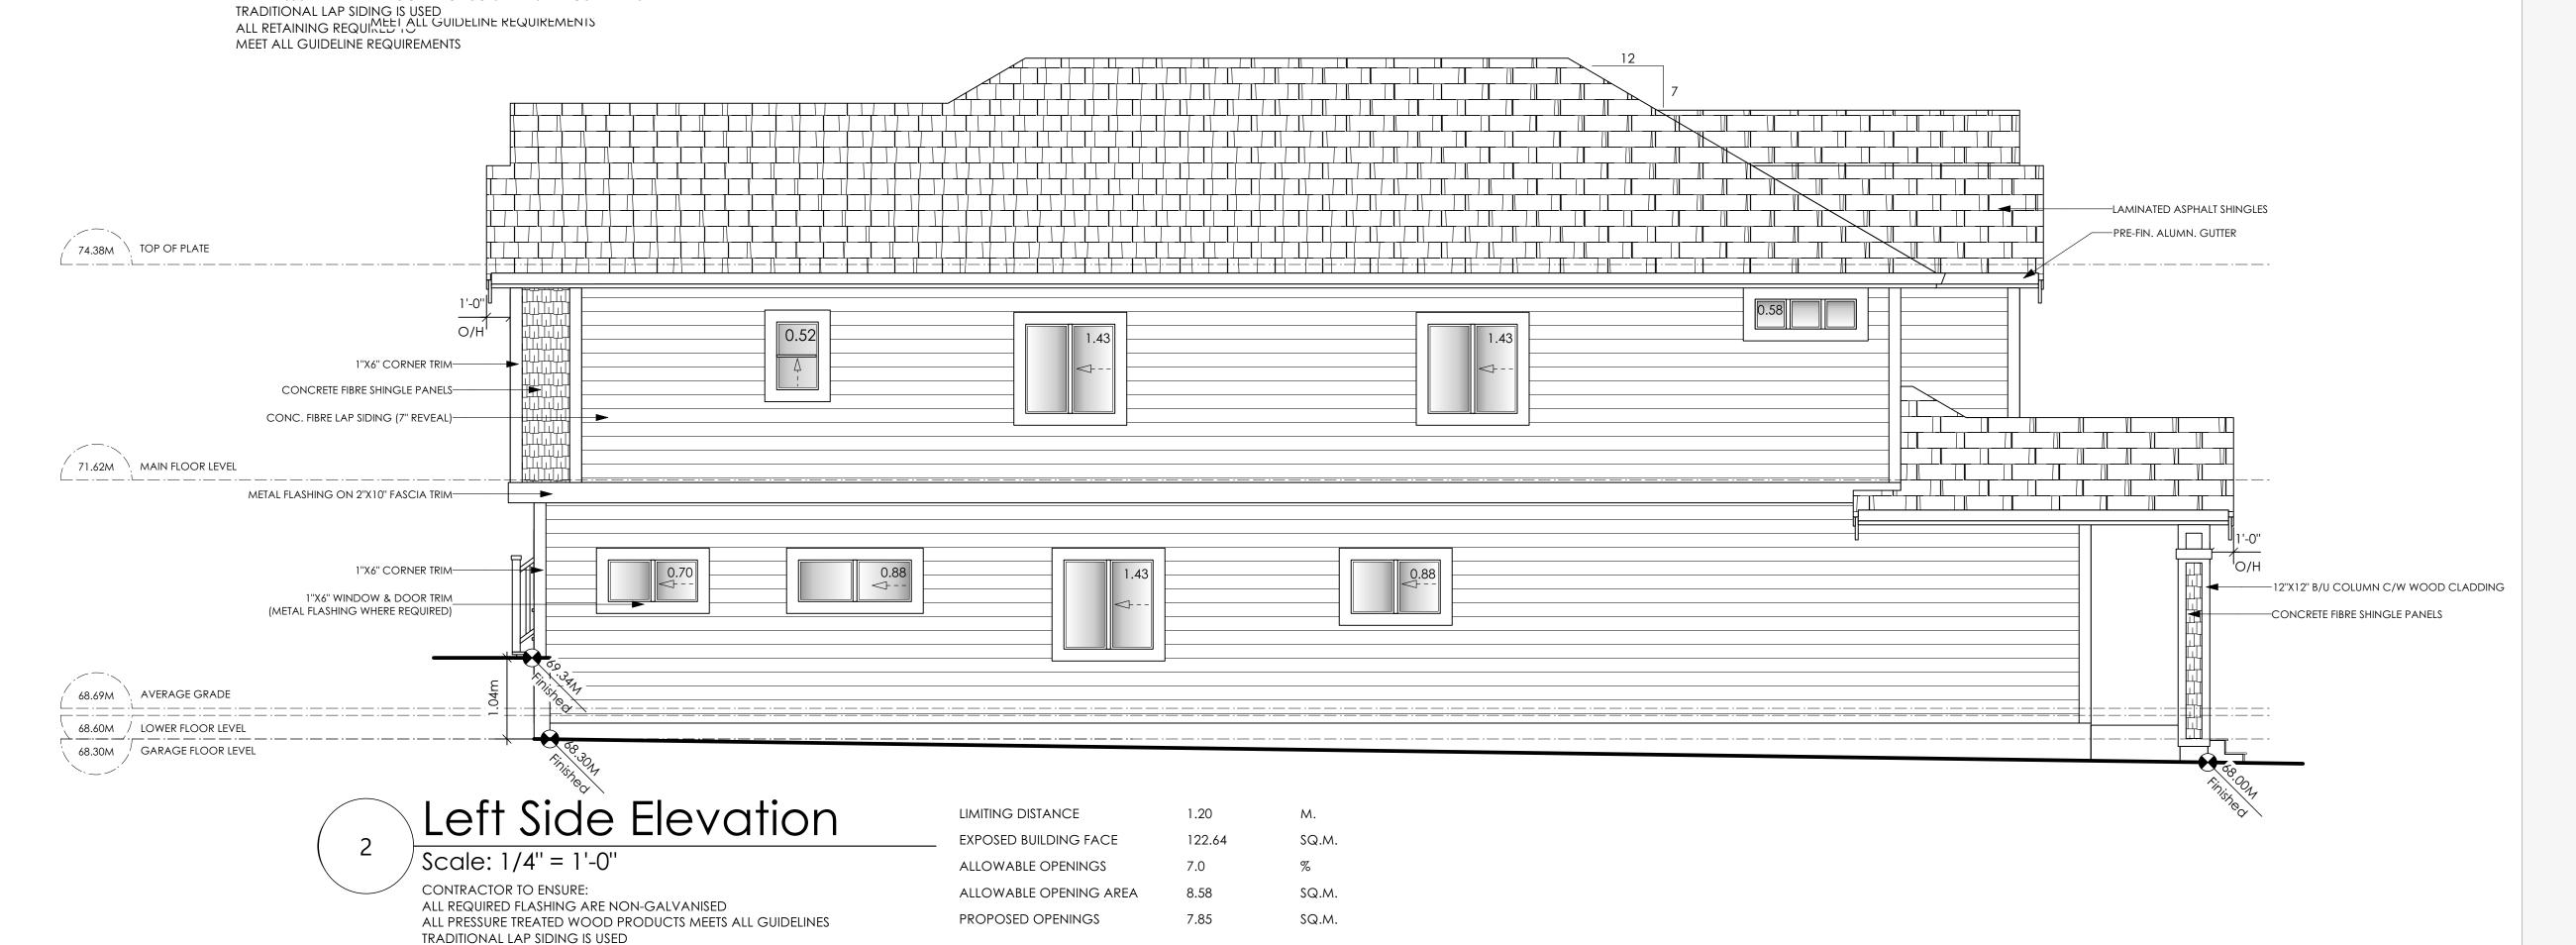

'PORT' - CRAFTSMAN

Date

Dec 22 2022

Project Address
3471 Trumpeter Street
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Colwood, B.C.

Prepared for

Verity Construction

Project #


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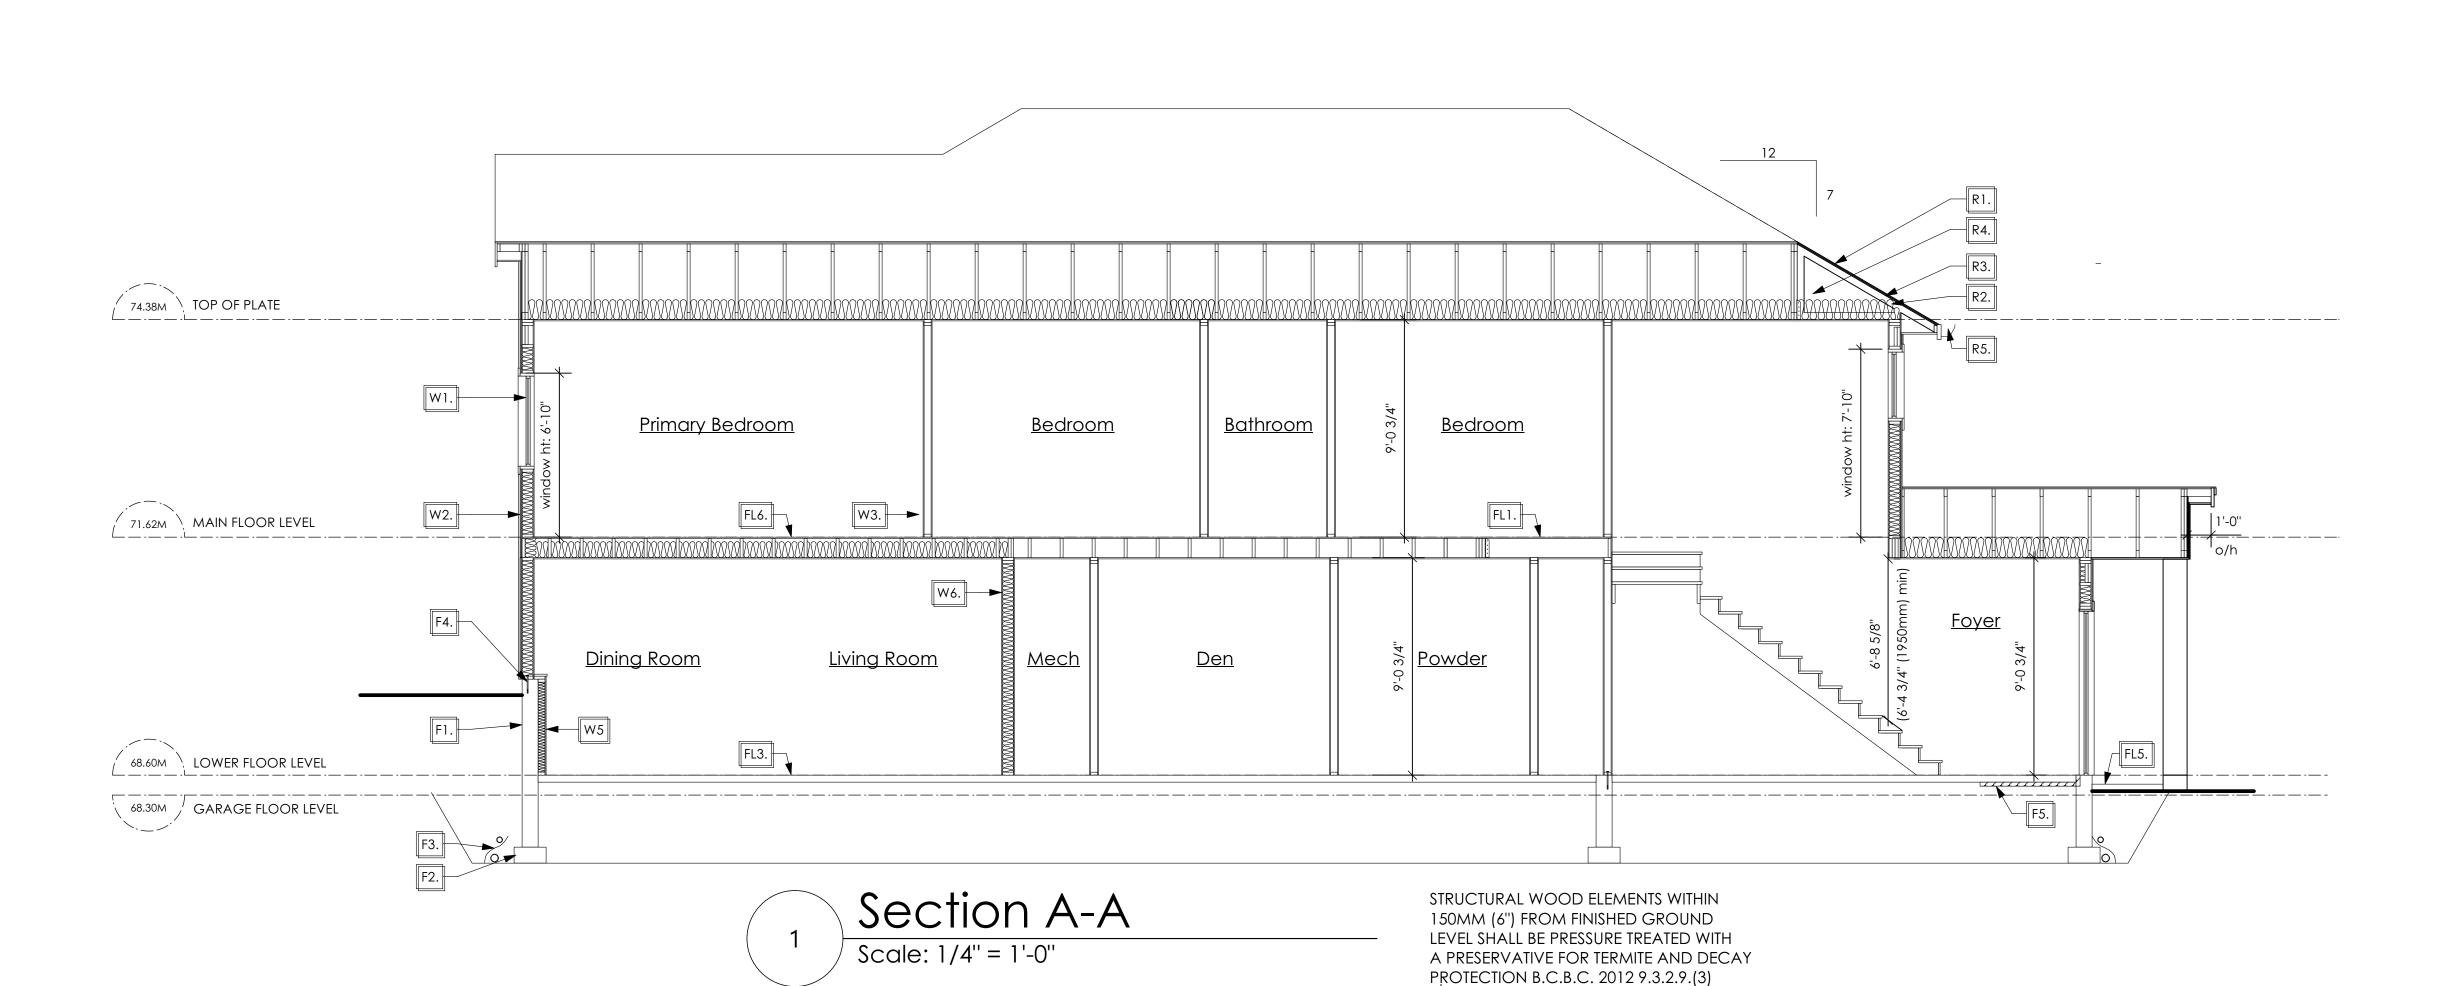
Scale

As Noted

Drawn By
MIS

Design Draft



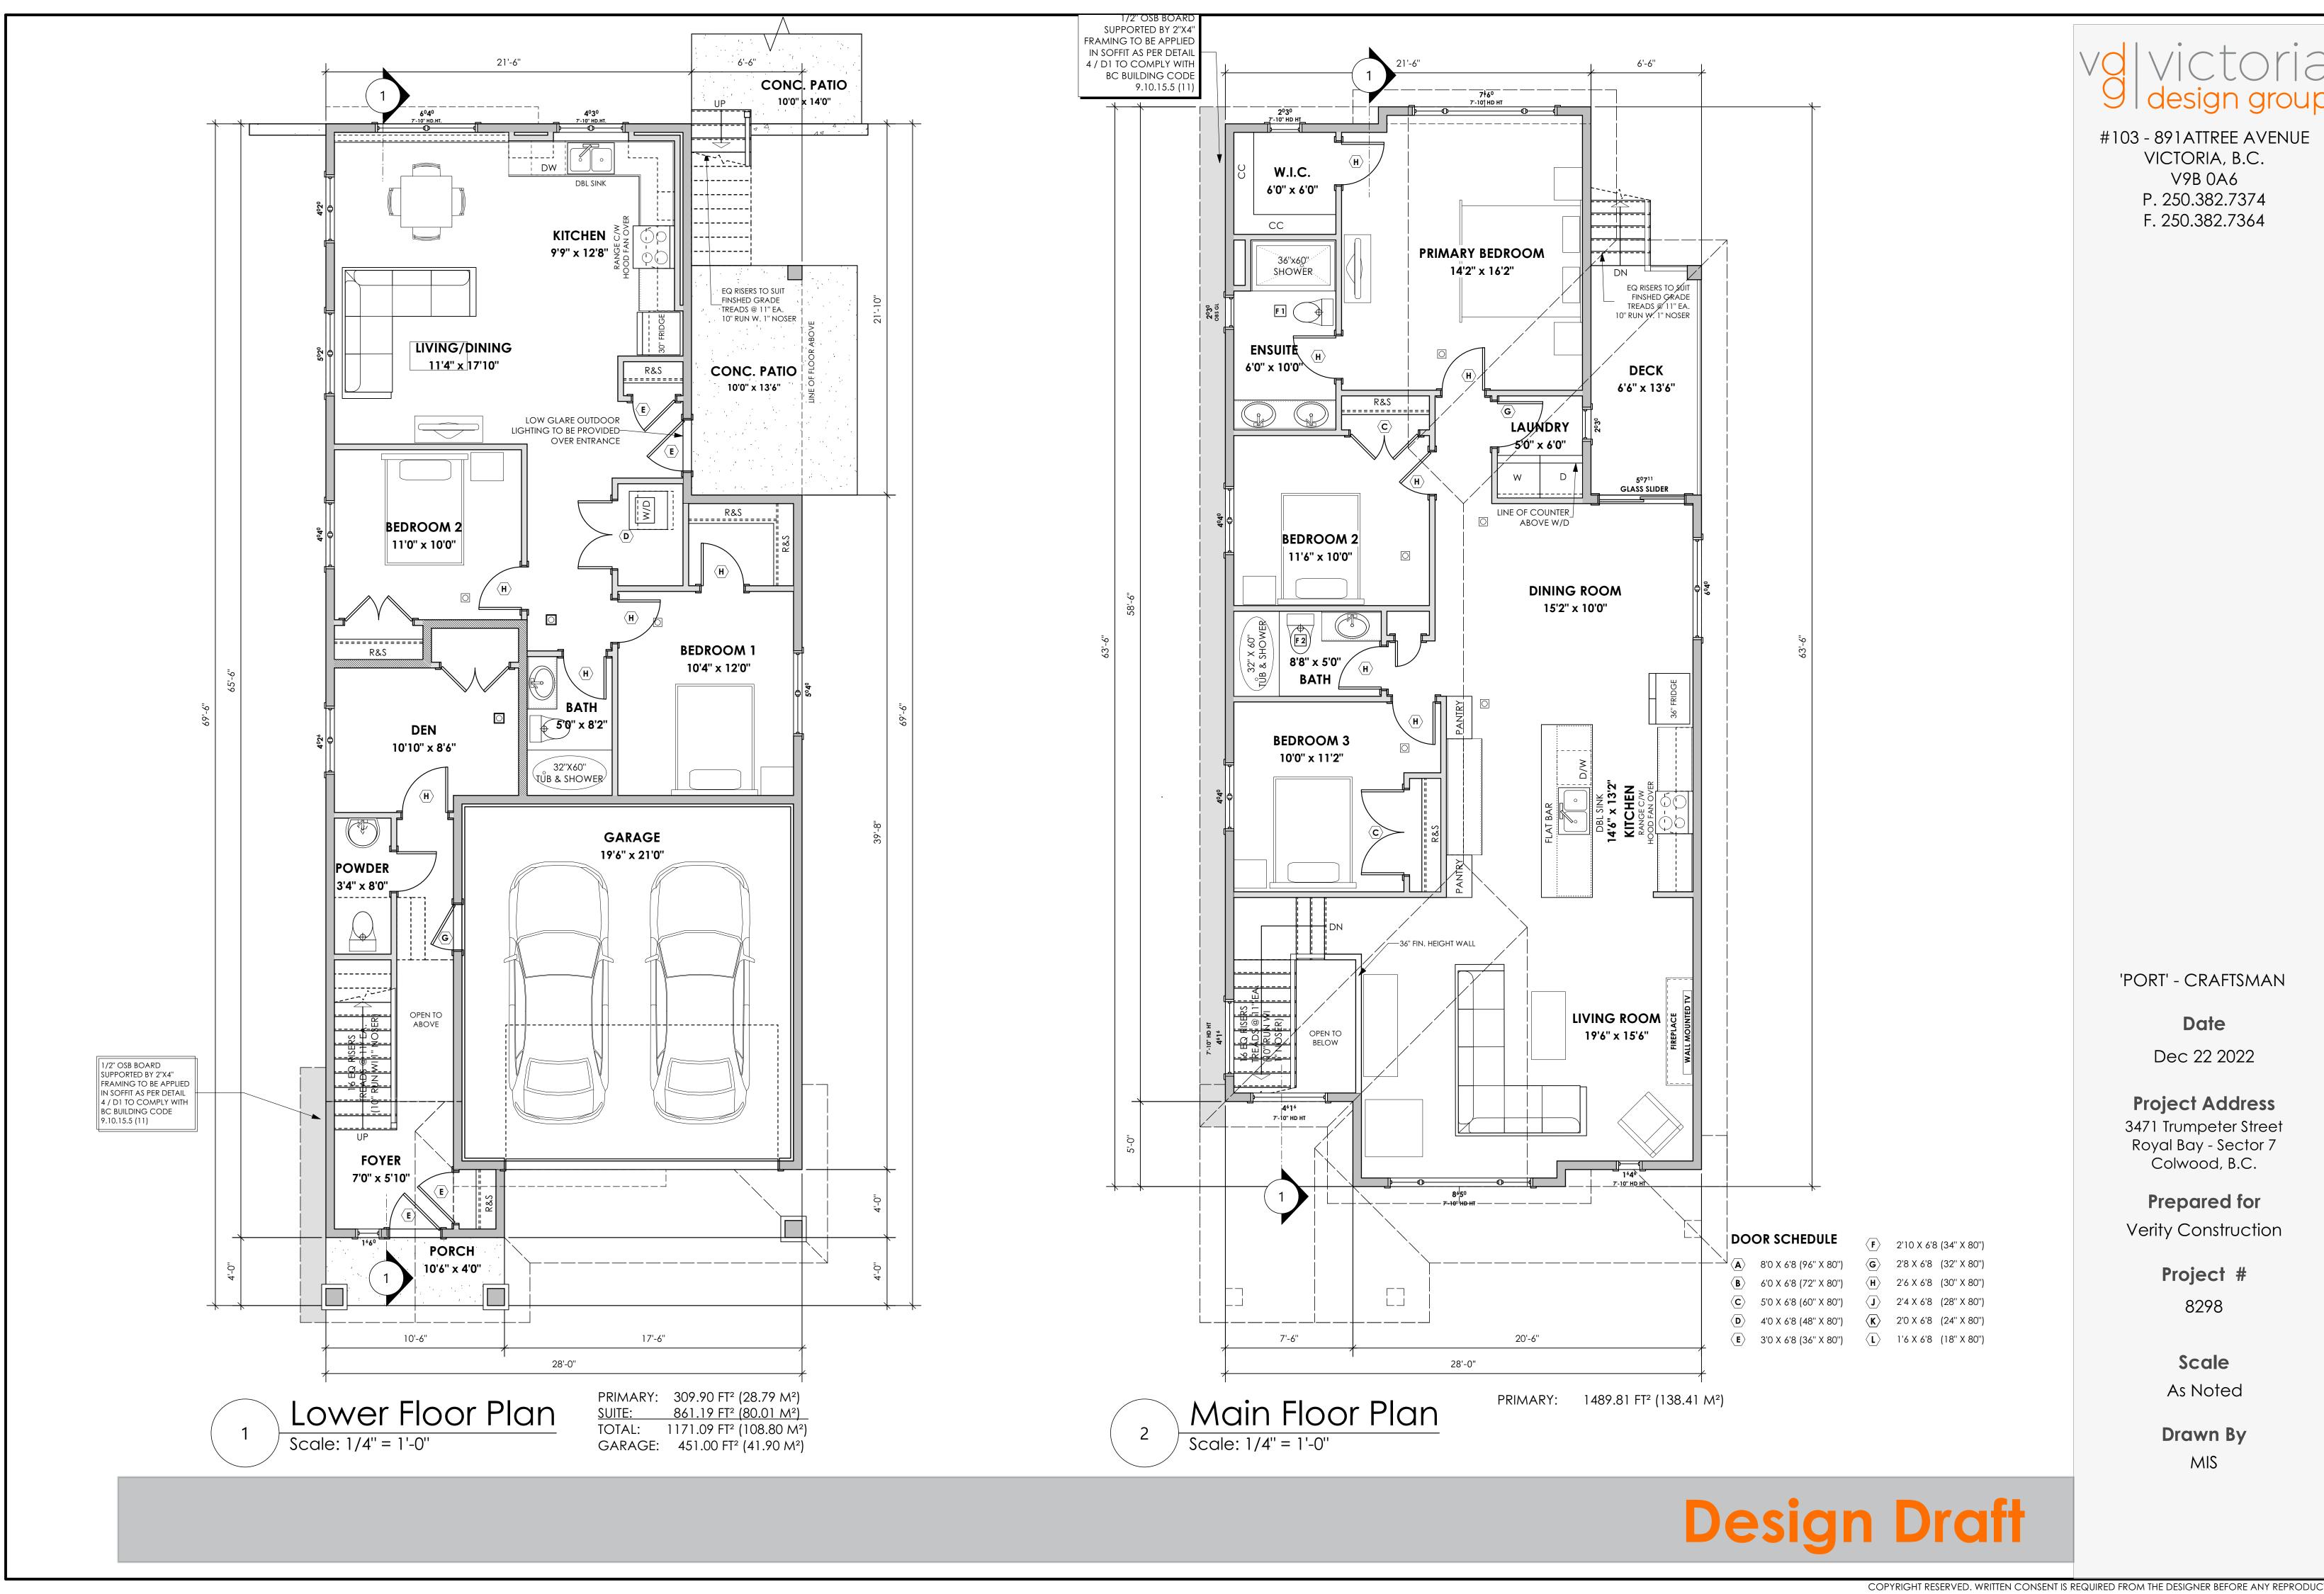

Roofs

- R1. LAMINATED ASPHALT SHINGLES ON
 7/16" ORIENTED STRAND BOARD C/W "H" CLIPS
 WD TRUSSES (DESIGNED BY MANUF.)
 14 1/2" FIBRE GLASS LOOSE FILL INSULATION
 (ALLOW FOR SETTLING)
 OR R-40 FIBRE GLASS BATT INSULATION
 6 MIL POLY'N V.B.
 5/8" GYPSUM BOARD
- R2. PROVIDE 2 1/2" (63mm) CLEAR BETWEEN R-20 INSULATION AND SHEATHING. (min. R-20 @ roof-wall connection for 4'-0" (1.2m) around perimeter of building. air ventelation baffles to be installed where required in as per BCBC 9.19.)
- R3. EAVE PROTECTION

 CONT. UP ROOF SLOPE FOR 12"

 PAST EXTERIOR WALL.
- R4. PROVIDE 1 SQ.FT. ATTIC VENT PER
 300 SQ.FT. OF INSULATED AREA MIN.
 25% OF REQUIREDTO BE @ TOP AND BOTTOM
 (to comply wi. B.C. bldg. code 9.19.1)
- R5. PRE-FN. FASCIA GUTTER
 2×8 FASCIA BD.
 2×4 SUB. FASCIA BD.
 VENTED SOFFIT
 (see contractor)

R6. PRE MANUF SOFFIT

1/2" OSB BOARD

SUPPORTED BY 2"X4" FRAMING

REFER TO DETAIL 4 / D1

(to be applied in any soffit that has less then

1.20m clearance to any proverty line.

To comply with BC BUILDING CODE

9.10.15.5 (11))

(AS REQUIRED, VERIFY ON SITE)

(NOT SHOWN IN SECTION)

Floors

FL1. FINISHED FLOORING ON
19/32" ORIENTED STRAND BOARD OR EQUAL
(NAILED & GLUED TO FLOOR STRUCT. BELOW) ON
2×10 FLOOR JOISTS @ 16" OR 12" O/C
C/W 2×2 X-BRIDGING @ 7.0' O/C (MAX)
1/2" GYPSUM BOARD

SECTION NOTES

- FL2. FINISHED FLOORING ON
 19/32" ORIENTED STRAND BOARD OR EQUAL
 (NAILED & GLUED TO FLOOR STRUCT. BELOW) ON
 2×10 FLOOR JOISTS @ 16" OR 12" O/C
 C/W 2×2 X-BRIDGING @ 7.0' O/C (MAX)
 R-31 FIBRE GLASS BATT INSULATION
 5/8" X-TYPE GYPSUM BOARD
 (BETWEEN GARAGE AND LIVING SPACE)
 (NOT SHOWN IN SECTION)
- FL3. 3 1/2" CONCRETE SLAB 6 MIL. POLY'N V.B. 6" COMPACTED GRAVEL OR SAND
- FL4. 3 1/2" CONCRETE SLAB
 6 MIL. POLY'N V.B.
 6" COMPACTED GRAVEL OR SAND
 SLOPE TO DOORS 1"
 (NOT SHOWN IN SECTION)
- FL5. 3 1/2" CONCRETE SLAB
 (CONTRACTOR TO VERIFY EXTENT OF
 EXTERIOR SLABS AND FINISHES)
 (SLOPE AWAY FROM BUILDING @ 2% MIN.)
 6" COMPACTED GRAVEL OR SAND
- FL6. F8d RATED CEILING ASSEMBLY
 (BC BUILDING CODE TABLE 9.10.3.1.B)
 FINISHED FLOORING ON
 19/32" ORIENTED STRAND BOARD OR EQ.
 (FASTENED & GLUED TO FLOOR STRUCT. BELOW) ON
 2×10 FLOOR JOISTS @ 16" OR 12" O/C
 C/W 2×2 X-BRIDGING @ 7.0' O/C (MAX)
 R-31 INSULATION
 RESILIENT METAL CHANNELS @ 24" O/C
 1 LAYERS 5/8" X-TYPE GYPSUM BOARD
 30 MINUTE F.R.R., 50 S.T.C.

Walls

- W1. DOUBLE GLAZING
 ENERGY STAR LOW "E" RATING IN
 THERMAL BREAK FRAMES
 2/2"X10" LINTEL OVER (@ BEARING WALLS ONLY)
 (TYPICAL, WI. 2 1/2" XPS INSULATION)
 FLASHING OVER @ EXTERIOR
 (GLAZING IN ALL EXTERIOR DOORS & WITHIN 3 FT.
 OF EXTERIOR DOORS TO BE SHATTERPROOF (SP))
 WINDOW REQUIREMENTS DERIVED FROM BCBC
 TABLE C-5 AS PER BCBC 9.7.4.3. AND ARE TO BE
 USED TO SATISFY THE REQUIREMENTS OF
 AAMA/WDMA/CSA 101/I.S.2/A440, "NAFS":
 COLWOOD, CLASS R, DP 1440, PG 30, WATER RESIST. 220, A2,
 RATINGS MUST BE CLEARLY LABELED ON ALL
 WINDOW UNITS UPON INSTALLATION FOR INSPECTION.
- W2. CONC. FIBRE BOARD ON
 9.5MM (3/8") AIR SPACE / STRAPPING
 3/8"×2" BORATE TREATED PLYWOOD STRAPPING
 HOUSE WRAP (A.B.) (TYVEK OR EQ.)
 7/16" ORIENTED STRAND BOARD SHEATHING
 2×6 STUDS (SEE APCING BELOW)
 R-20 INSULATION
 6 MIL. POLYETHYLENE VAPOUR BARRIER
 1/2" GYPSUM BOARD
 (REFER TO DETAILS ON D1)
- W3. INTERIOR PARTITION

 1/2" GYPSUM BOARD ON EACH SIDE

 OF 2×4 STUDS (SEE SPACING BELOW) OR

 2×6 STUDS (SEE SPACING BELOW) (IF NOTED)

W4. 5/8" X-TYPE GYPSUM BOARD ON 2×6 STUDS (SEE SPACING BELOW) R-20 INSULATION 6 MIL. POLY'N V.B 1/2" GYPSUM BOARD

(BETWEEN GARAGE & LIVING)
(NOT SHOWN IN SECTION)

W5. 1/2" GYPSUM BOARD ON
6 MIL. POLY'N V.B.
2×4 STUDS (SEE SPACING BELOW)
OR 2×6 STUDS (SEE SPACING BELOW) (IF NOTED)
R-12 BATT INSULATION
HOUSE WRAP (A.B.) (TYVEK OR EQ.) OR
12.7MM (1/2") AIR SPACE
(PROVIDE REQUIRED FIRE STOPS IN WALL

ASSEMBLIES TO COMPLY WITH

B.C. BLDG. CODE 9.10.16.)

(if applicable)

- W6. B.C. BUILDING CODE (TABLE 9.10.3.1.A)
 RATED WALL ASSEMBLY W3c

 1 LAYER 1/2" X-TYPE GYPSUM BOARD
 RESILIENT METAL CHANNELS @ 24" O/C
 2×4 STUDS @ 16" O/C OR
 2×6 STUDS @ 16" O/C (IF NOTED) C/W
 3 1/2" FIBRE GLASS SOUND BATTS
 1 LAYER 1/2" X-TYPE GYPSUM BOARD
 45 MIN. F.R.R 43 S.T.C
 (BETWEEM PRIMARY LIVING & SECONDARY SUITE)
- W7. STUD SPACING

 UPPER FLOOR: 2"X6" @ 24" O/C

 MAIN FLOOR: 2"X6" @ 24" O/C

 LOWER FLOOR: 2"X6" @ 16" O/C

 (if applicable)

 INTERIOR PARTITION: 2"X4"" @ 24" O/C

 LOAD BEARING: 2"X4"" @ 16" O/C

 PARTY WALL 2"X4"" @ 24" O/C

Foundation Walls

- F1. DAMPROOFING (where required) ON 8" THK. CONC. FOUNDATION WALL C/W 15 M BARS @ 24" o/c B/W
- F2. 16"X 8" CONC. FOOTINGS

 C/W 2 (TWO) 15m BARS CONT. 3 IN. FROM BOTT.

 ON UNDISTURBED SOIL (SOLID BEARING)
- F3. 4" PERIMETER DRAIN
 3" TIGHT PIPE FOR RWL
 DRAIN ROCK
- F4. ANCHOR BOLTS @ 4.0 FT. o/c MAX c/w SILL GASKETS
- F5. UNDER SLAB INSULATION
 2 1/2" (RSI 2.15) EXTRUDED POLYSTYRENE
 RIGID INSULATION 4'-0" (1.2M)
 CONT. AROUND PERIMETER UNDER
 SLAB INSTALLED HORIZONTALLY
 (VERIFY WITH MUNICIPALITY DEPTH OF FROST LINE)

#103 - 891ATTREE AVENUE

VICTORIA, B.C. V9B 0A6 P. 250.382.7374 F. 250.382.7364

'PORT' - CRAFTSMAN

Date

Dec 22 2022

Project Address

3471 Trumpeter Street Royal Bay - Sector 7 Colwood, B.C.

Prepared for Verity Construction

Project #

8298


ScaleAs Noted

Drawn By
MIS

Design Draft

ALL FENCING, RETAINING AND LANDSCAPING MUST MEET THE GUIDELINE REQUIREMENTS


ALL RETAINING WALLS ARE TO BE STAND ALONE STRUCTURES (THEY MUST TERMINATE AT PROPERTY LINE) AND MUST NOT CONNECT TO RETAINING WALLS LOCATED ON ADJACENT PRIVATE PROPERTIES *NOTE: In the interest of maintaining high standards, the developer reserves the right to modify plans, specifications and design without prior notice. Drawings contained within are artist renderings only. Sizes and dimensions are approximate and may vary with actual plan and survey. Exterior style may change pending municipal approval. Retaining wall location and types may vary and are subject to municipal, engineering or developer discretion. Subject to change without notice. Furniture as shown on plans are for layout purposes only and are not included in the sale.

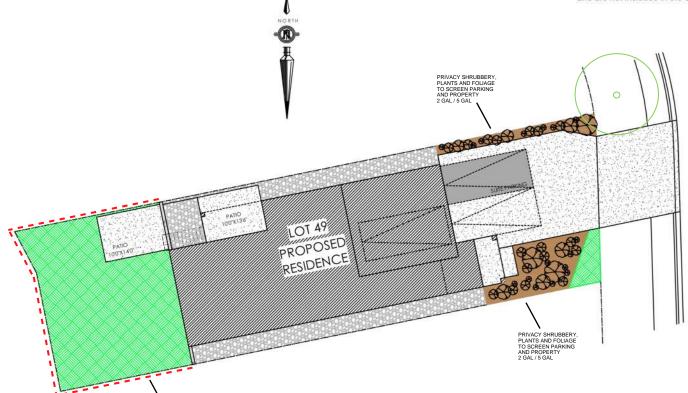


	ITEM	AREA (sf)	%
68	GARDEN BED	276	10%
	GRAVEL	510	18%
	CONCRETE	1,056	37%
	SOD	983	35%
	TOTAL	2,825	100%






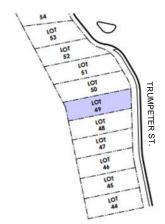

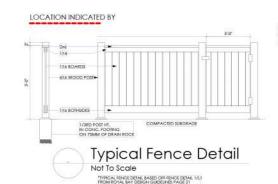

ADDITIONAL NOTES:
PROPERTY TO BE IRRIGATED
6" PIPE FOR DRIVEWAY SLEEVES TO
BE INSTALLED FOR CITY IRRIGATION
LINES

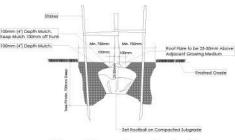

Tree Planting Detail
Not To Scale
All trees and plants by the home owner to be
planted in minimum Total of tertile topsol, 700mm Deep



MM/DD/YY		ISSUED/REVISED
01	10/17/22	FOR APPROVAL

ESTIMATED LOCATION OF REAR FENCING - SUBJECT TO CHANGE ACCORDING TO ACTUAL SITE CONDITIONS

02 01/12/23 SITE PLAN REVISION

DATE PROJECT

> LANDSCAPING PLAN LOT 49, 3471 TRUMPETER ST. ROYAL BAY, SECTOR 7 CITY OF COLWOOD



QUALITY CONSTRUCTION. TRUSTED SERVICE.

106 - 1039 Langford Parkway Victoria, B.C. V9B 0A6 P: 250.474.1039 www.verityconstruction.ca


GABLECTAST HOMES

BUILDING GRADE SLIP

WSP	Project	No:	201-08151-00
	-		

DATE

DOILDING	Issue Date:
MUNICIPAL ADDRESS 3471 Trumpeter Street	P.I.D.
LOT 49	PLAN
BUILDER VERITY HOMES	SUBDIVISION ROYAL BAY SECTOR 7
ADDRESS	DEVELOPER MEADOWS DEVELOPMENT LP
REPRESENTATIVE PH.	CONSULTANT WSP CANADA INC
PROPOSED BUILDING GRADES ALL ELEVATIONS ARE METRIC GEODETIC + MAIN FLOOR ELEVATION	PLAN: TRUMPETER ST. 49 QC 67.85 49 EG 67.8 GFE 68.27 MSE 65.03 S 64.53 S 64.53 S 64.53 D 64.69 LB PLAN: TRUMPETER ST.
SANITARY 100 100 100	88.89 69.0
DRAIN TO SUMP PUMP LIKELY REQUIRED (FOR BASEMENT IF INSTALLED)	LEGEND STREET SROW SROW SROW SROW STORIES SROW SROW STORIES STORIES SROW SHOWN ON ABOVE PLAN) PROPOSED FRONT CORNER ELEVATIONS PROPOSED FRONT SIDE YARD GRADES STORIES STORIE
NOTES 1. IT IS THE RESPONSIBILITY OF THE BUILDER TO ENSURE THE FOOTINGS ARE PLACED ON A PROPER BASE THAT IS FREE FROM FROST, EXCESSIVE MOISTURE AND DELETERIOUS MATERIALS AND HAVE APPROPRIATE FROST PROTECTION WHEN COMPLETED.	- PROPOSED REAR CORNER ELEVATIONS LANE/LOT
2. THE INFORMATION CONTAINED HEREIN IS BASED ON THE APPROVED LOT GRADING PLAN FOR THIS SUBDIVISION. UN—AUTHORIZED DEVIATIONS WILL BE THE RESPONSIBILITY OF THE BUILDER TO ENSURE COMPLIANCE WITH ALL LOCAL BYLAWS. 3. OTHER NOTES:	I, THE BUILDER'S REPRESENTATIVE, CERTIFY THAT THE FINAL HOUSE PLANS PROVIDED IN THE BUILDING PERMIT APPLICATION ARE THE SAME AS PROCESSED UNDER THIS GRADE SLIP AND THAT I UNDERSTAND THE INFORMATION AND THE REQUIREMENTS CONTAINED HEREIN AND WILL BUILD ACCORDINGLY.
LOT GRADING PLAN FOR THIS SUBDIVISION. UN—AUTHORIZED DEVIATIONS WILL BE THE RESPONSIBILITY OF THE BUILDER TO ENSURE COMPLIANCE WITH ALL LOCAL BYLAWS.	CERTIFY THAT THE FINAL HOUSE PLANS PROVIDED IN THE BUILDING PERMIT APPLICATION ARE THE SAME AS PROCESSED UNDER THIS GRADE SLIP AND THAT I UNDERSTAND THE INFORMATION AND THE REQUIREMENTS CONTAINED HEREIN AND WILL BUILD ACCORDINGLY. AUTHORIZED BUILDER'S REPRESENTATIVE DATE
LOT GRADING PLAN FOR THIS SUBDIVISION. UN—AUTHORIZED DEVIATIONS WILL BE THE RESPONSIBILITY OF THE BUILDER TO ENSURE COMPLIANCE WITH ALL LOCAL BYLAWS.	CERTIFY THAT THE FINAL HOUSE PLANS PROVIDED IN THE BUILDING PERMIT APPLICATION ARE THE SAME AS PROCESSED UNDER THIS GRADE SLIP AND THAT I UNDERSTAND THE INFORMATION AND THE REQUIREMENTS CONTAINED HEREIN AND WILL BUILD ACCORDINGLY.

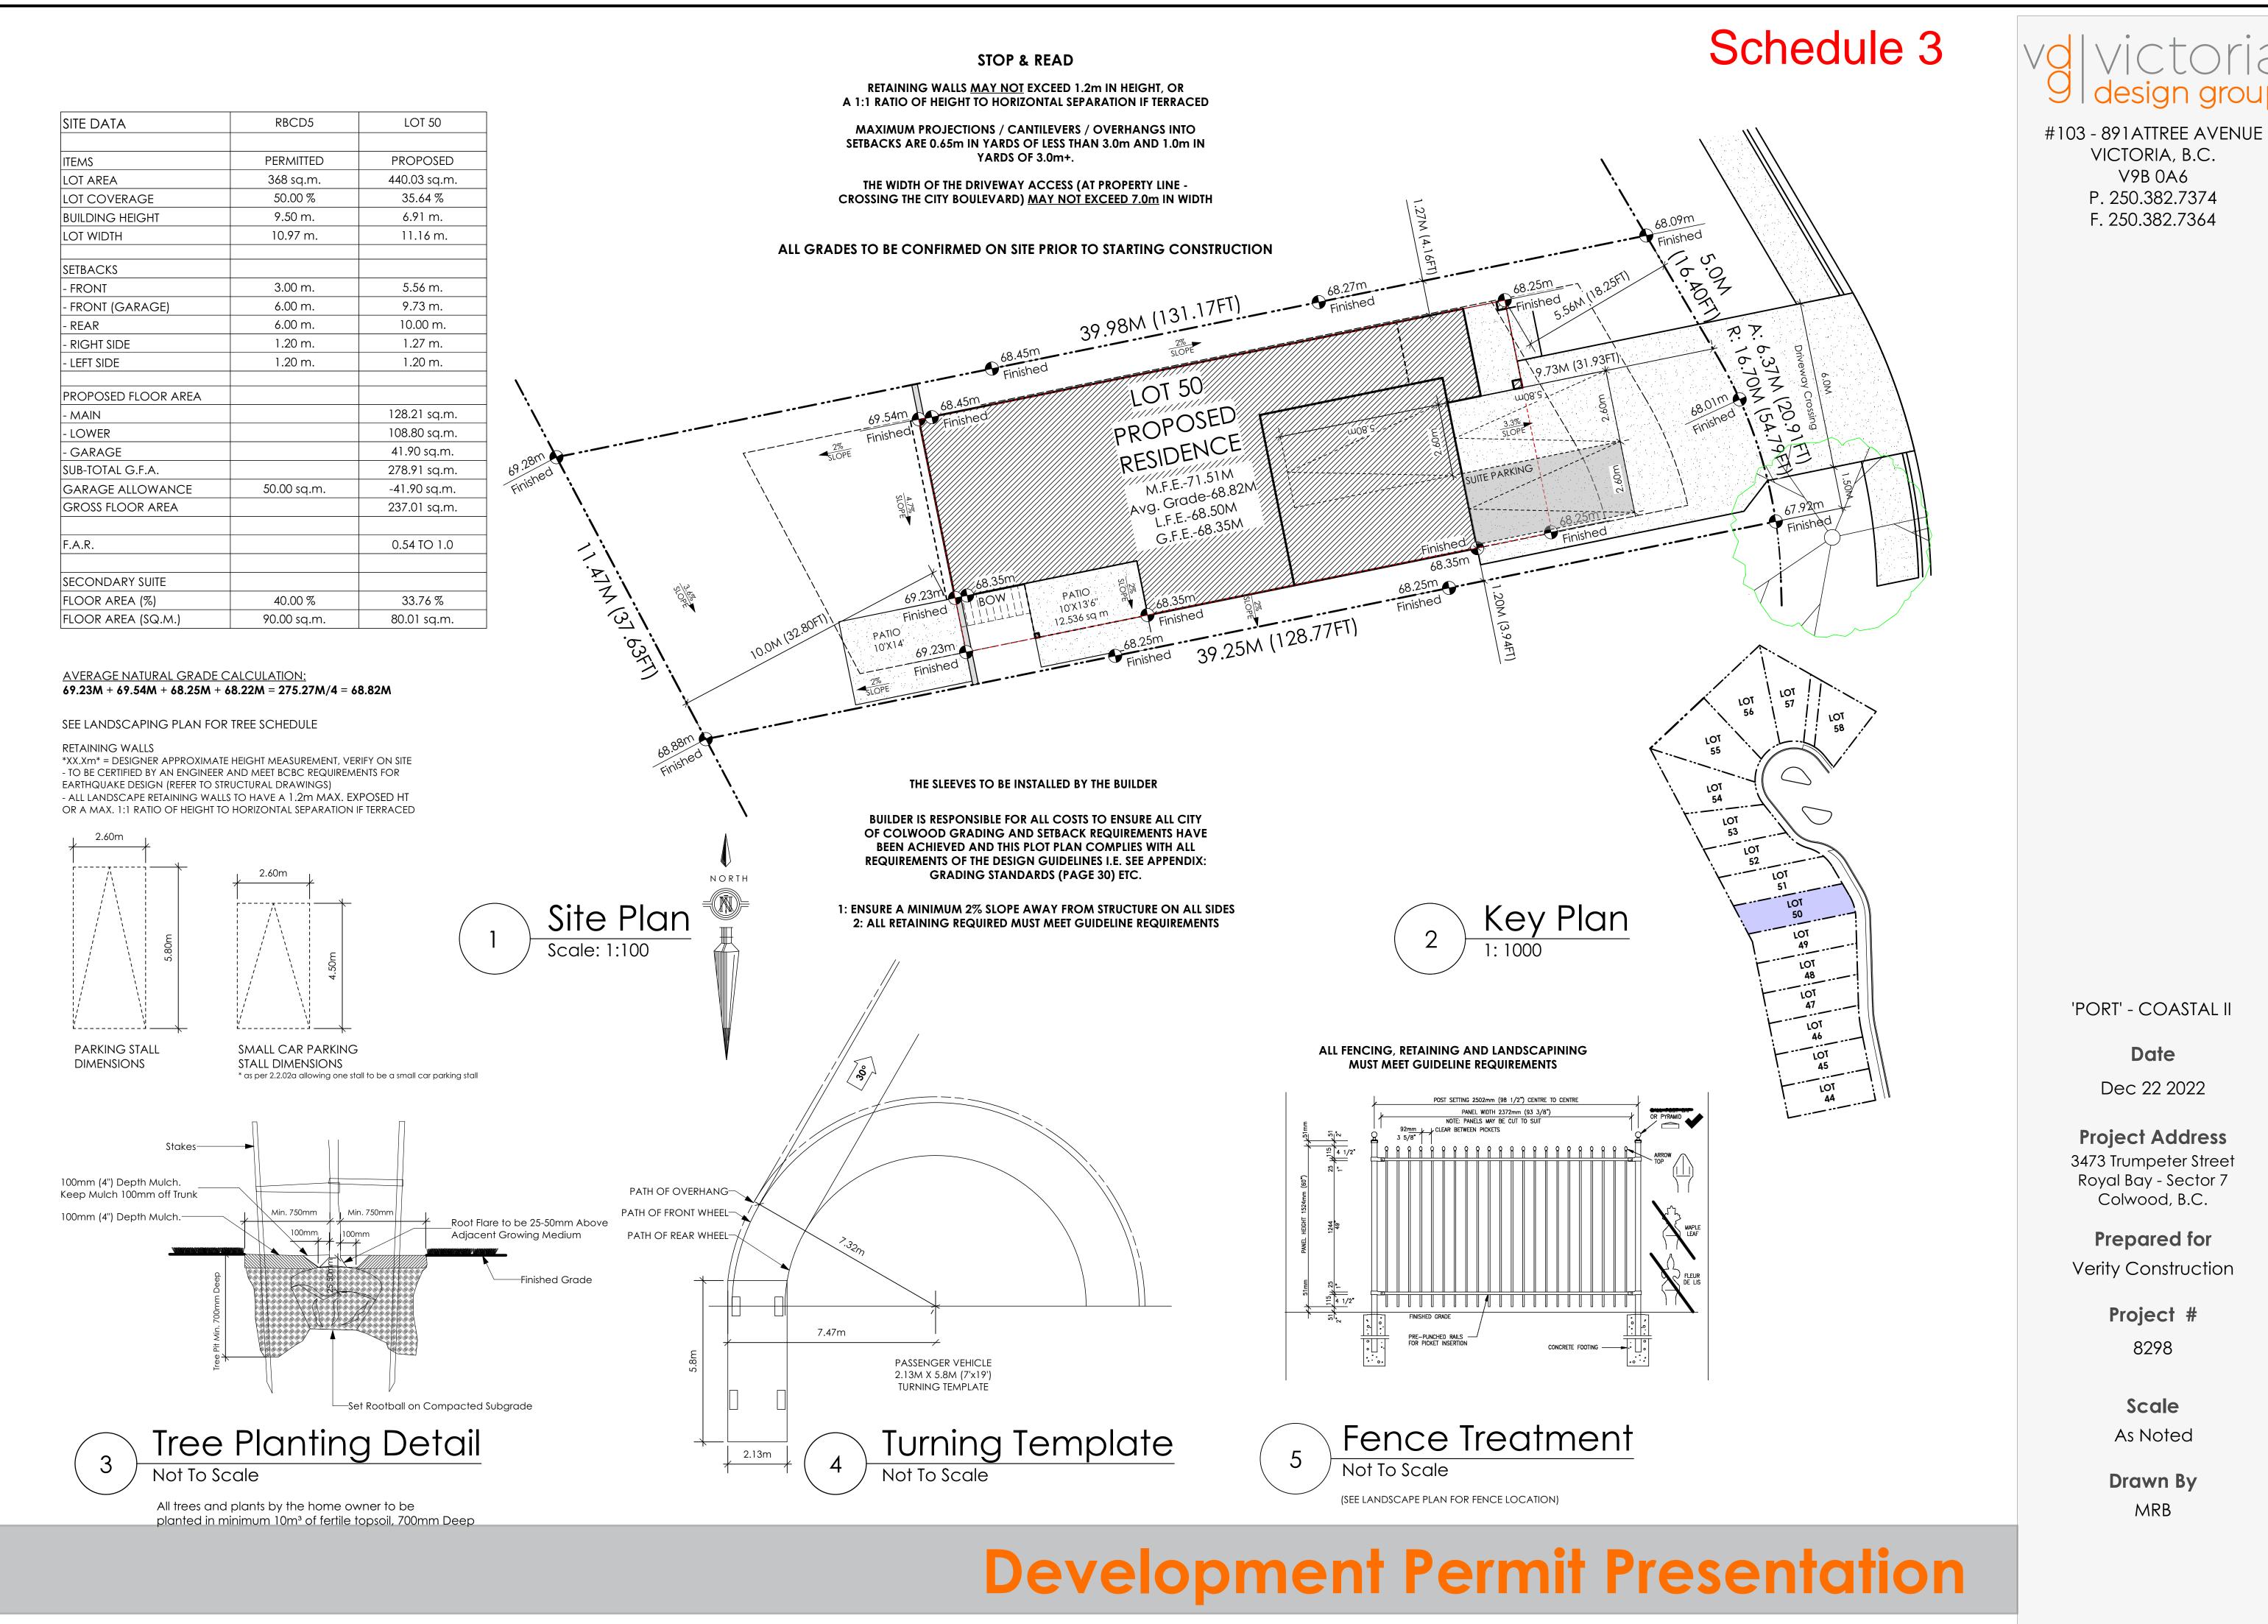

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VICTORIA, B.C.

V9B 0A6

P. 250.382.7374

F. 250.382.7364

'PORT' - COASTAL II

Date

Dec 22 2022

Project Address

3473 Trumpeter Street Royal Bay - Sector 7

Colwood, B.C.

Prepared for

Verity Construction

Project #


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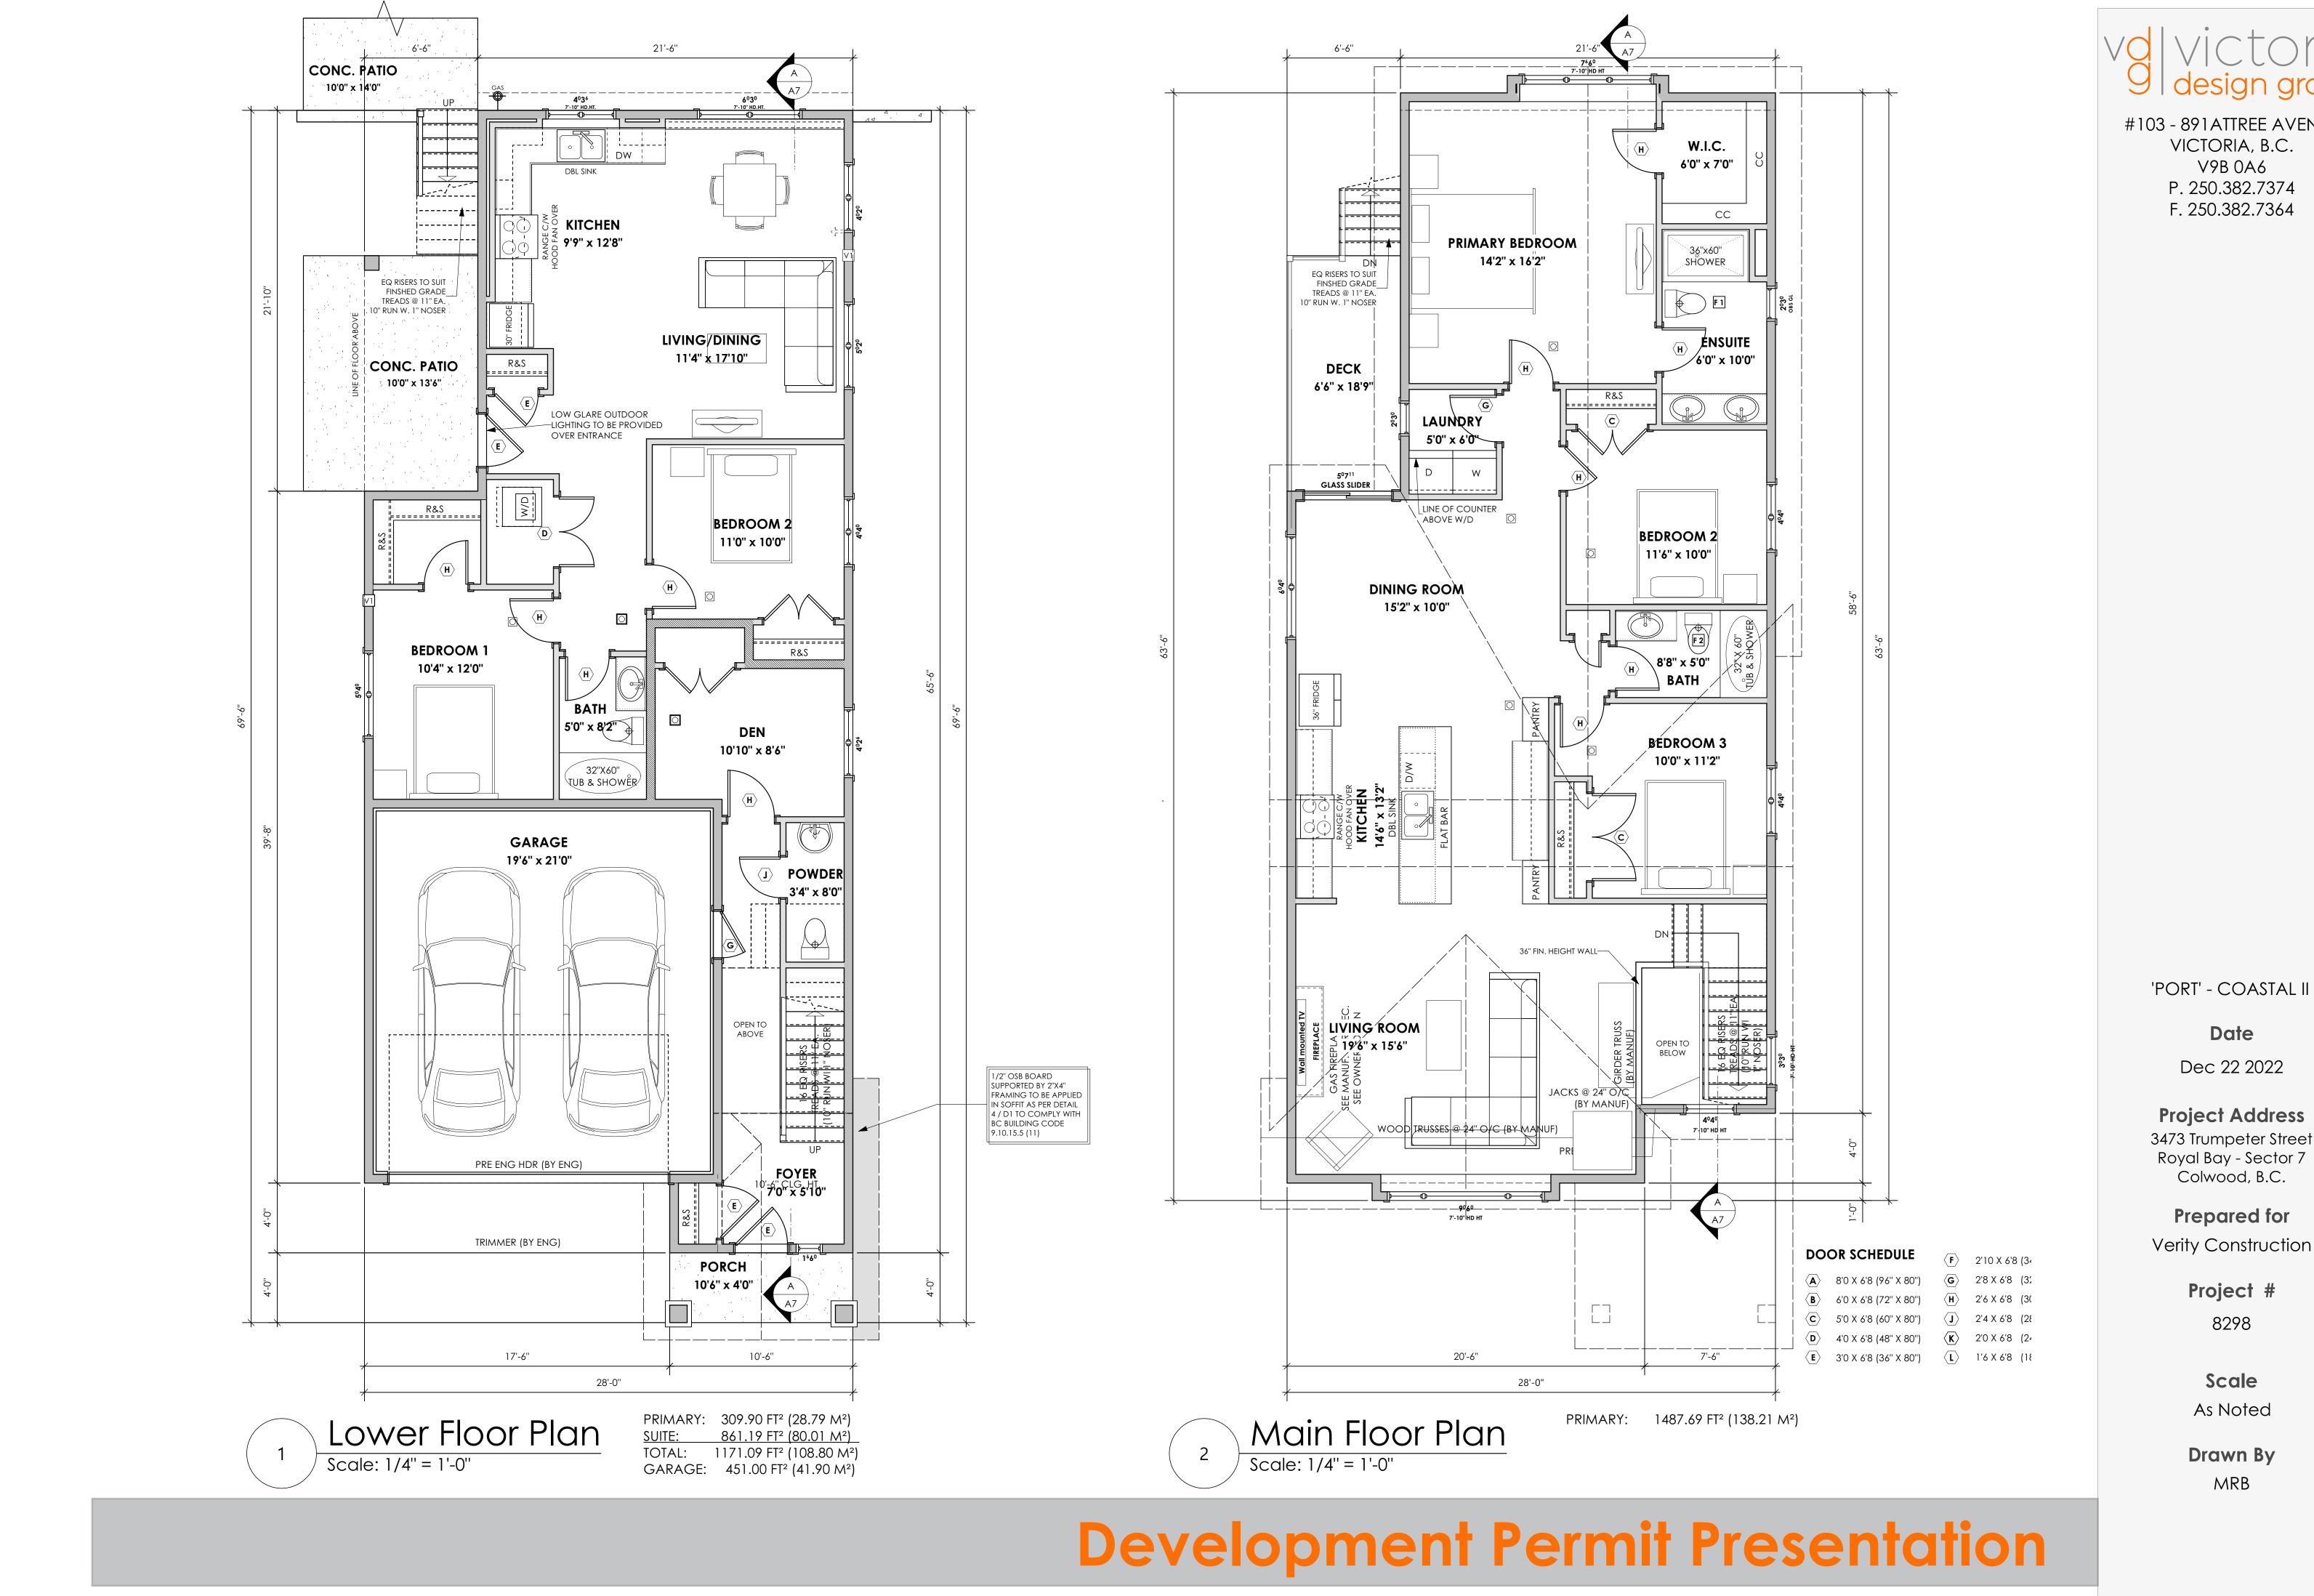
Scale

As Noted

Drawn By

MRB



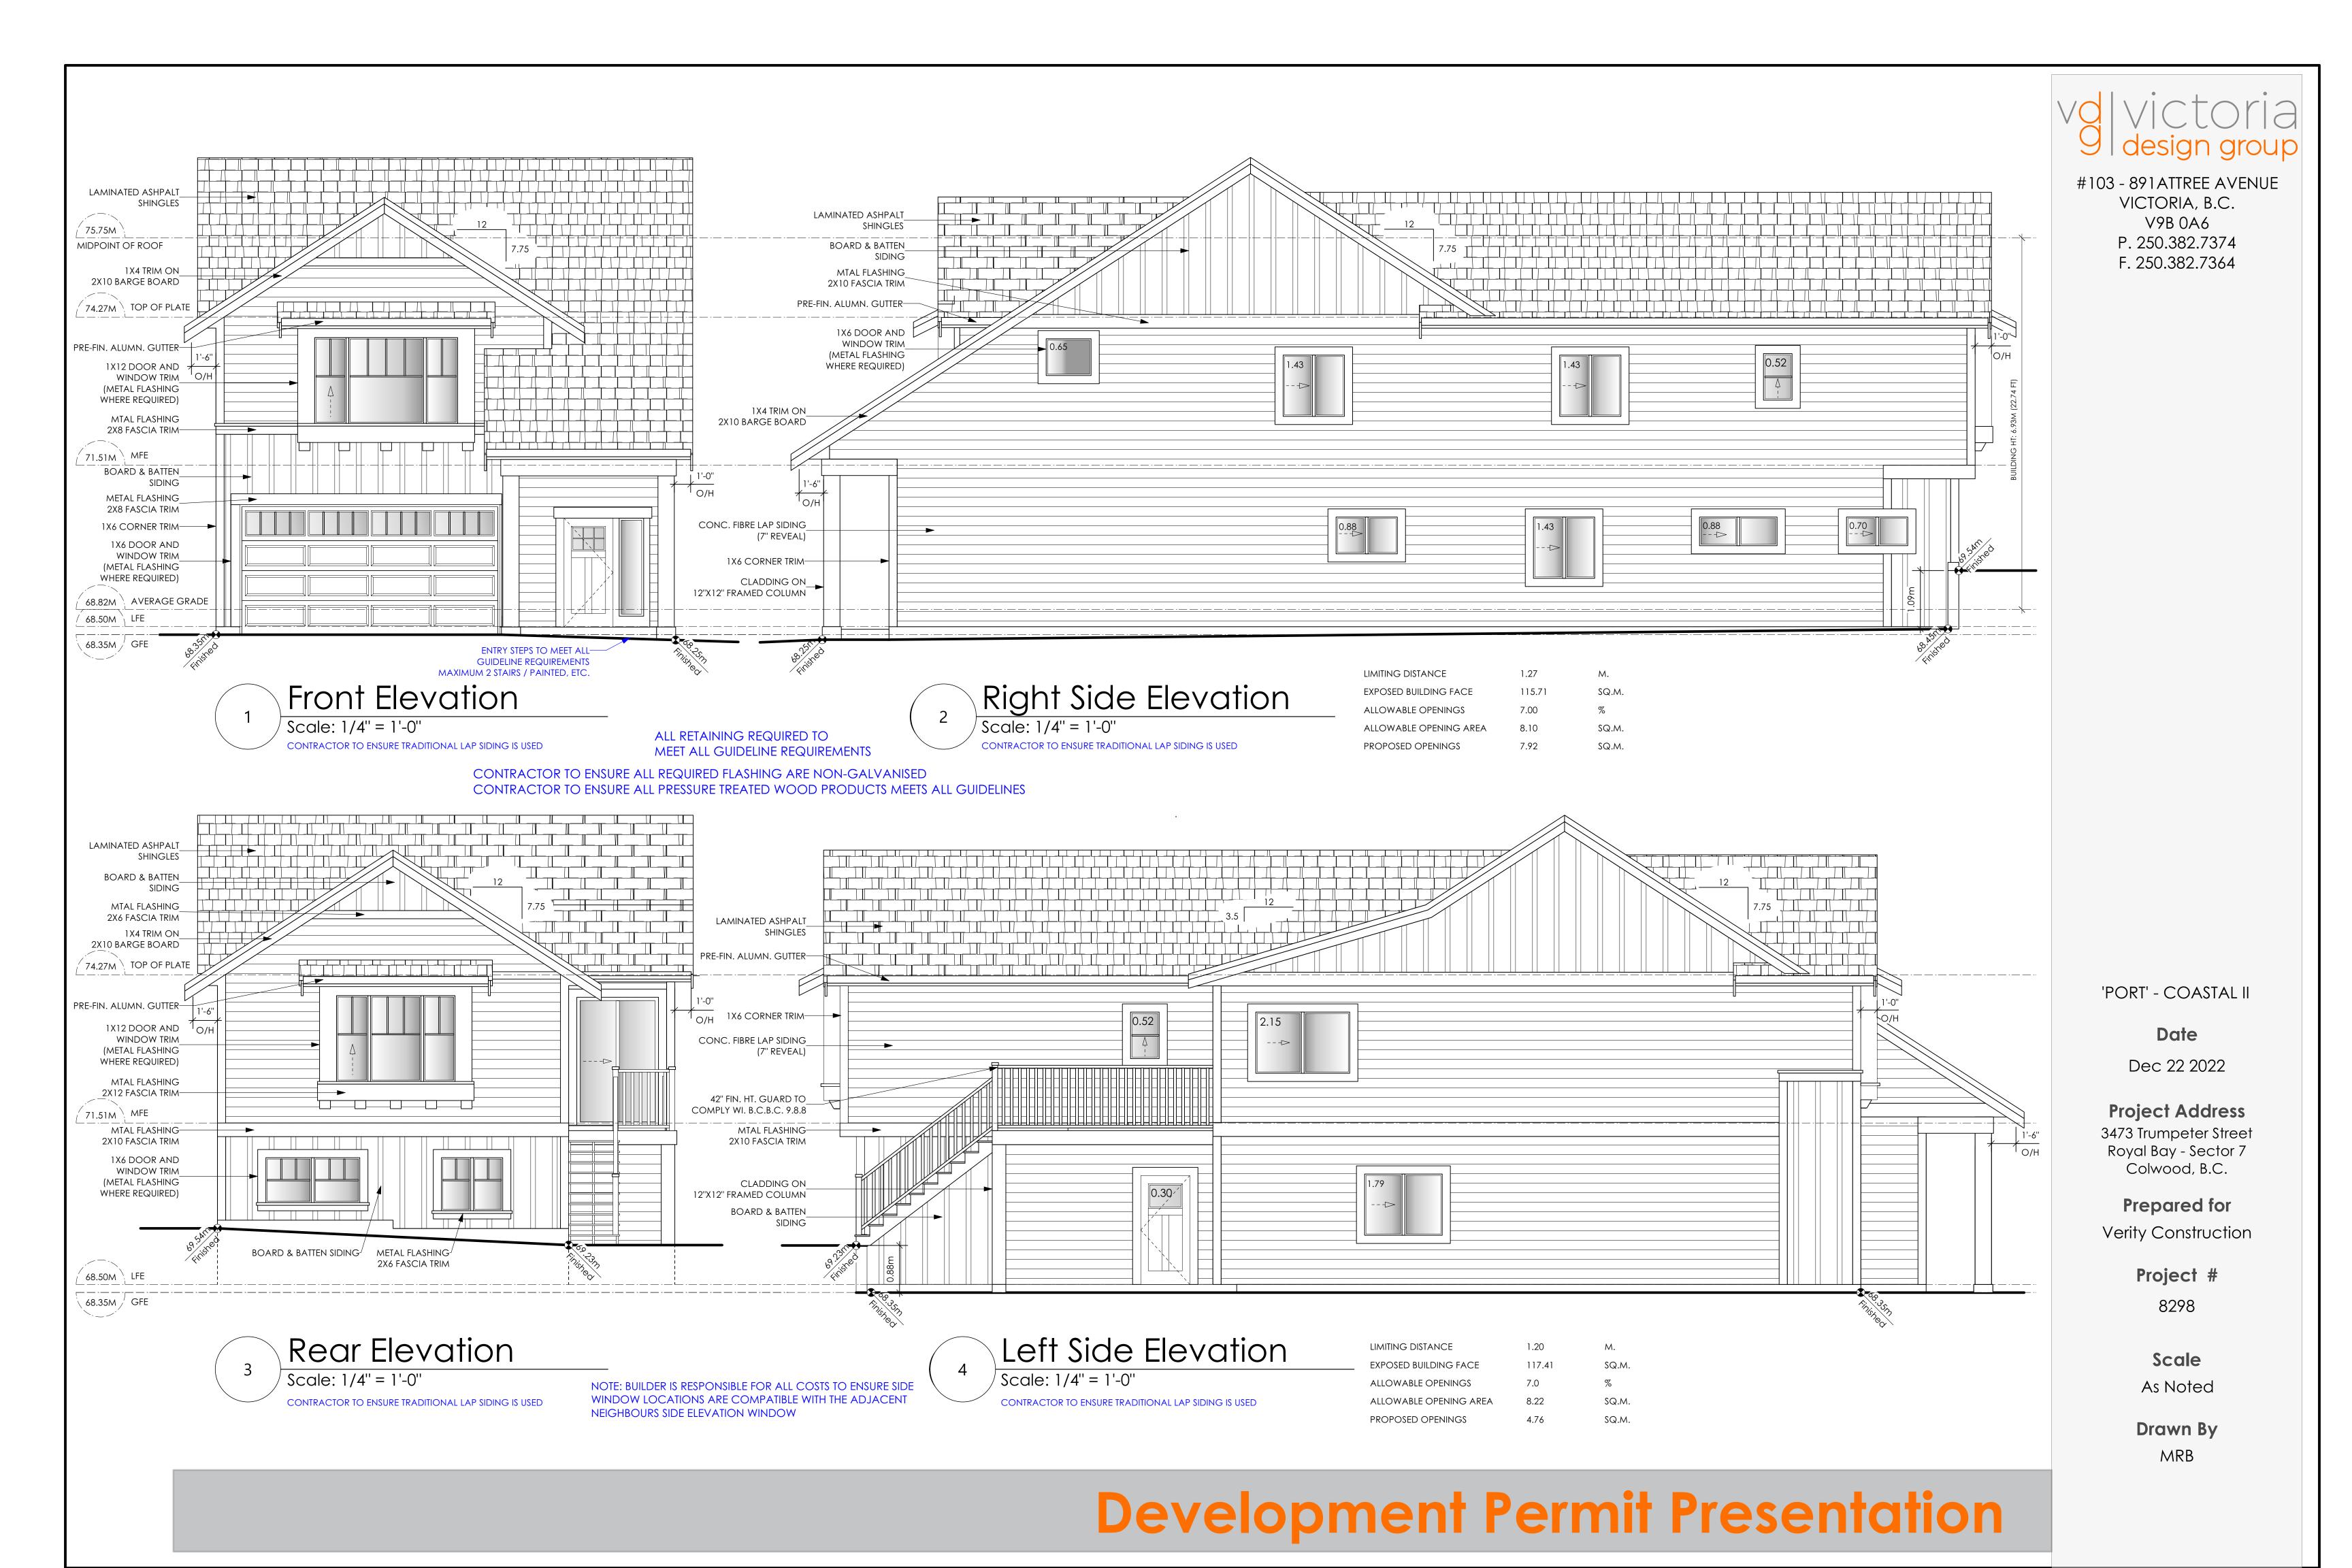

Dec 22 2022

Project Address

3473 Trumpeter Street Royal Bay - Sector 7

Prepared for


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Scale

As Noted

MRB



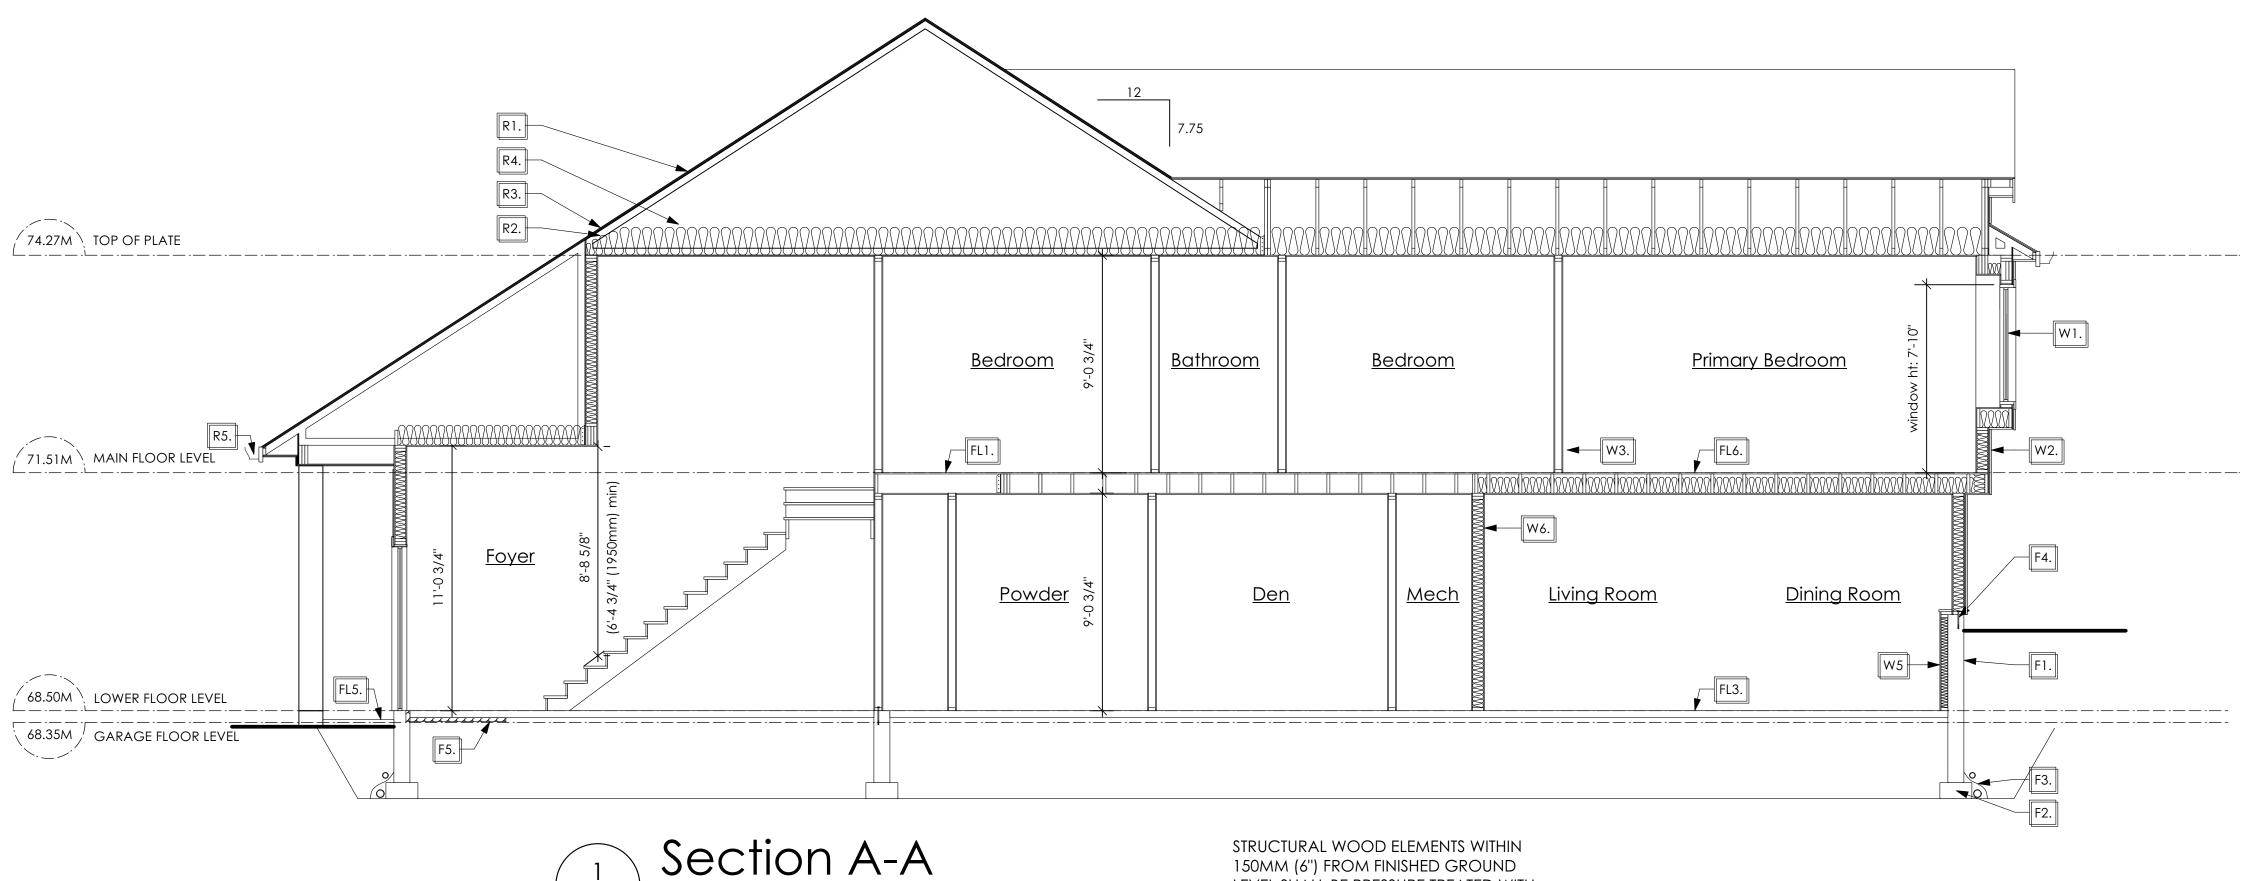

STRUCTURAL WOOD ELEMENTS WITHIN 150MM (6") FROM FINISHED GROUND LEVEL SHALL BE PRESSURE TREATED WITH A PRESERVATIVE FOR TERMITE AND DECAY PROTECTION B.C.B.C. 2012 9.3.2.9.(3)

SECTION NOTES

Roofs

- R1. LAMINATED ASPHALT SHINGLES ON
 7/16" ORIENTED STRAND BOARD C/W "H" CLIPS
 WD TRUSSES (DESIGNED BY MANUF.)
 14 1/2" FIBRE GLASS LOOSE FILL INSULATION
 (ALLOW FOR SETTLING)
 OR R-40 FIBRE GLASS BATT INSULATION
 6 MIL POLY'N V.B.
 5/8" GYPSUM BOARD
- R2. PROVIDE 2 1/2" (63mm) CLEAR BETWEEN R-20 INSULATION AND SHEATHING. (min. R-20 @ roof-wall connection for 4'-0" (1.2m) around perimeter of building. air ventelation baffles to be installed where required in as per BCBC 9.19.)
- R3. EAVE PROTECTION

 CONT. UP ROOF SLOPE FOR 12"

 PAST EXTERIOR WALL.
- R4. PROVIDE 1 SQ.FT. ATTIC VENT PER
 300 SQ.FT. OF INSULATED AREA MIN.
 25% OF REQUIREDTO BE @ TOP AND BOTTOM
 (to comply wi. B.C. bldg. code 9.19.1)
- R5. PRE-FN. FASCIA GUTTER
 2×8 FASCIA BD.
 2×4 SUB. FASCIA BD.
 VENTED SOFFIT
 (see contractor)

R6. PRE MANUF SOFFIT

1/2" OSB BOARD

SUPPORTED BY 2"X4" FRAMING

REFER TO DETAIL 4 / D1

(to be applied in any soffit that has less then
1.20m clearance to any proverty line.

To comply with BC BUILDING CODE
9.10.15.5 (11))

(AS REQUIRED, VERIFY ON SITE)

(NOT SHOWN IN SECTION)

Floors

- FL1. FINISHED FLOORING ON
 19/32" ORIENTED STRAND BOARD OR EQUAL
 (NAILED & GLUED TO FLOOR STRUCT. BELOW) ON
 2×10 FLOOR JOISTS @ 16" OR 12" O/C
 C/W 2×2 X-BRIDGING @ 7.0' O/C (MAX)
 1/2" GYPSUM BOARD
- FL2. FINISHED FLOORING ON

 19/32" ORIENTED STRAND BOARD OR EQUAL
 (NAILED & GLUED TO FLOOR STRUCT. BELOW) ON

 2×10 FLOOR JOISTS @ 16" OR 12" O/C

 C/W 2×2 X-BRIDGING @ 7.0' O/C (MAX)

 R-31 FIBRE GLASS BATT INSULATION

 5/8" X-TYPE GYPSUM BOARD
 (BETWEEN GARAGE AND LIVING SPACE)
 (NOT SHOWN IN SECTION)
- FL3. 3 1/2" CONCRETE SLAB
 6 MIL. POLY'N V.B.
 6" COMPACTED GRAVEL OR SAND
- FL4. 3 1/2" CONCRETE SLAB
 6 MIL. POLY'N V.B.
 6" COMPACTED GRAVEL OR SAND
 SLOPE TO DOORS 1"
 (NOT SHOWN IN SECTION)
- FL5. 3 1/2" CONCRETE SLAB
 (CONTRACTOR TO VERIFY EXTENT OF
 EXTERIOR SLABS AND FINISHES)
 (SLOPE AWAY FROM BUILDING @ 2% MIN.)
 6" COMPACTED GRAVEL OR SAND
- FL6. F8d RATED CEILING ASSEMBLY
 (BC BUILDING CODE TABLE 9.10.3.1.B)
 FINISHED FLOORING ON
 19/32" ORIENTED STRAND BOARD OR EQ.
 (FASTENED & GLUED TO FLOOR STRUCT. BELOW) ON
 2×10 FLOOR JOISTS @ 16" OR 12" O/C
 C/W 2×2 X-BRIDGING @ 7.0' O/C (MAX)
 R-31 INSULATION
 RESILIENT METAL CHANNELS @ 24" O/C
 1 LAYERS 5/8" X-TYPE GYPSUM BOARD
 30 MINUTE F.R.R., 50 S.T.C.

Walls

W1. DOUBLE GLAZING

- ENERGY STAR LOW "E" RATING IN THERMAL BREAK FRAMES

 2/2"X10" LINTEL OVER (@ BEARING WALLS ONLY)
 (TYPICAL, WI. 2 1/2" XPS INSULATION)
 FLASHING OVER @ EXTERIOR
 (GLAZING IN ALL EXTERIOR DOORS & WITHIN 3 FT.
 OF EXTERIOR DOORS TO BE SHATTERPROOF (SP))
 WINDOW REQUIREMENTS DERIVED FROM BCBC
 TABLE C-5 AS PER BCBC 9.7.4.3. AND ARE TO BE
 USED TO SATISFY THE REQUIREMENTS OF
 AAMA/WDMA/CSA 101/I.S.2/A440, "NAFS":
 COLWOOD, CLASS R, DP 1440, PG 30, WATER RESIST. 220, A2,
 RATINGS MUST BE CLEARLY LABELED ON ALL
 WINDOW UNITS UPON INSTALLATION FOR INSPECTION.
- W2. CONC. FIBRE BOARD ON
 9.5MM (3/8") AIR SPACE / STRAPPING
 3/8"×2" BORATE TREATED PLYWOOD STRAPPING
 HOUSE WRAP (A.B.) (TYVEK OR EQ.)
 7/16" ORIENTED STRAND BOARD SHEATHING
 2×6 STUDS (SEE APCING BELOW)
 R-20 INSULATION
 6 MIL. POLYETHYLENE VAPOUR BARRIER
 1/2" GYPSUM BOARD
 (REFER TO DETAILS ON D1)
- W3. INTERIOR PARTITION
 1/2" GYPSUM BOARD ON EACH SIDE
 OF 2×4 STUDS (SEE SPACING BELOW) OR
 2×6 STUDS (SEE SPACING BELOW) (IF NOTED)

W4. 5/8" X-TYPE GYPSUM BOARD ON 2×6 STUDS (SEE SPACING BELOW) R-20 INSULATION

- 6 MIL. POLY'N V.B
 1/2" GYPSUM BOARD
 (BETWEEN GARAGE & LIVING)
 (NOT SHOWN IN SECTION)

 W5. 1/2" GYPSUM BOARD ON
 6 MIL. POLY'N V.B.
 2×4 STUDS (SEE SPACING BELOW)
 OR 2×6 STUDS (SEE SPACING BELOW) (IF NOTED)

 ST. 220, A2,
 R-12 BATT INSULATION
 HOUSE WRAP (A.B.) (TYVEK OR EQ.) OR
 12.7MM (1/2") AIR SPACE
 - W6. B.C. BUILDING CODE (TABLE 9.10.3.1.A)
 RATED WALL ASSEMBLY W3c
 1 LAYER 1/2" X-TYPE GYPSUM BOARD
 RESILIENT METAL CHANNELS @ 24" O/C
 2×4 STUDS @ 16" O/C OR
 2×6 STUDS @ 16" O/C (IF NOTED) C/W
 3 1/2" FIBRE GLASS SOUND BATTS
 1 LAYER 1/2" X-TYPE GYPSUM BOARD
 45 MIN. F.R.R 43 S.T.C
 (BETWEEM PRIMARY LIVING & SECONDARY SUITE)

(PROVIDE REQUIRED FIRE STOPS IN WALL

ASSEMBLIES TO COMPLY WITH

B.C. BLDG. CODE 9.10.16.)

W7. STUD SPACING
- UPPER FLOOR: 2"X6" @ 24" O/C
- MAIN FLOOR: 2"X6" @ 24" O/C
- LOWER FLOOR: 2"X6" @ 16" O/C
(if applicable)
- INTERIOR PARTITION: 2"X4"" @ 24" O/C
- LOAD BEARING: 2"X4"" @ 16" O/C
- PARTY WALL
(if applicable)

Foundation Walls

- . DAMPROOFING (where required) ON 8" THK. CONC. FOUNDATION WALL C/W 15 M BARS @ 24" o/c B/W
- F2. 16"X 8" CONC. FOOTINGS

 C/W 2 (TWO) 15m BARS CONT. 3 IN. FROM BOTT.

 ON UNDISTURBED SOIL (SOLID BEARING)
- F3. 4" PERIMETER DRAIN
 3" TIGHT PIPE FOR RWL
 DRAIN ROCK
- F4. ANCHOR BOLTS @ 4.0 FT. o/c MAX c/w SILL GASKETS
- F5. UNDER SLAB INSULATION
 2 1/2" (RSI 2.15) EXTRUDED POLYSTYRENE
 RIGID INSULATION 4'-0" (1.2M)
 CONT. AROUND PERIMETER UNDER
 SLAB INSTALLED HORIZONTALLY
 (VERIFY WITH MUNICIPALITY DEPTH OF FROST LINE)

'PORT' - COASTAL II

Date

Dec 22 2022

Project Address
3473 Trumpeter Street
Royal Bay - Sector 7
Colwood, B.C.

Prepared for

Verity Construction

Project #

8298

ScaleAs Noted

Drawn By


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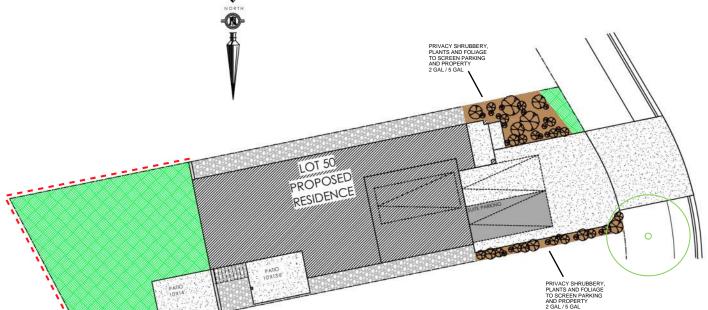
Development Permit Presentation

ALL FENCING, RETAINING AND LANDSCAPING MUST MEET THE **GUIDELINE REQUIREMENTS**

ALL RETAINING WALLS ARE TO BE STAND ALONE STRUCTURES (THEY MUST TERMINATE AT PROPERTY LINE) AND MUST NOT CONNECT TO RETAINING WALLS LOCATED ON ADJACENT PRIVATE PROPERTIES

*NOTE: In the interest of maintaining high standards, the developer reserves the right to modify plans. specifications and design without prior notice. Drawings contained within are artist renderings only. Sizes and dimensions are approximate and may vary with actual plan and survey. Exterior style may change pending municipal approval. Retaining wall location and types may vary and are subject to municipal, engineering or developer discretion. Subject to change without notice. Furniture as shown on plans are for layout purposes only




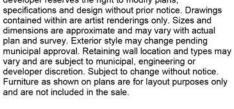


20000	ITEM	AREA (sf)	%
66	GARDEN BED	260	8%
	GRAVEL	511	16%
1	CONCRETE	1,077	35%
N///X	SOD	1,255	41%
	TOTAL	3,103	100%

LEGEND					
88	PRIVACY SHRUBBERY PRIVACY SHRUBBERY		UPGRADE SHRUBBERY, PLANTS AND FOLIAGE -2 GAL -5 GAL		




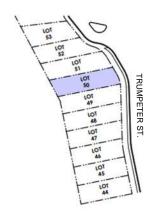

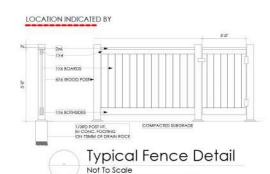

*TYPICAL FENCE DETAIL BASED OFF FENCE DETAIL 1/L1 FROM ROYAL BAY DESIGN GUIDELINES PAGE 21

ADDITIONAL NOTES: PROPERTY TO BE IRRIGATED 6" PIPE FOR DRIVEWAY SLEEVES TO BE INSTALLED FOR CITY IRRIGATION LINES

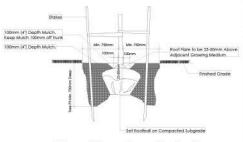

Tree Planting Detail All trees and plants by the home owner to be



	MM/DD/YY	ISSUED/REVISED
01	10/12/22	FOR APPROVAL
02	01/12/23	SITE PLAN REVISION
r e	i i	

ESTIMATED LOCATION OF REAR FENCING - SUBJECT TO CHANGE ACCORDING TO ACTUAL SITE CONDITIONS

PROJECT

DATE

LANDSCAPING PLAN LOT 50, 3473 TRUMPETER ST. **ROYAL BAY, SECTOR 7** CITY OF COLWOOD



QUALITY CONSTRUCTION. TRUSTED SERVICE.

106 - 1039 Langford Parkway Victoria, B.C. V9B 0A6


P: 250.474.1039 www.verityconstruction.ca


GABLECTAST HOMES BUILDING GRADE SLIP


WSP	Project	No:	201-08151-00
	,		

C. Hume - Oct. 26/22


GABLECIAIT HOWES	BUILDING	GRADE SLIP Issue Date:
MUNICIPAL		P.I.D.
ADDRESS 3473 Trumpeter Street LOT		PLAN
50		
VERITY HOMES		SUBDIVISION ROYAL BAY SECTOR 7
ADDRESS		DEVELOPER MEADOWS DEVELOPMENT LP
REPRESENTATIVE	PH.	CONSULTANT WSP CANADA INC
PROPOSED BUILDING GRADES		PLAN
ALL ELEVATIONS ARE METRIC GEODETIC +		LOT: PLAN:
MAIN FLOOR ELEVATION		TRUMPETER ST.
FRONT ELEV. 68.25 (FINISHED GRADE) REAR ELEV. 69.23/69.54 (FINISHED GRADE)	JOIS DEPT	TRUMPE
(FINISHED GRADE) (FINISHED GRADE) FINISHED GRADE AT GARAGE 68.35		160
TINDIED GRADE AT GARAGE	∑	-
	WEADROOM	. (89.10)
	HEA	
ACTUAL TOP OF FOOTING		- [2] 50 EG 67.7
LOWEST PERMITTED TOP OF	FLOOR SLA	- B MFE 68.62
(BOTTOM OF BASEMENT SLAB FROST WALLS ARE REQUIRED.)	Ī	MSE 65.42 MSE 65.42 S 64.90 D 64.92 LB 88
SERVICES FRONT REAR CENTER	REFER SIZE	- 88 × 9 · · · · · · · · · · · · · · · · · ·
	TO PLAN (mm)	7789
WATER	19	
SANITARY		(8) (8) (8) (8) (8) (8) (8) (8) (8) (8)
STORM	100	88.6
COMMENTS	YES NO	
DRAIN TO SUMP PUMP LIKELY REQUIRED		
(FOR BASEMENT IF INSTALLED)		LEGEND
(FOR BASEMENT IF INSTALLED)		STREET
SERVICES INSTALLED TO m INSIDE PROPERTY		SAN TAN
FOUNDATION SOIL BEARING INVESTIGATION CERTIFICATION REQUIRED		- SERVICE LOCATION (SHOWN ON ABOVE PLAN)
GEOTECHNICAL RESTRICTIONS APPLY (SEE GEOTECHNICAL REPORT)		SROW OF PROPOSED FRONT CORNER ELEVATIONS PROPOSED FRONT SIDE YARD GRADES
ENVIRONMENTAL RESTRICTIONS APPLY		PROPOSED FRONT CORNER ELEVATIONS PROPOSED FRONT SIDE YARD GRADES L# 6 L# 6 L# 6
(SEE ENVIRONMENTAL REPORT)		$\begin{bmatrix} 1.7 \\ 0.8 \end{bmatrix}$ EG 49.90 $\begin{bmatrix} 1.2 \\ 0.7 \end{bmatrix}$ — EXISTING GROUND ELEVATION
UTILITY EASEMENTS AFFECT THIS LOT		LFE/MFE 47.70 - LOWER/MAIN FLOOR ELEVATION GFE 47.55 - GARAGE FLOOR ELEVATION
		MSE 52.20 — MINIMUM SANITARY SERVICABLE
		S 49.12 (P) D 49.12 (P) ELEVATION BY GRAVITY SAN SERVICE INV. (P) DENOTES PUMP IS LIKELY REQUIRED
		FOR BASEMENT IF INSTALLED STORM SERVICE INV.
		(P) DENOTES PUMP IS LIKELY REQUIRED FOR BASEMENT IF INSTALLED
		→ PROPOSED REAR SIDE YARD GRADES
NOTES		
IT IS THE RESPONSIBILITY OF THE BUILDER TO I ARE PLACED ON A PROPER BASE THAT IS FREE EXCESSIVE MOISTURE AND DELETERIOUS MATERI.	FROM FROST,	LANE/LOT - PROPOSED REAR CORNER ELEVATIONS
APPROPRIATE FROST PROTECTION WHEN COMPLE		
2. THE INFORMATION CONTAINED HEREIN IS BASED LOT GRADING PLAN FOR THIS SUBDIVISION. UN DEVIATIONS WILL BE THE RESPONSIBILITY OF TH ENSURE COMPLIANCE WITH ALL LOCAL BYLAWS.	-AUTHORIZED	I, THE BUILDER'S REPRESENTATIVE, CERTIFY THAT THE FINAL HOUSE PLANS PROVIDED IN THE BUILDING PERMIT
3. OTHER NOTES:		APPLICATION ARE THE SAME AS PROCESSED UNDER THIS GRADE SLIP AND THAT I UNDERSTAND THE INFORMATION AND THE REQUIREMENTS CONTAINED HEREIN AND WILL BUILD ACCORDINGLY.
		AUTHORIZED BUILDER'S REPRESENTATIVE DATE
		THE INFORMATION CONTAINED HEREIN IS BASED ON THE APPROVED LOT GRADING PLAN FOR THIS SUBDIVISION, DATED

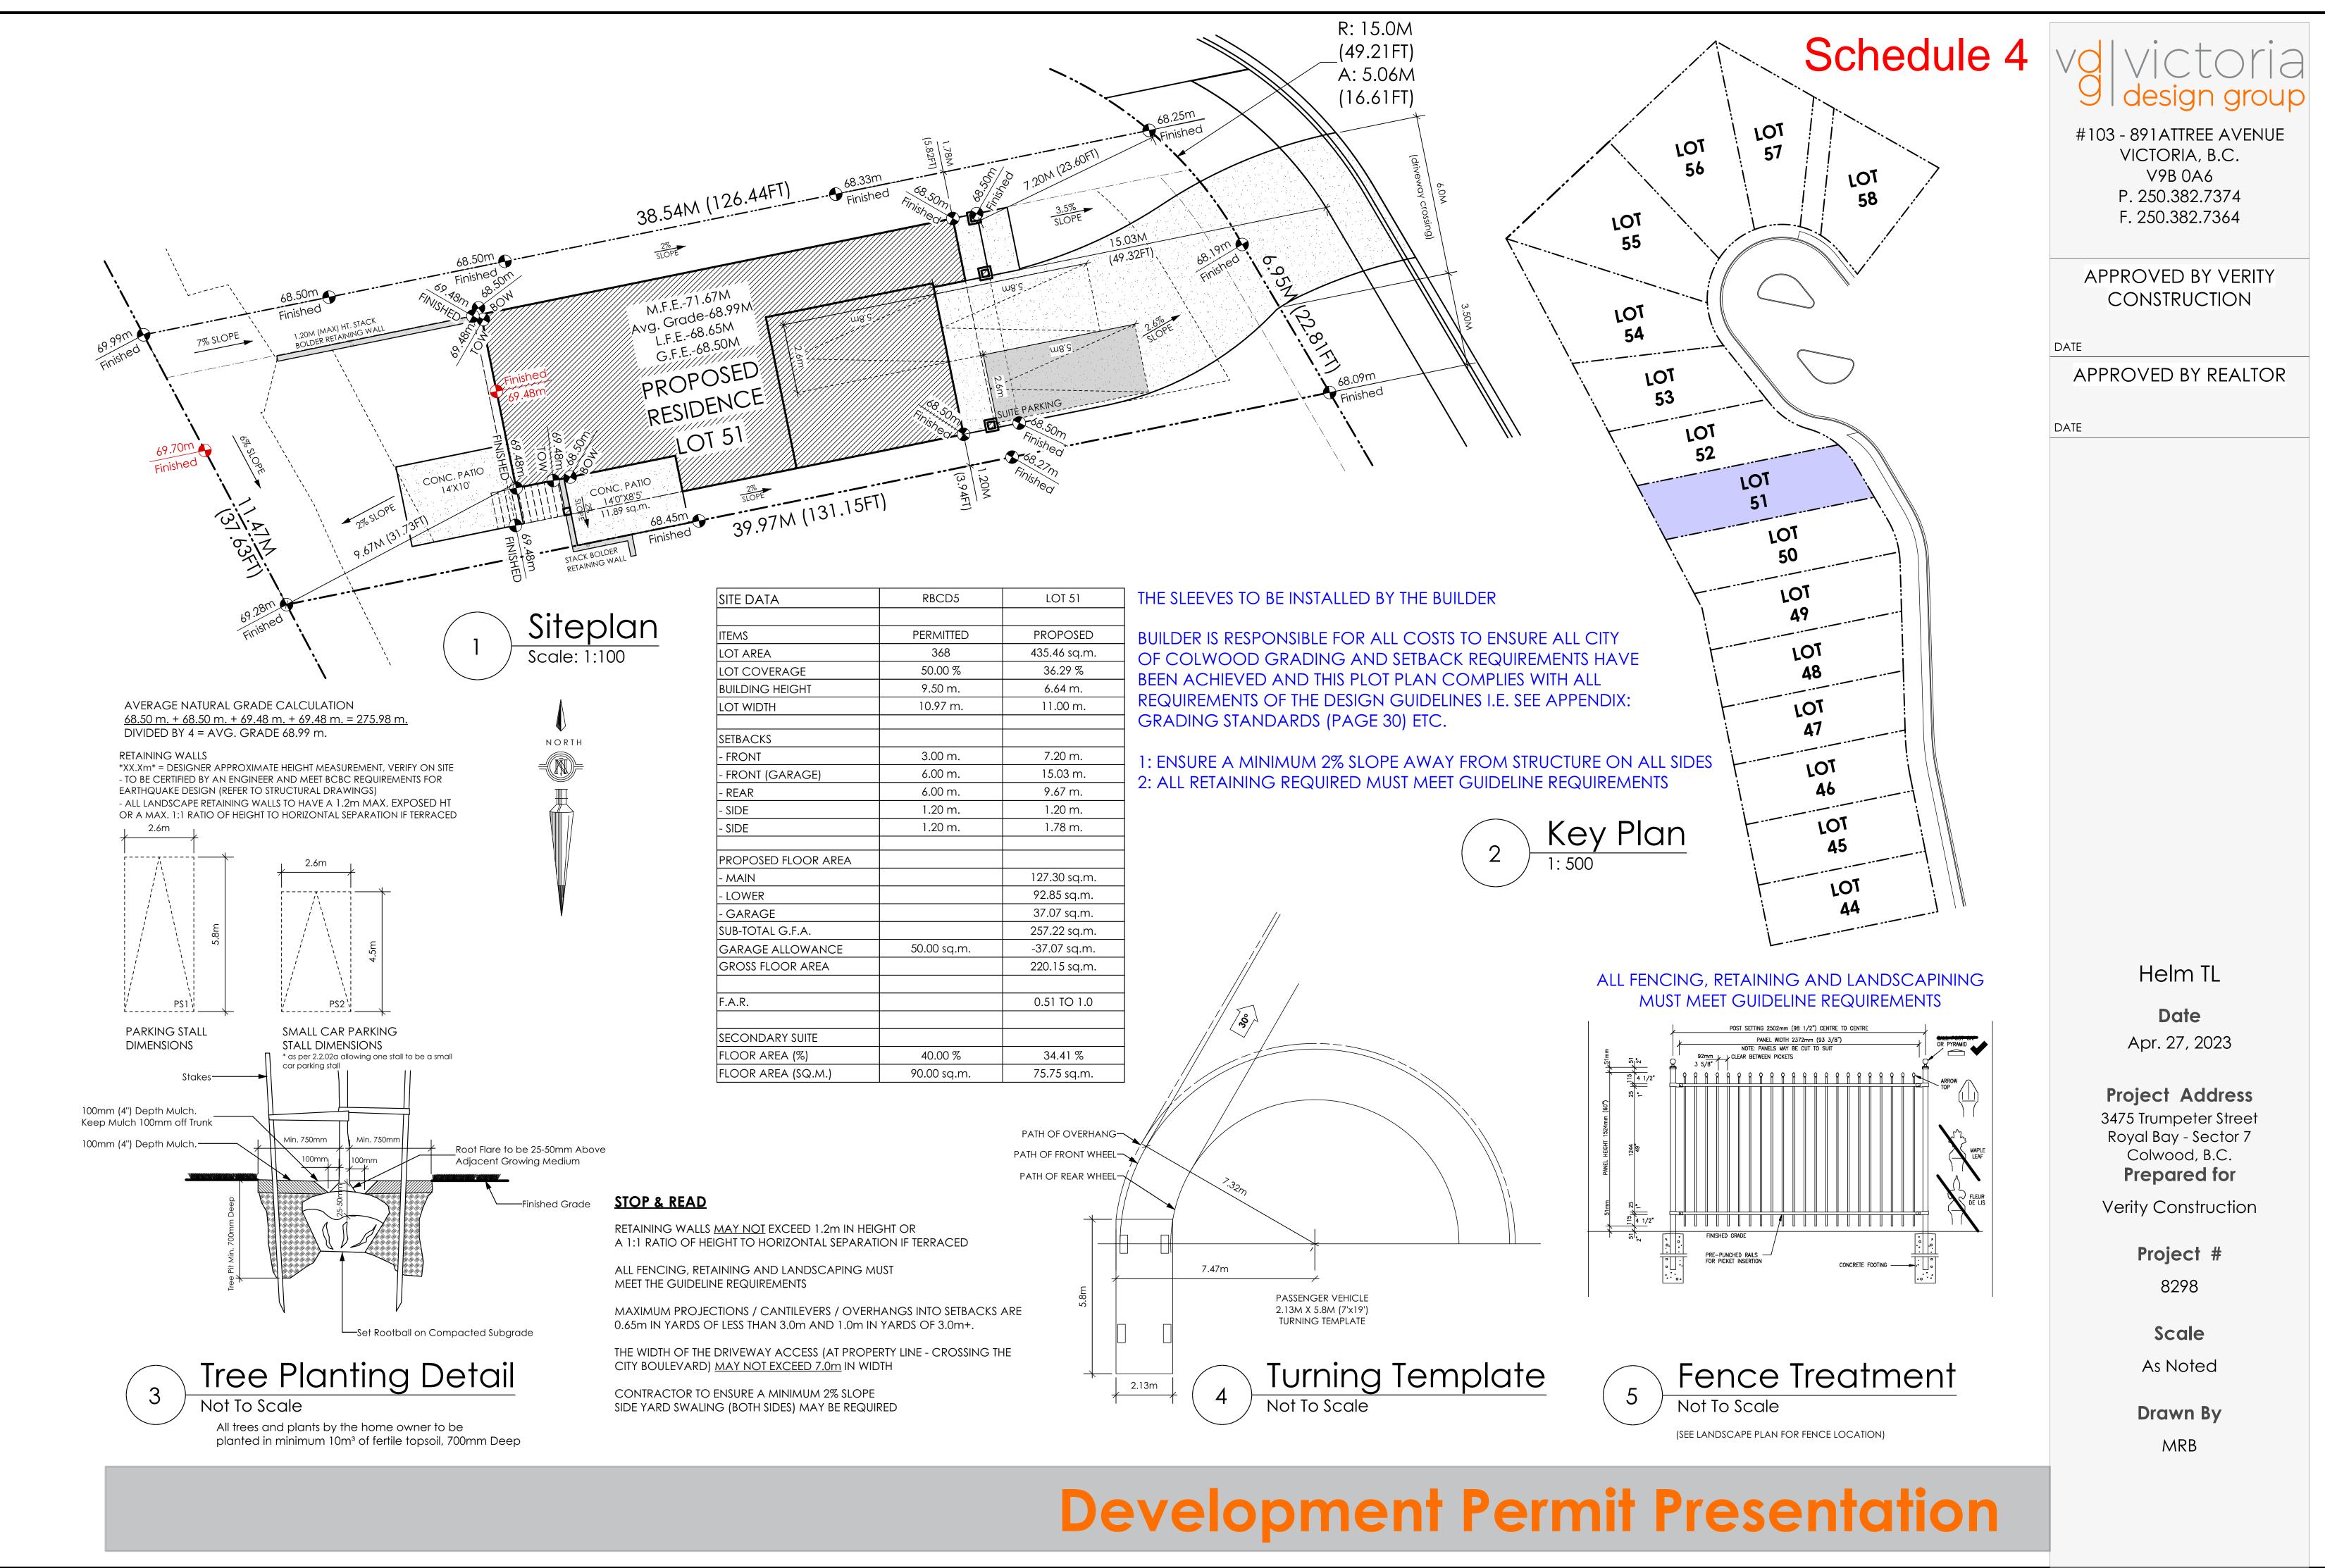

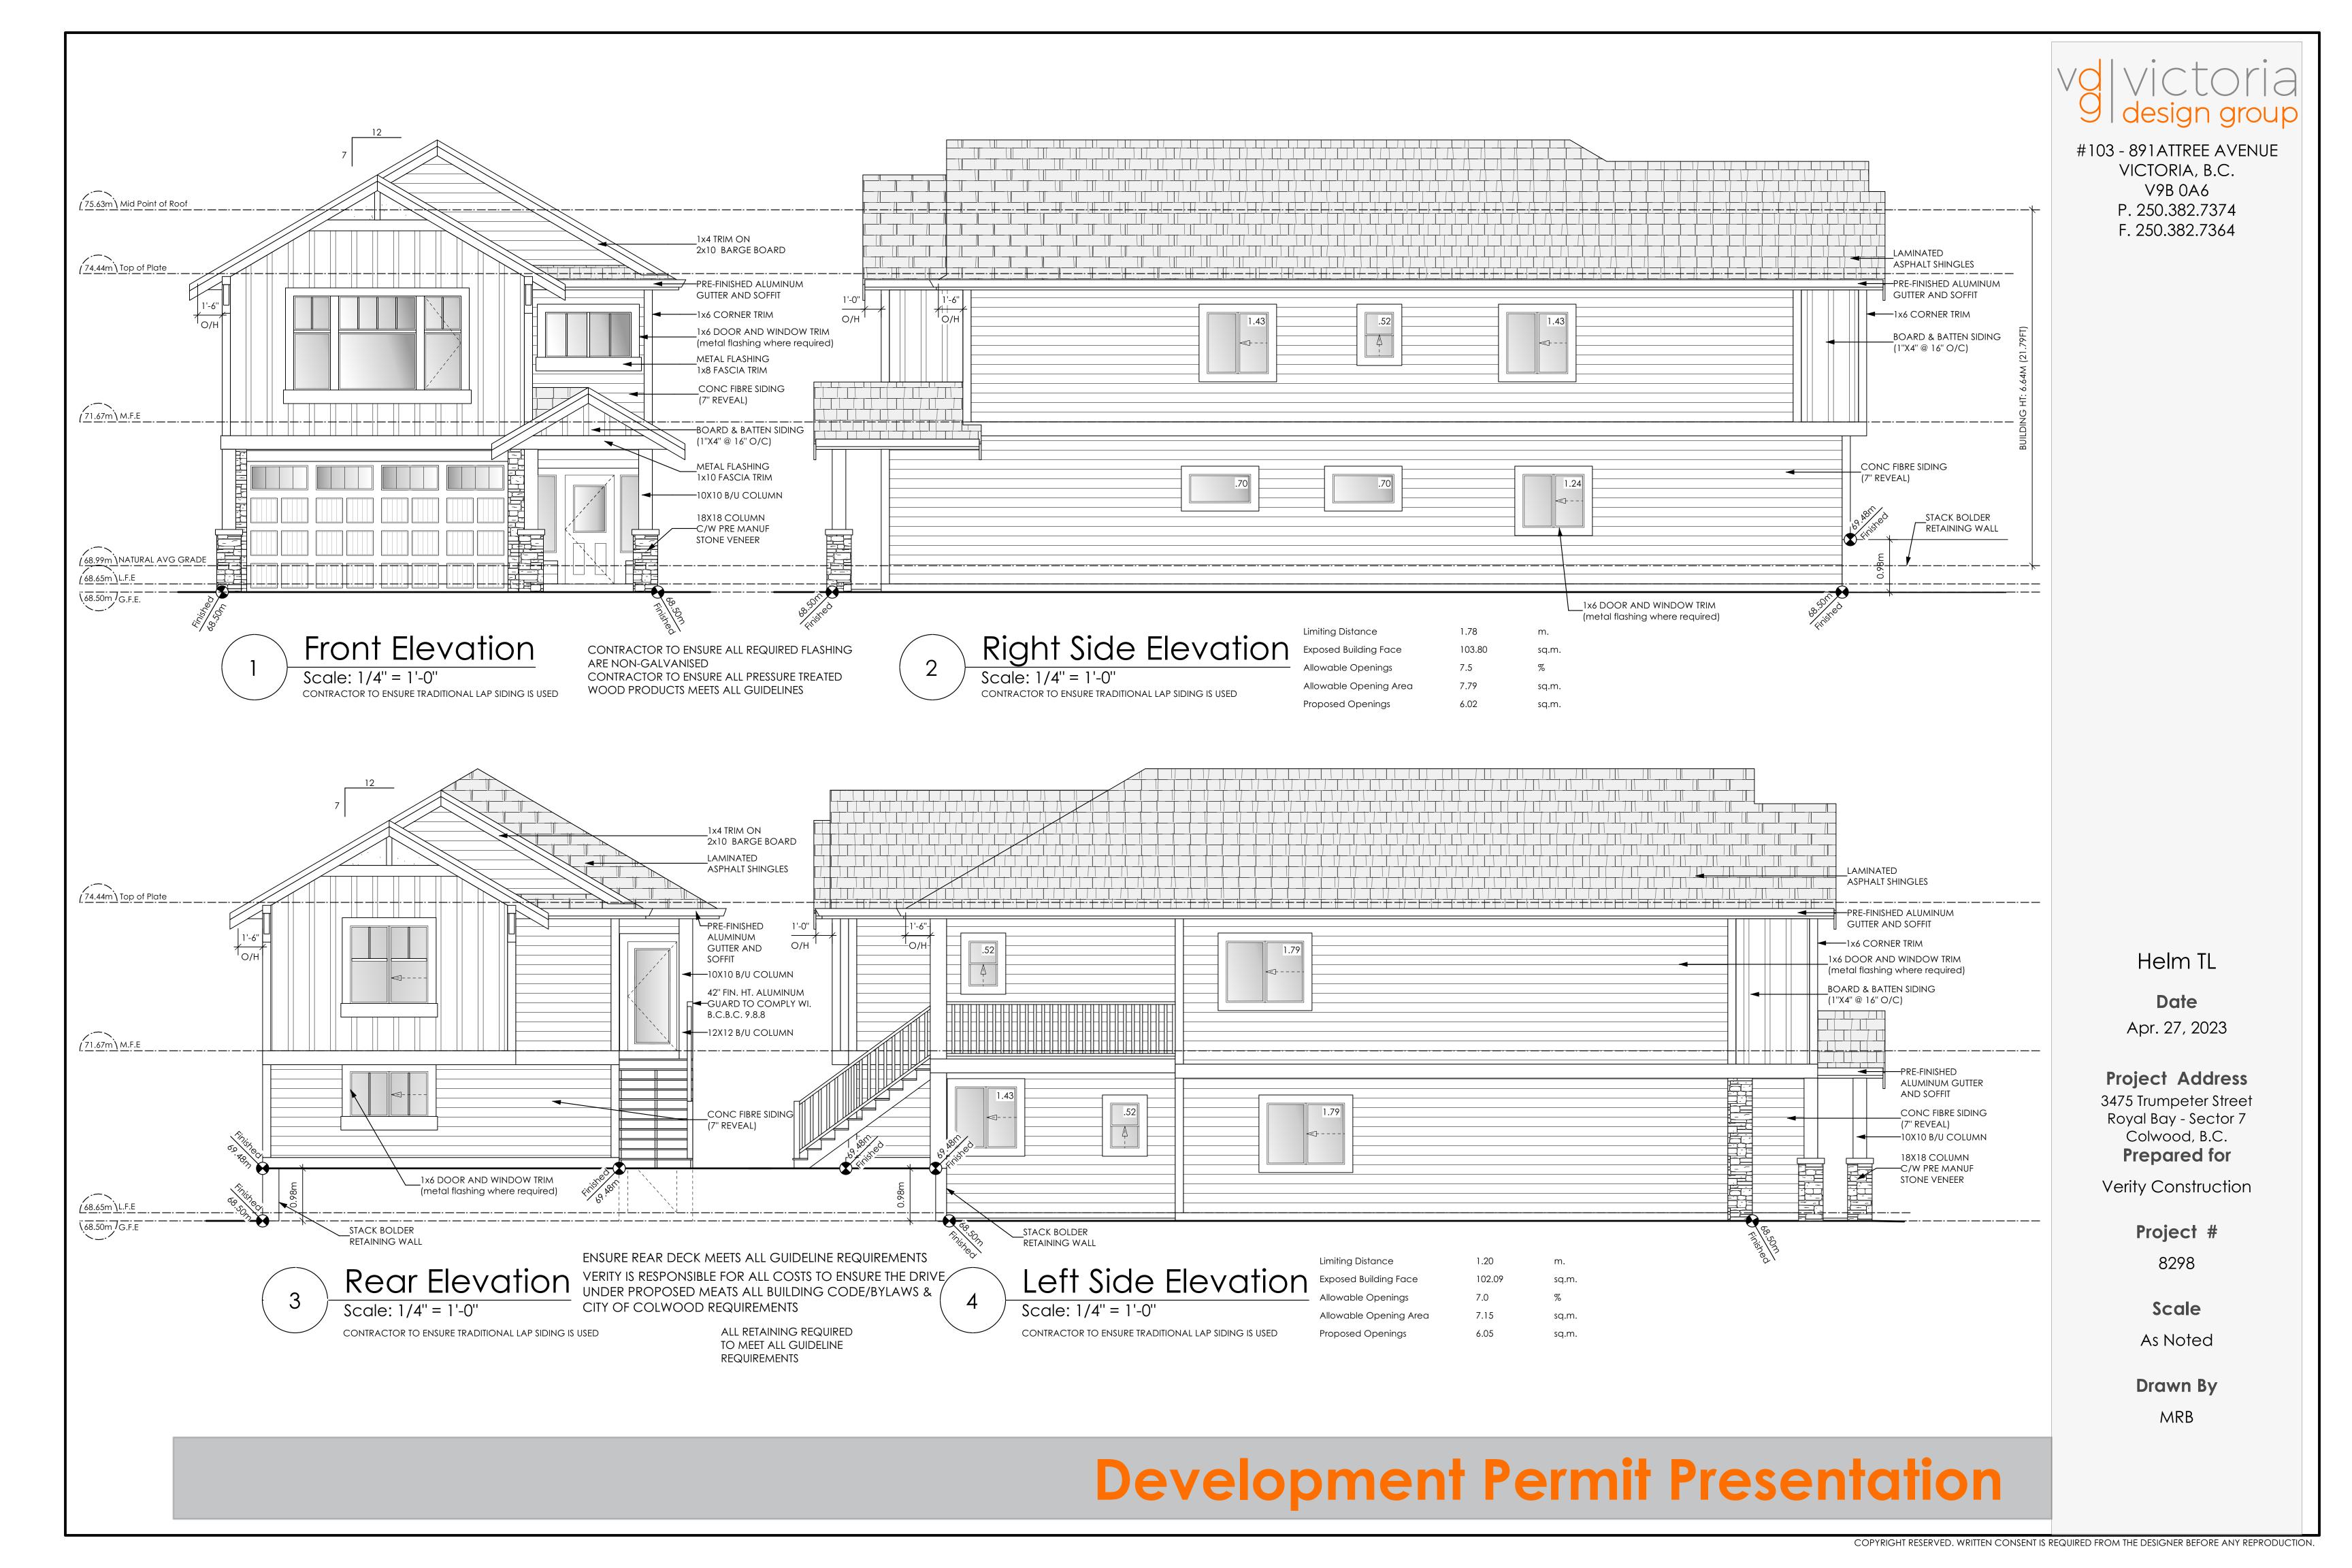

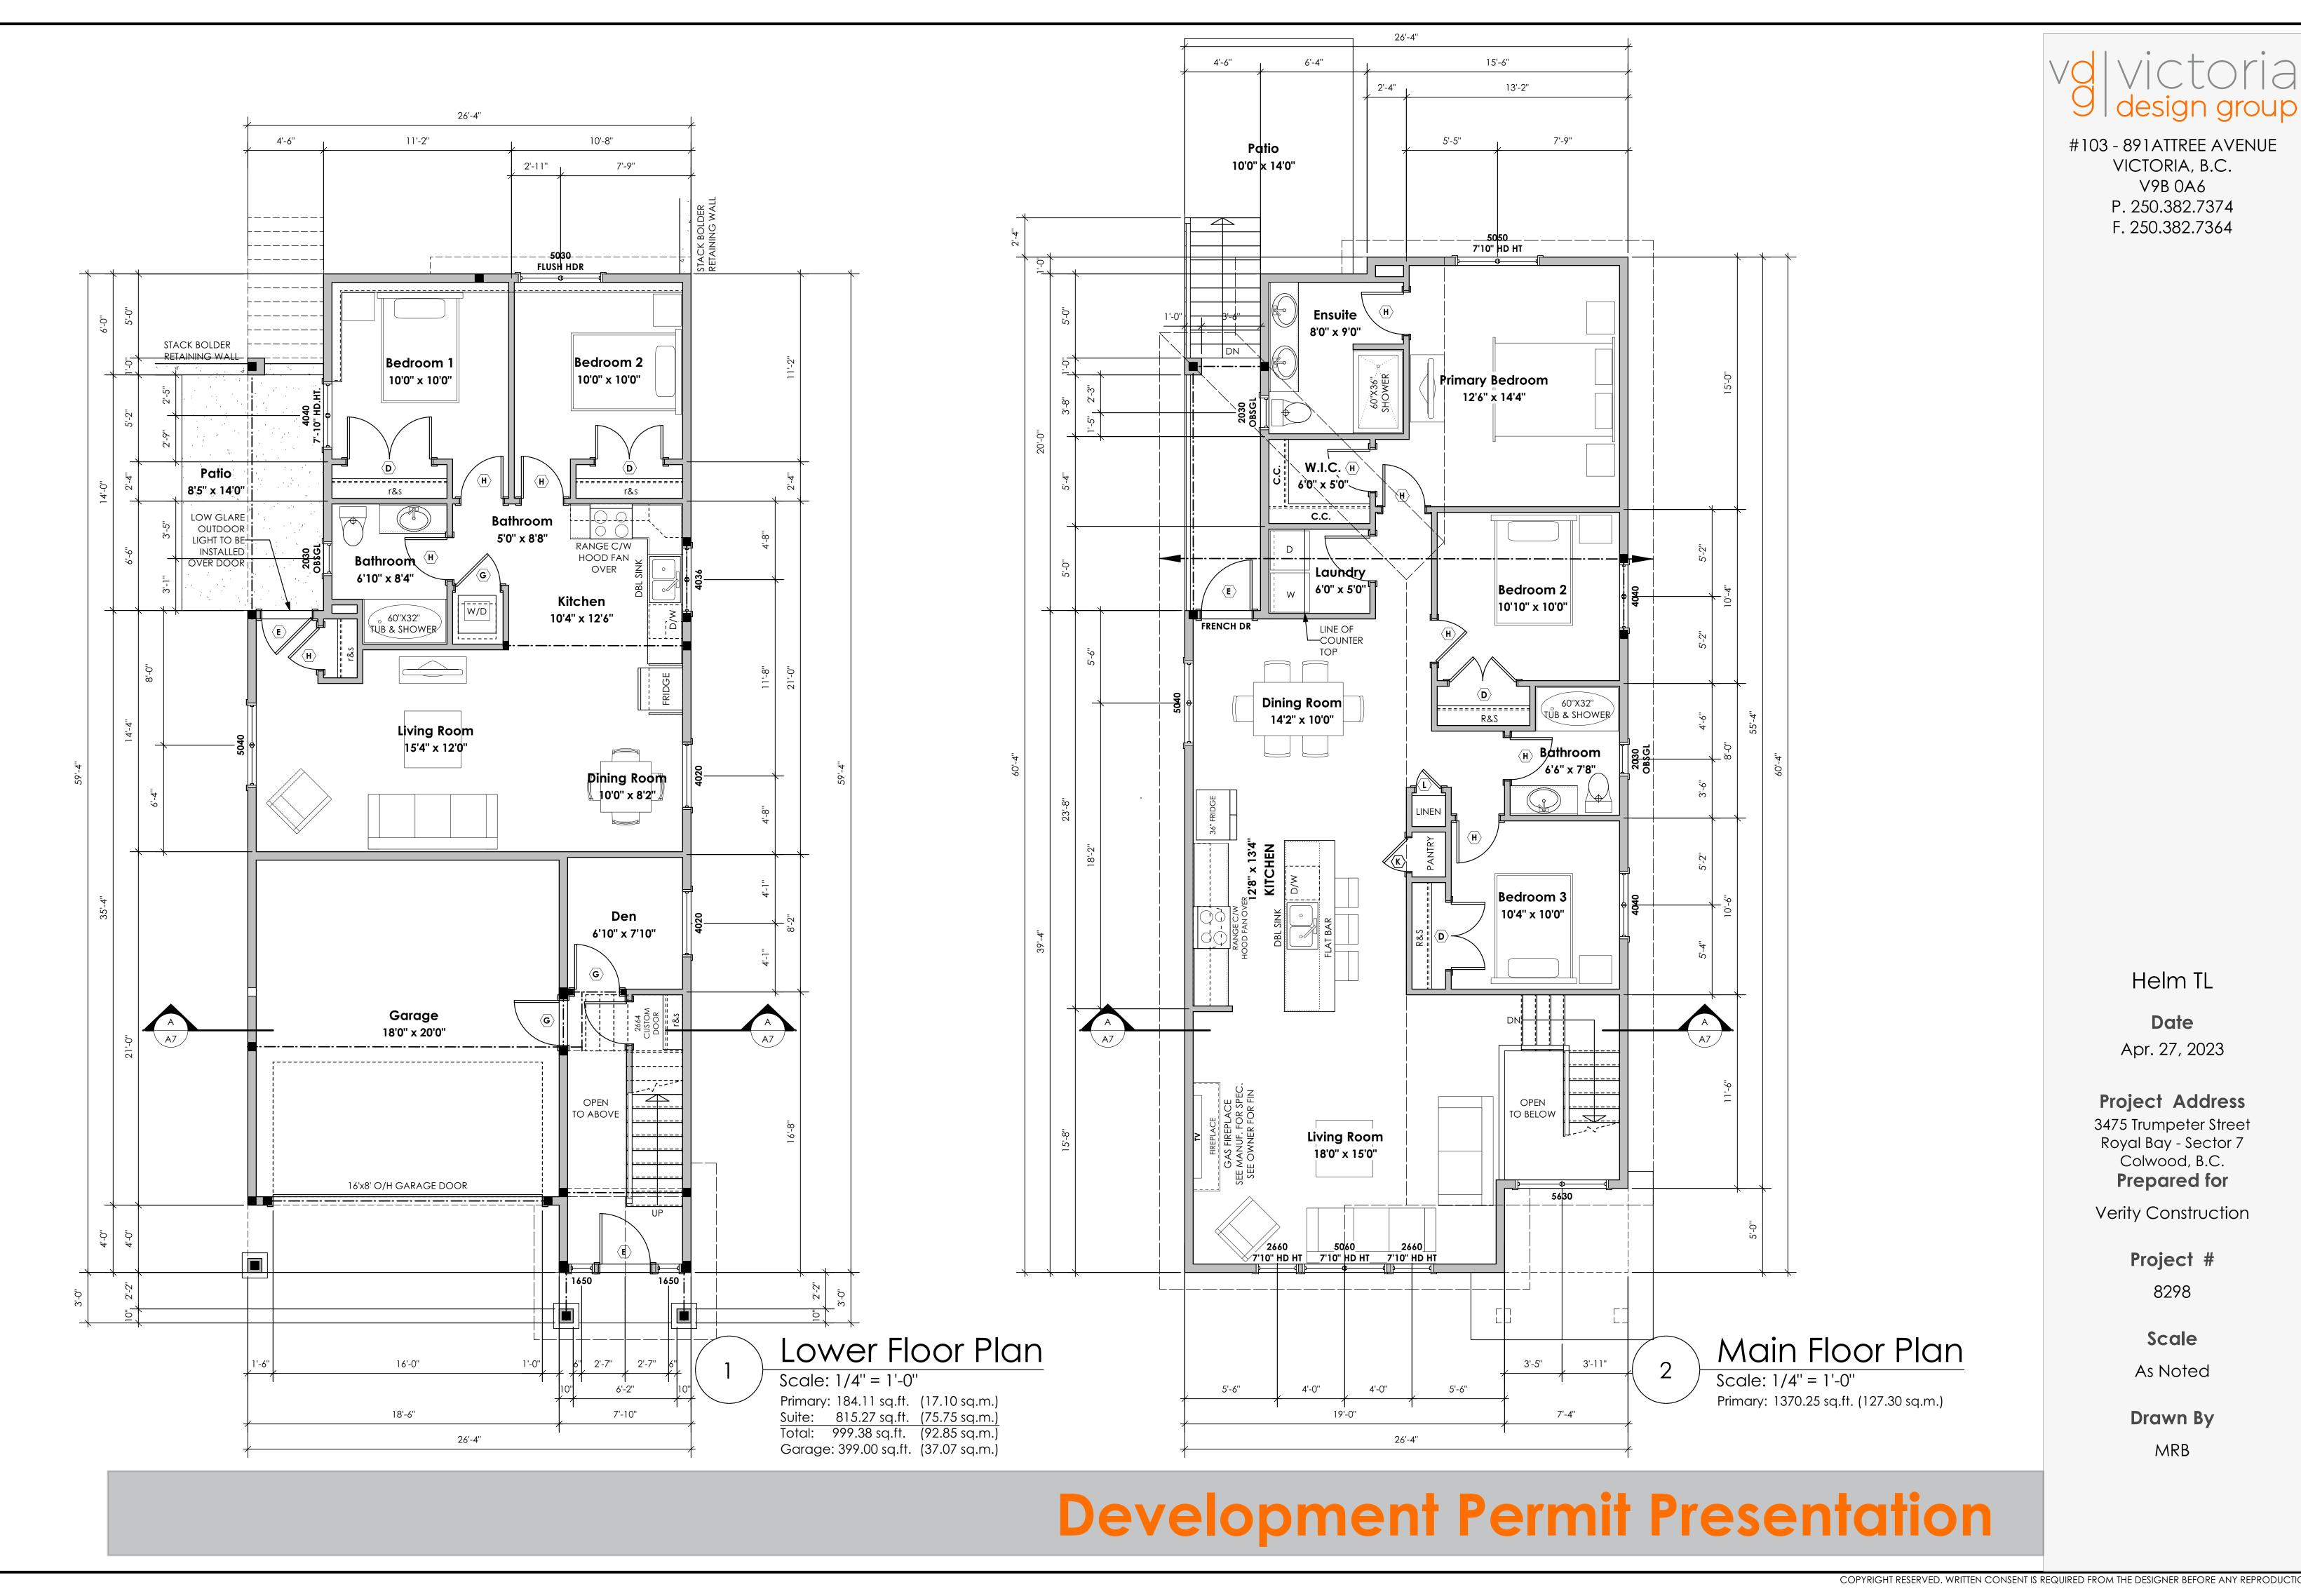

Section Notes

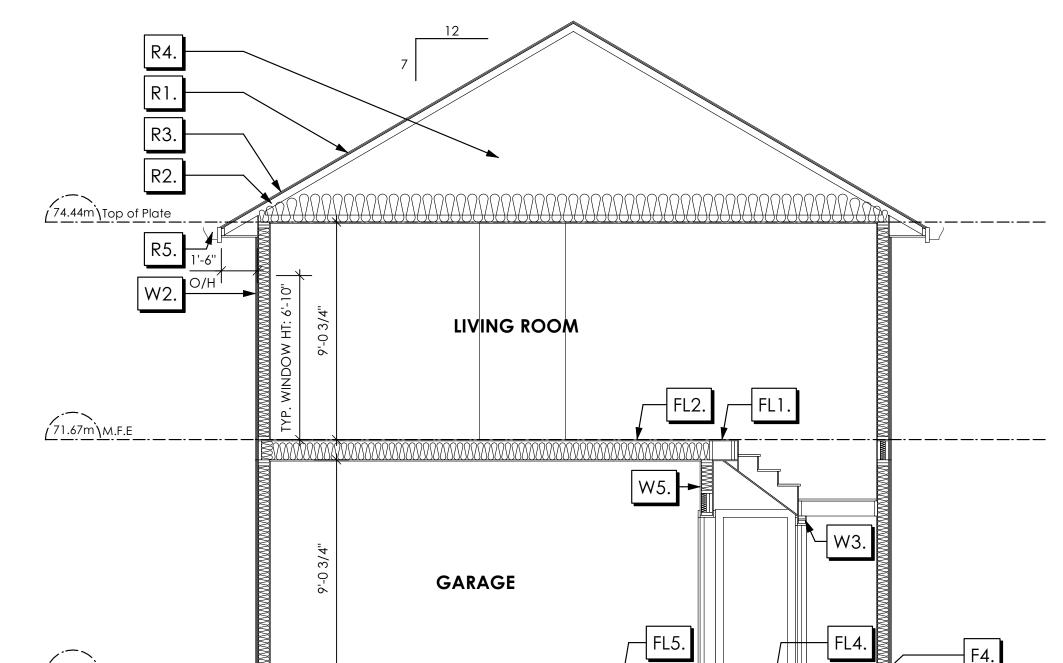

Scale: 1/4" = 1'-0"

ALL STRUCTURE TO BE VERIFIED OR DESIGNED BY A STRUCTURAL ENGINEER.
STRUCTURAL ENGINEER TO LOCATE AND DESIGN WALLS TO RESIST LATERAL LOADS.

ALL STRUCTURE TO BE VERIFIED OR DESIGNED BY A STRUCTURAL ENGINEER.

STRUCTURAL ENGINEER TO LOCATE AND DESIGN REQUIRED EXTERIOR

AND INTERIOR BRACED WALL PANELS TO RESIST LATERAL LOADS IN COMPLIANCE

WITH B.C. BUILDING CODE 9.23.13.2 AND SUPPLY DETAILS IF REQUIRED

FOUNDATION WALLS

- F1. DAMP PROOFING (WHERE REQUIRED) ON 8" THK. CONC. FOUNDATION WALL C/W 15 M BARS @ 24" O/C B/W
- F2. 16"X 8" CONC. FOOTINGS

 C/W 2 (TWO) 15M BARS CONT. 3 IN. FROM BOTT.

 ON UNDISTURBED SOIL (SOLID BEARING)
- F3. 4" PERIMETER DRAIN 3" TIGHT PIPE FOR RWL DRAIN ROCK
- F4. ANCHOR BOLTS @ 4.0 FT. O/C MAX C/W SILL GASKETS
- F5. UNDER SLAB INSULATION
 2 1/2" (RSI 2.15) EXTRUDED POLYSTYRENE
 RIGID INSULATION 4'-0" (1.2M)
 CONT. AROUND PERIMETER UNDER
 SLAB INSTALLED HORIZONTALLY
 (VERIFY WITH MUNICIPALITY DEPTH OF FROST LINE)
 (NOT IN SECTION)

ROOFS

- R1. LAMINATED ASPHALT SHINGLES ON
 7/16" ORIENTED STRAND BOARD C/W "H" CLIPS
 WD TRUSSES (DESIGNED BY MANUF.)
 14 1/2" FIBRE GLASS LOOSE FILL INSULATION
 (ALLOW FOR SETTLING)
 6 MIL POLY'N V.B.
 5/8" GYPSUM BOARD
- R2. PROVIDE 2 1/2" (63MM) CLEAR BETWEEN
 R-20 INSULATION AND SHEATHING.
 (MIN. R-20 @ ROOF-WALL CONNECTION FOR
 4'-0" (1.2M) AROUND PERIMETER OF BUILDING.
 AIR VENTILATION BAFFLES TO BE INSTALLED
 WHERE REQUIRED IN AS PER BCBC 9.19.)
- R3. EAVE PROTECTION
 CONT. UP ROOF SLOPE FOR 12"
 PAST EXTERIOR WALL.
- R4. PROVIDE 1 SQ.FT. ATTIC VENT PER
 300 SQ.FT. OF INSULATED AREA MIN.
 25% OF REQUIRED TO BE @ TOP AND BOTTOM
 (TO COMPLY WI. B.C. BLDG. CODE 9.19.1)
- R5. PRE-FIN. FASCIA GUTTER
 2×8 FASCIA BD.
 2×4 SUB. FASCIA BD.
 VENTED SOFFIT
 (SEE CONTRACTOR)

FLOORS

- FL1. FINISHED FLOORING ON
 11/16" ORIENTED STRAND BOARD
 (NAILED & GLUED TO FLOOR STRUCT. BELOW) ON
 2×10 FLOOR JOISTS @ 16" OR 12" O/C
 C/W 2×2 X-BRIDGING @ 7.0' O/C (MAX)
 1/2" GYPSUM BOARD
- FL2. FINISHED FLOORING ON
 11/16" ORIENTED STRAND BOARD
 (NAILED & GLUED TO FLOOR STRUCT. BELOW) ON
 2×10 FLOOR JOISTS @ 16" OR 12" O/C
 C/W 2×2 X-BRIDGING @ 7.0' O/C (MAX)
 R-31 INSULATION
 5/8" X-TYPE GYPSUM BOARD
 (BETWEEN GARAGE AND LIVING SPACE)
- FL3. FINISHED FLOORING ON
 19/32" ORIENTED STRAND BOARD
 (FASTENED & GLUED TO FLOOR STRUCT. BELOW) ON
 2×10 FLOOR JOISTS @ 16" OR 12" O/C
 C/W 2×2 X-BRIDGING @ 7.0' O/C (MAX)
 PROVIDE R-31 F/G BATT INSULATION IN
 JOIST CAVITY C/W
 BUILDING WRAP
 VENTED SOFFIT (TO OWNERS SPEC'S)
 TO ALL SUSPENDED FLOOR AREAS
- FL4. 3 1/2" CONCRETE SLAB 6 MIL. POLY'N V.B. 6" COMPACTED GRAVEL OR SAND

(NOT SHOWN IN SECTION)

- FL5. 3 1/2" CONCRETE SLAB
 6 MIL. POLY'N V.B.
 6" COMPACTED GRAVEL OR SAND
 SLOPE TO DOORS 1"
- FL6. F8d RATED FLOOR ASSEMBLY
 (BC BUILDING CODE TABLE 9.10.3.1.B)
 FINISHED FLOORING ON
 19/32" ORIENTED STRAND BOARD OR EQ.
 (FASTENED & GLUED TO FLOOR STRUCT. BELOW) ON
 2×10 FLOOR JOISTS @ 16" OR 12" O/C
 C/W 2×2 X-BRIDGING @ 7.0' O/C (MAX)
 R-31 INSULATION
 RESILIENT METAL CHANNELS @ 24" O/C
 1 LAYERS 5/8" X-TYPE GYPSUM BOARD
 30 MINUTE F.R.R., 50 S.T.C.
 (NOT SHOWN IN SECTION)
- FL7. DECKING MEMBRANE
 (TO COMPLY WITH CAN/CGSB 37.54) ON
 19/32" ORIENTED STRAND BOARD OR EQ.
 C/W "H" CLIPS ON
 2×10 DECK JOISTS @ 16" O/C C/W
 (PROVIDE ADEQUATE MEMBRANE
 "UPSTAND" @ EXT. WALL.)
 (SLOPE JOISTS OR SLOPED WOOD TAPERS
 TO PROVIDE MIN.1:50 SLOPE)

(NOT SHOWN IN SECTION)

WALLS

- W1. DOUBLE GLAZING ENERGY STAR LOW "E" RATING IN THERMAL BREAK FRAMES 2/2"X10" LINTEL OVER (@ BEARING WALLS ONLY) (TYPICAL, WI. 2 1/2" XPS INSULATION) FLASHING OVER @ EXTERIOR (GLAZING IN ALL EXTERIOR DOORS & WITHIN 3 FT. OF EXTERIOR DOORS TO BE SHATTERPROOF (SP)) WINDOW REQUIREMENTS DERIVED FROM BCBC TABLE C-4 AS PER BCBC 9.7.4.3. AND ARE TO BE USED TO SATISFY THE REQUIREMENTS OF AAMA/WDMA/CSA 101/I.S.2/A440, "NAFS": LANGFORD, CLASS R, DP 960, PG 20, WATER RESIST. 220, A2, RATINGS MUST BE CLEARLY LABELED ON ALL WINDOW UNITS UPON INSTALLATION FOR INSPECTION. (NOT SHOWN IN SECTION)
- W2. CONC. FIBRE BOARD ON
 9.5MM (3/8") AIR SPACE / STRAPPING
 3/8"×2" BORATE TREATED PLYWOOD STRAPPING
 HOUSE WRAP (A.B.) (TYVEK OR EQ.)
 7/16" ORIENTED STRAND BOARD SHEATHING
 2×6 STUDS @ 16" O/C
 R-20 INSULATION
 6 MIL. POLYETHYLENE VAPOUR BARRIER
 1/2" GYPSUM BOARD
 (REFER TO DETAILS ON D1)
- W3. INTERIOR PARTITION
 1/2" GYPSUM BOARD ON EACH SIDE
 OF 2×4 STUDS @ 16" O/C OR
 2×6 STUDS @ 16" O/C (IF NOTED)
- W4. PRE-MANUFACTURED STONE VENEER
 (INSTALLED TO MANUF. SPEC)
 LIME BASED MORTAR SETTING BED ON
 LIME BASED MORTAR SCRATCH COAST ON
 METAL LATHE INSTALLED HORIZONTALLY
 OVERLAP HORIZONTAL AND VERTICAL SEAMS 1"
 SEMI-RIGID BACK BOARD
 (HAL-TEX RAINBOARD OR EQ.)
 9.5MM (3/8") AIR SPACE / STRAPPING
 3/8"×2" BORATE TREATED PLYWOOD STRAPPING
 HOUSE WRAP (A.B.) (TYVEK OR EQ.)
 7/16" ORIENTED STRAND BOARD SHEATHING
 2×6 STUDS @ 16" (AS REQUIRED)
 (NOT SHOWN IN SECTION)
- W5. 5/8" X-TYPE GYPSUM BOARD ON 2×6 STUDS @ 16" O/C C/W R-20 INSULATION 6 MIL. POLY'N V.B 1/2" GYPSUM BOARD (BETWEEN GARAGE & LIVING)
- W6. 1/2" GYPSUM BOARD ON
 6 MIL. POLY'N V.B.
 2×4 STUDS @ 24" O/C C/W
 R-12 BATT INSULATION
 2 PLY 30 MINUTE BUILDING PAPER OR
 12.7MM (1/2") AIR SPACE
 (PROVIDE REQUIRED FIRE STOPS IN WALL
 ASSEMBLIES TO COMPLY WITH
 B.C. BLDG. CODE 9.10.16.)
 (NOT SHOWN IN SECTION)
- W7. B.C. BUILDING CODE (TABLE 9.10.3.1.A)
 RATED WALL ASSEMBLY W3c
 1 LAYER 1/2" X-TYPE GYPSUM BOARD
 RESILIENT METAL CHANNELS @ 24" O/C
 2×4 STUDS @ 16" O/C OR
 2×6 STUDS @ 16" O/C (IF NOTED) C/W
 3 1/2" FIBRE GLASS SOUND BATTS
 1 LAYER 1/2" X-TYPE GYPSUM BOARD
 45 MIN. F.R.R 43 S.T.C
 (BETWEEN PRIMARY LIVING / GARAGE
 & SECONDARY SUITE)
 (NOT SHOWN IN SECTION)

Helm TL

Date Apr. 27, 2023

Project Address
3475 Trumpeter Street
Royal Bay - Sector 7
Colwood, B.C.
Prepared for

Verity Construction

Project #

8298


As Noted

Scale

Drawn By


MRB

Development Permit Presentation

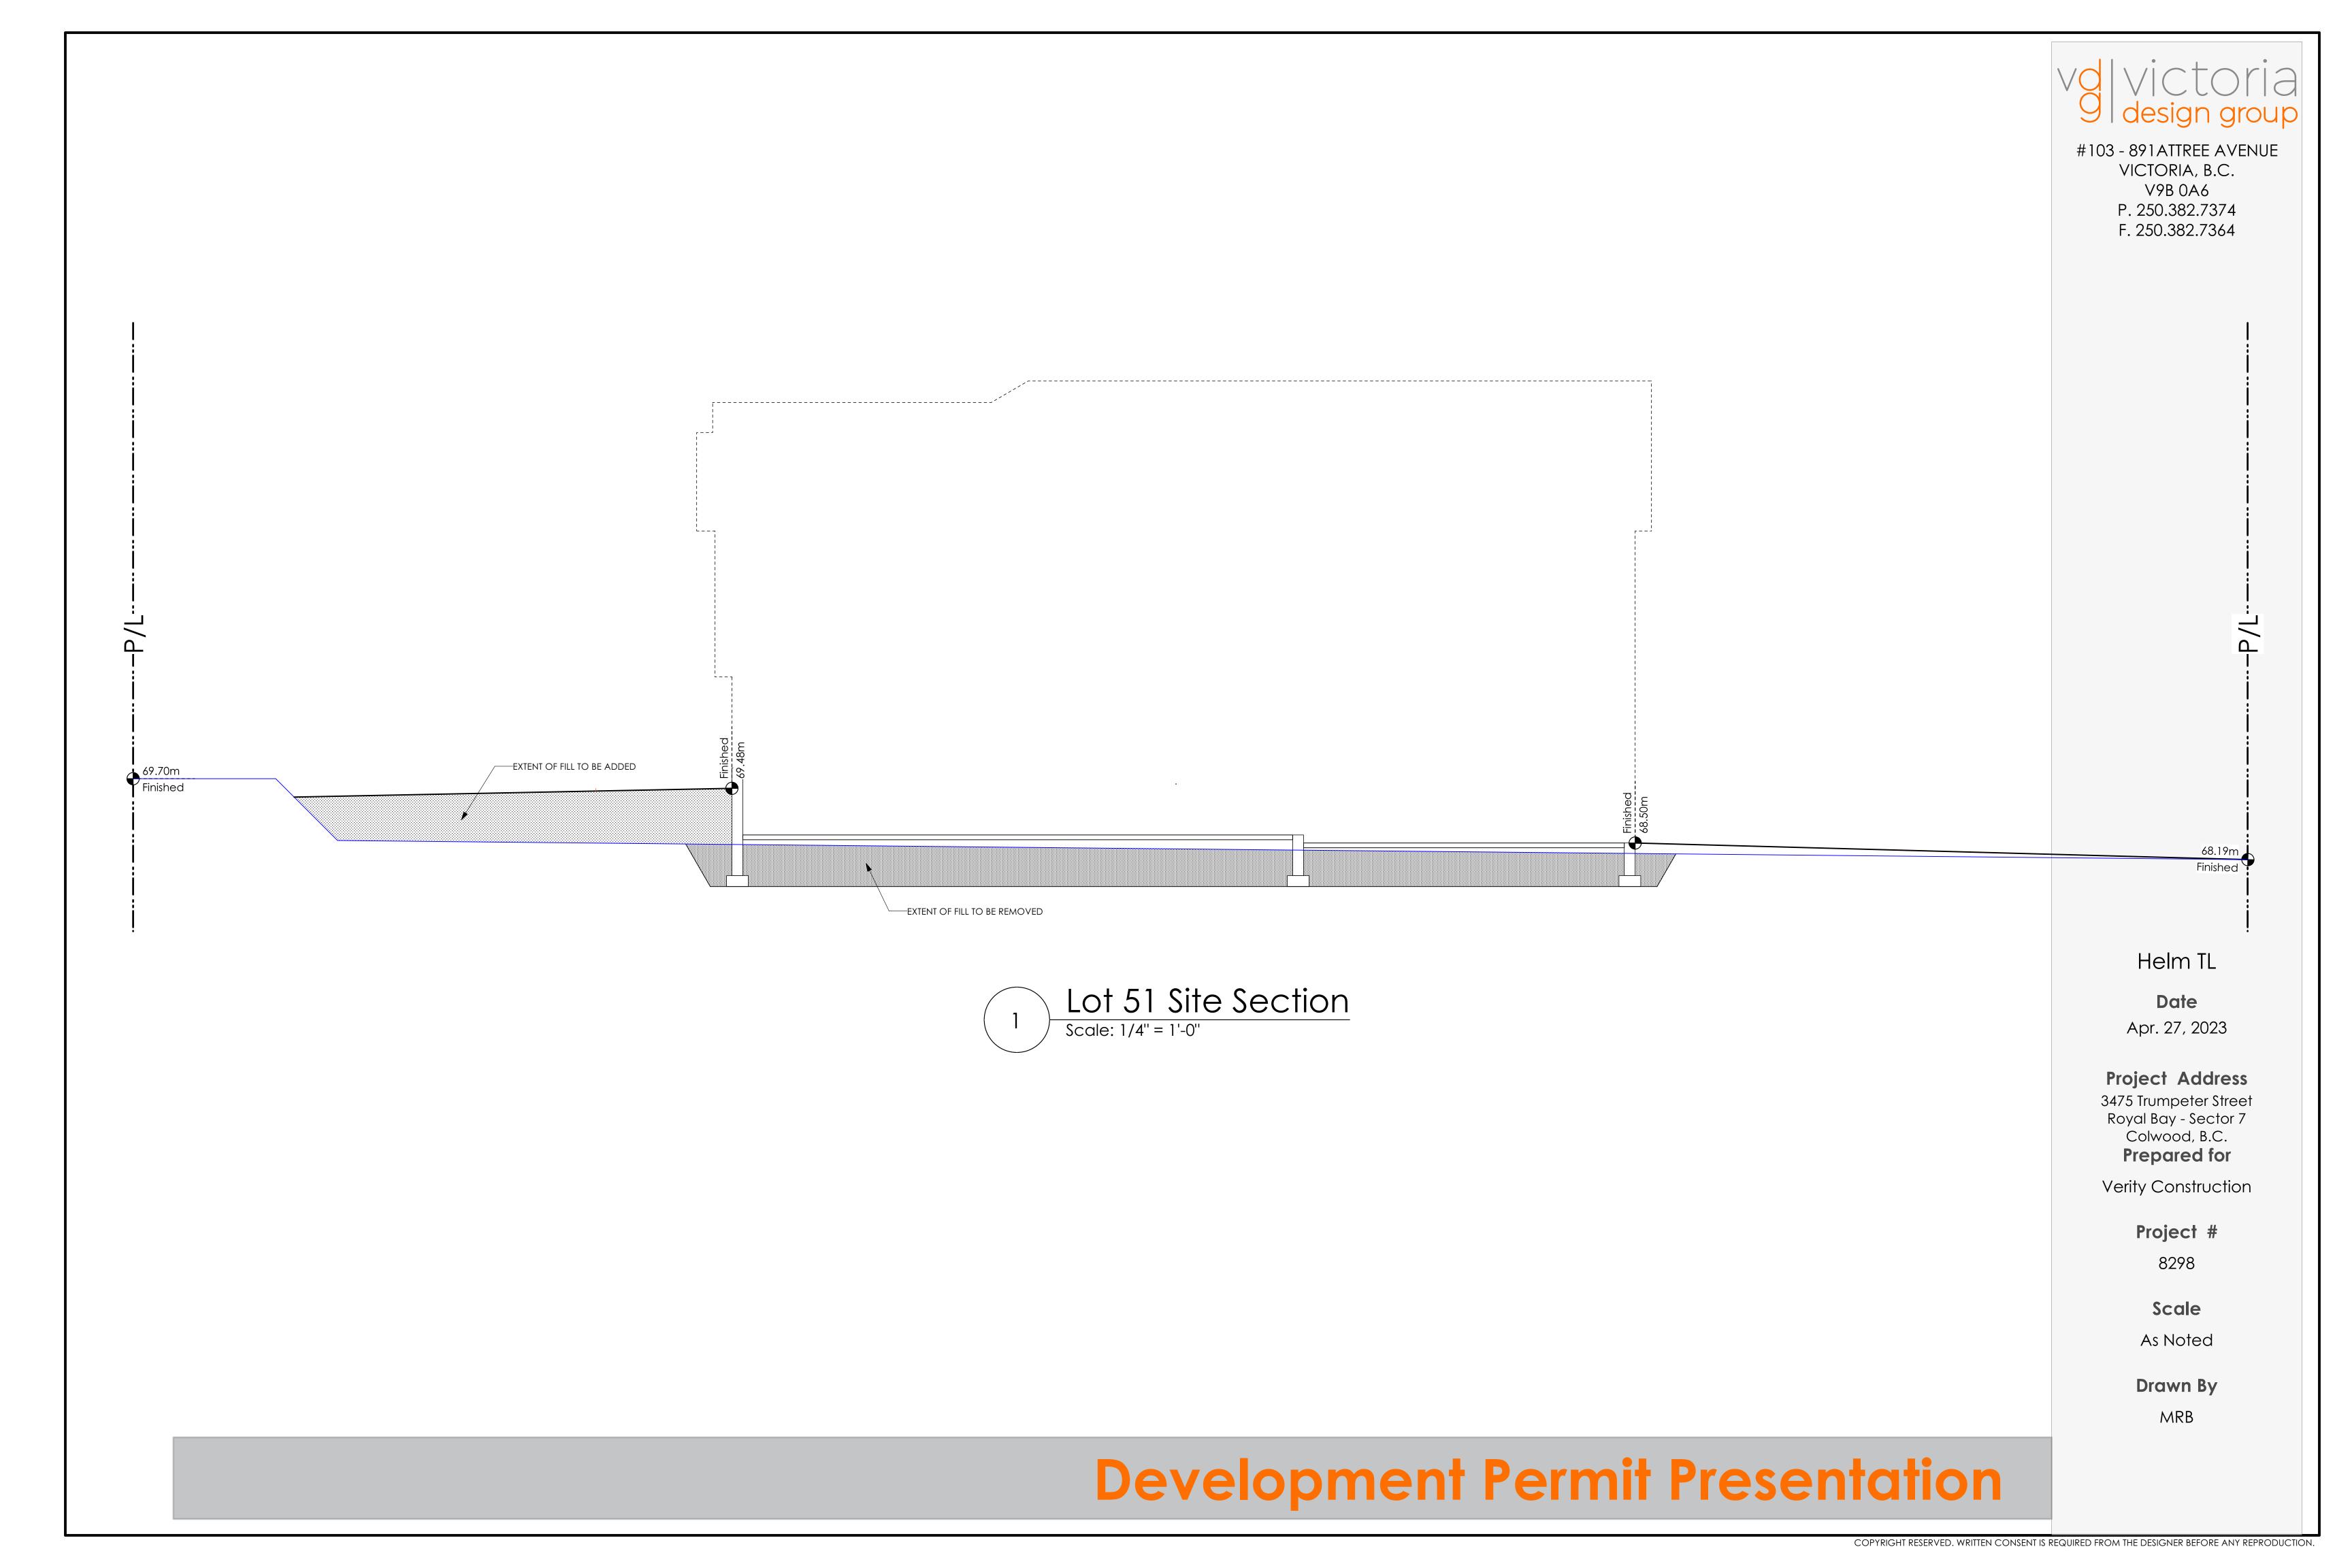

ALL FENCING, RETAINING AND LANDSCAPING MUST MEET THE GUIDELINE REQUIREMENTS


ALL RETAINING WALLS ARE TO BE STAND ALONE STRUCTURES (THEY MUST TERMINATE AT PROPERTY LINE) AND MUST NOT CONNECT TO RETAINING WALLS LOCATED ON ADJACENT PRIVATE PROPERTIES *NOTE: In the interest of maintaining high standards, the developer reserves the right to modify plans, specifications and design without prior notice. Drawings contained within are artist renderings only. Sizes and dimensions are approximate and may vary with actual plan and survey. Exterior style may change pending municipal approval. Retaining wall location and types may vary and are subject to municipal, engineering or developer discretion. Subject to change without notice. Furniture as shown on plans are for layout purposes only and are not included in the sale.

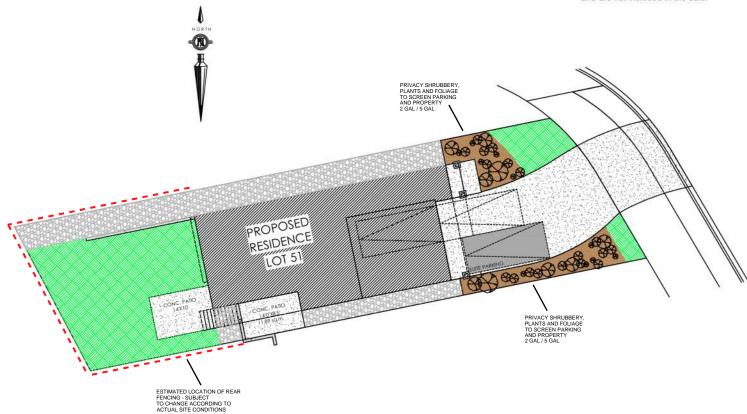

	ITEM	AREA (sf)	%
88	GARDEN BED	328	10%
ER	GRAVEL	772	24%
1	CONCRETE	1,064	32%
	SOD	1,099	34%
	TOTAL	3,263	100%

LEGEND

PRIVACY
SHRUBBERY
PRIVACY
SHRUBBERY
PRIVACY
SHRUBBERY
FRANCY
SHRUBBERY
FRANCY
SHRUBBERY
FRANCY
SHRUBBERY
FRANCY
SGAL

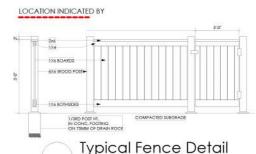

Typical Fence Deta

Not To Scale


**TYPICAL BEAUGUER AND OFF FRANCE SEA A. I/L.)


**TYPICAL BEAUGUER AND OFF FRANCE SEA A. I/L.)

**TYPICAL BEAUGUER AND OFF FRANCE SEA A. I/L.)

ADDITIONAL NOTES:
PROPERTY TO BE IRRIGATED
6" PIPE FOR DRIVEWAY SLEEVES TO
BE INSTALLED FOR CITY IRRIGATION
LINES

KEY PLAN NOT TO SCALE

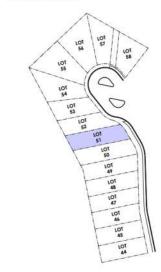

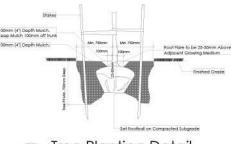

Tree Planting Detail

Not To Scale

All trees and plants by the home owner to be planted in minimum 10m² of tertile topsoil, 700mm Deep



	MM/DD/YY	ISSUED/REVISED
03	10/26/22	GARDEN BED PLANTING
04	01/13/23	SITE PLAN REVISION
05	03/28/23	COMMENTS FROM THE CITY
06	04/13/23	COMMENTS FROM THE CITY
07	05/02/23	COMMENTS FROM THE CITY

DATE PROJECT

> LANDSCAPING PLAN LOT 51, 3475 TRUMPETER ST. ROYAL BAY, SECTOR 7 CITY OF COLWOOD



QUALITY CONSTRUCTION. TRUSTED SERVICE.


106 - 1039 Langford Parkway Victoria, B.C. V9B 0A6 P: 250.474.1039 www.verityconstruction.ca


GABLECTAST HOMES BUILDING GRADE SLIP


WSP	Project	No:	201-08151-00
	,		

C. Hume - Nov. 9/22

BUILDING (SRADE SLIP Issue Date:			
MUNICIPAL ADDRESS 3475 Trumpeter Street	P.I.D.			
LOT 51	PLAN			
BUILDER VERITY HOMES	SUBDIVISION ROYAL BAY SECTOR 7			
ADDRESS	DEVELOPER MEADOWS DEVELOPMENT LP			
REPRESENTATIVE PH.	CONSULTANT WSP CANADA INC			
PROPOSED BUILDING GRADES	PLAN			
ALL ELEVATIONS ARE METRIC GEODETIC +	LOT:51 PLAN:			
MAIN FLOOR ELEVATION	IMPETER			
FRONT ELEV. 68.30 (FINISHED GRADE) REAR ELEV. 69.54/70.25 DEPTH	TRU (66.19)			
FINISHED GRADE AT GARAGE 68.50	88-7			
HEADROOM	(88)			
HEAL	51 EG 67.7 MFE 68.83			
ACTUAL TOP OF FOOTING	GFE 68.63 MSE 64.76 S 64.19			
LOWEST PERMITTED TOP OF not provided FLOOR SLAB FOOTING ELEVATION (LTF)	D 65.61 BFT 88			
(BOTTOM OF BASEMENT SLAB FROST WALLS ARE REQUIRED.)	₩ (68.61) 			
SERVICES FRONT REAR CENTER REFER SIZE	8.01			
TO PLAN (mm) WATER 19				
SANITARY \(\) \(3.50m SROW			
STORM 100	66.83			
COMMENTS YES NO				
DRAIN TO SUMP PUMP LIKELY REQUIRED				
(FOR BASEMENT IF INSTALLED)	LEGEND			
(FOR BASEMENT IF INSTALLED)	STREET			
FOUNDATION SOIL BEARING INVESTIGATION				
CERTIFICATION REQUIRED	SROW SROW SROW PROPOSED FRONT CORNER ELEVATIONS PROPOSED FRONT SIDE YARD GRADES			
GEOTECHNICAL RESTRICTIONS APPLY (SEE GEOTECHNICAL REPORT)	A A A A A A A A A A A A A A A A A A A			
ENVIRONMENTAL RESTRICTIONS APPLY (SEE ENVIRONMENTAL REPORT)	1 121 121			
UTILITY EASEMENTS AFFECT THIS LOT	EG 49.90 - EXISTING GROUND ELEVATION LFE/MFE 47.70 - LOWER/MAIN FLOOR ELEVATION GFE 47.55 - GARAGE FLOOR ELEVATION			
	MSE 52.20 — MINIMUM SANITARY SERVICABLE			
	S 49.12 (P) D 49.12 (P) D 49.12 (P) ELEVATION BY GRAVITY SAN SERVICE INV. (P) DENOTES PUMP IS LIKELY REQUIRED			
	FOR BASEMENT IF INSTALLED STORM SERVICE INV.			
	(P) DENOTES PUMP IS LIKELY REQUIRED FOR BASEMENT IF INSTALLED			
	PROPOSED REAR SIDE YARD GRADES			
NOTES	- LOT TYPE (L/LB/LBT) - PROPOSED PEAR CORNER ELEVATIONS			
1. IT IS THE RESPONSIBILITY OF THE BUILDER TO ENSURE THE FOOTINGS ARE PLACED ON A PROPER BASE THAT IS FREE FROM FROST, EXCESSIVE MOISTURE AND DELETERIOUS MATERIALS AND HAVE APPROPRIATE FROST PROTECTION WHEN COMPLETED.				
2. THE INFORMATION CONTAINED HEREIN IS BASED ON THE APPROVED LOT GRADING PLAN FOR THIS SUBDIVISION. UN—AUTHORIZED				
DEVIATIONS WILL BE THE RESPONSIBILITY OF THE BUILDER TO ENSURE COMPLIANCE WITH ALL LOCAL BYLAWS.	I, THE BUILDER'S REPRESENTATIVE, CERTIFY THAT THE FINAL HOUSE PLANS PROVIDED IN THE BUILDING PERMIT APPLICATION APE THE SAME AS PROCESSED LINDER THIS CRADE SUB AND			
3. OTHER NOTES:	APPLICATION ARE THE SAME AS PROCESSED UNDER THIS GRADE SLIP AND THAT I UNDERSTAND THE INFORMATION AND THE REQUIREMENTS CONTAINED HEREIN AND WILL BUILD ACCORDINGLY.			
	AUTHORIZED BUILDER'S REPRESENTATIVE DATE			
	THE INFORMATION CONTAINED HEREIN IS BASED ON THE APPROVED LOT GRADING PLAN FOR THIS SUBDIVISION, DATED			

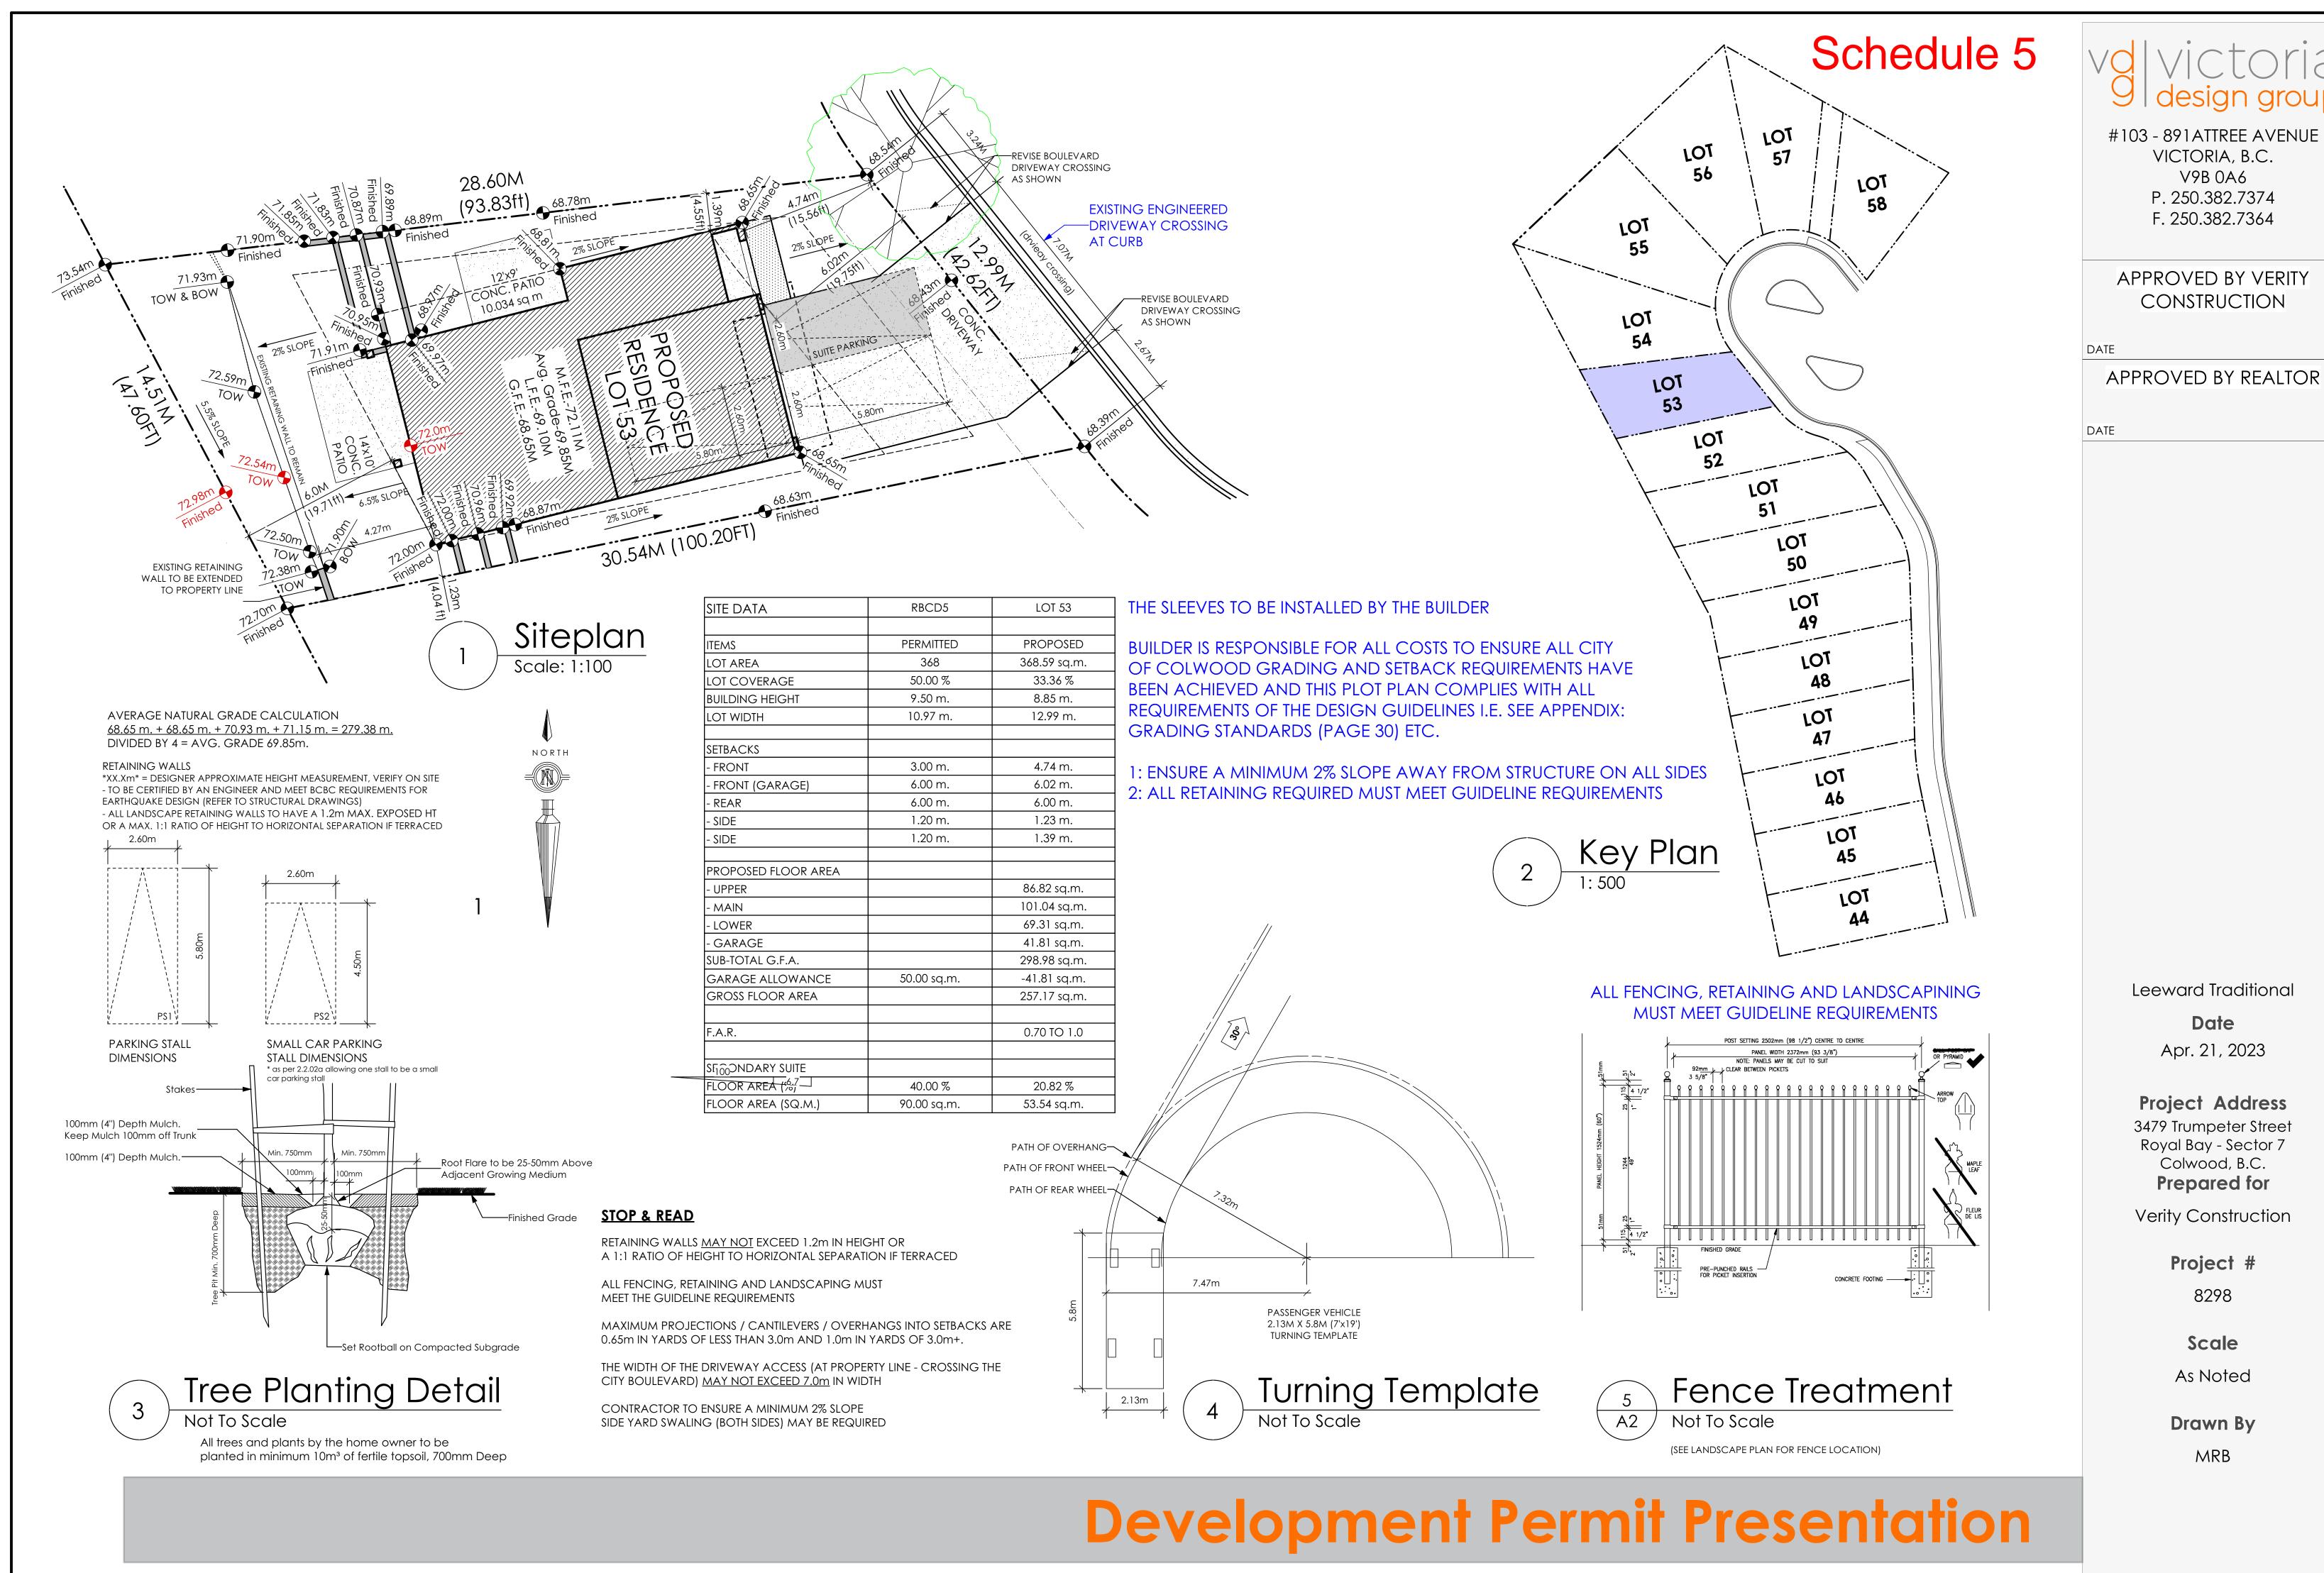

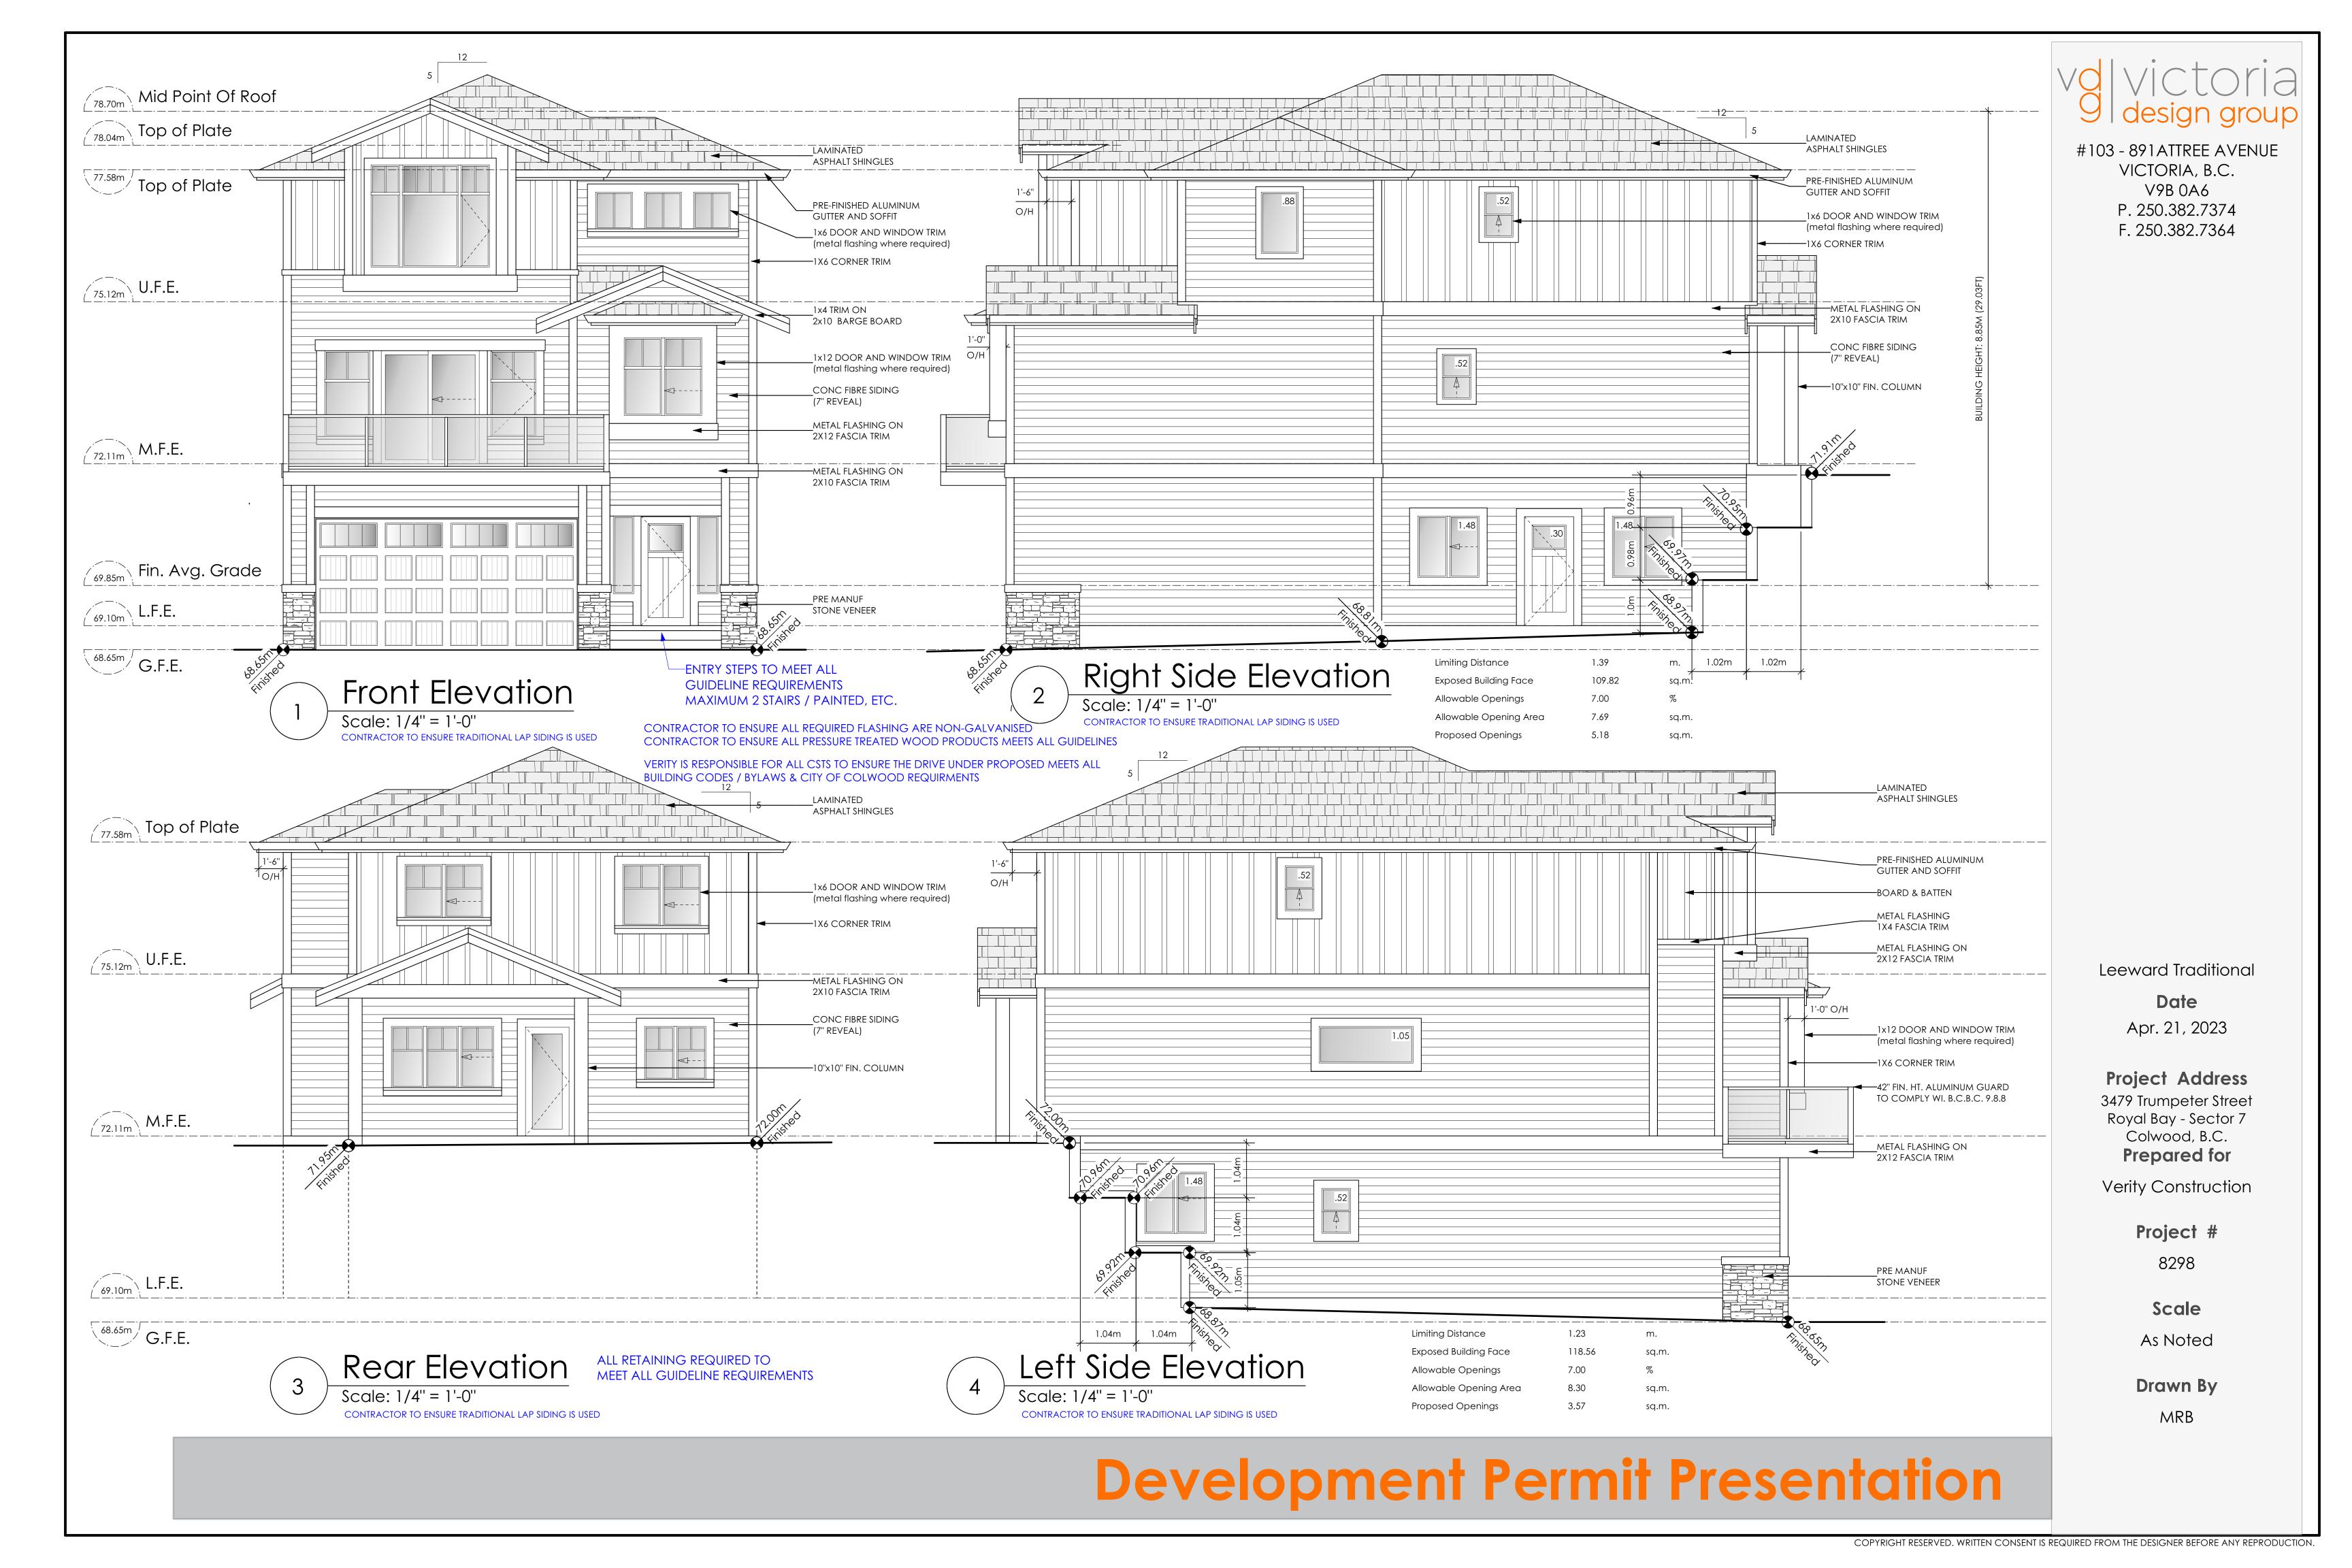

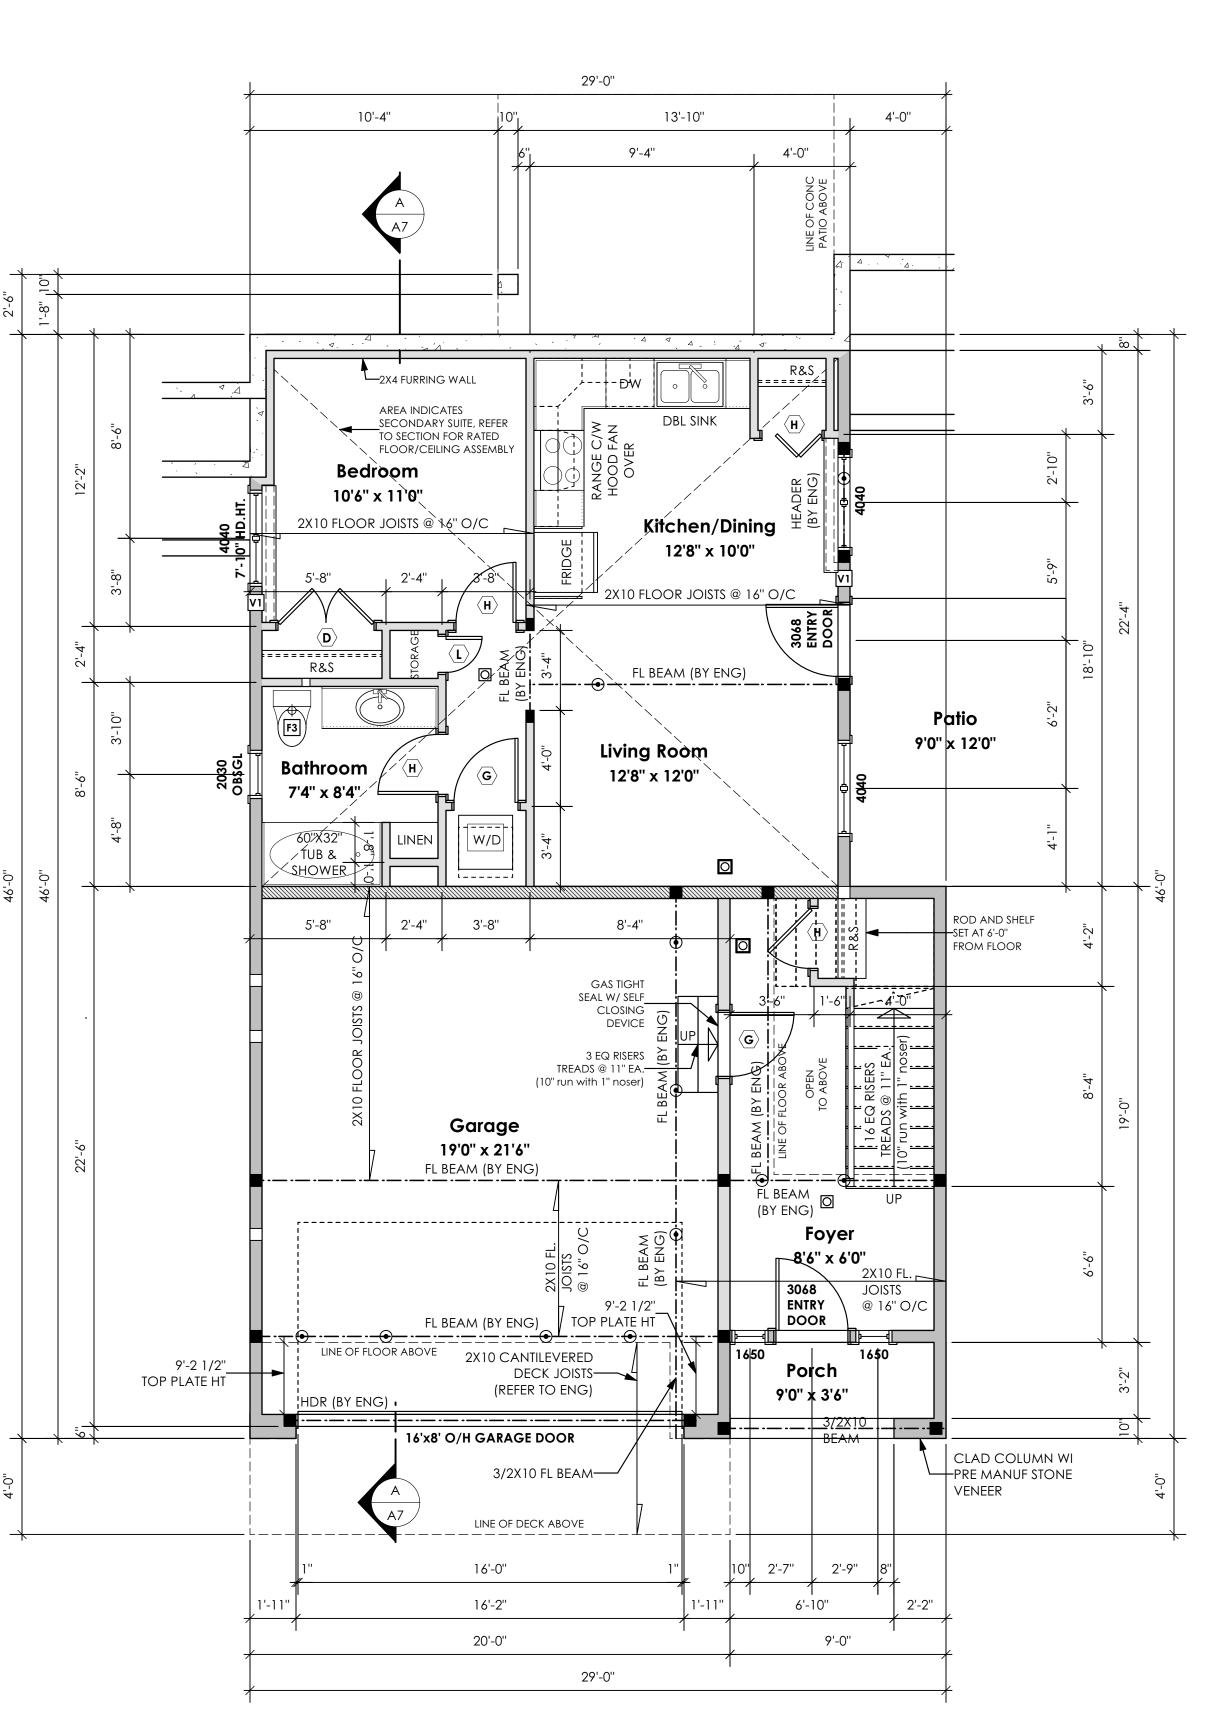



PRIMARY: 169.75 sq.ft. (15.77 sq.m.)

<u>SUITE:</u> 576.25 sq.ft. (53.54 sq.m.)

TOTAL: 746.00 sq.ft. (69.31 sq.m.)

GARAGE: 450.00 sq.ft. (41.81 sq.m.)

volvictoria 9 design group

> #103 - 891ATTREE AVENUE VICTORIA, B.C. V9B 0A6 P. 250.382.7374 F. 250.382.7364

> > Leeward Traditional

Date Apr. 21, 2023

Project Address
3479 Trumpeter Street
Royal Bay - Sector 7
Colwood, B.C.
Prepared for

Verity Construction

Project #

8298 **Scale**


As Noted

Drawn By

MRB

Development Permit Presentation



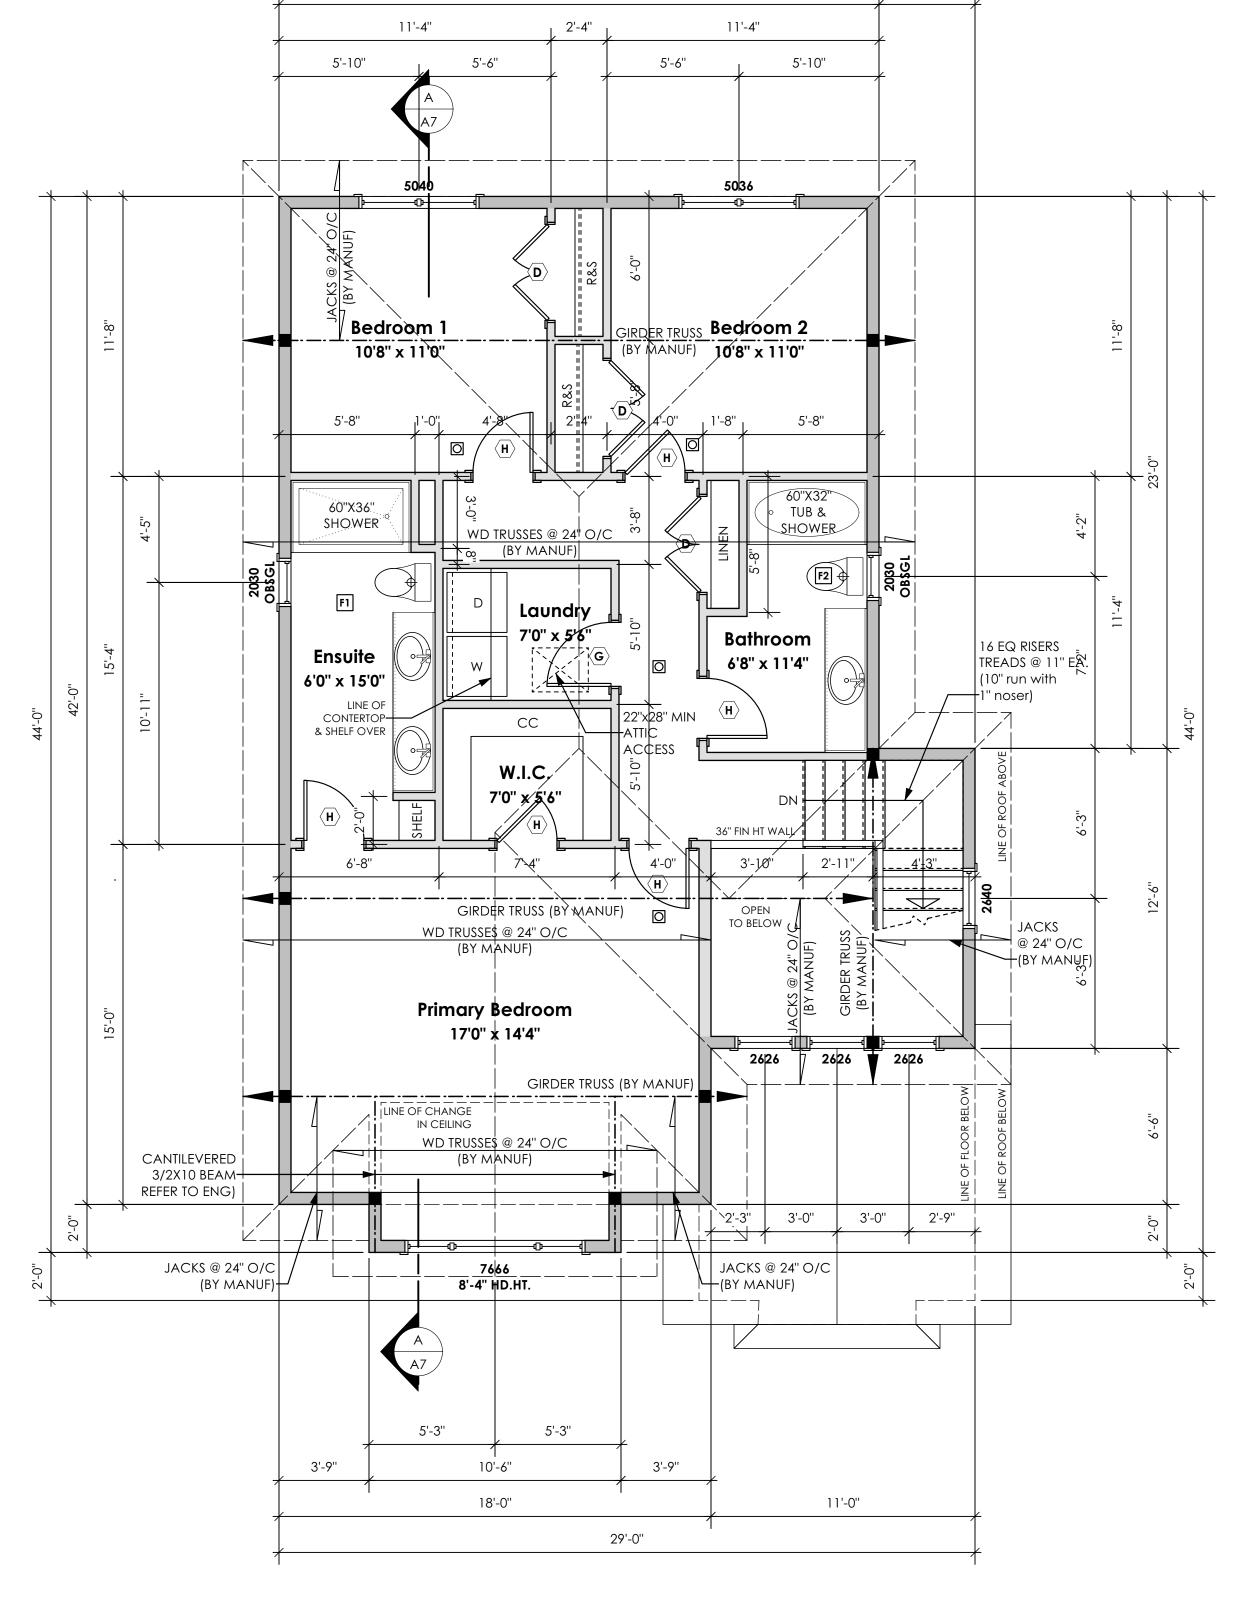

29'-0"

25'-0"

Main Floor Plan

Scale: 1/4" = 1'-0"

29'-0"

3'-5"

PRIMARY: 1087.58 sq.ft. (101.04 sq.m.)

13'-0''

Family Room 14'0" x 13'10"

7'-2''

Powder

WD TRUSSES @ 24" O/C (BY MANUF)

10'6" 🗴 10'0"

5050 7'-10" HD.HT.

3'-3 1/2" 3'-3 1/2"

6'-7''

11'-6"

16 EQ RISERS
TREADS @ 11" EA.

–(10" run with 1" noser)

TREADS @ 11" EA.

4'-2" (10" run with 1" noser)

14'0" x 10'0"

5'-0''

10'0" x 13'10"

Dining Room

13'10" x 10'8"

HDR (BY ENG)

membrane

42" FIN. HT. ALUMINUM GUARD C/W OBSCURED GLAZING PANELS

TO COMPLY WI. B.C.B.C. 9.8.8——

can/cgsb 37.54

FL CANTILEVERED BEAM (BY ENG)

Living Room

17'0" x 16'0"

60611 GLASS SLIDER
DBL BOTTOM PLATE

17'6" x 8'0"

NOTE:
STRUCTURAL ENGINEER TO REVIEW PLAN (WHERE REQUIRED)
AND SPECIFY STRUCTURE AS DEEMED NECESSARY. IT IS
THE RESPONSIBILITY OF THE OWNER. OR CONTRACTOR TO
VERIFY ALL ENGINEERING REQUIREMENTS WITH MUNICIPAL
BUILDING DEPARTMENTS PRIOR TO STARTING WORK.

STRUCTURAL WOOD ELEMENTS WITHIN 150MM (6") FROM FINISHED GROUND LEVEL SHALL BE PRESSURE TREATED WITH A PRESERVATIVE FOR TERMITE AND DECAY PROTECTION B.C.B.C. 2012 9.3.2.9.(3)



Leeward Traditional

Date

Apr. 21, 2023

Project Address3479 Trumpeter Street

Royal Bay - Sector 7 Colwood, B.C. **Prepared for**

Verity Construction

Project #

8298

Scale


4 a N l a ±

As Noted

Drawn By

MRB

Development Permit Presentation

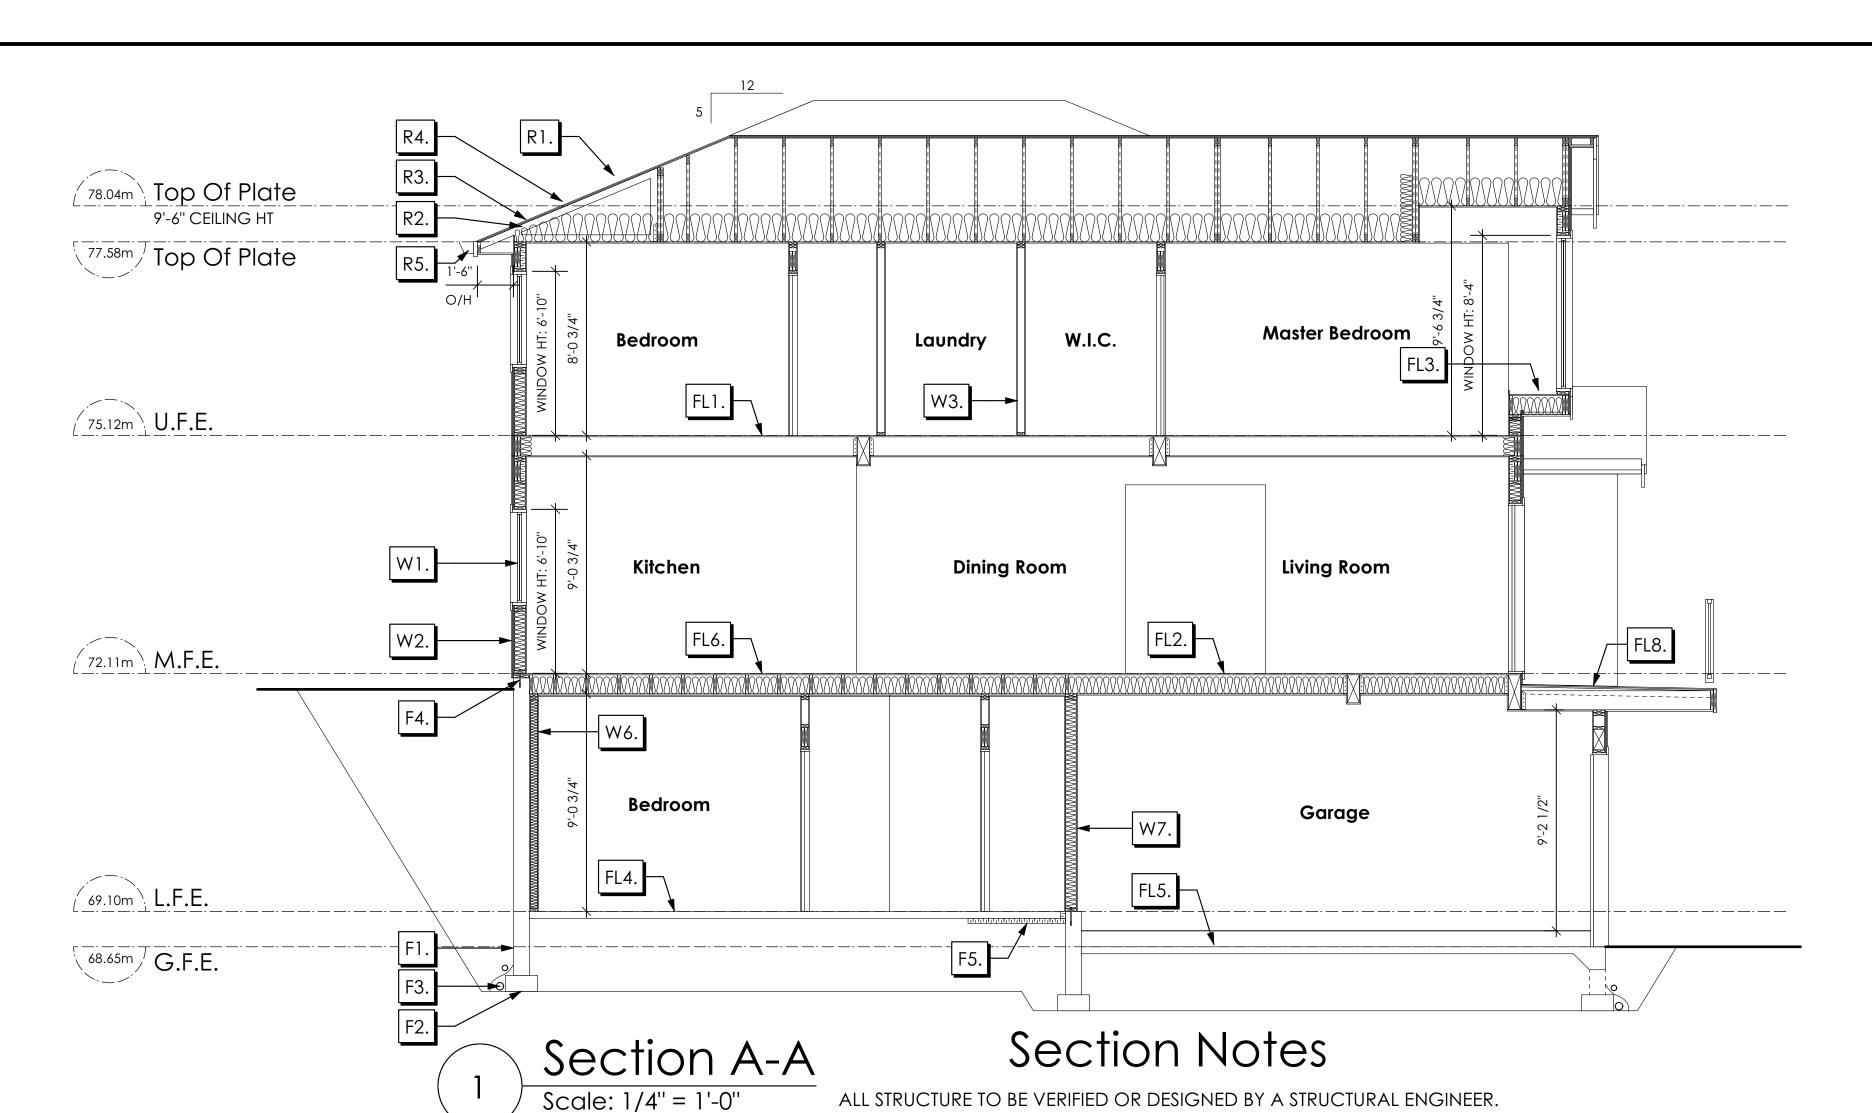

ALL STRUCTURE TO BE VERIFIED OR DESIGNED BY A STRUCTURAL ENGINEER.

STRUCTURAL ENGINEER TO LOCATE AND DESIGN REQUIRED EXTERIOR

AND INTERIOR BRACED WALL PANELS TO RESIST LATERAL LOADS IN COMPLIANCE

WITH B.C. BUILDING CODE 2012 9.23.13.2 AND SUPPLY DETAILS IF REQUIRED

STRUCTURAL ENGINEER TO LOCATE AND DESIGN WALLS TO RESIST LATERAL LOADS.

WALLS

2/2"X10" LINTEL OVER (@ BEARING WALLS ONLY)

(GLAZING IN ALL EXTERIOR DOORS & WITHIN 3 FT.

OF EXTERIOR DOORS TO BE SHATTERPROOF (SP))

WINDOW REQUIREMENTS DERIVED FROM BCBC

TABLE C-4 AS PER BCBC 9.7.4.3. AND ARE TO BE

LANGFORD, CLASS R, DP 960, PG 20, WATER RESIST. 220, A2,

USED TO SATISFY THE REQUIREMENTS OF

AAMA/WDMA/CSA 101/I.S.2/A440, "NAFS":

RATINGS MUST BE CLEARLY LABELED ON ALL

ENERGY STAR LOW "E" RATING IN

(TYPICAL, WI. 2 1/2" XPS INSULATION)

THERMAL BREAK FRAMES

FLASHING OVER @ EXTERIOR

W1. DOUBLE GLAZING

ROOFS

R1. LAMINATED ASPHALT SHINGLES ON
7/16" ORIENTED STRAND BOARD C/W "H" CLIPS
WD TRUSSES (DESIGNED BY MANUF.)
14 1/2" FIBRE GLASS LOOSE FILL INSULATION
(ALLOW FOR SETTLING)
6 MIL POLY'N V.B.
5/8" GYPSUM BOARD

R2. PROVIDE 2 1/2" (63MM) CLEAR BETWEEN R-20 INSULATION AND SHEATHING.
(MIN. R-20 @ ROOF-WALL CONNECTION FOR 4'-0" (1.2M) AROUND PERIMETER OF BUILDING. AIR VENTILATION BAFFLES TO BE INSTALLED WHERE REQUIRED IN AS PER BCBC 9.19.)

R3. EAVE PROTECTION

CONT. UP ROOF SLOPE FOR 12"

PAST EXTERIOR WALL.

R4. PROVIDE 1 SQ.FT. ATTIC VENT PER
300 SQ.FT. OF INSULATED AREA MIN.
25% OF REQUIRED TO BE @ TOP AND BOTTOM
(TO COMPLY WI. B.C. BLDG. CODE 9.19.1)

R5. PRE-FIN. FASCIA GUTTER
2×8 FASCIA BD.
2×4 SUB. FASCIA BD.
VENTED SOFFIT
(SEE CONTRACTOR)

FLOORS

FL1. FINISHED FLOORING ON
11/16" ORIENTED STRAND BOARD
(NAILED & GLUED TO FLOOR STRUCT. BELOW) ON
2×10 FLOOR JOISTS @ 16" OR 12" O/C
C/W 2×2 X-BRIDGING @ 7.0' O/C (MAX)
1/2" GYPSUM BOARD

FL2. FINISHED FLOORING ON
11/16" ORIENTED STRAND BOARD
(NAILED & GLUED TO FLOOR STRUCT. BELOW) ON
2×10 FLOOR JOISTS @ 16" OR 12" O/C
C/W 2×2 X-BRIDGING @ 7.0' O/C (MAX)
R-31 INSULATION
5/8" X-TYPE GYPSUM BOARD
(BETWEEN GARAGE AND LIVING SPACE)

FL3. FINISHED FLOORING ON
19/32" ORIENTED STRAND BOARD
(FASTENED & GLUED TO FLOOR STRUCT. BELOW) ON
2×10 FLOOR JOISTS @ 16" OR 12" O/C
C/W 2×2 X-BRIDGING @ 7.0' O/C (MAX)
PROVIDE R-31 F/G BATT INSULATION IN
JOIST CAVITY C/W
BUILDING WRAP
VENTED SOFFIT (TO OWNERS SPEC'S)
TO ALL SUSPENDED FLOOR AREAS

FL4. 3 1/2" CONCRETE SLAB 6 MIL. POLY'N V.B. 6" COMPACTED GRAVEL OR SAND

FL5. 3 1/2" CONCRETE SLAB
6 MIL. POLY'N V.B.
6" COMPACTED GRAVEL OR SAND
SLOPE TO DOORS 1"

FL6. F8d RATED FLOOR ASSEMBLY
(BC BUILDING CODE TABLE 9.10.3.1.B)
FINISHED FLOORING ON
19/32" ORIENTED STRAND BOARD OR EQ.
(FASTENED & GLUED TO FLOOR STRUCT. BELOW) ON
2×10 FLOOR JOISTS @ 16" OR 12" O/C
C/W 2×2 X-BRIDGING @ 7.0' O/C (MAX)
R-31 INSULATION
RESILIENT METAL CHANNELS @ 24" O/C
1 LAYERS 5/8" X-TYPE GYPSUM BOARD
30 MINUTE F.R.R., 50 S.T.C.

FL7. DECKING MEMBRANE (TO COMPLY WITH CAN/CGSB 37.54) ON 19/32" ORIENTED STRAND BOARD 2×10 DECK JOISTS @ 16" O/C C/W (PROVIDE ADEQUATE MEMBRANE "UPSTAND" @ EXT. WALL.)

(SLOPE JOISTS TO PROVIDE MIN.1:50 SLOPE)
(NOT IN SECTION)

DECKING MEMBRANE
(TO COMPLY WITH CAN/CGSB 37.54) ON
19/32" ORIENTED STRAND BOARD C/W "H" CLIPS
TAPERS TO PROVIDE MIN.1:50 SLOPE ON

19/32" ORIENTED STRAND BOARD C/W "H" CLIPS
TAPERS TO PROVIDE MIN.1:50 SLOPE ON
2×10 DECK JOISTS @ 16" O/C C/W
(PROVIDE ADEQUATE MEMBRANE
"UPSTAND" @ EXT. WALL.)

W2

WINDOW UNITS UPON INSTALLATION FOR INSPECTION.

W2. CONC. FIBRE BOARD ON
9.5MM (3/8") AIR SPACE / STRAPPING
3/8"×2" BORATE TREATED PLYWOOD STRAPPING
HOUSE WRAP (A.B.) (TYVEK OR EQ.)
7/16" ORIENTED STRAND BOARD SHEATHING
2×6 STUDS @ 16" O/C
R-20 INSULATION
6 MIL. POLYETHYLENE VAPOUR BARRIER
1/2" GYPSUM BOARD

W3. INTERIOR PARTITION
1/2" GYPSUM BOARD ON EACH SIDE
OF 2×4 STUDS @ 16" O/C OR
2×6 STUDS @ 16" O/C (IF NOTED)

(REFER TO DETAILS ON D1)

W4. PRE-MANUFACTURED STONE VENEER
(INSTALLED TO MANUF. SPEC)
LIME BASED MORTAR SETTING BED ON
LIME BASED MORTAR SCRATCH COAST ON
METAL LATHE INSTALLED HORIZONTALLY
OVERLAP HORIZONTAL AND VERTICAL SEAMS 1"
SEMI-RIGID BACK BOARD
(HAL-TEX RAINBOARD OR EQ.)
9.5MM (3/8") AIR SPACE / STRAPPING
3/8"×2" BORATE TREATED PLYWOOD STRAPPING
HOUSE WRAP (A.B.) (TYVEK OR EQ.)
7/16" ORIENTED STRAND BOARD SHEATHING
2×6 STUDS @ 16" (AS REQUIRED)
(NOT SHOWN IN SECTION)

W5. 5/8" X-TYPE GYPSUM BOARD ON 2×6 STUDS @ 16" O/C C/W R-20 INSULATION 6 MIL. POLY'N V.B

1/2" GYPSUM BOARD
(BETWEEN GARAGE & LIVING)
(NOT SHOWN IN SECTION)

W6. 1/2" GYPSUM BOARD ON
6 MIL. POLY'N V.B.
2×4 STUDS @ 24" O/C C/W

6 MIL. POLY'N V.B.
2×4 STUDS @ 24" O/C C/W
R-12 BATT INSULATION
2 PLY 30 MINUTE BUILDING PAPER OR
12.7MM (1/2") AIR SPACE
(PROVIDE REQUIRED FIRE STOPS IN WALL
ASSEMBLIES TO COMPLY WITH
B.C. BLDG. CODE 9.10.16.)

W7. B.C. BUILDING CODE (TABLE 9.10.3.1.A)
RATED WALL ASSEMBLY W3c
1 LAYER 1/2" X-TYPE GYPSUM BOARD
RESILIENT METAL CHANNELS @ 24" O/C
2×4 STUDS @ 16" O/C OR
2×6 STUDS @ 16" O/C (IF NOTED) C/W
3 1/2" FIBRE GLASS SOUND BATTS
1 LAYER 1/2" X-TYPE GYPSUM BOARD
45 MIN. F.R.R 43 S.T.C
(BETWEEN PRIMARY LIVING / GARAGE
& SECONDARY SUITE)

FOUNDATION WALLS

F1. DAMP PROOFING (WHERE REQUIRED) ON 8" THK. CONC. FOUNDATION WALL C/W 15 M BARS @ 24" O/C B/W

72. 16"X 8" CONC. FOOTINGS C/W 2 (TWO) 15M BARS CONT. 3 IN. FROM BOTT. ON UNDISTURBED SOIL (SOLID BEARING)

F3. 4" PERIMETER DRAIN
3" TIGHT PIPE FOR RWL
DRAIN ROCK

4. ANCHOR BOLTS @ 4.0 FT. O/C MAX C/W SILL GASKETS

F5. UNDER SLAB INSULATION
2 1/2" (RSI 2.15) EXTRUDED POLYSTYRENE
RIGID INSULATION 4'-0" (1.2M)
CONT. AROUND PERIMETER UNDER
SLAB INSTALLED HORIZONTALLY
(VERIFY WITH MUNICIPALITY DEPTH OF FROST LINE)
(NOT IN SECTION)

volvictoria 9 design group

#103 - 891 ATTREE AVENUE VICTORIA, B.C. V9B 0A6 P. 250.382.7374 F. 250.382.7364

Leeward Traditional

Date

Apr. 21, 2023

Project Address
3479 Trumpeter Street
Royal Bay - Sector 7
Colwood, B.C.
Prepared for

Verity Construction

Project #

8298

Scale


As Noted

Drawn By

MRB



#103 - 891 ATTREE AVENUE VICTORIA, B.C. V9B 0A6 P. 250.382.7374 F. 250.382.7364

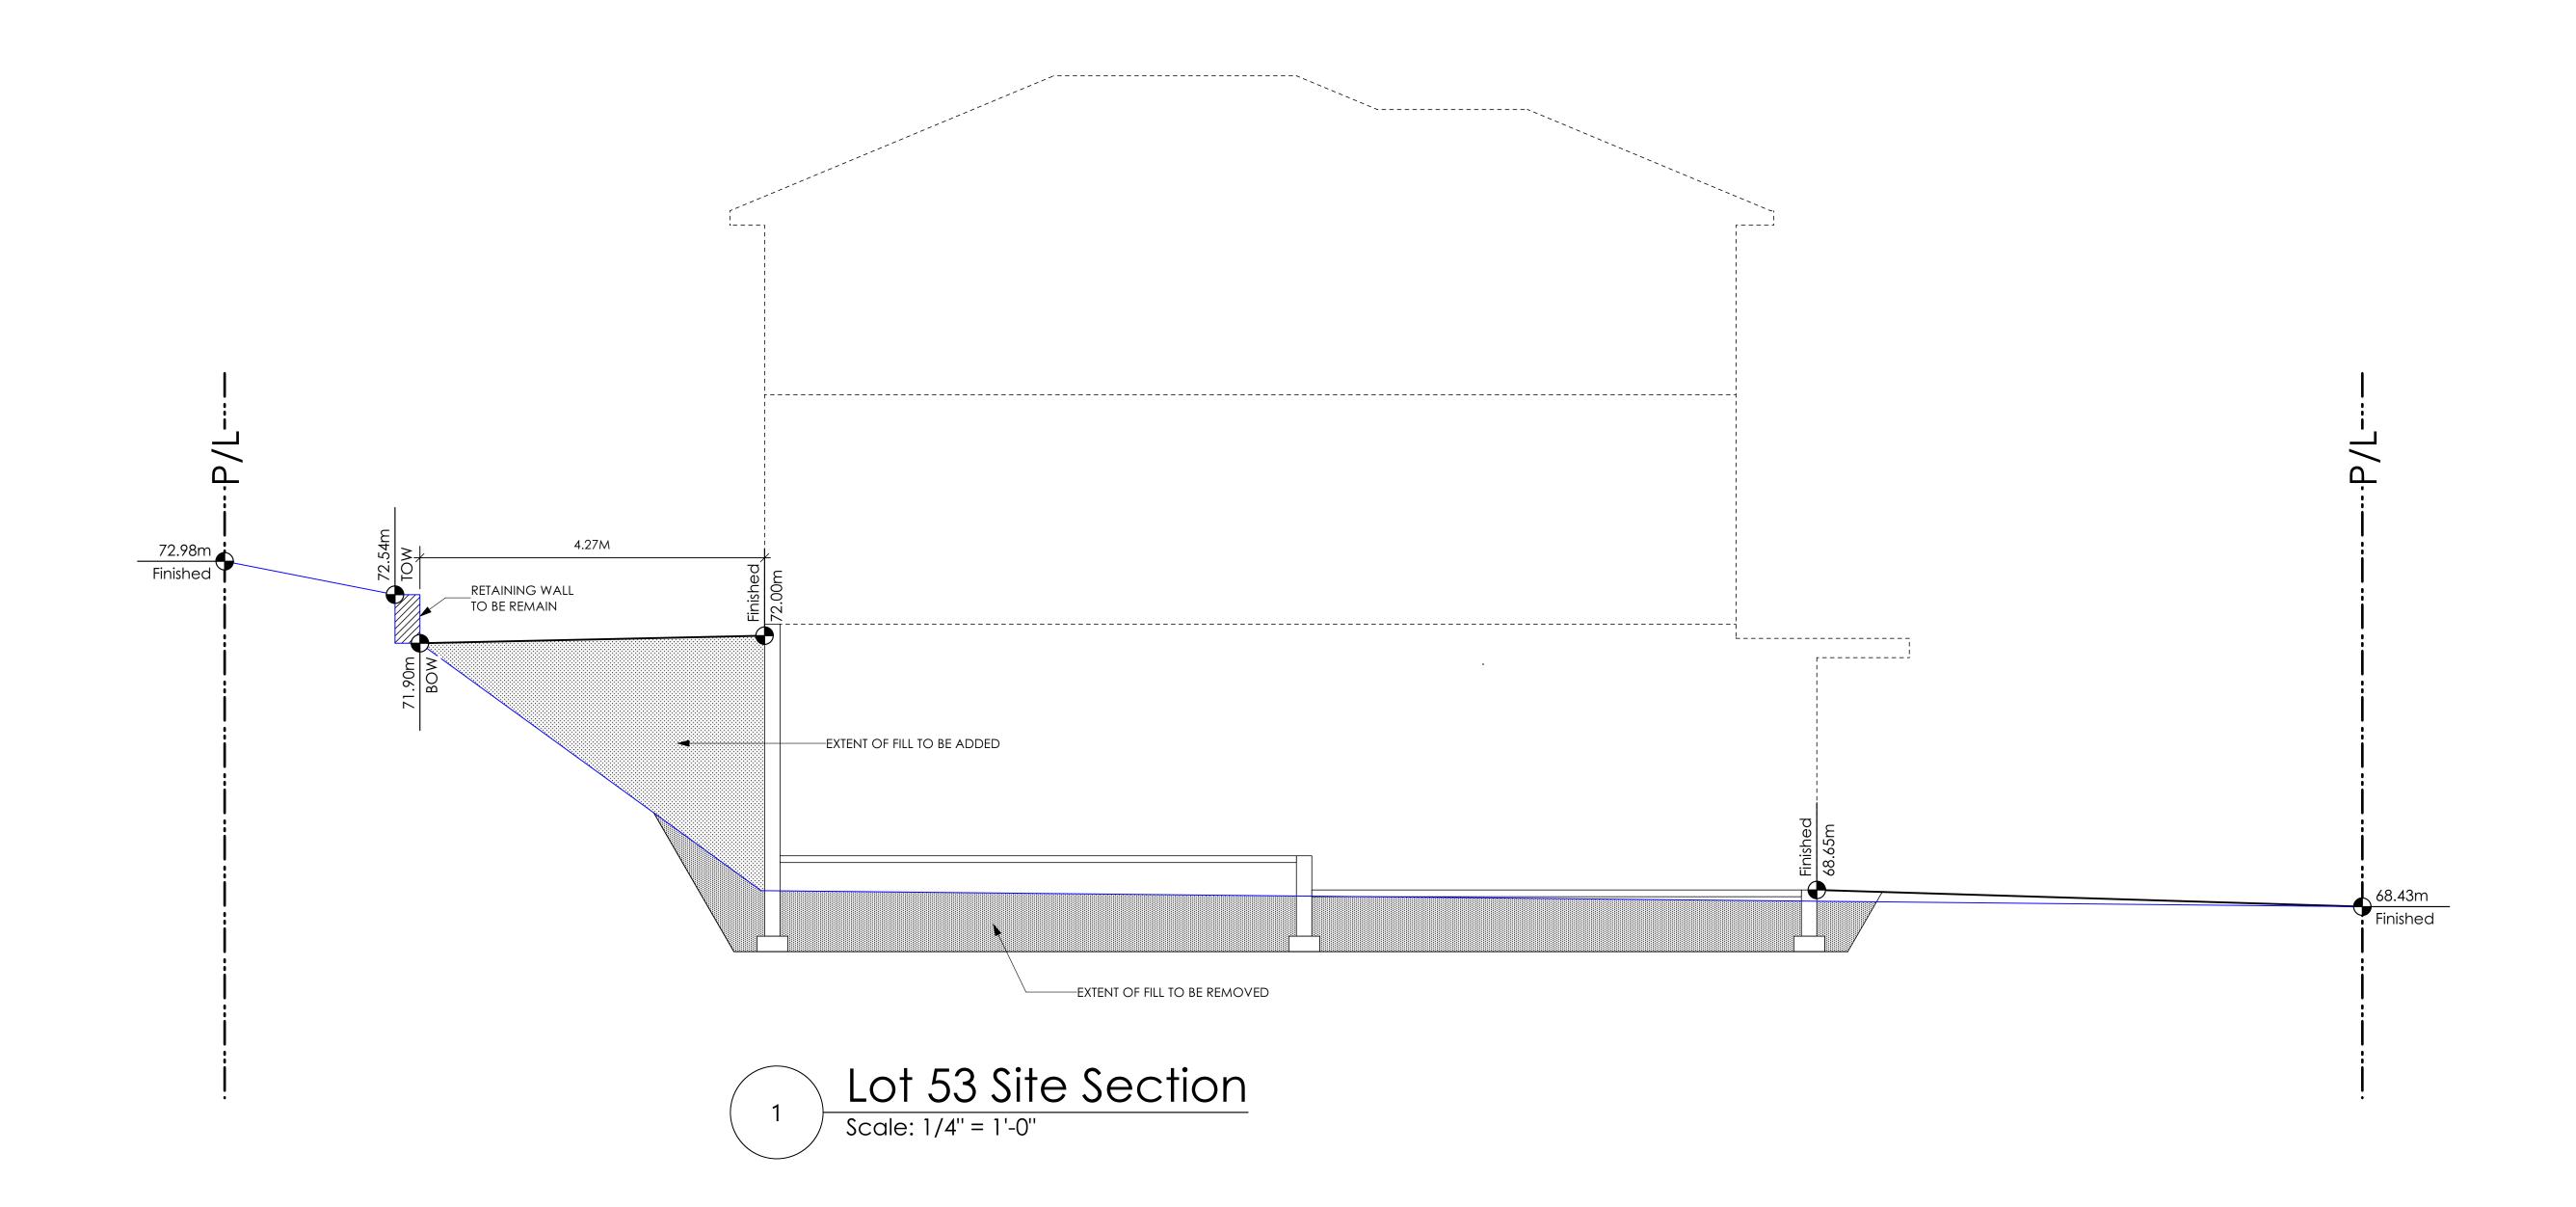

Leeward Traditional

Date

Apr. 21, 2023

Project Address

3479 Trumpeter Street Royal Bay - Sector 7 Colwood, B.C. **Prepared for**

Verity Construction

Project #

8298

Scale


As Noted

Drawn By

MRB

ALL FENCING, RETAINING AND LANDSCAPING MUST MEET THE GUIDELINE REQUIREMENTS

ALL RETAINING WALLS ARE TO BE STAND ALONE STRUCTURES (THEY MUST TERMINATE AT PROPERTY LINE) AND MUST NOT CONNECT TO RETAINING WALLS LOCATED ON ADJACENT PRIVATE PROPERTIES *NOTE: In the interest of maintaining high standards, the developer reserves the right to modify plans, specifications and design without prior notice. Drawings contained within are artist renderings only. Sizes and dimensions are approximate and may vary with actual plan and survey. Exterior style may change pending municipal approval. Retaining wall location and types may vary and are subject to municipal, engineering or developer discretion. Subject to change without notice. Furniture as shown on plans are for layout purposes only and are not included in the sale.

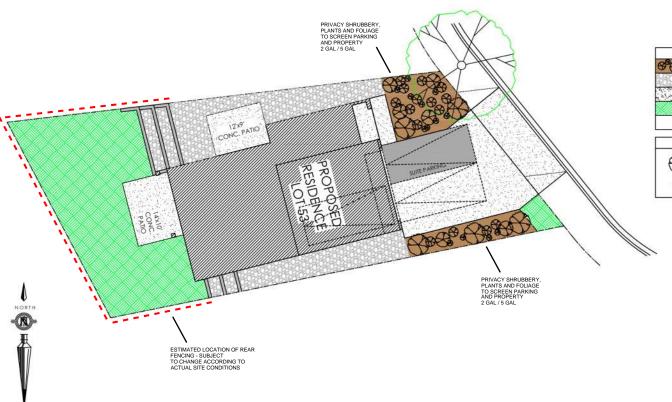

	ITEM	AREA (sf)	%
68	GARDEN BED	324	12%
	GRAVEL	556	20%
	CONCRETE	874	32%
	SOD	968	36%
	TOTAL	2,722	100%

LEGEND


PRIVACY
SHRUBBERY

PRIVACY
SHRUBBERY

PRIVACY
SHRUBBERY

-2 GAL

-5 GAL

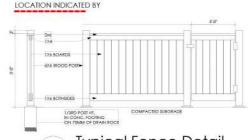


Typical Fence Detail
Not To Scale


"TYPICA: IRRICA BEAR AND CHE PROCESSION A TAIL
FROM BOAR DEAR AND CHEST PROCESSION A TAIL
FROM BOARD CHEST PROCESSION A TAIL
FROM BOAR DEAR AND CHEST PROCESSION A

ADDITIONAL NOTES: PROPERTY TO BE IRRIGATED

6" PIPE FOR DRIVEWAY SLEEVES TO BE INSTALLED FOR CITY IRRIGATION LINES

KEY PLAN NOT TO SCALE

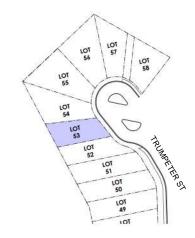

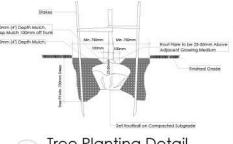

Tree Planting Detail

Not To Scale

All frees and plants by the home owner to be planted in minimum 10m² of fertile topsail, 700mm Deep



	MM/DD/YY	ISSUED/REVISED
01	06/27/22	FOR APPROVAL
02	08/04/22	FOR APPROVAL
03	01/17/23	SITE PLAN REVISION
	i	

DATE PROJECT

> LANDSCAPING PLAN LOT 53, 3479 TRUMPETER ST. ROYAL BAY, SECTOR 7 CITY OF COLWOOD




QUALITY CONSTRUCTION. TRUSTED SERVICE.


106 - 1039 Langford Parkway Victoria, B.C. V9B 0A6 P: 250.474.1039 www.verityconstruction.ca


GABLECTART HOMES BUILDING GRADE SLIP

WSP	Project	No:	201-08151-00
	,		

BUILDING	JRADE SLIP Issue Date:
MUNICIPAL ADDRESS 3479 Trumpeter Street	P.I.D.
LOT 53	PLAN
BUILDER VERITY HOMES	SUBDIVISION PAY SECTOR 7
ADDRESS	ROYAL BAY SECTOR 7 DEVELOPER MEADOWS DEVELOPMENT LP
REPRESENTATIVE PH.	CONSULTANT WSP CANADA INC
PROPOSED BUILDING GRADES	PLAN
ALL ELEVATIONS ARE METRIC GEODETIC +	LOT: PLAN:
MAIN FLOOR ELEVATION	5 .
FRONT ELEV. 68.65 (FINISHED GRADE) (FINISHED GRADE) DEPTH (FINISHED GRADE)	TRUMPETER ST.
FINISHED GRADE AT GARAGE 68.65	TRUM G
HEADROOM	
WE HEAD!	(6)
ACTUAL TOP OF FOOTING	53 EG 68.4
ELEVATION (ATF) LOWEST PERMITTED TOP OF not provided FLOOR SLAB FOOTING ELEVATION (LTF)	
(BOTTOM OF BASEMENT SLAB FROST WALLS ARE REQUIRED.)	LFE 69.05 GFE 68.85 MSE 65.52 S 65.06
SERVICES FRONT REAR CENTER REFER SIZE	D 66.23 D 989
TO PLAN (mm) WATER 19	· ************************************
SANITARY	
STORM	E DZZ
000000000000000000000000000000000000000	RETAINING
COMMENTS YES NO DRAIN TO SUMP PUMP LIKELY REQUIRED	WALL
(FOR BASEMENT IF INSTALLED)	LEGEND
SEWER TO SUMP PUMP LIKELY REQUIRED (FOR BASEMENT IF INSTALLED)	STREET
SERVICES INSTALLED TO m INSIDE PROPERTY	NY F NY F
FOUNDATION SOIL BEARING INVESTIGATION CERTIFICATION REQUIRED	SROW (SHOWN ON ABOVE PLAN)
GEOTECHNICAL RESTRICTIONS APPLY (SEE GEOTECHNICAL REPORT)	PROPOSED FRONT CORNER ELEVATIONS PROPOSED FRONT SIDE YARD GRADES 2000 2000 100 100 100 100 100
ENVIRONMENTAL RESTRICTIONS APPLY (SEE ENVIRONMENTAL REPORT)	L# 6 C# 256 L# 6 C# 256 L# 6 C# 256 L# 6 C# 256
	EG 49.90 - EXISTING GROUND ELEVATION - LOWER/MAIN FLOOR ELEVATION
UTILITY EASEMENTS AFFECT THIS LOT	GFE 47.55 — GARAGE FLOOR ELEVATION MFGE 47.70 — MAXIMUM FINAL GROUND ELEVATION
	MSE 52.20 - MINIMUM SANITARY SERVICABLE ELEVATION BY GRAVITY - SAN SERVICE INV.
	D 49.12 (P) (P) DENOTES PUMP IS LIKELY REQUIRED FOR BASEMENT IF INSTALLED
	40.00 STORM SERVICE INV. (P) DENOTES PUMP IS LIKELY REQUIRED FOR BASEMENT IF INSTALLED
	- PROPOSED REAR SIDE YARD GRADES - MAXIMUM BASEMENT SLAB DEPTH ELEVATION
NOTES	- LOT TYPE (L/LB/LBT)
IT IS THE RESPONSIBILITY OF THE BUILDER TO ENSURE THE FOOTINGS ARE PLACED ON A PROPER BASE THAT IS FREE FROM FROST,	LANE/LOT - PROPOSED REAR CORNER ELEVATIONS
EXCESSIVE MOISTURE AND DELETERIOUS MATERIALS AND HAVE APPROPRIATE FROST PROTECTION WHEN COMPLETED.	
THE INFORMATION CONTAINED HEREIN IS BASED ON THE APPROVED LOT GRADING PLAN FOR THIS SUBDIVISION. UN—AUTHORIZED	
DEVIATIONS WILL BE THE RESPONSIBILITY OF THE BUILDER TO ENSURE COMPLIANCE WITH ALL LOCAL BYLAWS.	I, THE BUILDER'S REPRESENTATIVE, CERTIFY THAT THE FINAL HOUSE PLANS PROVIDED IN THE BUILDING PERMIT
3. OTHER NOTES:	APPLICATION ARE THE SAME AS PROCESSED UNDER THIS GRADE SLIP AND THAT I UNDERSTAND THE INFORMATION AND THE REQUIREMENTS CONTAINED HEREIN AND WILL BUILD ACCORDINGLY.
	AUTHORIZED BUILDER'S REPRESENTATIVE DATE THE INFORMATION CONTAINED HEREIN IS BASED ON THE APPROVED
	LOT GRADING PLAN FOR THIS SUBDIVISION, DATED
	C. Hume - August 16/22

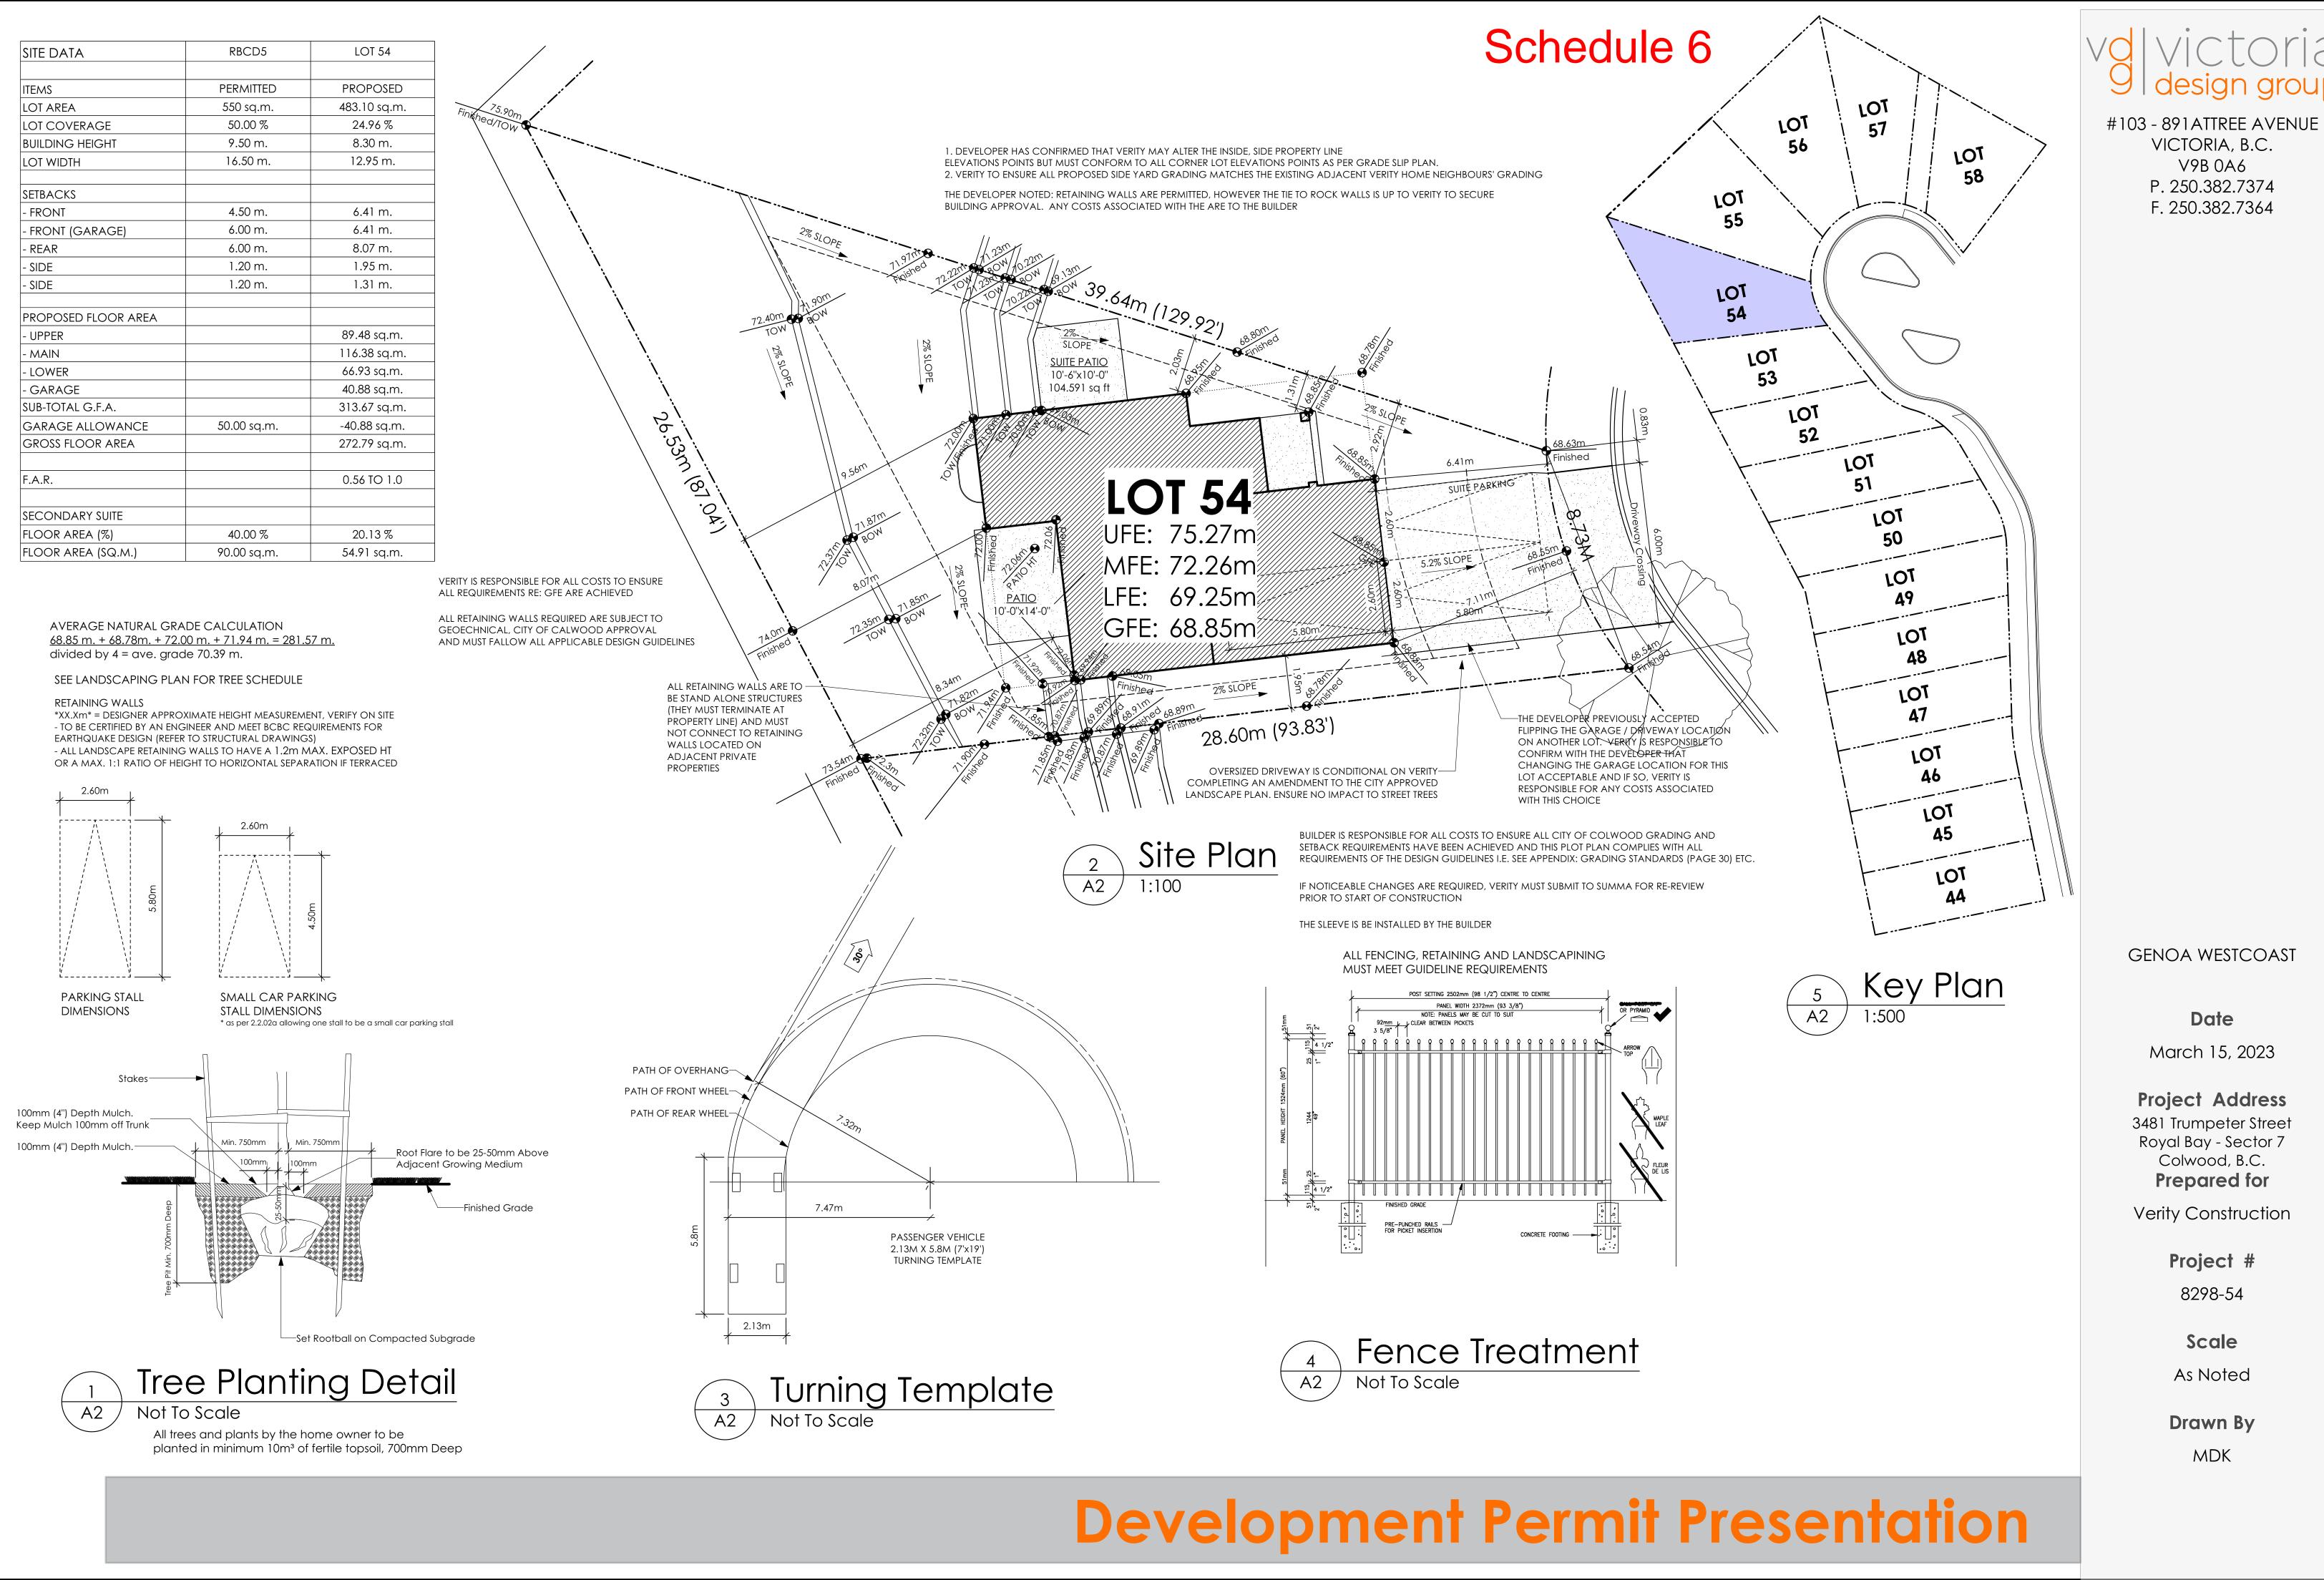

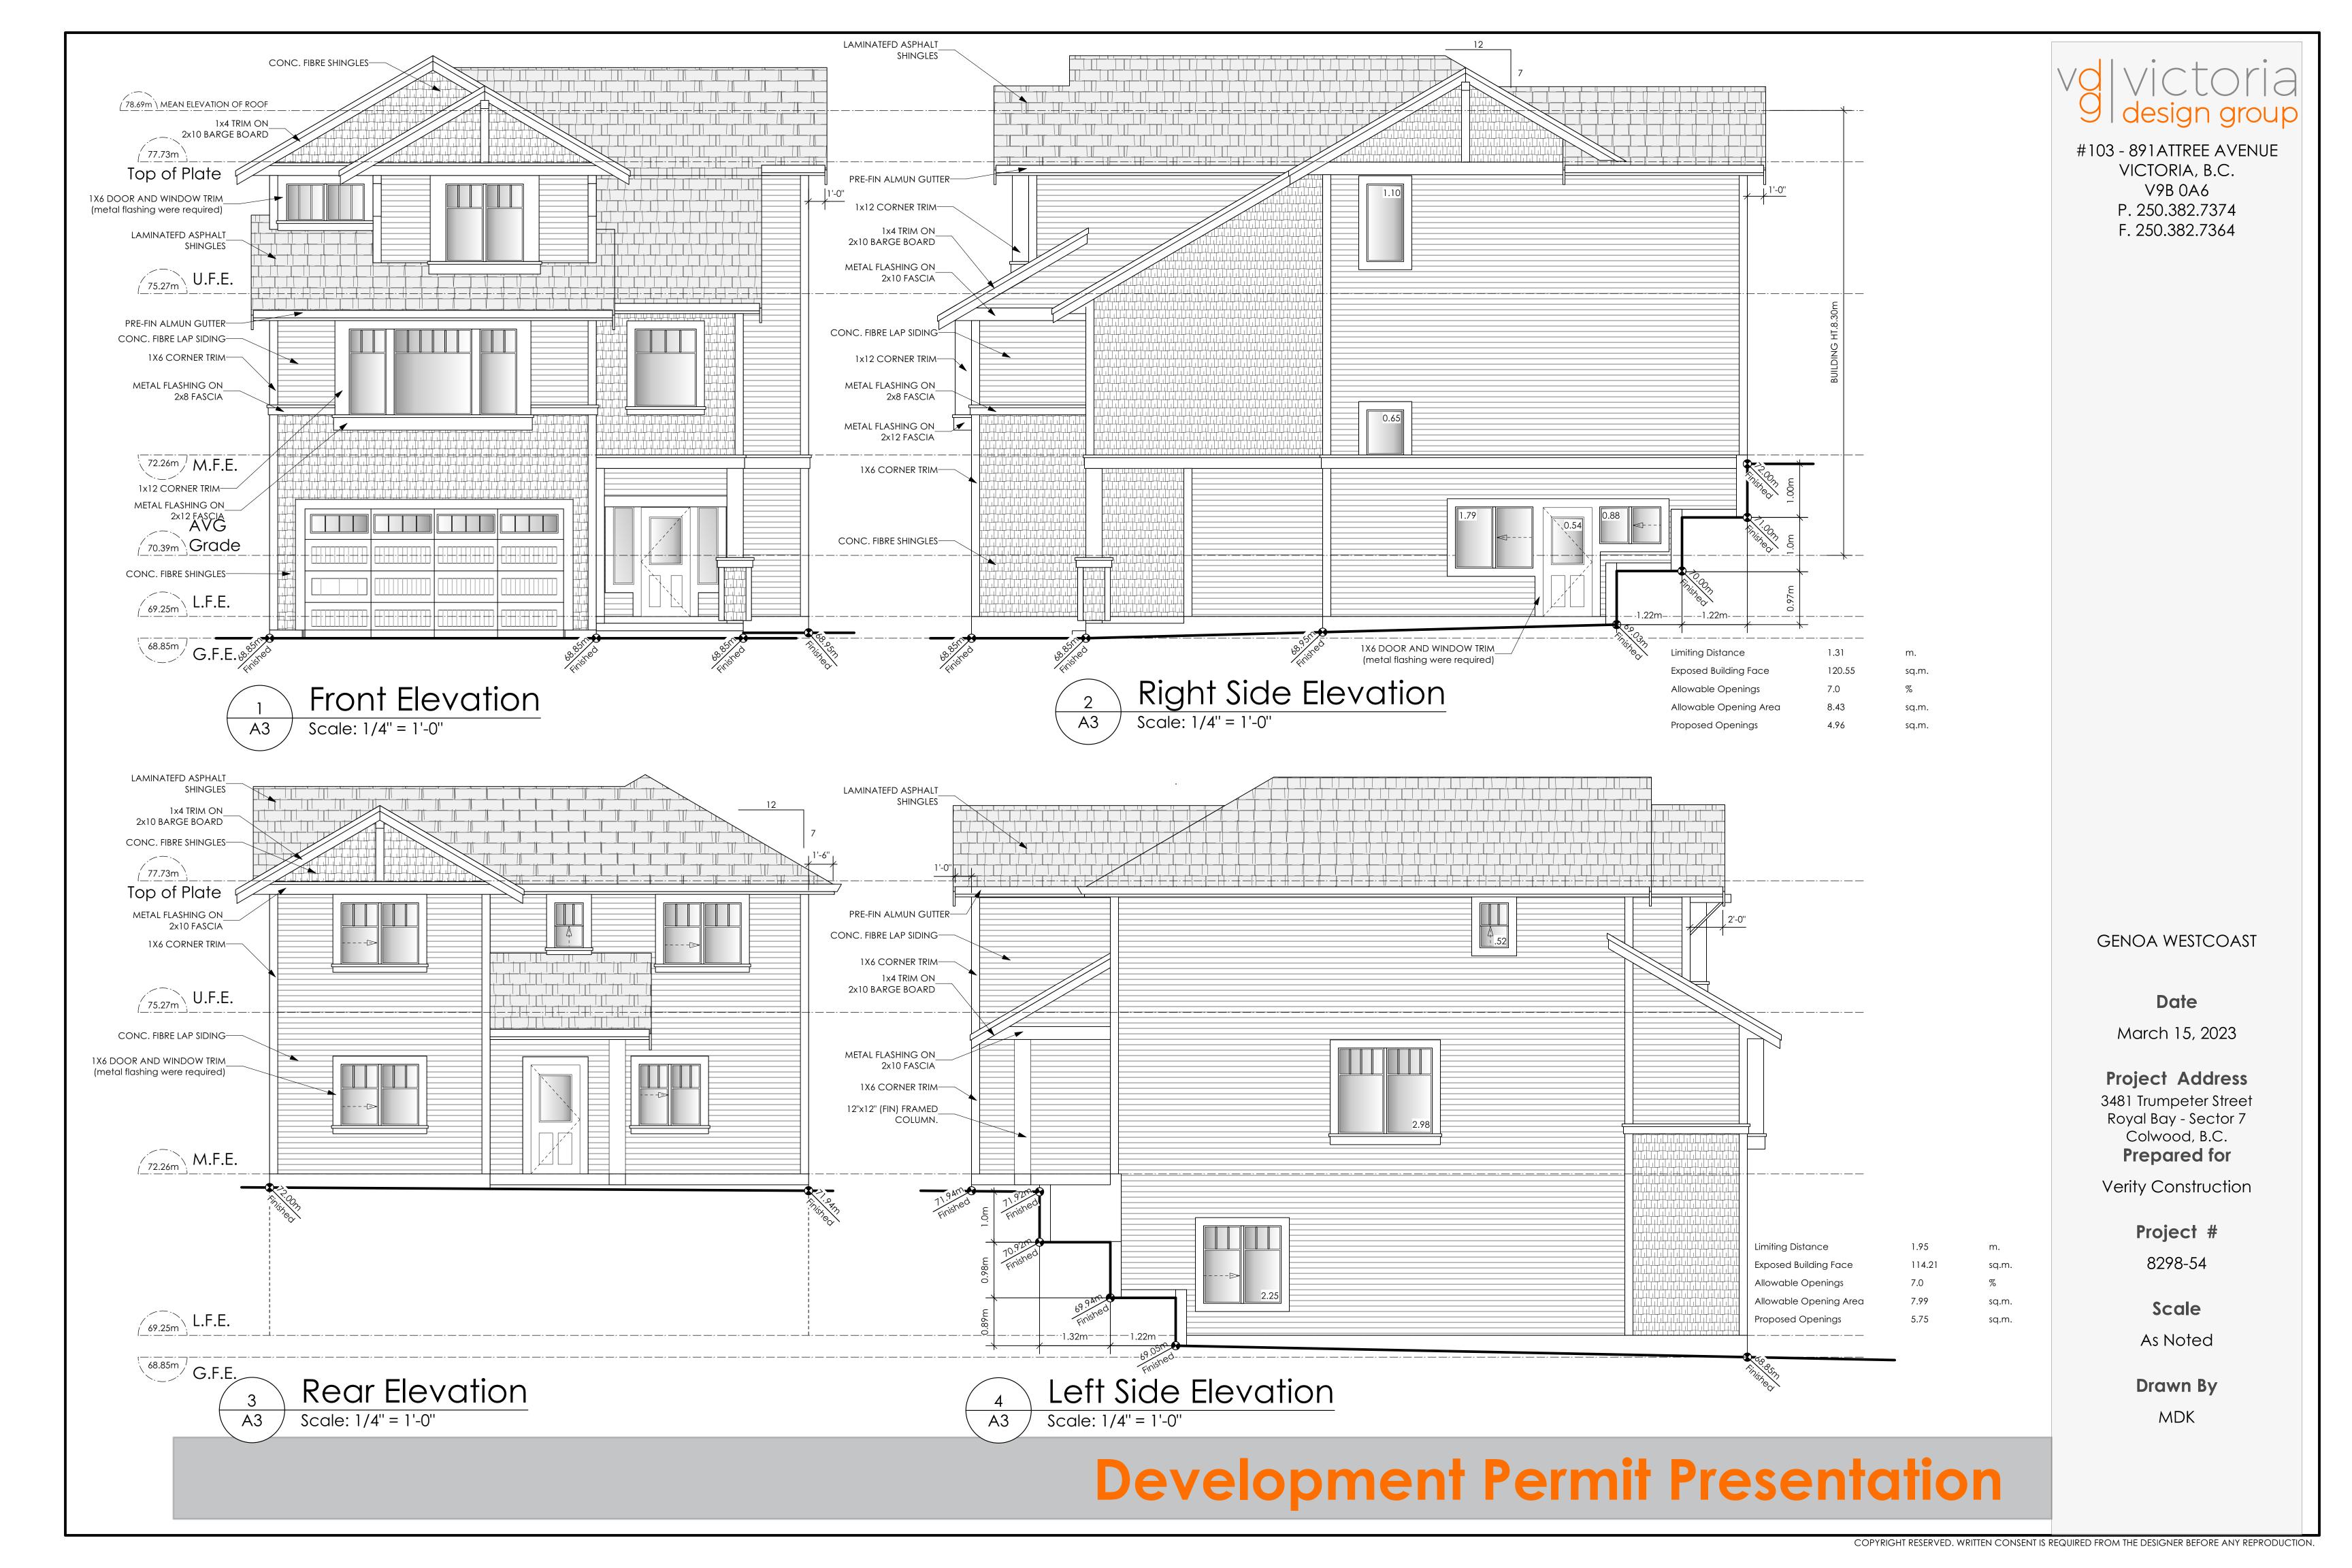

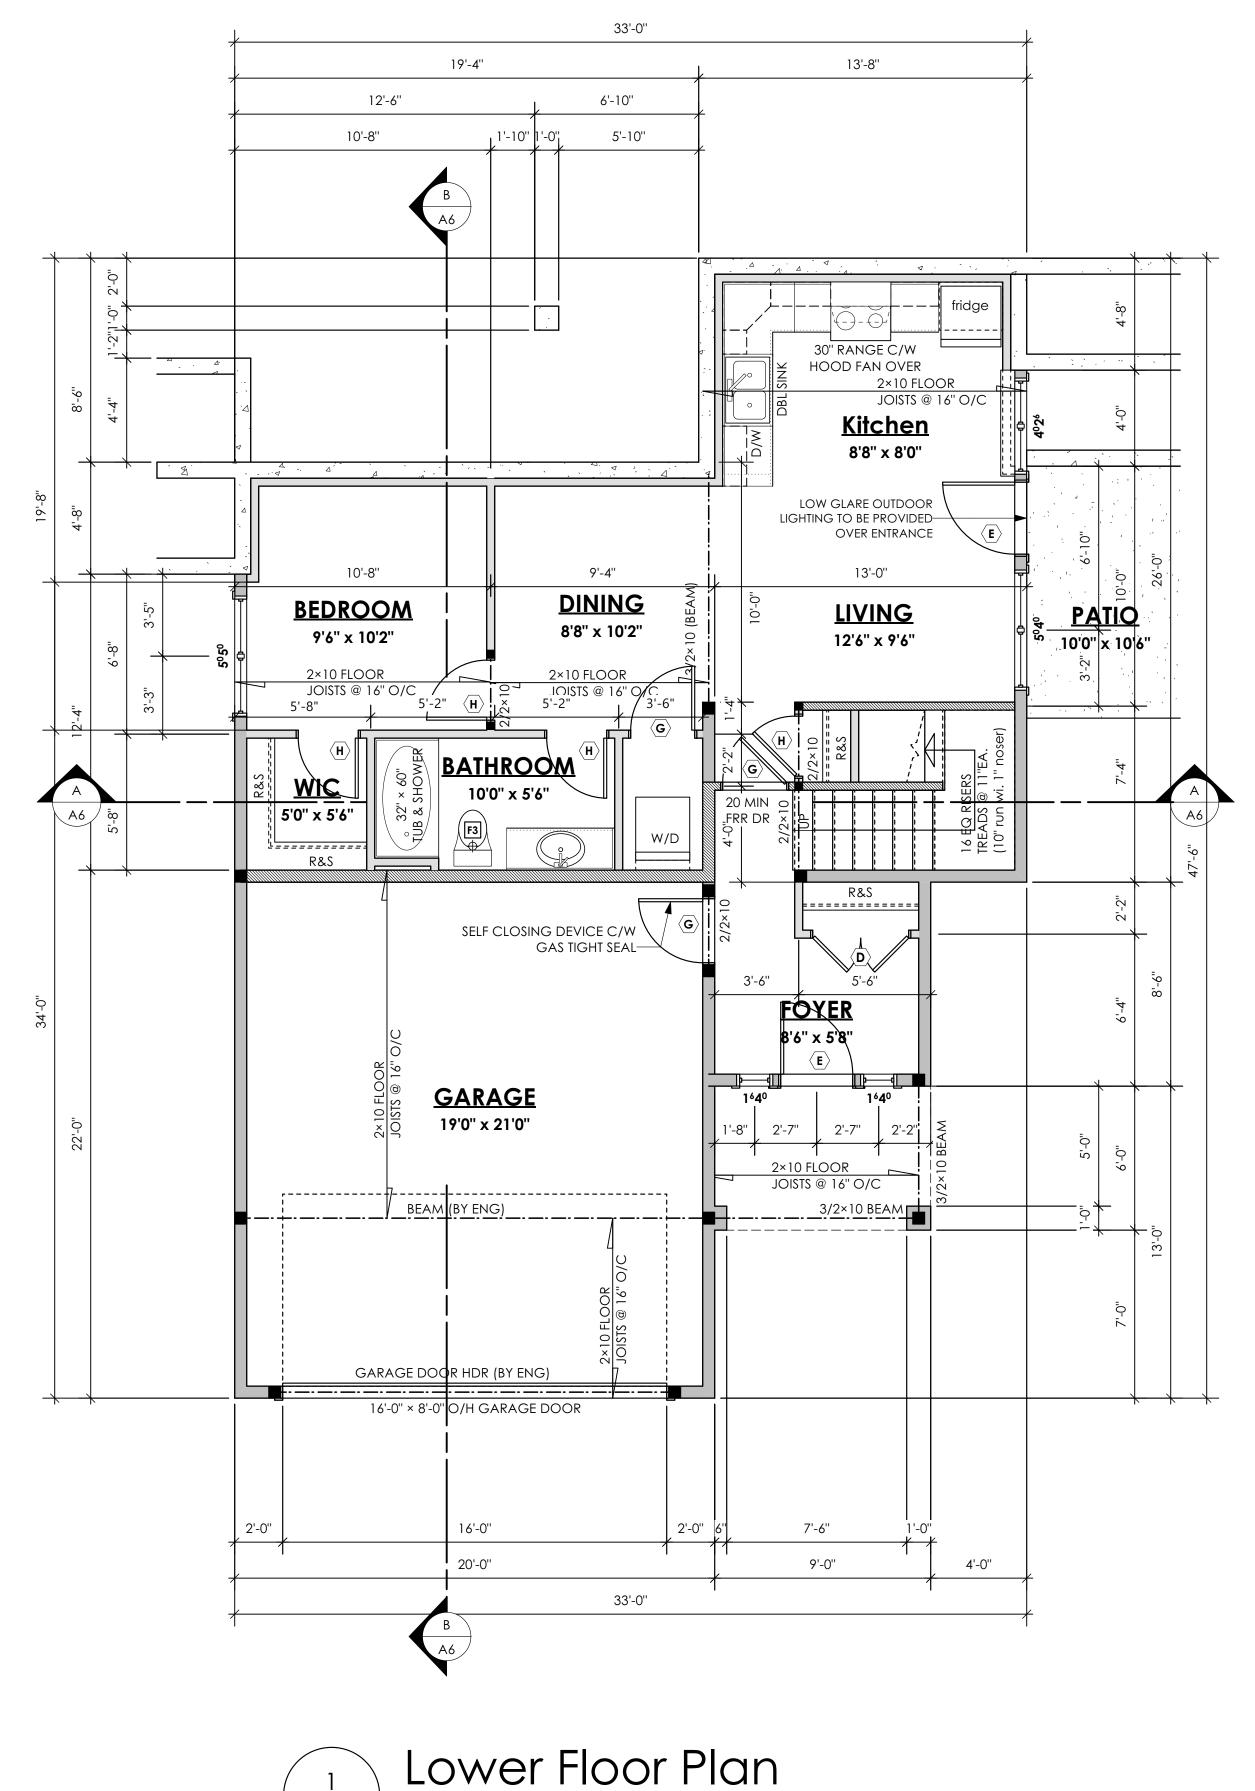



PRIMARY: 129.38 sq.ft. (12.02 sq.m.) SUITE: 591.00 sq.ft.4 (54.91 sq.m.) TOTAL: 720.38 sq.ft. (66.93 sq.m.) GARAGE: 440.00 sq.ft. (40.88 sq.m.)

#103 - 891ATTREE AVENUE VICTORIA, B.C. V9B 0A6 P. 250.382.7374 F. 250.382.7364

GENOA WESTCOAST

Date

March 15, 2023

Project Address

3481 Trumpeter Street Royal Bay - Sector 7 Colwood, B.C. Prepared for

Verity Construction

Project #

8298-54

As Noted


Scale

Drawn By

MDK



#103 - 891 ATTREE AVENUE VICTORIA, B.C. V9B 0A6 P. 250.382.7374 F. 250.382.7364

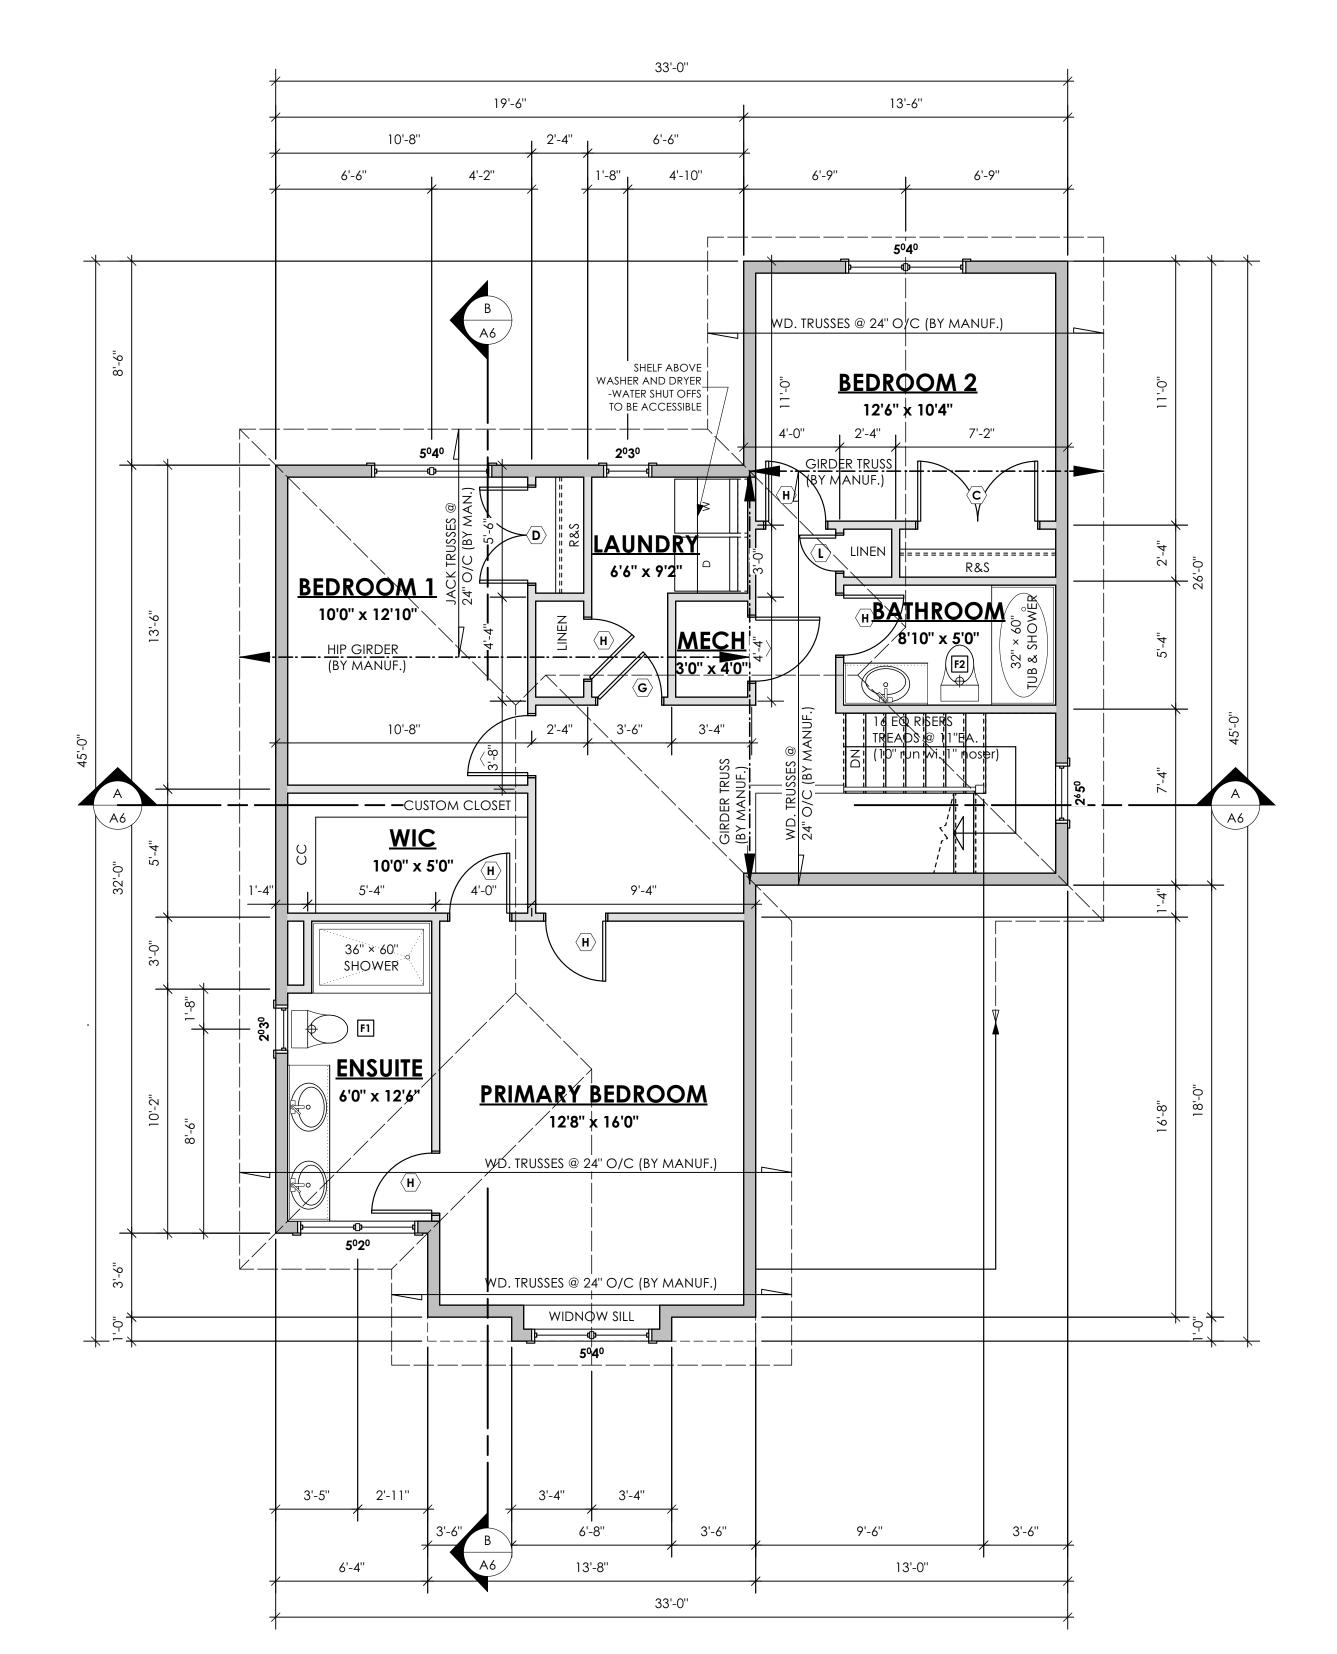



2'-6''

33'-0"

3'-6"

4'-3"

4'-0''

33'-0"

FRENCH

13'-6"

2×10 FLOOR JOISTS @ 16" O/C

OFFICE

BEDROOM 3

12'6" x 10'4"

19'-6"

<u>Kitchen</u>

19'0" x 11'0"

LATBAR BEAM (BY ENG)

<u>DINING</u>

19'0" x 11'0"

<u>LIVING</u>

19|'0" x 16'0"

2'-6"

BEAM (BY ENG)

12'-6"

8'-6"

NOTE:
ALL STRUCTURE TO BE VERIFIED OR DESIGNED BY A STRUCTURAL ENGINEER.
STRUCTURAL ENGINEER TO LOCATE AND DESIGN REQUIRED EXTERIOR
AND INTERIOR WALL BRACING TO RESIST LATERAL LOADS IN COMPLIANCE
WITH B.C. BUILDING CODE 9.23.13. AND SUPPLY DETAILS IF REQUIRED

STRUCTURAL WOOD ELEMENTS WITHIN 150MM (6") FROM FINISHED GROUND LEVEL SHALL BE PRESSURE TREATED WITH A PRESERVATIVE FOR TERMITE AND DECAY PROTECTION B.C.B.C. 9.3.2.9.(3)



GENOA WESTCOAST

Date

March 15, 2023

Project Address
3481 Trumpeter Street
Royal Bay - Sector 7
Colwood, B.C.
Prepared for

Verity Construction

Project #


8298-54

Scale

As Noted

Drawn By

MDK

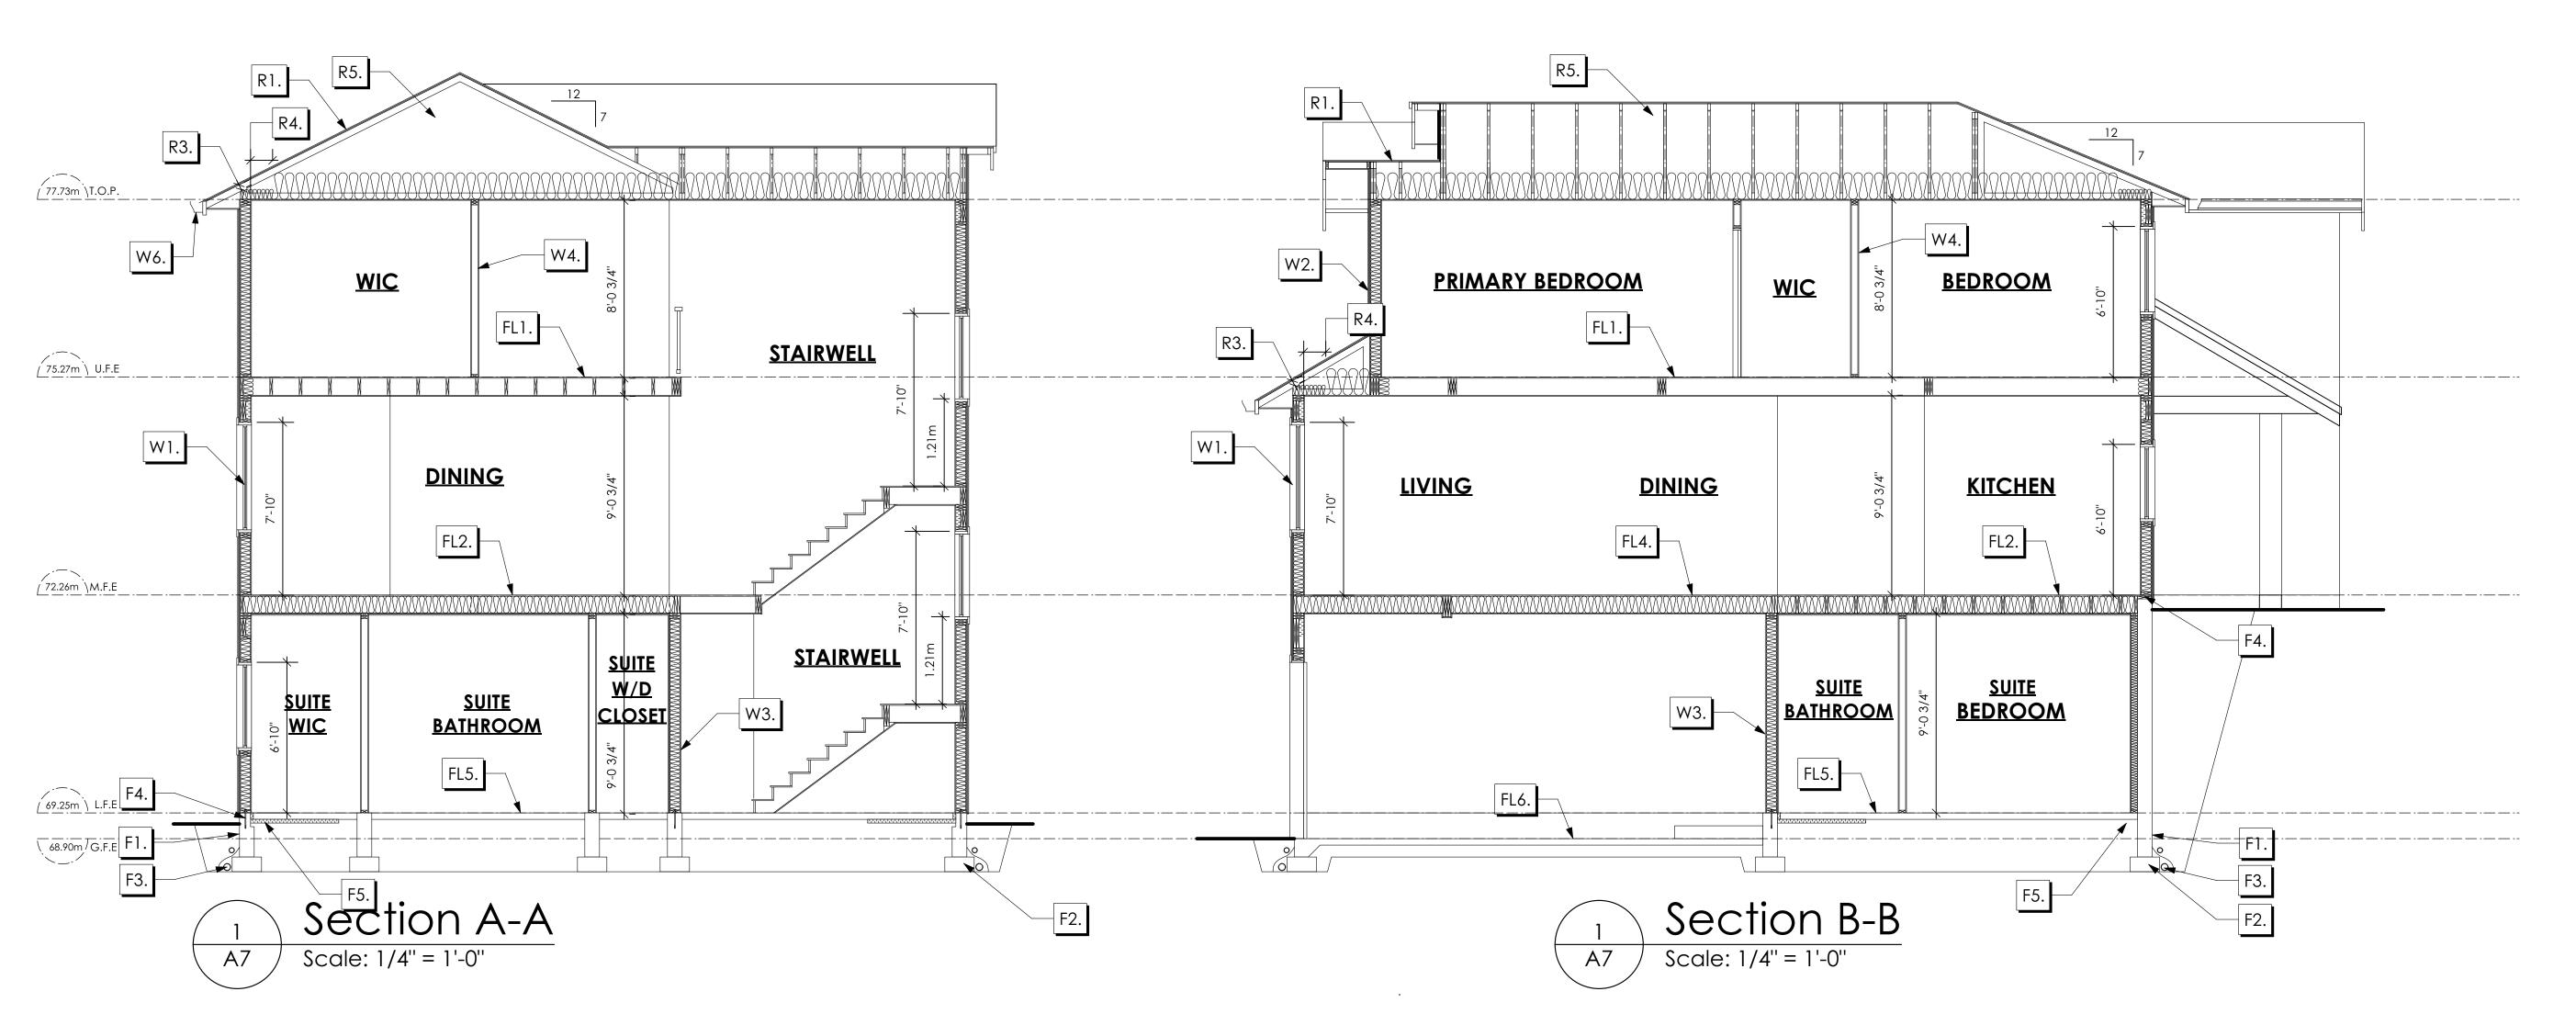

R1. LAMINATED ASPHALT SHINGLES ON
7/16" ORIENTED STRAND BOARD C/W "H" CLIPS
WD TRUSSES (DESIGNED BY MANUF.)
R-40 FIBRE GLAS BATT INSULATION OR
14 1/2" FIBRE GLASS LOOSE FILL INSULATION
6 MIL POLY'N V.B.
5/8" GYPSUM BOARD

22. LAMINATED ASPHALT SHINGLES ON
7/16" ORIENTED STRAND BOARD C/W "H" CLIPS
WD TRUSSES (DESIGNED BY MANUF.)
1/2" ORIENTED STRAND BOARD
VENTED SOFFIT

R3. PROVIDE 2 1/2" (63MM) CLEAR BETWEEN
R-20 INSULATION AND SHEATHING.
(MIN. R-20 @ ROOF-WALL CONNECTION FOR
4'-0" (1.2M) AROUND PERIMETER OF BUILDING.
AIR VENTILATION BAFFLES TO BE INSTALLED
WHERE REQUIRED IN AS PER BCBC 9.19.)

R4. EAVE PROTECTION

CONT. UP ROOF SLOPE FOR 12"

PAST EXTERIOR WALL.

R5. PROVIDE 1 SQ.FT. ATTIC VENT PER
300 SQ.FT. OF INSULATED AREA MIN.
25% OF REQUIRED TO BE @ TOP AND BOTTOM
(TO COMPLY WI. B.C. BLDG. CODE 9.19.1)

R6. PRE-FIN. FASCIA GUTTER
2×8 FASCIA BD.
2×4 SUB. FASCIA BD.
VENTED SOFFIT
(SEE CONTRACTOR)

R7. PRE-FIN. FASCIA GUTTER
2×8 FASCIA BD.
2×4 SUB. FASCIA BD.
1/2" ORIENTED STRAND BOARD
VENTED SOFFIT
(SEE CONTRACTOR)

FL1. FINISHED FLOORING ON

11/16" ORIENTED STRAND BOARD

(FASTENED & GLUED TO FLOOR STRUCT. BELOW) ON

2×10 FLOOR JOISTS @ 16" OR 12" O/C

C/W 2×2 X-BRIDGING @ 7.0' O/C (MAX)

1/2" GYPSUM BOARD

FL2. B.C. BUILDING CODE (TABLE-9.10.3.1.B)
RATED FLOOR ASSEMBLY F8D
FINISHED FLOORING ON
11/16" ORIENTED STRAND BOARD
(FASTENED & GLUED TO FLOOR STRUCT. BELOW) ON
2×10 FLOOR JOISTS @ 16" OR 12" O/C
C/W 2×2 X-BRIDGING @ 7.0' O/C (MAX)
R-31 INSULATION
RESILIENT METAL CHANNELS @ 24" O/C
1 LAYERS 5/8" X-TYPE GYPSUM BOARD
30 MINUTE F.R.R., 50 S.T.C.

FL3. FINISHED FLOORING ON

11/16" ORIENTED STRAND BOARD

(FASTENED & GLUED TO FLOOR STRUCT. BELOW) ON

2×10 FLOOR JOISTS @ 16" OR 12" O/C

C/W 2×2 X-BRIDGING @ 7.0' O/C (MAX)

PROVIDE R-31 F/G BATT INSULATION IN

JOIST CAVITY C/W

BUILDING WRAP

VENTED SOFFIT (TO OWNERS SPEC'S)

TO ALL SUSPENDED FLOOR AREAS

FL4. FINISHED FLOORING ON
19/32" ORIENTED STRAND BOARD
(NAILED & GLUED TO FLOOR STRUCT. BELOW) ON
2×10 FLOOR JOISTS @ 16" OR 12" O/C
C/W 2×2 X-BRIDGING @ 7.0' O/C (MAX)
R-31 INSULATION
5/8" X-TYPE GYPSUM BOARD
(BETWEEN GARAGE AND LIVING SPACE)

FL5. 3 1/2" CONCRETE SLAB
6 MIL. POLY'N V.B.
6" COMPACTED GRAVEL OR SAND

FL6. 3 1/2" CONCRETE SLAB
6 MIL. POLY'N V.B.
6" COMPACTED GRAVEL OR SAND
SLOPE TO DOORS 1"
(NOT IN SECTION)

W1. DOUBLE GLAZING
ENERGY STAR LOW "E" RATING IN
THERMAL BREAK FRAMES
2/2"X10" LINTEL OVER (@ bearing walls only)
(TYPICAL, wi. 2 1/2" XPS insulation)
FLASHING OVER @ EXTERIOR
(glazing in all exterior doors & within 3 ft.
of exterior doors to be shatterproof (SP))

WINDOW REQUIREMENTS DERIVED FROM
CITY OF COLWOOD BUILDING BYLAW
AND ARE TO BE USED TO SATISFY
THE REQUIREMENTS OF
AAMA/WDMA/CSA 101/I.S.2/A440, "NAFS":
COLWOOD, CLASS R - PG30 (220) A3,
RATINGS MUST BE CLEARLY LABELED ON ALL

UNITS UPON INSTALLATION FOR INSPECTION.

W2. CONC. FIBRE BOARD ON
9.5MM (3/8") AIR SPACE / STRAPPING
3/8"×2" BORATE TREATED PLYWOOD STRAPPING
HOUSE WRAP (A.B.) (TYVEK OR EQ.)
7/16" ORIENTED STRAND BOARD SHEATHING
2×6 STUDS @ 16" O/C
R-20 INSULATION
6 MIL. POLYETHYLENE VAPOUR BARRIER
1/2" GYPSUM BOARD

W3. B.C. BUILDING CODE (TABLE 9.10.3.1.A)
RATED WALL ASSEMBLY W3C

1 LAYER 1/2" X-TYPE GYPSUM BOARD
RESILIENT METAL CHANNELS @ 24" O/C
2×4 STUDS @ 16" O/C OR
2×6 STUDS @ 16" O/C (IF NOTED) C/W
3 1/2" FIBRE GLASS SOUND BATTS
1 LAYER 1/2" X-TYPE GYPSUM BOARD
45 MIN. F.R.R 43 S.T.C
(BETWEEN PRIMARY LIVING & SECONDARY SUITE)

W4. INTERIOR PARTITION

1/2" GYPSUM BOARD ON EACH SIDE

OF 2×4 STUDS @ 16" O/C OR

2×6 STUDS @ 16" O/C (IF NOTED)

W5. 5/8" X-TYPE GYPSUM BOARD ON 2×6 STUDS @ 16" O/C C/W
R-20 INSULATION
6 MIL. POLY'N V.B
1/2" GYPSUM BOARD
(BETWEEN GARAGE & LIVING)
(not in section)

W6. 1/2" GYPSUM BOARD ON
6 MIL. POLY'N V.B.
2×4 STUDS @ 24" O/C C/W
R-12 BATT INSULATION
BUILDING WRAP OR
12.7MM (1/2") AIR SPACE
(PROVIDE REQUIRED FIRE STOPS IN WALL
ASSEMBLIES TO COMPLY WITH
B.C. BLDG. CODE 9.10.16.)

F1. DAMP PROOFING (WHERE REQUIRED) ON 8" THK. CONC. FOUNDATION WALL C/W 15 M BARS @ 24" O/C B/W

F2. 16"X 8" CONC. FOOTINGS

C/W 2 (TWO) 15M BARS CONT. 3 IN. FROM BOTT.

ON UNDISTURBED SOIL (SOLID BEARING)

F3. 4" PERIMETER DRAIN 3" TIGHT PIPE FOR RWL DRAIN ROCK

F4. ANCHOR BOLTS @ 4.0 FT. O/C MAX C/W SILL GASKETS

F5. STEP DOWN TO GARAGE SLAB MAY VARY, VERIFY EXTENT ON SITE (NOT IN SECTION) Volvictoria 9 design group

#103 - 891 ATTREE AVENUE VICTORIA, B.C. V9B 0A6 P. 250.382.7374 F. 250.382.7364

GENOA WESTCOAST

Date

March 15, 2023

Project Address

3481 Trumpeter Street Royal Bay - Sector 7 Colwood, B.C. **Prepared for**

Verity Construction

Project #

8298-54

Scale


As Noted

Drawn By

MDK



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GENOA WESTCOAST
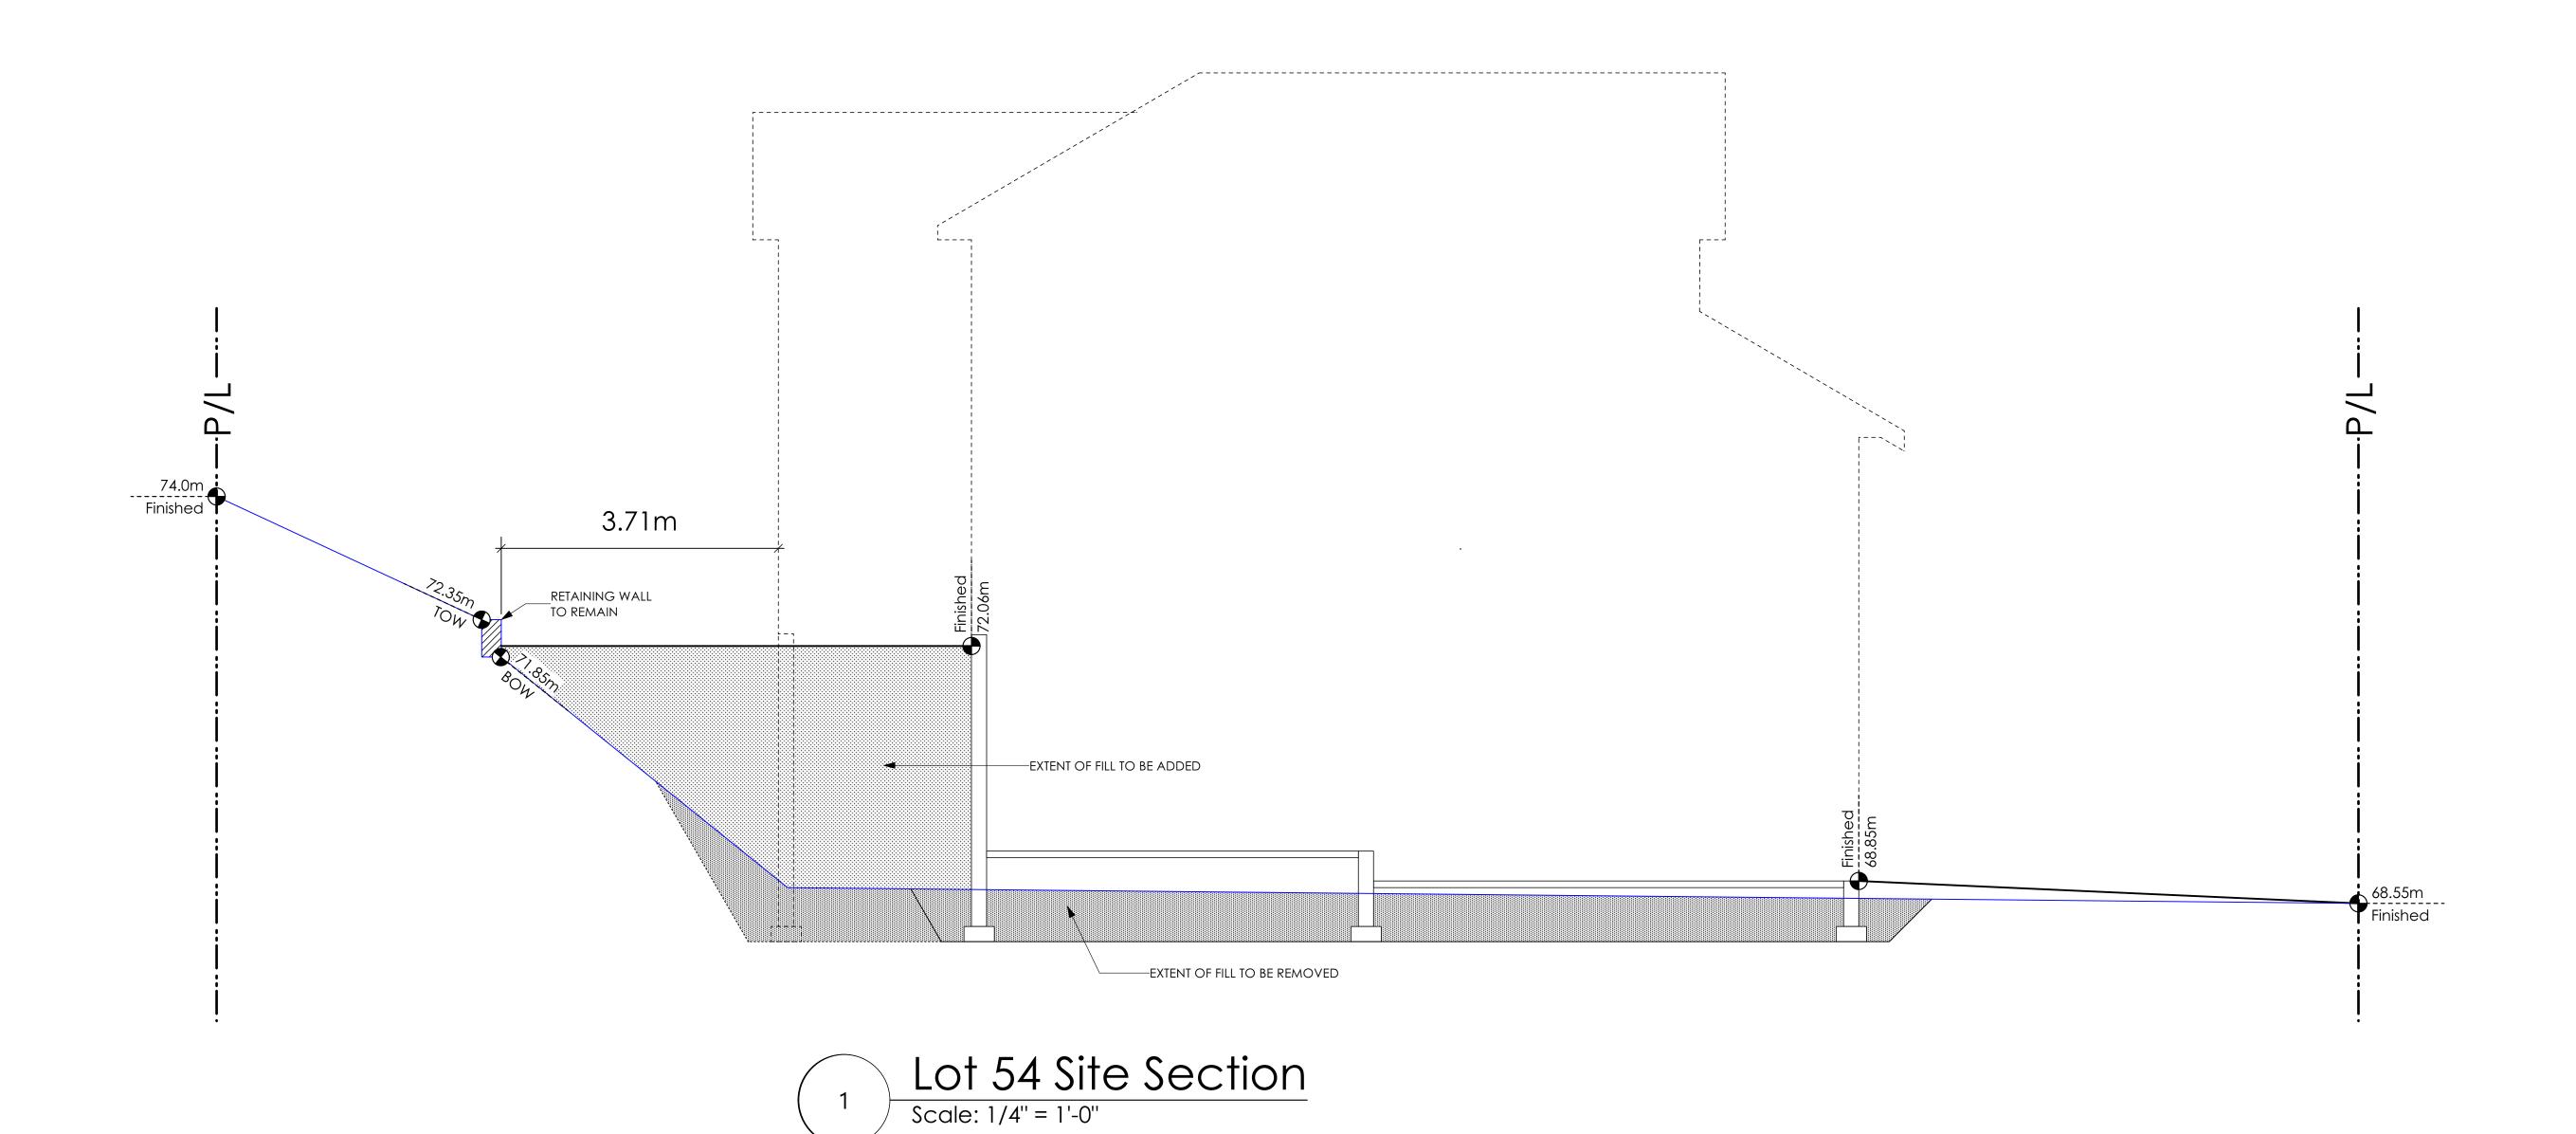
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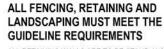
8298-54

Scale

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MDK



ALL RETAINING WALLS ARE TO BE STAND ALONE STRUCTURES (THEY MUST TERMINATE AT PROPERTY LINE) AND MUST NOT CONNECT TO RETAINING WALLS LOCATED ON ADJACENT PRIVATE PROPERTIES

> ESTIMATED LOCATION OF REAR FENCING - SUBJECT TO CHANGE ACCORDING TO

10/14/22

01/17/23

01

02

*NOTE: In the interest of maintaining high standards, the developer reserves the right to modify plans, specifications and design without prior notice. Drawings contained within are artist renderings only. Sizes and dimensions are approximate and may vary with actual plan and survey. Exterior style may change pending municipal approval. Retaining wall location and types may vary and are subject to municipal, engineering or developer discretion. Subject to change without notice. Furniture as shown on plans are for layout purposes only and are not included in the sale.

ITEM		AREA (sf)	%
68	GARDEN BED	345	9%
	GRAVEL	571	15%
21/2/19	CONCRETE	784	20%
	SOD	2,150	56%
	TOTAL	3,850	100%

LEGEND

LOCATION INDICATED BY


6X6 WOOD POST


PRIVACY SHRUBBERY

PRIVACY

8

UPGRADE SHRUBBERY, PLANTS AND FOLIAGE - 2 GAL KEY PLAN NOT TO SCALE

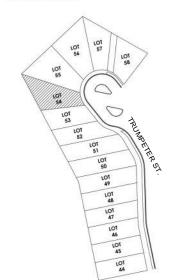

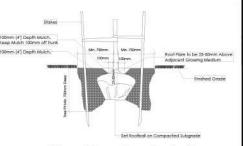

Tree Planting Detail

Not To Scale

All trees and plants by the home owner to be particular in minimum (Dan' of tertile topsoil, 700mm Deser

ADDITIONAL NOTES:

PROPERTY TO BE IRRIGATED
6" PIPE FOR DRIVEWAY SLEEVES TO
BE INSTALLED FOR CITY IRRIGATION
LINES

Not To Scale

COMPACTED SUBGRADE

Typical Fence Detail

*TYPICAL FENCE DETAIL BASED OFF FENCE DETAIL 1/L1 FROM ROYAL BAY DESIGN GUIDELINES PAGE 21

MM/DD/YY	ISSUED/REVISED	DATE	

FOR APPROVAL

SITE PLAN REVISION

PATIO 10'-0'x14'-0"

PROJECT

LOT 54

LANDSCAPING PLAN LOT 54, 3481 TRUMPETER ST. ROYAL BAY, SECTOR 7 CITY OF COLWOOD

PRIVACY SHRUBBERY PLANTS AND FOLIAGE

LANDSCAPE PLAN

NOT TO SCALE

PRIVACY SHRUBBERY

PLANTS AND FOLIAGE TO SCREEN PARKING

AND PROPERTY



QUALITY CONSTRUCTION. TRUSTED SERVICE.

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WSP	Project	No:	201-08151-00
	,		

C. Hume - Nov. 9/22

GABLECTART HOMES BILLIDING	WSP Project No: 201-08151-00 G GRADE SLIP
BUILDING	issue Dute.
MUNICIPAL ADDRESS	P.I.D.
LOT 54	PLAN
VERITY HOMES	SUBDIVISION ROYAL BAY SECTOR 7
ADDRESS	DEVELOPER MEADOWS DEVELOPMENT LP
REPRESENTATIVE PH.	CONSULTANT WSP CANADA INC
FRONT ELEV. 08.05 REAR ELEV. 10.02172.0072.00 (FINISHED GRADE) FINISHED GRADE AT GARAGE 68.85 ACTUAL TOP OF FOOTING	68.55 54 EG 68.2 LFE 69.12 GFE 68.92 MSE 65.82 S 65.54 D 66.46 D
SANITARY 100	
STORM 100	RETAINING
COMMENTS YES NO) WALL
DRAIN TO SUMP PUMP LIKELY REQUIRED (FOR BASEMENT IF INSTALLED)	LECEND
SEWER TO SUMP PUMP LIKELY REQUIRED (FOR BASEMENT IF INSTALLED)	<u>LEGEND</u> Street
SERVICES INSTALLED TO m INSIDE PROPERTY	
FOUNDATION SOIL BEARING INVESTIGATION CERTIFICATION REQUIRED	SERVICE LOCATION (SHOWN ON ABOVE PLAN)
GEOTECHNICAL RESTRICTIONS APPLY	
(SEE GEOTECHNICAL REPORT)	- PROPOSED FRONT CORNER ELEVATIONS - PROPOSED FRONT SIDE YARD GRADES
(SEE ENVIRONMENTAL REPORT)	EG 49.90 PO - EXISTING GROUND ELEVATION
UTILITY EASEMENTS AFFECT THIS LOT	LFE/MFE 47.70 GFE 47.55 MSE 52.20 S 49.12 (P) D 49.12 (P) D 49.12 (P) L OR BASEMENT IF INSTALLED - STORM SERVICE INV. (P) DENOTES PUMP IS LIKELY REQUIRED FOR BASEMENT IF INSTALLED - STORM SERVICE INV. (P) DENOTES PUMP IS LIKELY REQUIRED FOR BASEMENT IF INSTALLED - PROPOSED REAR SIDE YARD GRADES
NOTES	- LOT TYPE (L/LB/LBT) - PROPOSED REAR CORNER ELEVATIONS
IT IS THE RESPONSIBILITY OF THE BUILDER TO ENSURE THE FOOTINGS ARE PLACED ON A PROPER BASE THAT IS FREE FROM FROST, EXCESSIVE MOISTURE AND DELETERIOUS MATERIALS AND HAVE APPROPRIATE FROST PROTECTION WHEN COMPLETED. THE INSORMATION CONTAINED HEREIN IS PASED ON THE APPROVED.	LANE/LOT
2. THE INFORMATION CONTAINED HEREIN IS BASED ON THE APPROVED LOT GRADING PLAN FOR THIS SUBDIVISION. UN—AUTHORIZED DEVIATIONS WILL BE THE RESPONSIBILITY OF THE BUILDER TO ENSURE COMPLIANCE WITH ALL LOCAL BYLAWS. 3. OTHER NOTES:	I, THE BUILDER'S REPRESENTATIVE, CERTIFY THAT THE FINAL HOUSE PLANS PROVIDED IN THE BUILDING PERMIT APPLICATION ARE THE SAME AS PROCESSED UNDER THIS GRADE SLIP AND THAT I UNDERSTAND THE INFORMATION AND THE REQUIREMENTS CONTAINED HEREIN AND WILL BUILD ACCORDINGLY.
	AUTHORIZED BUILDER'S REPRESENTATIVE DATE THE INFORMATION CONTAINED HEREIN IS BASED ON THE APPROVED LOT GRADING PLAN FOR THIS SUBDIVISION, DATED