

CITY OF COLWOOD 3300 Wishart Road | Colwood | BC V9C 1R1 | 250-294-8153 planning@colwood.ca | www.colwood.ca

File: DP-23-001A

DEVELOPMENT PERMIT DP-23-001A

THIS PERMIT, issued June <u>1</u> 2023 is,

ISSUED BY: CITY OF COLWOOD, a municipality incorporated under the *Local Government Act*, 3300 Wishart Road, Victoria, BC, V9C 1R1

(the "City")

PURSUANT TO: Section 490 of the Local Government Act, RSBC 2015, Chapter 1

ISSUED TO: Verity Construction Ltd 106-1039 Langford Parkway Victoria, BC V9B 0A6

(the "Permittee")

1. This Form and Character Development Permits applies to those lands within the City of Colwood described below, and any and all buildings, structures, and other development thereon:

Lots 49 – 54 PLAN EPP117070 SECTION 38 ESQUIMALT 3471, 3473, 3475, 3477, 3479 and 3481 Trumpeter Street

(the "Lands")

- 2. This Development Permit regulates the development and alterations of the Land, and supplements the "Colwood Land Use Bylaw, 1989" (Bylaw No. 151), to ensure the form & character considerations for 6 single family homes with secondary suites and associated site improvements are consistent with the guidelines for areas designated as "Neighbourhood Intensive Residential" in the City of Colwood Official Community Plan (Bylaw No. 1700).
- 3. This Development Permit is **NOT** a Building Permit or a subdivision approval.
- 4. This Development Permit is issued subject to compliance with all of the bylaws of the City of Colwood that apply to the development of the Lands, except as specifically varied by Council or supplemented by this Permit, including DP-21-008.
- 5. The Director of Development Services or their delegate may approve minor variations to the schedules attached to and forming part of this Development Permit, provided that such minor

variations are consistent with the overall intent of the original plans and do not alter the form and character of the development authorized by those plans.

- 6. If the Permittee does not substantially start the construction permitted by this Permit within 24 months of the date of this Permit, the Permit shall lapse and be of no further force and effect.
- 7. The development is to be constructed in accordance with the following plans and specifications, which are attached to and form as part of this permit:

Schedule 1	Geotechnical Report prepared by MGE Services Inc. revised May 5, 2023.
Schedule 2	Site Plan, Architectural Drawings, Elevation Drawings, Landscape Plan, and
	Grading Plan for 3471 Trumpeter Street dated December 22, 2022.
Schedule 3	Site Plan, Architectural Drawings, Elevation Drawings, Landscape Plan, and
	Grading Plan for 3473 Trumpeter Street dated December 22, 2022.
Schedule 4	Site Plan, Architectural Drawings, Elevation Drawings, Landscape Plan, and
	Grading Plan for 3475 Trumpeter Street dated April 27, 2023.
Schedule 5	Site Plan, Architectural Drawings, Elevation Drawings, Landscape Plan, and
	Grading Plan for 3477 Trumpeter Street dated May 2, 2023
Schedule 6	Site Plan, Architectural Drawings, Elevation Drawings, Landscape Plan, and
	Grading Plan for 3479 Trumpeter Street dated April 21, 2023.
Schedule 7	Site Plan, Architectural Drawings, Elevation Drawings, Landscape Plan, and
	Grading Plan for 3481 Trumpeter Street dated March 15, 2023

8. This Development Permit authorizes land alterations for the construction of 6 single family homes with secondary suites along with any associated site works. The Land shall not be altered, nor any buildings or structures constructed, except in accordance with the following conditions:

FORM AND CHARACTER CONDITIONS

Building Features

- 8.1. The form and character of the buildings to be constructed on the Lands shall conform to the Site Plan, Architectural Drawings and Elevation Drawings prepared by Victoria Design Group (Schedules 2-7).
- 8.2. Within any group of three adjacent homes on the lands, no two houses shall have the same dwelling unit design.
- 8.3. Any future additions of telecommunications antennas or equipment to the exterior of the buildings and/or structures included in this Permit shall be architecturally integrated into the buildings and/or structures they are mounted on or screened from views so as not to be visually obtrusive, to the satisfaction of the Director of Development Services.
- 8.4. No future construction/installation of unenclosed or enclosed outdoor storage areas, and recycling/refuse collection and storage areas shall be undertaken without the issuance of a further Development Permit or amendment to this Permit.
- 8.5. All mechanical roof elements, including mechanical equipment, elevator housings, and vents shall be visually screened with sloped roofs or parapets, or other forms of solid screening to the satisfaction of the Director of Development Services.

Landscaping

8.6. The design and construction of the proposed landscaping shall be in substantial compliance with the Landscape Plan prepared by Verity Construction (Schedules 2-7).

Grading

- 8.7. As required by Covenant CA9828107 registered on title, a geotechincal report was prepared to assess the Lands, and the recommendations from this report must be followed (Schedule 1).
- 8.8. Lot preparations shall be in compliance with the site-specific grading plan by Gablecraft Homes as part of Schedules 2-7.
- 8.9. All cut and fill expectations must be in substantial compliance with the Site Sections by Victoria Design Group as part of Schedules 2-7.

8.10.Retaining walls are not to connect with neighbouring properties and be a maximum height of 1.2m.

ISSUED ON THIS _____DAY OF JUNE, 2023.

YAZMIN HERNANDEZ DIRECTOR OF DEVELOPMENT SERVICES



RE:

MGE Services Inc. EGBC Permit to Practice No. 1003085 740 Cowper Street, Victoria, BC V9A 2E9 250-661-8335 MGEservices@shaw.ca

Revised May 5, 2023

April 3, 2023 File: 23V-003

Schedule 1

Verity Construction Ltd. 106-1039 Langford Parkway Victoria, BC V9B 0A5 Attention: Ms. Patricia Gomes

> Proposed House Construction Lots 49 to 54, Trumpeter Street (Sector 7, Royal Bay), Colwood Geotechnical Assessment Report

INTRODUCTION

As requested by Verity Construction Ltd. (the Client), MGE Services Inc. (MGE) has carried out a geotechnical assessment for six lots within the residential subdivision at the above-referenced site. The site was developed as part of the Royal Bay subdivision in Colwood, BC. Review of the Geotechnical Assessment Report for the Sector 7 Subdivision where the subject lots are located (prepared by Thurber Engineering Ltd. (Thurber) dated February 4, 2022) was carried out as part of our site review. This geotechnical report has been prepared as part of the development permit application specifically for Lots 49 to 54 within Sector 7 at the Royal Bay subdivision in Colwood.

The Royal Bay subdivision is located within a former gravel pit within the Colwood Outwash deposit. The subgrade within the subject sites consist of well-graded, pit run sand and gravel that was placed as part of the gravel pit reclamation following closure in 2008. MGE conducted site walkover of the subject lots in March 2023, at which time the lots were prepared to the approximate footing grade, with slopes extending up at the rear of the site. Grading of the existing slopes was prepared by the developer of the Royal Bay subdivision, which is proposed to be altered by the Client to achieve the house designs prepared for Lots 49 to 54.

MGE has conducted visual review of the subject lots, as documented in the attached Table 1 -Site Photos. The lot layout is shown in the attached Comprehensive Site Plan provided by the Client, with cross sections of the final grading on Lots 52, 53 and 54 (where existing retaining walls are located or new retaining walls are proposed) also attached to this report. This geotechnical assessment has been prepared in support of the development permit application prepared by the Client for single family houses to be constructed on the six subject lots.

PROJECT / SITE CONDITIONS

The proposed development includes six detached, single family homes that will be constructed with slabon-grade foundations and with either full or partial step up backyards. Due to the grading, which slopes down from west to east, the houses are to be constructed with foundation walls increased to provide support for backyards that will be approx. 1m above the front yard elevations at the Lot 49 end of these



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subject lots, grading up to approx. 3m above the front yard at Lot 54. It is understood that there will be retaining walls required between the house foundations at accommodate the grade changes between the front and rear yards of the subject lots. These walls are proposed to be stacked boulder walls constructed in tiers to a maximum height of 1.2m, as per City of Colwood requirements. Backfilling of the walls will be carried out with site-excavated pit run sand and gravel that is free-draining and suitable for positive drainage. A cross section schematic of the boulder wall is provided as Drawing 1.

Our review of open excavations onsite indicate that the lots are underlain by dense, native sand and gravel, which is consistent with the local geology mapping that shows the site to be within the Colwood Outwash deposit. The surface of the pit run sand and gravel has been disturbed since initial subdivision development and will require further site preparation, as per recommendations provided herein.

GEOTECHNICAL RECOMMENDATIONS

Based on our review of the subsurface conditions, the development of six single family houses is considered geotechnically appropriate. The native sand and gravel is considered suitable for providing bearing of the house foundations and associated retaining walls. It is recommended that building foundation design be based on a 100 kPa allowable bearing capacity, as determined by independent calculations. The sand and gravel subgrade is expected to require re-compaction, which is recommended to be carried out with a 10 tonne, steel drum, vibratory roller. MGE should be contacted to carry out review of the sand and gravel subgrade prior to foundation construction or structural filling, as needed by final grading.

If structural filling is required, the excavated sand and gravel material from the site is considered suitable for re-use based on past experience with the Colwood Outwash deposit. It is recommended that the sand and gravel is placed in maximum 300mm thickness lifts and thoroughly compacted with the vibratory roller. The extent of structural filling should be outside the building footprint or road alignment by at least the thickness of the fill, ie. a 1H:1V splay. As per the BC Building Code, MGE needs to carry out continuous monitoring of structural fill placement procedures to provide subgrade approval for the building foundations.

As discussed above, re-grading at the rear of the lots, specifically Lots 52 to 54 will be carried out following foundation construction and is shown in the Cross Sections attached to this report. New retaining wall construction will be necessary and is proposed to be limited to a maximum height of 1.2m to meet City of Colwood bylaw requirements. It is proposed to construct the retaining walls proposed on the site with stacked boulders, which are recommended to be sloped back at ½H:1V and oriented such that the long axis of the boulder extends back into the slope. Backfilling should be carried out with free-draining material, such as the sand and gravel observed onsite. MGE can provide further detail on retaining wall review as necessary. The attached Drawing 1 provides details on stacked boulder wall construction.



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CLOSURE

Our geotechnical assessment of the project site and the proposed development indicates that the lands are considered safe and suitable for the use intended. MGE to carry out field reviews during site preparation to confirm the intent of our geotechnical recommendations is met.

This letter has been prepared exclusively for Verity Construction Ltd. in accordance with the January 3, 2023 contract between MGE and Verity Construction Ltd. No third party can rely on this report, except for the City of Colwood, which is considered to be an authorized user, subject to the terms and conditions under which the work was completed.

We trust this meets your current requirements and ask that you contact the undersigned if there are any questions or concerns.

Yours truly,

MGE Services Inc.

Per: Alec Morse, P.Eng.


Attach: Table 1 – Site Photos Comprehensive Site Plan Cross Sections – Lots 52, 53 & 54 Drawing 1 – Boulder Wall Schematic






Table 1 – Site PhotosProject: Lots 49 – 54, Trumpeter Street, Royal Bay

Verity Construction Ltd. File: 23V-003

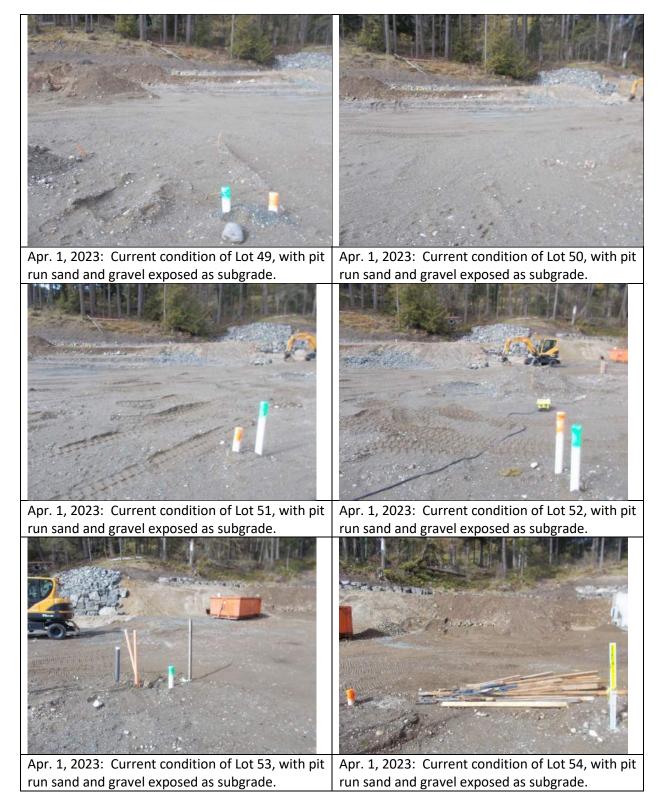

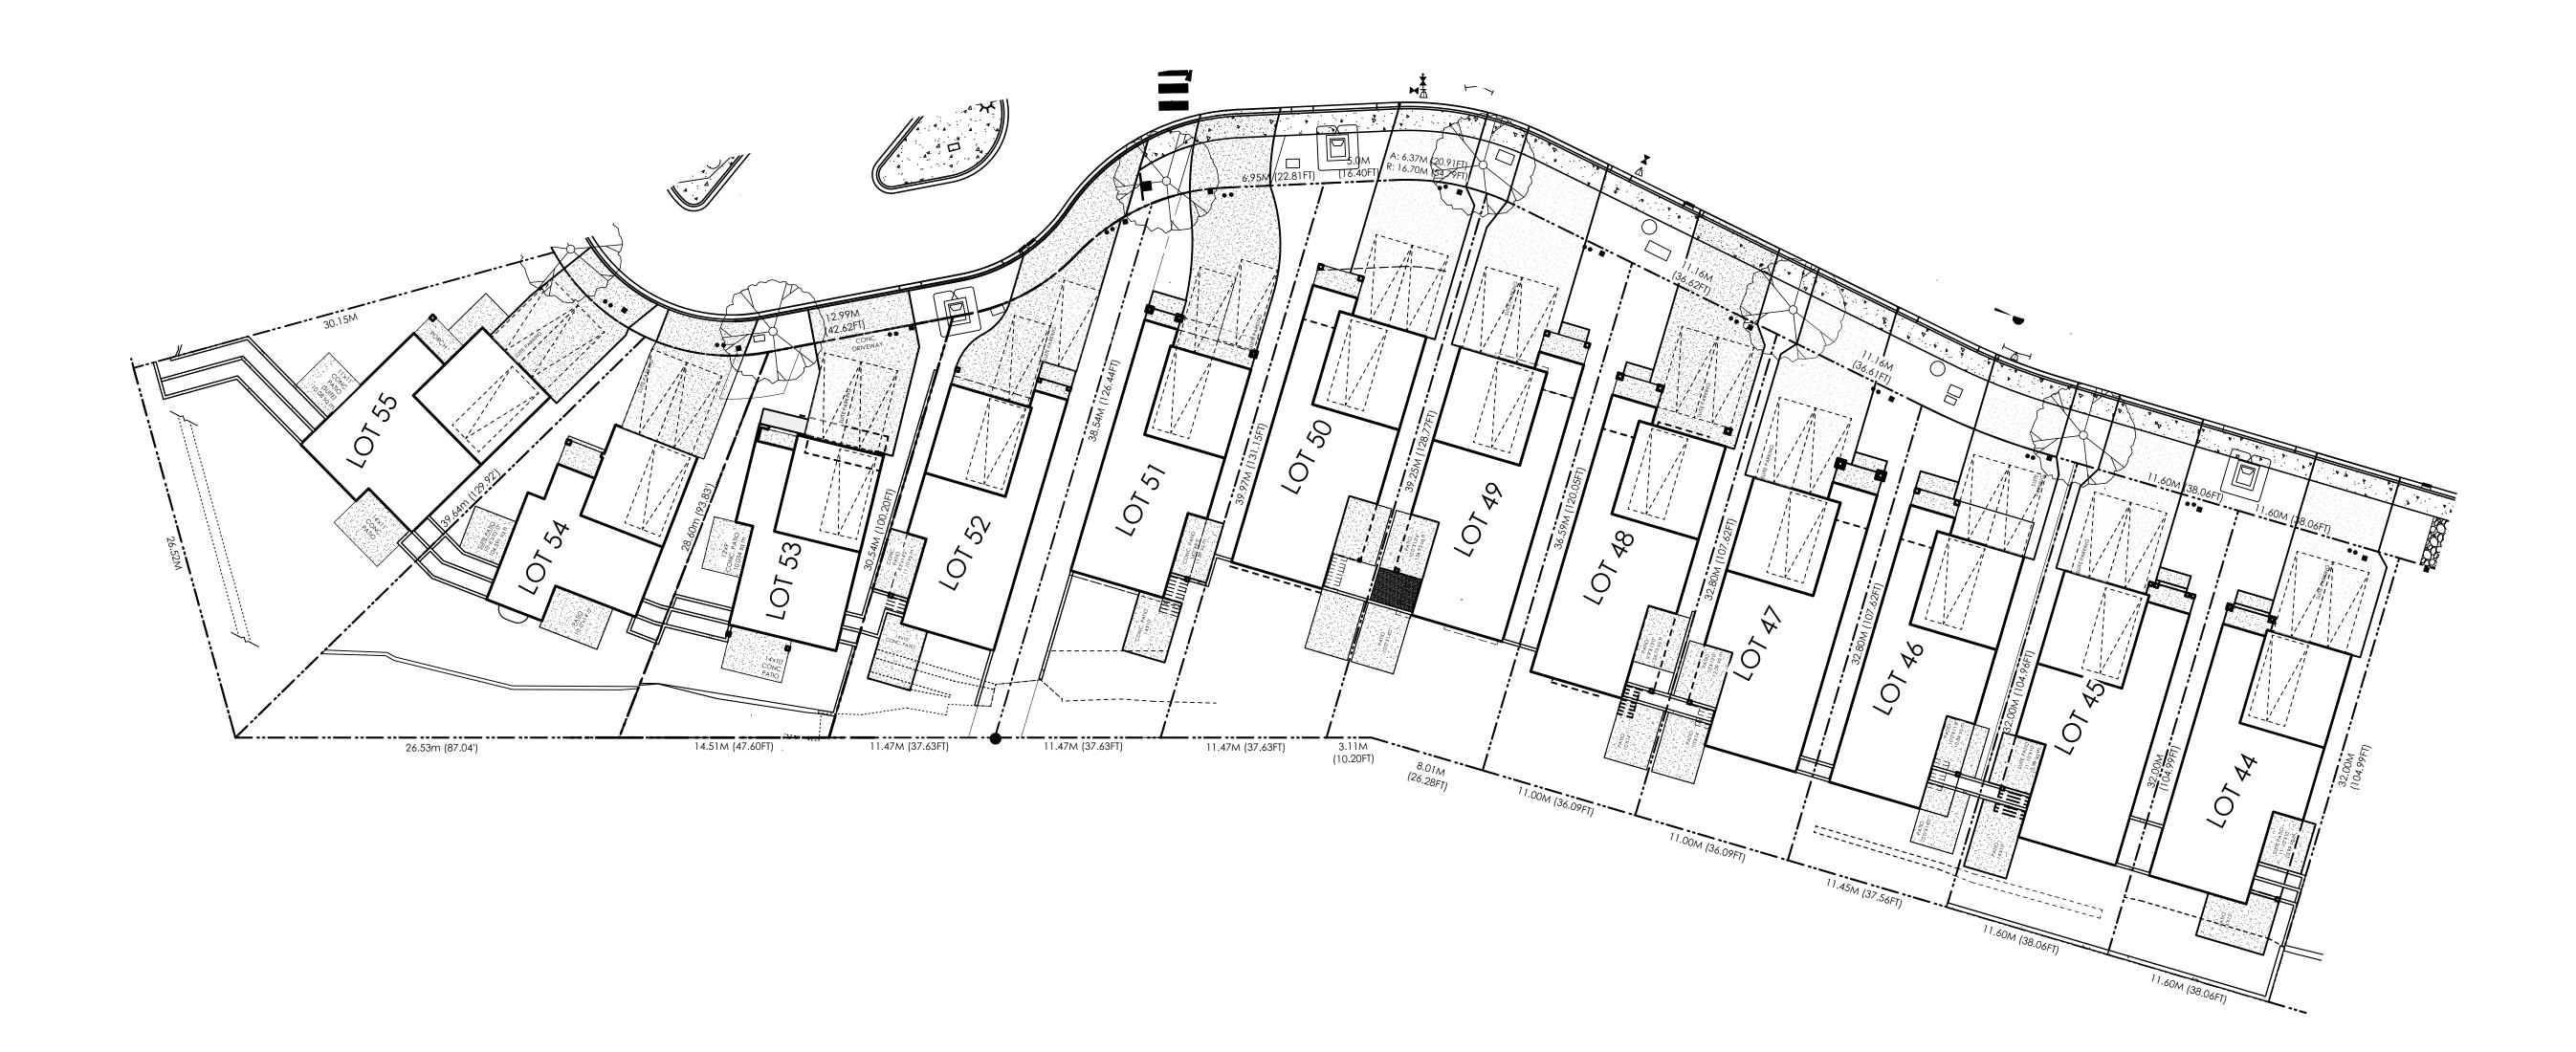

Comprehensive Site Plan



#103 - 891ATTREE AVENUE VICTORIA, B.C. V9B 0A6 P. 250.382.7374 F. 250.382.7364

> **Date** May 2, 2023


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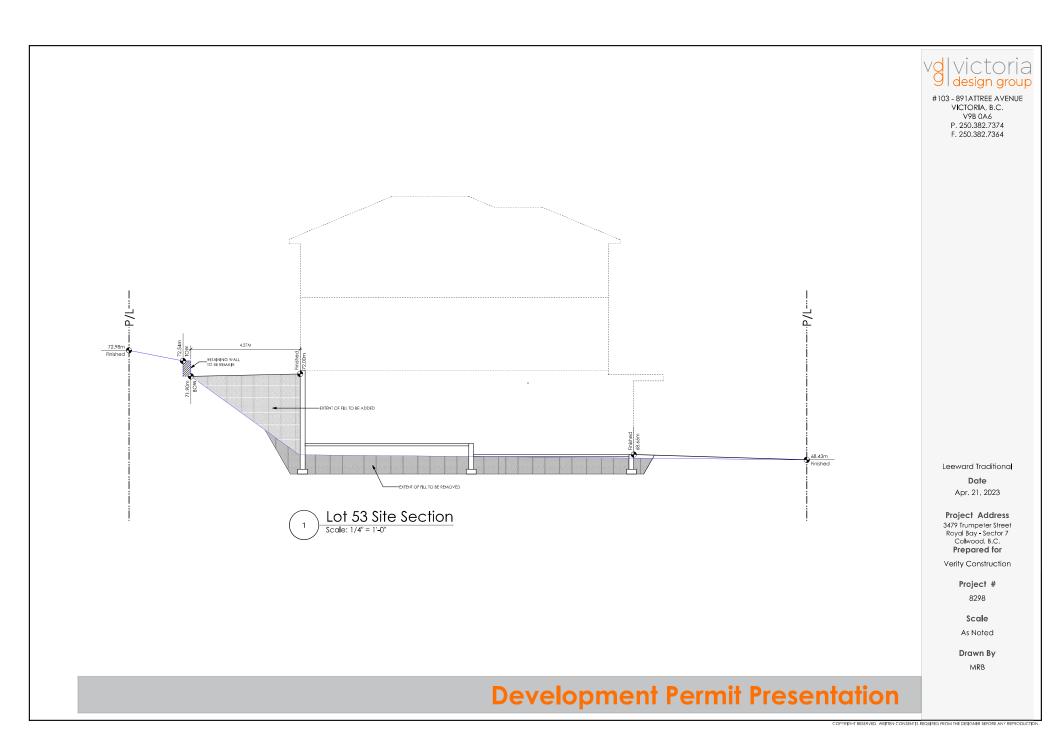
Prepared for Verity Construction


Project # 8298-Sector 7


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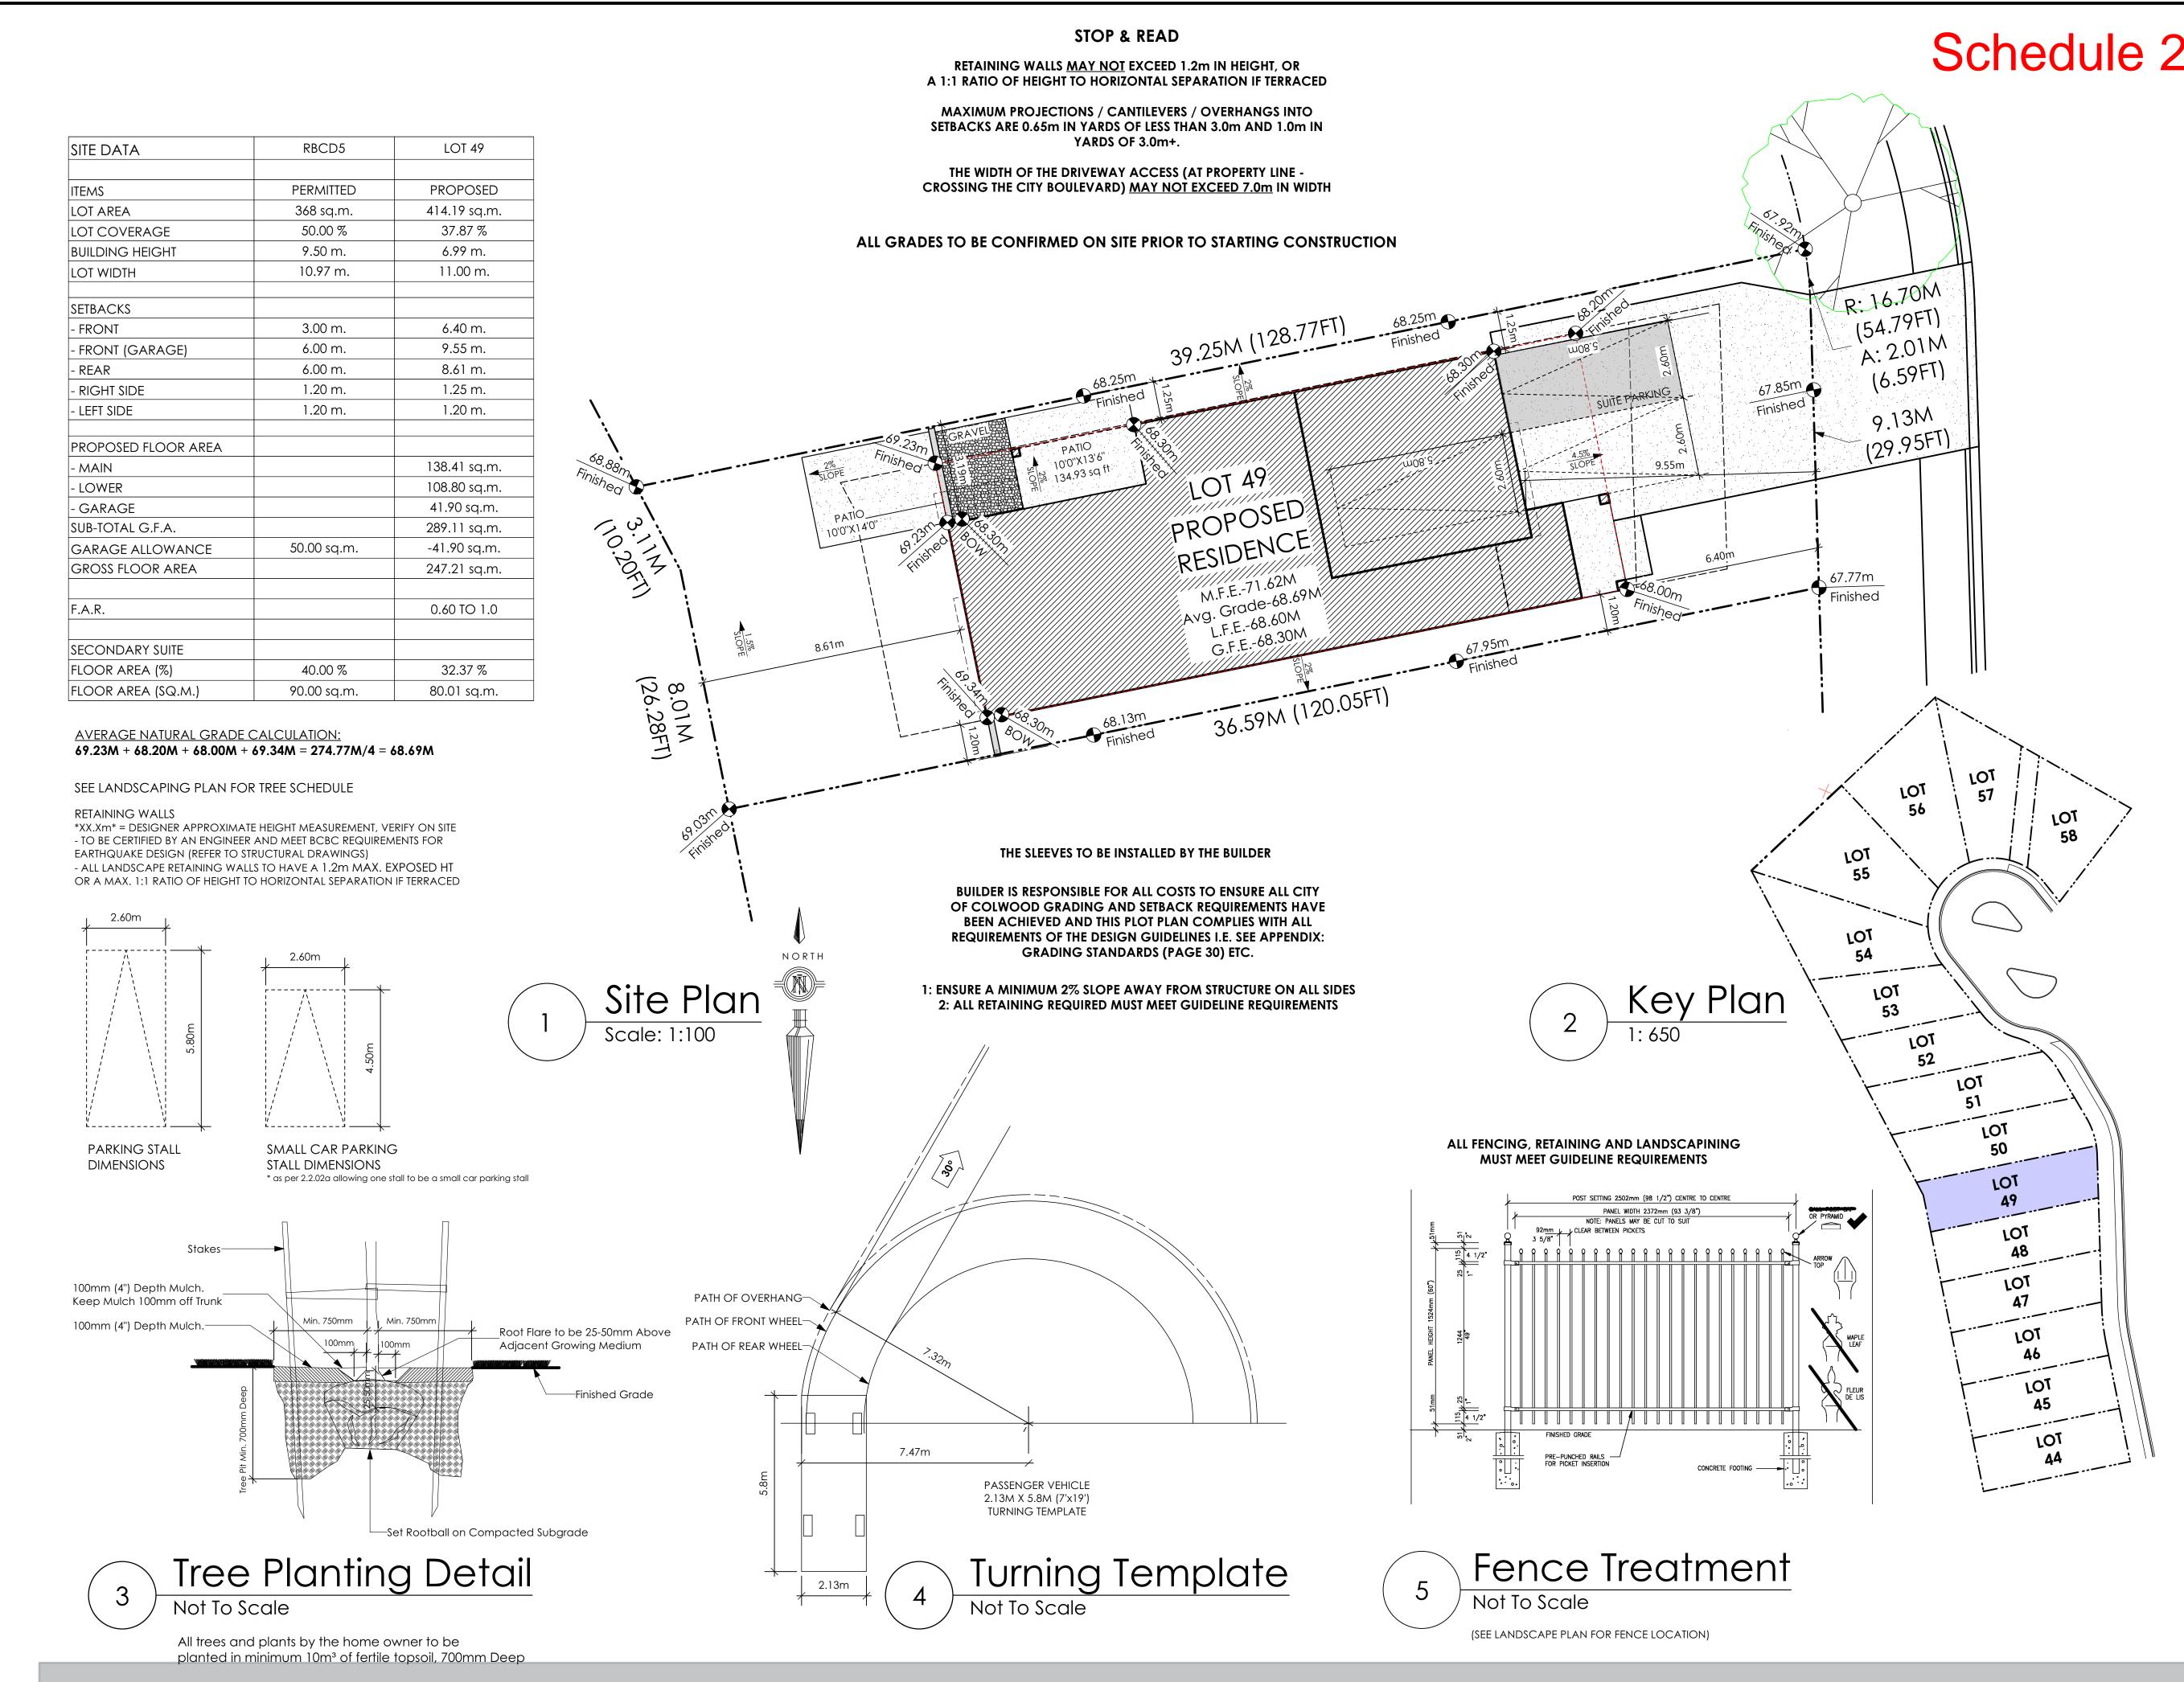
Drawn By MDK/MRB





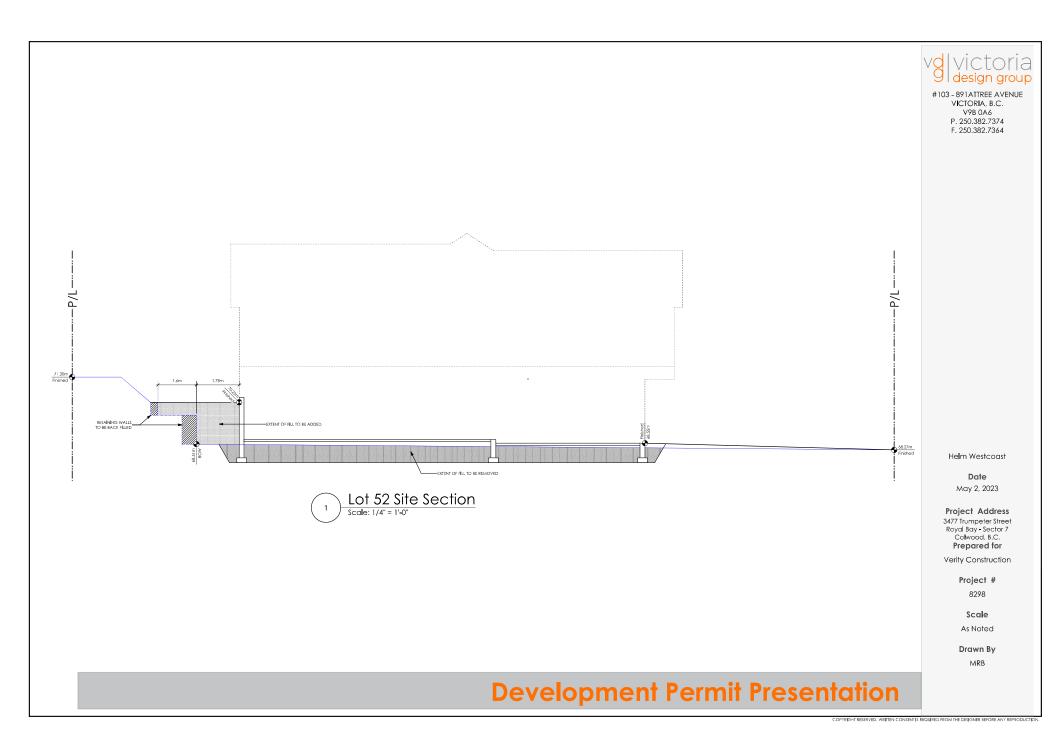

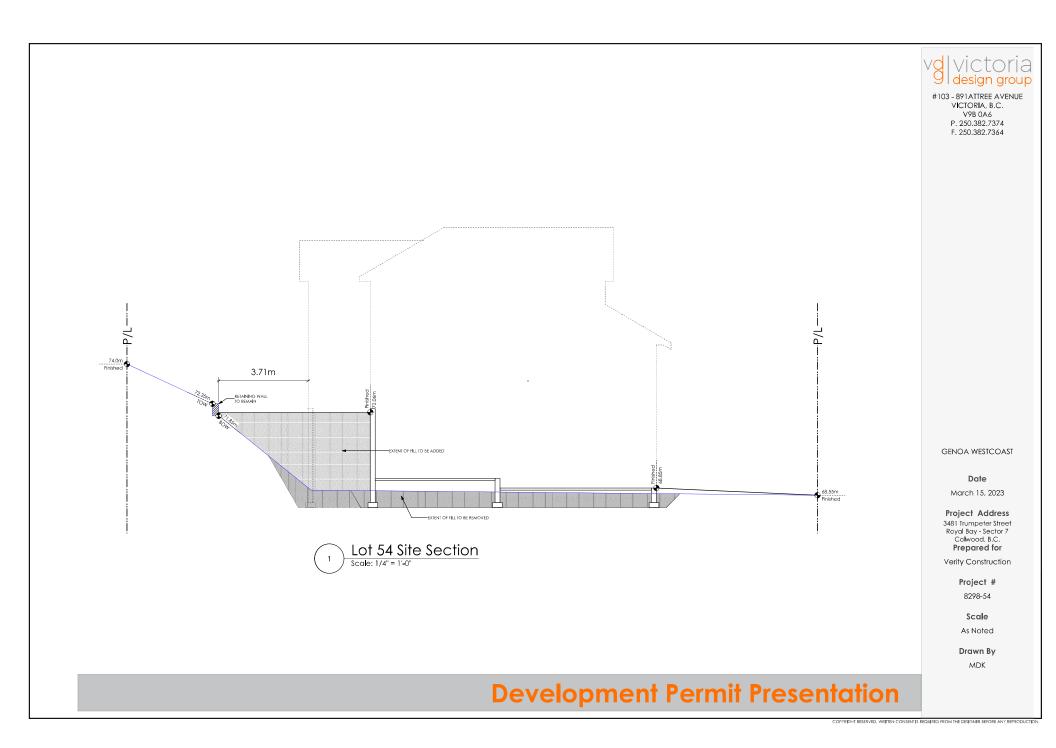

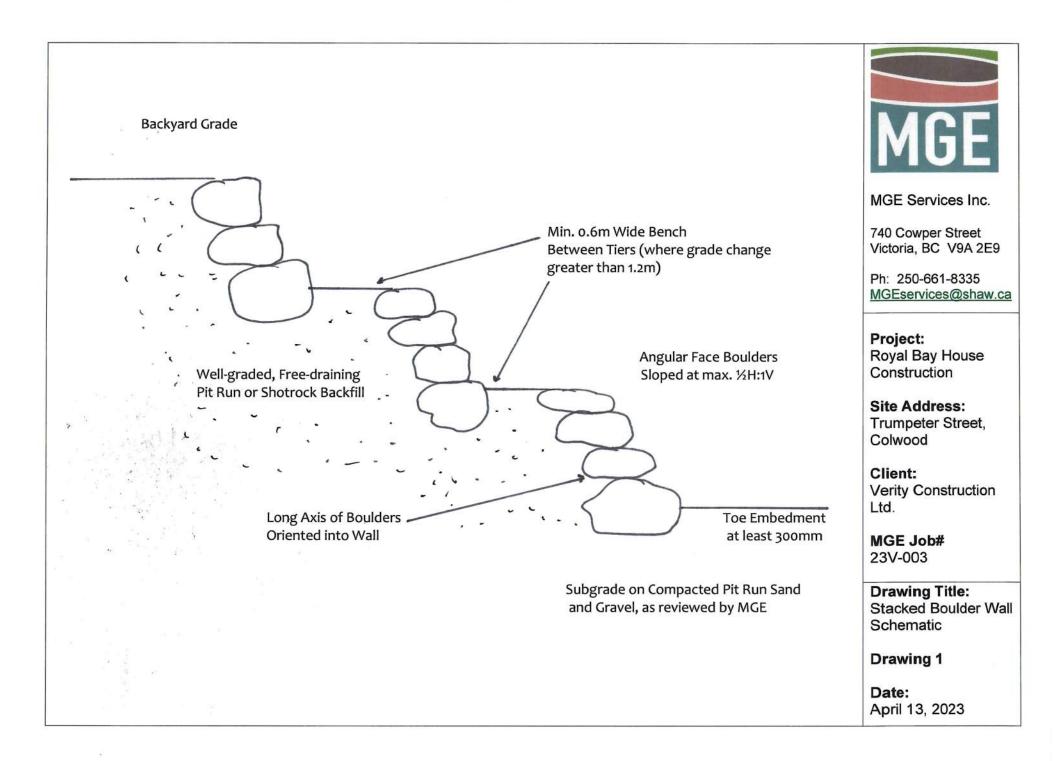

SITE DATA	RBCD5	LOT 49
ITEMS	PERMITTED	PROPOSED
LOT AREA	368 sq.m.	414.19 sq.m.
LOT COVERAGE	50.00 %	37.87 %
BUILDING HEIGHT	9.50 m.	6.99 m.
LOT WIDTH	10.97 m.	11.00 m.
Setbacks		
- FRONT	3.00 m.	6.40 m.
- FRONT (GARAGE)	6.00 m.	9.55 m.
- REAR	6.00 m.	8.61 m.
- RIGHT SIDE	1.20 m.	1.25 m.
- LEFT SIDE	1.20 m.	1.20 m.
PROPOSED FLOOR AREA		
- MAIN		138.41 sq.m.
- LOWER		108.80 sq.m.
- GARAGE		41.90 sq.m.
SUB-TOTAL G.F.A.		289.11 sq.m.
GARAGE ALLOWANCE	50.00 sq.m.	-41.90 sq.m.
GROSS FLOOR AREA		247.21 sq.m.
F.A.R.		0.60 TO 1.0
SECONDARY SUITE		
FLOOR AREA (%)	40.00 %	32.37 %
FLOOR AREA (SQ.M.)	90.00 sq.m.	80.01 sq.m.



Design Draft



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'PORT' - CRAFTSMAN

Date Dec 22 2022


Project Address 3471 Trumpeter Street Royal Bay - Sector 7 Colwood, B.C.

Prepared for Verity Construction

> Project # 8298

Scale As Noted

Drawn By MIS

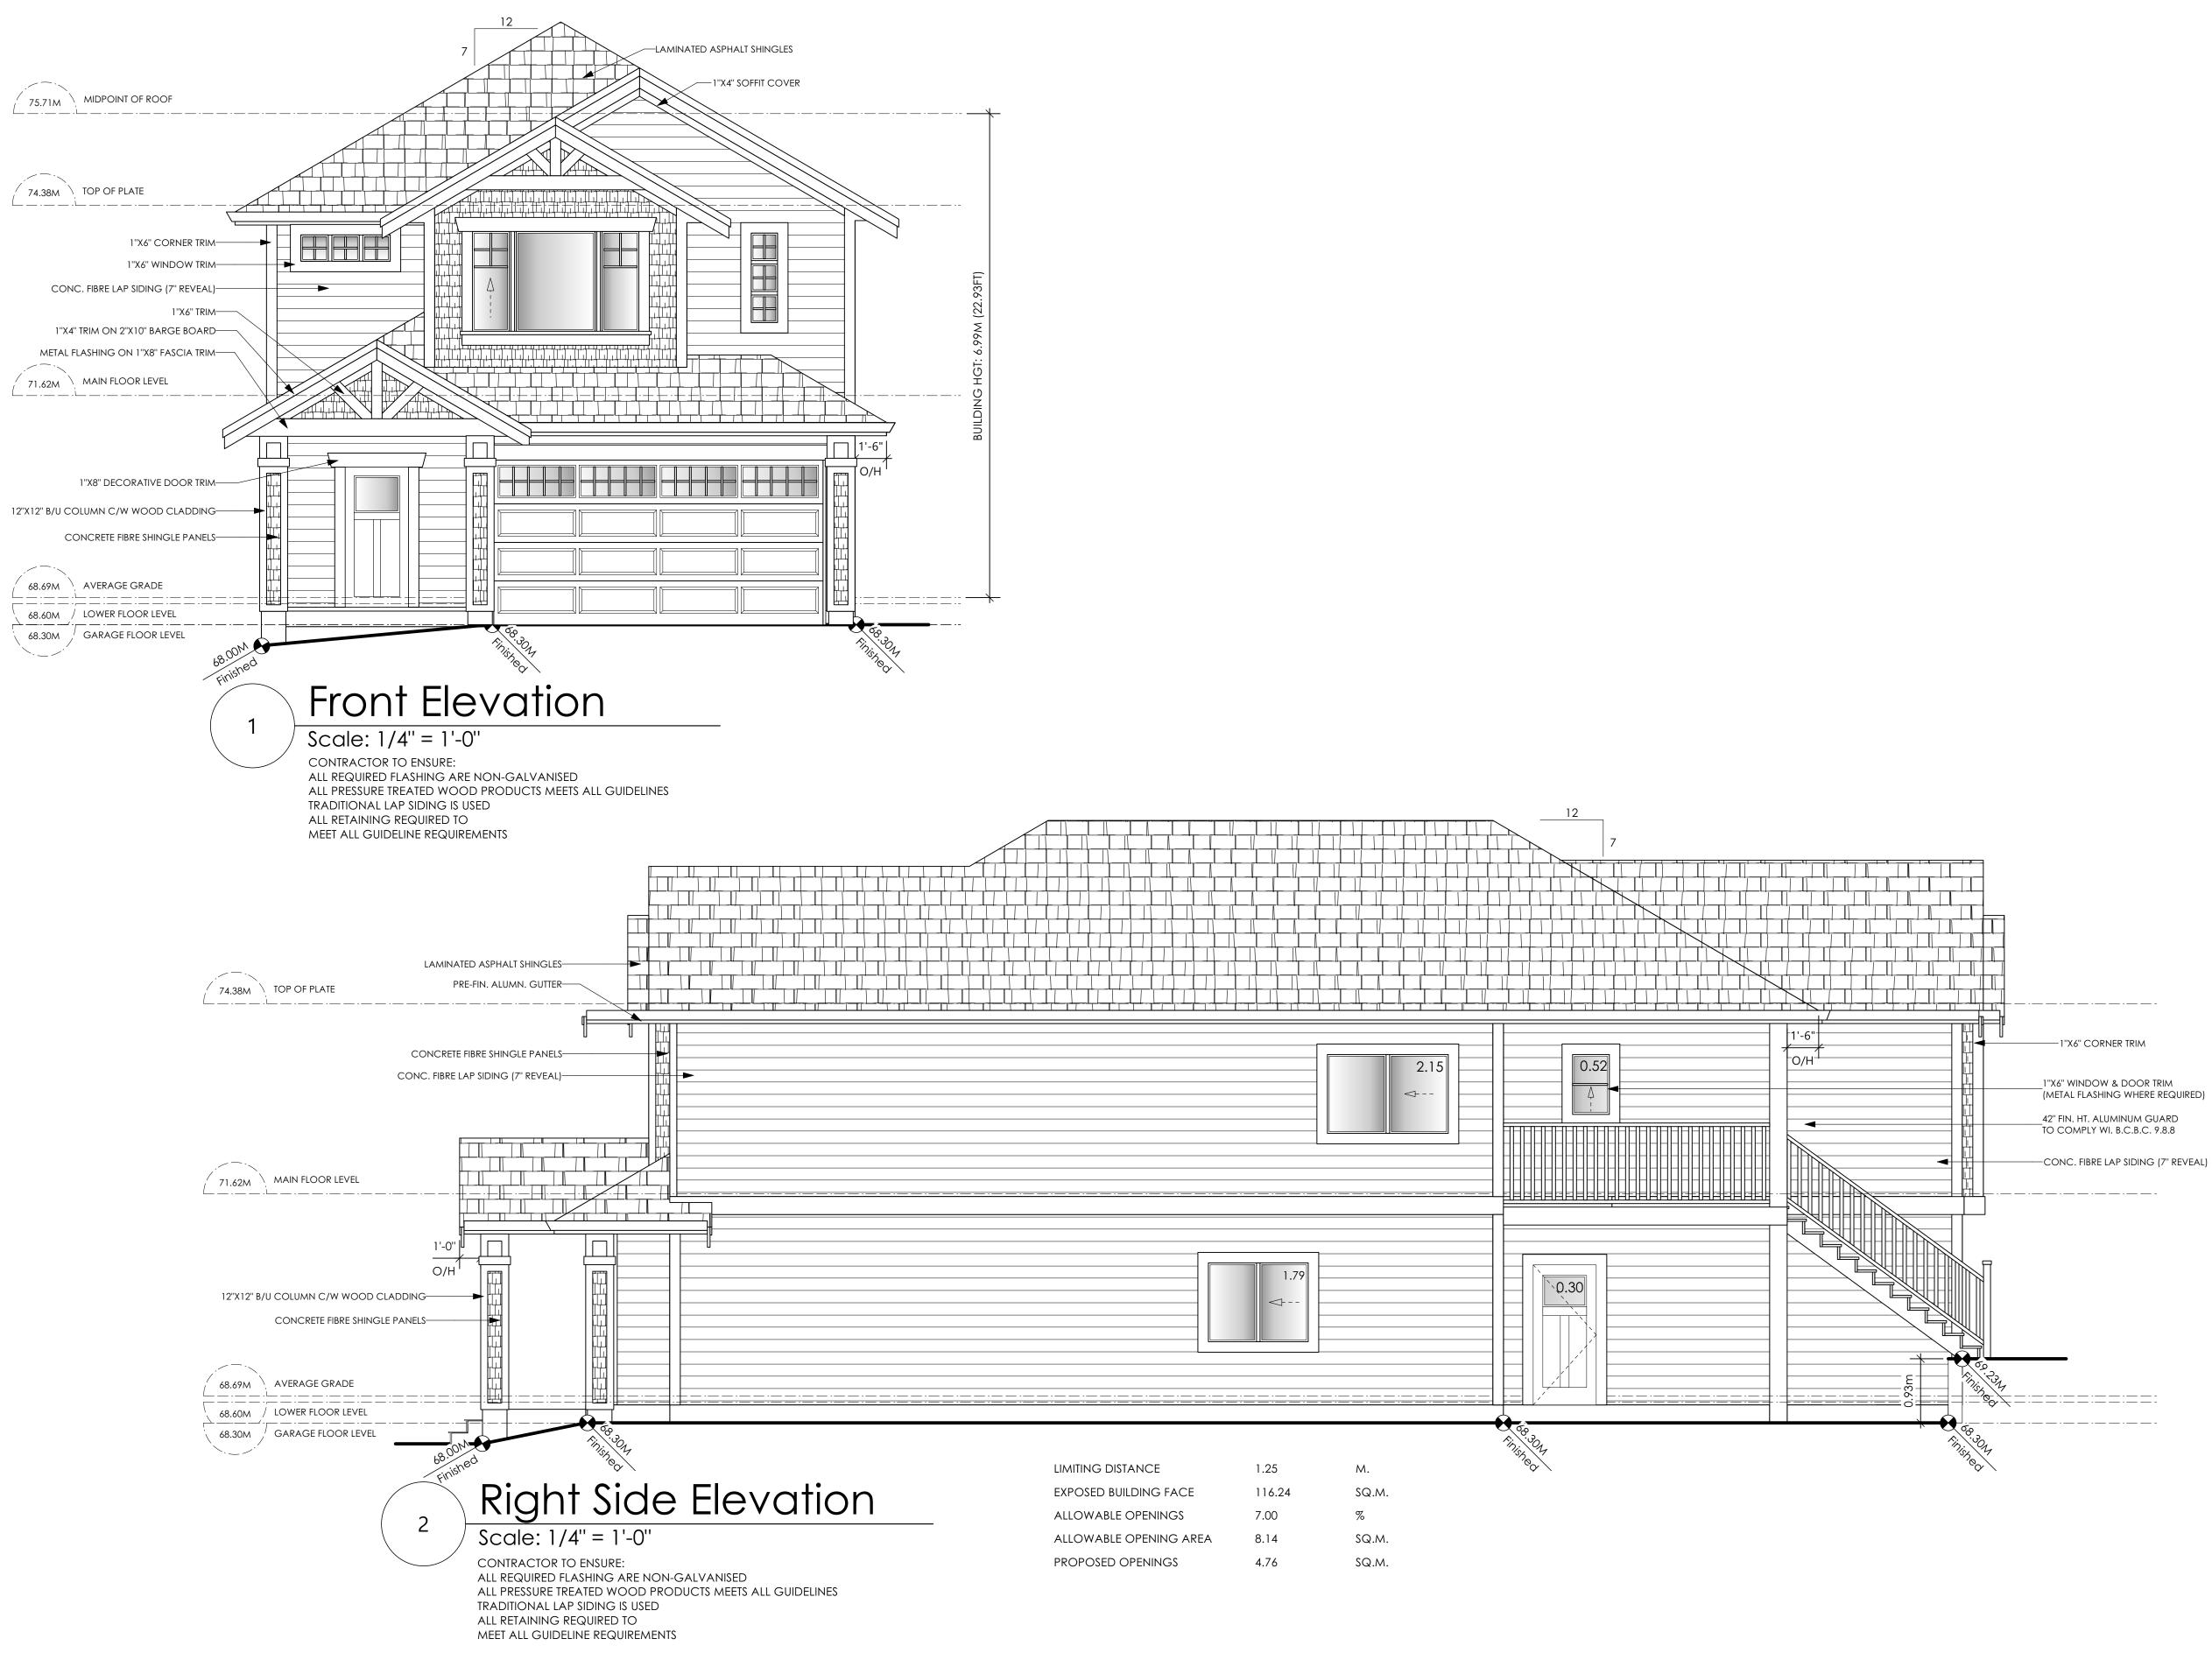



#103 - 891ATTREE AVENUE VICTORIA, B.C. V9B 0A6 P. 250.382.7374 F. 250.382.7364

'PORT' - CRAFTSMAN

Date Dec 22 2022

Project Address 3471 Trumpeter Street Royal Bay - Sector 7 Colwood, B.C.


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Design Draft



MITING DISTANCE	8.61	M.
(POSED BUILDING FACE	43.50	SQ.M.
LLOWABLE OPENINGS	100.00	%
LLOWABLE OPENING AREA	43.50	SQ.M.
ROPOSED OPENINGS	10.96	SQ.M.


	1.43	
0.88		

a	tion	

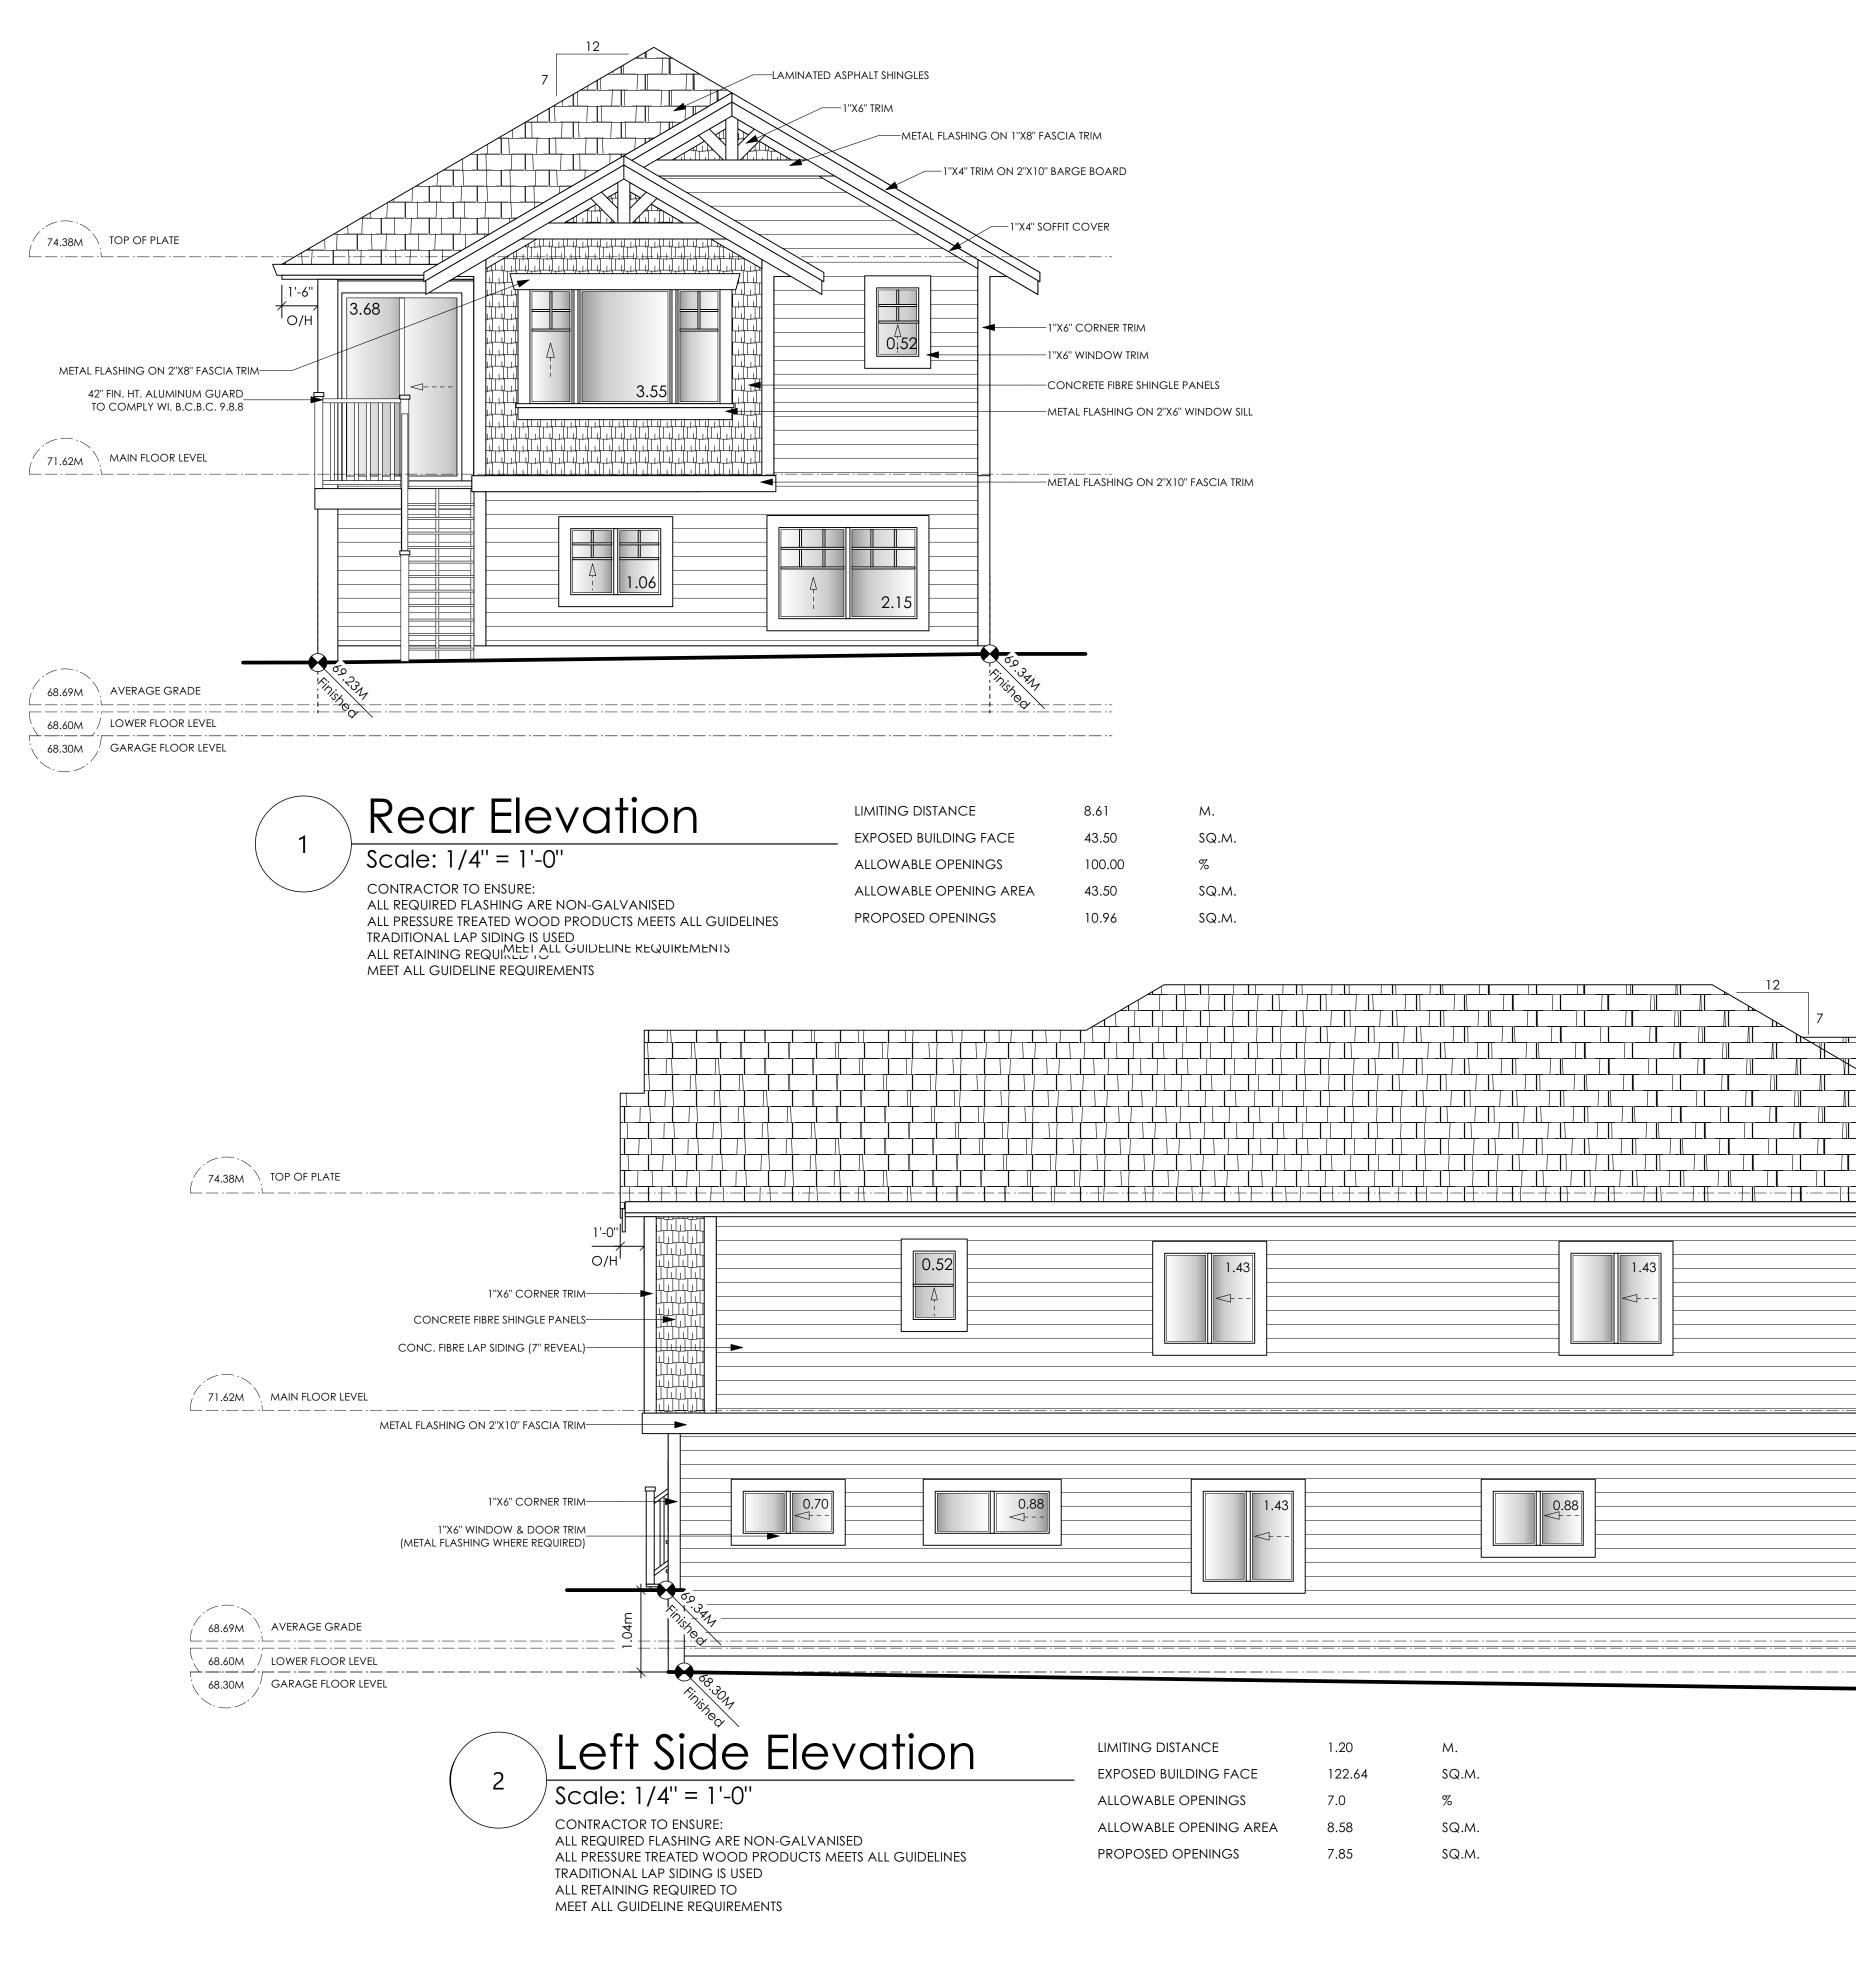LIMITING DISTANCE	1.20
 EXPOSED BUILDING FACE	122.64
ALLOWABLE OPENINGS	7.0
ALLOWABLE OPENING AREA	8.58
PROPOSED OPENINGS	7.85



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Design Draft
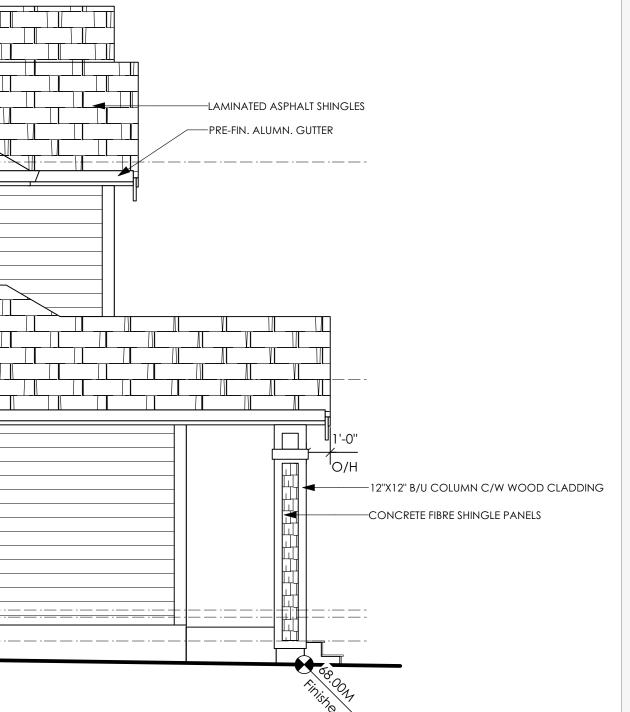
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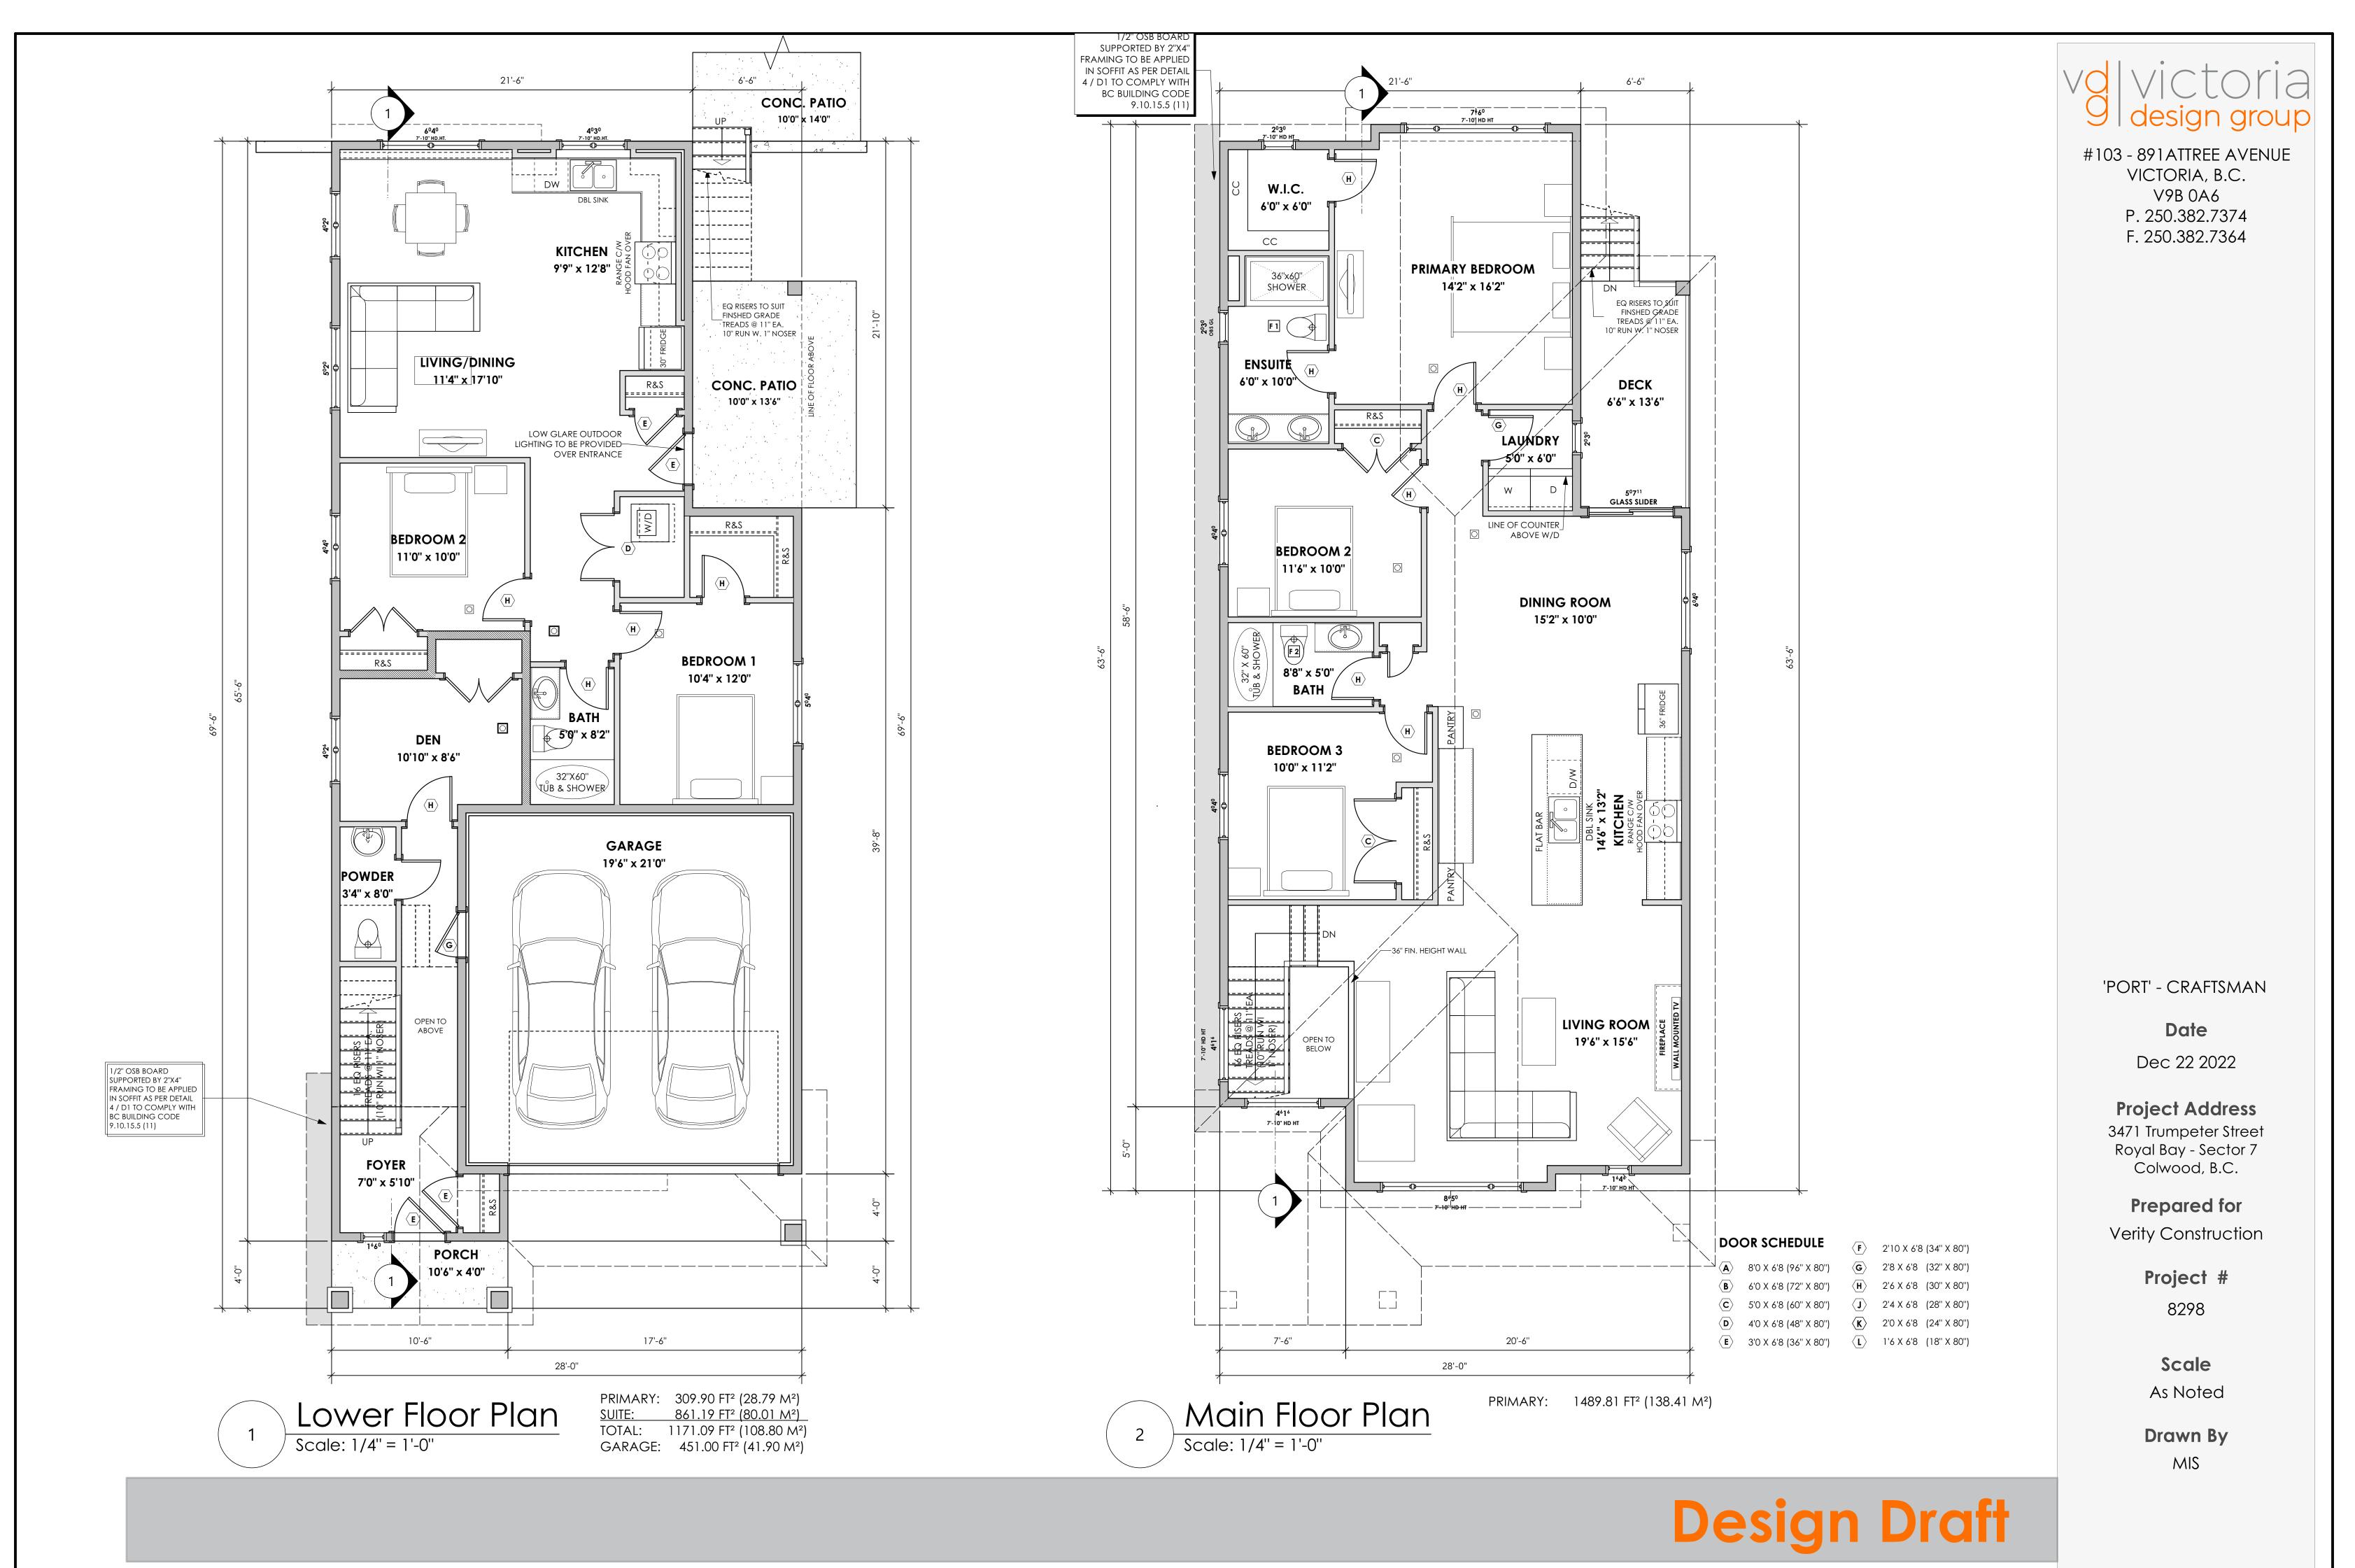
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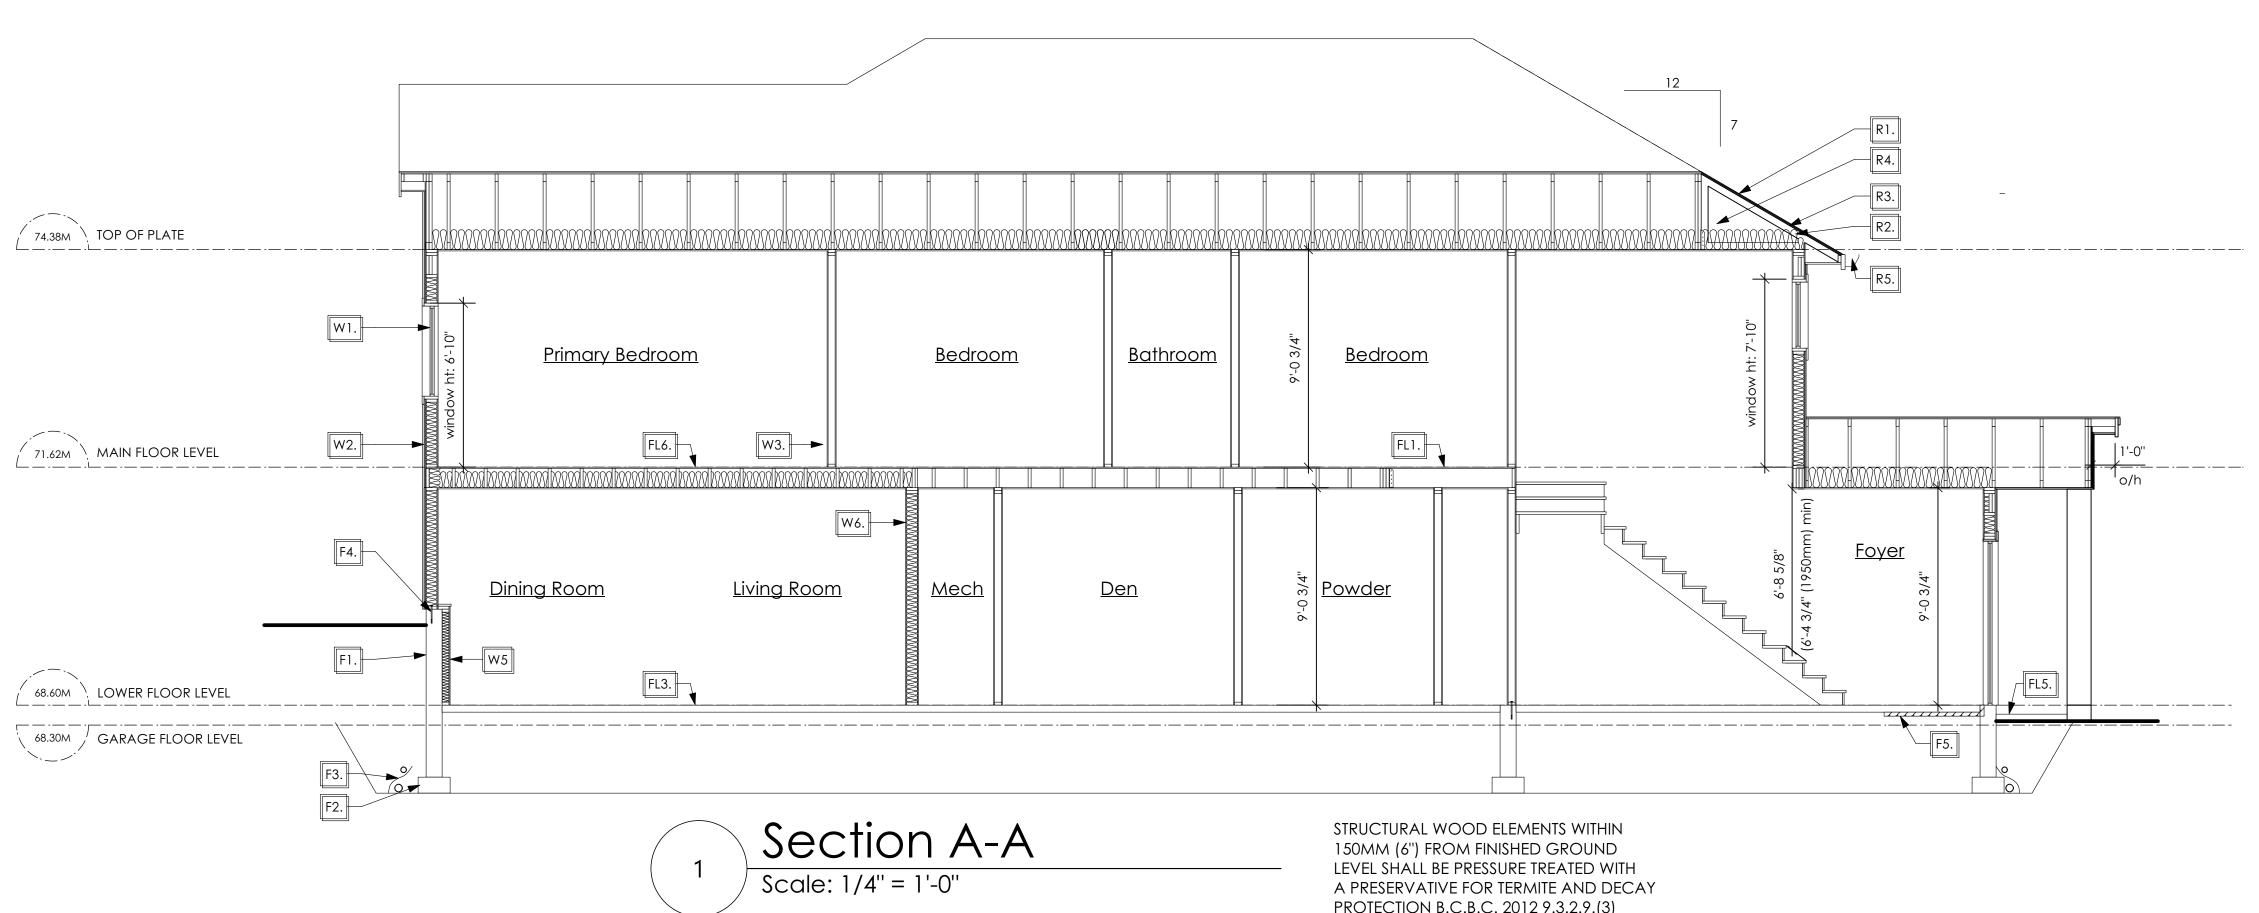
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Roofs

- R1. LAMINATED ASPHALT SHINGLES ON 7/16" ORIENTED STRAND BOARD C/W "H" CLIPS WD TRUSSES (DESIGNED BY MANUF.) 14 1/2" FIBRE GLASS LOOSE FILL INSULATION (ALLOW FOR SETTLING) OR R-40 FIBRE GLASS BATT INSULATION 6 MIL POLY'N V.B. 5/8" GYPSUM BOARD
- R2. PROVIDE 2 1/2" (63mm) CLEAR BETWEEN R-20 INSULATION AND SHEATHING. (min. R-20 @ roof-wall connection for 4'-0" (1.2m) around perimeter of building. air ventelation baffles to be installed where required in as per BCBC 9.19.)
- R3. EAVE PROTECTION CONT. UP ROOF SLOPE FOR 12" PAST EXTERIOR WALL.
- R4. PROVIDE 1 SQ.FT. ATTIC VENT PER 300 SQ.FT. OF INSULATED AREA MIN. 25% OF REQUIREDTO BE @ TOP AND BOTTOM (to comply wi. B.C. bldg. code 9.19.1)
- R5. PRE-FN. FASCIA GUTTER 2×8 FASCIA BD. 2×4 SUB. FASCIA BD. VENTED SOFFIT (see contractor)

PRE MANUF SOFFIT 1/2" OSB BOARD SUPPORTED BY 2"X4" FRAMING REFER TO DETAIL 4 / D1 (to be applied in any soffit that has less then 1.20m clearance to any proverty line. To comply with BC BUILDING CODE 9.10.15.5 (11)) (AS REQUIRED, VERIFY ON SITE) (NOT SHOWN IN SECTION)

R6.

SECTION NOTES

PROTECTION B.C.B.C. 2012 9.3.2.9.(3)

Floors

- FL1. FINISHED FLOORING ON 19/32" ORIENTED STRAND BOARD OR EQUAL (NAILED & GLUED TO FLOOR STRUCT. BELOW) ON 2×10 FLOOR JOISTS @ 16" OR 12" O/C C/W 2×2 X-BRIDGING @ 7.0' O/C (MAX) 1/2" GYPSUM BOARD
- FL2. FINISHED FLOORING ON 19/32" ORIENTED STRAND BOARD OR EQUAL (NAILED & GLUED TO FLOOR STRUCT. BELOW) ON 2×10 FLOOR JOISTS @ 16" OR 12" O/C C/W 2×2 X-BRIDGING @ 7.0' O/C (MAX) R-31 FIBRE GLASS BATT INSULATION 5/8" X-TYPE GYPSUM BOARD (BETWEEN GARAGE AND LIVING SPACE) (NOT SHOWN IN SECTION)
- FL3. 3 1/2" CONCRETE SLAB 6 MIL. POLY'N V.B. 6" COMPACTED GRAVEL OR SAND
- FL4. 3 1/2" CONCRETE SLAB 6 MIL. POLY'N V.B. 6" COMPACTED GRAVEL OR SAND SLOPE TO DOORS 1" (NOT SHOWN IN SECTION)
- FL5. 3 1/2" CONCRETE SLAB (CONTRACTOR TO VERIFY EXTENT OF EXTERIOR SLABS AND FINISHES) (SLOPE AWAY FROM BUILDING @ 2% MIN.) 6" COMPACTED GRAVEL OR SAND
- FL6. F8d RATED CEILING ASSEMBLY (BC BUILDING CODE TABLE 9.10.3.1.B) FINISHED FLOORING ON 19/32" ORIENTED STRAND BOARD OR EQ. (FASTENED & GLUED TO FLOOR STRUCT. BELOW) ON 2×10 FLOOR JOISTS @ 16" OR 12" O/C C/W 2×2 X-BRIDGING @ 7.0' O/C (MAX) **R-31 INSULATION** RESILIENT METAL CHANNELS @ 24" O/C
- 1 LAYERS 5/8" X-TYPE GYPSUM BOARD 30 MINUTE F.R.R., 50 S.T.C.

Walls

- W1. DOUBLE GLAZING ENERGY STAR LOW "E" RATING IN THERMAL BREAK FRAMES 2/2"X10" LINTEL OVER (@ BEARING WALLS ONLY) (TYPICAL, WI. 2 1/2" XPS INSULATION) FLASHING OVER @ EXTERIOR (GLAZING IN ALL EXTERIOR DOORS & WITHIN 3 FT. OF EXTERIOR DOORS TO BE SHATTERPROOF (SP)) WINDOW REQUIREMENTS DERIVED FROM BCBC TABLE C-5 AS PER BCBC 9.7.4.3. AND ARE TO BE USED TO SATISFY THE REQUIREMENTS OF AAMA/WDMA/CSA 101/I.S.2/A440, "NAFS": COLWOOD, CLASS R, DP 1440, PG 30, WATER RESIST. 220, A2, RATINGS MUST BE CLEARLY LABELED ON ALL WINDOW UNITS UPON INSTALLATION FOR INSPECTION.
- W2. CONC. FIBRE BOARD ON 9.5MM (3/8") AIR SPACE / STRAPPING 3/8"×2" BORATE TREATED PLYWOOD STRAPPING HOUSE WRAP (A.B.) (TYVEK OR EQ.) 7/16" ORIENTED STRAND BOARD SHEATHING 2×6 STUDS (SEE APCING BELOW) **R-20 INSULATION** 6 MIL. POLYETHYLENE VAPOUR BARRIER 1/2" GYPSUM BOARD (REFER TO DETAILS ON D1)
- W3. INTERIOR PARTITION 1/2" GYPSUM BOARD ON EACH SIDE OF 2×4 STUDS (SEE SPACING BELOW) OR 2×6 STUDS (SEE SPACING BELOW) (IF NOTED)

- W4. 5/8" X-TYPE GYPSUM BOARD ON 2×6 STUDS (SEE SPACING BELOW) **R-20 INSULATION** 6 MIL. POLY'N V.B 1/2" GYPSUM BOARD (BETWEEN GARAGE & LIVING) (NOT SHOWN IN SECTION)
- W5. 1/2" GYPSUM BOARD ON 6 MIL. POLY'N V.B. 2×4 STUDS (SEE SPACING BELOW) OR 2x6 STUDS (SEE SPACING BELOW) (IF NOTED) **R-12 BATT INSULATION** HOUSE WRAP (A.B.) (TYVEK OR EQ.) OR 12.7MM (1/2") AIR SPACE (PROVIDE REQUIRED FIRE STOPS IN WALL ASSEMBLIES TO COMPLY WITH B.C. BLDG. CODE 9.10.16.)
- W6. B.C. BUILDING CODE (TABLE 9.10.3.1.A) RATED WALL ASSEMBLY W3c 1 LAYER 1/2" X-TYPE GYPSUM BOARD RESILIENT METAL CHANNELS @ 24" O/C 2×4 STUDS @ 16'' O/C OR 2×6 STUDS @ 16" O/C (IF NOTED) C/W 3 1/2" FIBRE GLASS SOUND BATTS 1 LAYER 1/2" X-TYPE GYPSUM BOARD 45 MIN. F.R.R 43 S.T.C (BETWEEM PRIMARY LIVING & SECONDARY SUITE)

W7.	STUD SPACING - UPPER FLOOR: - MAIN FLOOR: - LOWER FLOOR: (if applicable)	2"X6" @ 24" O/C 2"X6" @ 24" O/C 2"X6" @ 16" O/C
	- INTERIOR PARTITION: - LOAD BEARING: - PARTY WALL (if applicable)	2"X4"" @ 24" O/C 2"X4"" @ 16" O/C 2"X4"" @ 24" O/C

Foundation Walls

- F1. DAMPROOFING (where required) ON 8" THK. CONC. FOUNDATION WALL C/W 15 M BARS @ 24" o/c B/W
- F2. 16"X 8" CONC. FOOTINGS C/W 2 (TWO) 15m BARS CONT. 3 IN. FROM BOTT. ON UNDISTURBED SOIL (SOLID BEARING)
- F3. 4" PERIMETER DRAIN 3" TIGHT PIPE FOR RWL DRAIN ROCK
- F4. ANCHOR BOLTS @ 4.0 FT. o/c MAX c/w SILL GASKETS
- UNDER SLAB INSULATION F5. 2 1/2" (RSI 2.15) EXTRUDED POLYSTYRENE RIGID INSULATION 4'-0" (1.2M) CONT. AROUND PERIMETER UNDER SLAB INSTALLED HORIZONTALLY (VERIFY WITH MUNICIPALITY DEPTH OF FROST LINE)

'PORT' - CRAFTSMAN

91

l design group

#103 - 891ATTREE AVENUE

VICTORIA, B.C.

V9B 0A6

P. 250.382.7374

F. 250.382.7364

Date Dec 22 2022

Project Address 3471 Trumpeter Street Royal Bay - Sector 7 Colwood, B.C.

Prepared for Verity Construction


> Project # 8298

Scale As Noted

Drawn By MIS

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Design Draft

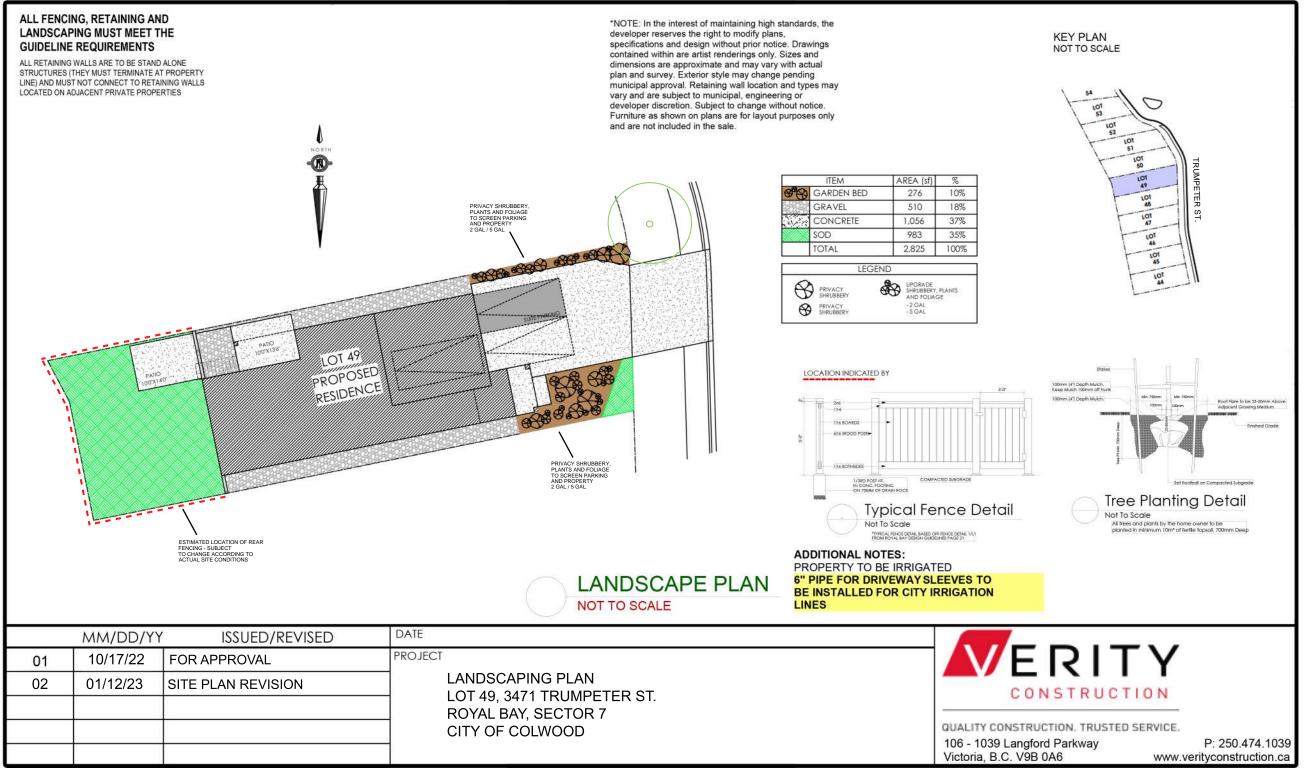


GABLECRAFT HOMES BUILDING GRADE SLIP


WSP Project No: <u>201-08151-00</u>


Issue Date: _____

ADDRESS 3471 Trumpeter Street	P.I.D.
LOT	PLAN
BUILDER VERITY HOMES	SUBDIVISION
ADDRESS	ROYAL BAY SECTOR 7 DEVELOPER
REPRESENTATIVE PH.	MEADOWS DEVELOPMENT LP CONSULTANT
	WSP CANADA INC
PROPOSED BUILDING GRADES ALL ELEVATIONS ARE METRIC GEODETIC +	
(TOP OF JOISTS) FRONT ELEV. 68.00 (FINISHED GRADE) (FINISHED GRADE)	TRUMPETER ST.
(FINISHED GRADE) (FINISHED GRADE)	
HEADROOM	- -
	01.99
ACTUAL TOP OF FOOTING	
LOWEST PERMITTED TOP OF FLOOR SLAB	EG 67.8 MFE 68.47 GFE 68.27
(BOTTOM OF BASEMENT ŚLAB FROST WALLS ARE REQUIRED.)	B 15 65.03 MSE 65.03 64.53 D 64.69 60 M LB 16
SERVICES FRONT REAR CENTER REFER SIZE	83.28 × 23.28
TO PLAN (mm) WATER	0 0 0 0 0
SANITARY SANITARY	
STORM	
	E.3
COMMENTS YES NO	~~~~~
DRAIN TO SUMP PUMP LIKELY REQUIRED (FOR BASEMENT IF INSTALLED)	LEGEND
SEWER TO SUMP PUMP LIKELY REQUIRED (FOR BASEMENT IF INSTALLED)	STREET
SERVICES INSTALLED TO m INSIDE PROPERTY	SAN. STHL NAT.
FOUNDATION SOIL BEARING INVESTIGATION	III - SERVICE LOCATION (m) SROW (m) - SERVICE LOCATION (SHOWN ON ABOVE PLAN)
GEOTECHNICAL RESTRICTIONS APPLY	- PROPOSED FRONT CORNER ELEVATIONS
(SEE GEOTECHNICAL REPORT)	LEGAL LOT NUMBER
(SEE ENVIRONMENTAL REPORT)	
UTILITY EASEMENTS AFFECT THIS LOT	GFE 47.55 - GARAGE FLOOR ELEVATION
	MSE 52.20 - MINIMUM SANITARY SERVICABLE ELEVATION BY GRAVITY
	S 49.12 (P) D 49.12 (P) - SAN SERVICE INV. (P) DENOTES PUMP IS LIKELY REQUIRED
	FOR BASEMENT IF INSTALLED
	(P) DENOTES PUMP IS LIKELY REQUIRED FOR BASEMENT IF INSTALLED - PROPOSED REAR SIDE YARD GRADES
NOTES	– LOT TYPE (L/LB/LBT) – PROPOSED REAR CORNER ELEVATIONS
 IT IS THE RESPONSIBILITY OF THE BUILDER TO ENSURE THE FOOTINGS ARE PLACED ON A PROPER BASE THAT IS FREE FROM FROST, EXCESSIVE MOISTURE AND DELETERIOUS MATERIALS AND HAVE APPROPRIATE FROST PROTECTION WHEN COMPLETED. 	LANE/LOT
 THE INFORMATION CONTAINED HEREIN IS BASED ON THE APPROVED LOT GRADING PLAN FOR THIS SUBDIVISION. UN-AUTHORIZED DEVIATIONS WILL BE THE RESPONSIBILITY OF THE BUILDER TO ENSURE COMPLIANCE WITH ALL LOCAL BYLAWS. 	I, THE BUILDER'S REPRESENTATIVE,
3. OTHER NOTES:	CERTIFY THAT THE FINAL HOUSE PLANS PROVIDED IN THE BUILDING PERMIT APPLICATION ARE THE SAME AS PROCESSED UNDER THIS GRADE SLIP AND THAT I UNDERSTAND THE INFORMATION AND THE REQUIREMENTS CONTAINED HEREIN AND WILL BUILD ACCORDINCLY
	HEREIN AND WILL BUILD ACCORDINGLY.
	AUTHORIZED BUILDER'S REPRESENTATIVE DATE
	THE INFORMATION CONTAINED HEREIN IS BASED ON THE APPROVED LOT GRADING PLAN FOR THIS SUBDIVISION, DATED
	C. Hume - Nov. 10/22
WSP - May 13, 2022 8:05 AM D:\2021\211-00627-00_ROYAL BAY - SECTOR 7\3_TECH\3_CADD\3_SHEETS\211-00627-00-E	ISSUED BY DEVELOPER'S AUTHORIZED REPRESENTATIVE DATE


SITE DATA	RBCD5	LOT 50
ITEMS	PERMITTED	PROPOSED
LOT AREA	368 sq.m.	440.03 sq.m.
LOT COVERAGE	50.00 %	35.64 %
BUILDING HEIGHT	9.50 m.	6.91 m.
LOT WIDTH	10.97 m.	11.16 m.
Setbacks		
- FRONT	3.00 m.	5.56 m.
- FRONT (GARAGE)	6.00 m.	9.73 m.
- REAR	6.00 m.	10.00 m.
- RIGHT SIDE	1.20 m.	1.27 m.
- LEFT SIDE	1.20 m.	1.20 m.
PROPOSED FLOOR AREA		
- MAIN		128.21 sq.m.
- LOWER		108.80 sq.m.
- GARAGE		41.90 sq.m.
SUB-TOTAL G.F.A.		278.91 sq.m.
GARAGE ALLOWANCE	50.00 sq.m.	-41.90 sq.m.
GROSS FLOOR AREA		237.01 sq.m.
F.A.R.		0.54 TO 1.0
SECONDARY SUITE		
FLOOR AREA (%)	40.00 %	33.76 %
FLOOR AREA (SQ.M.)	90.00 sq.m.	80.01 sq.m.

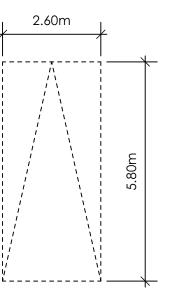

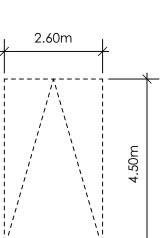

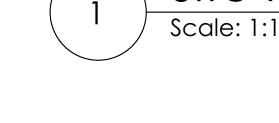



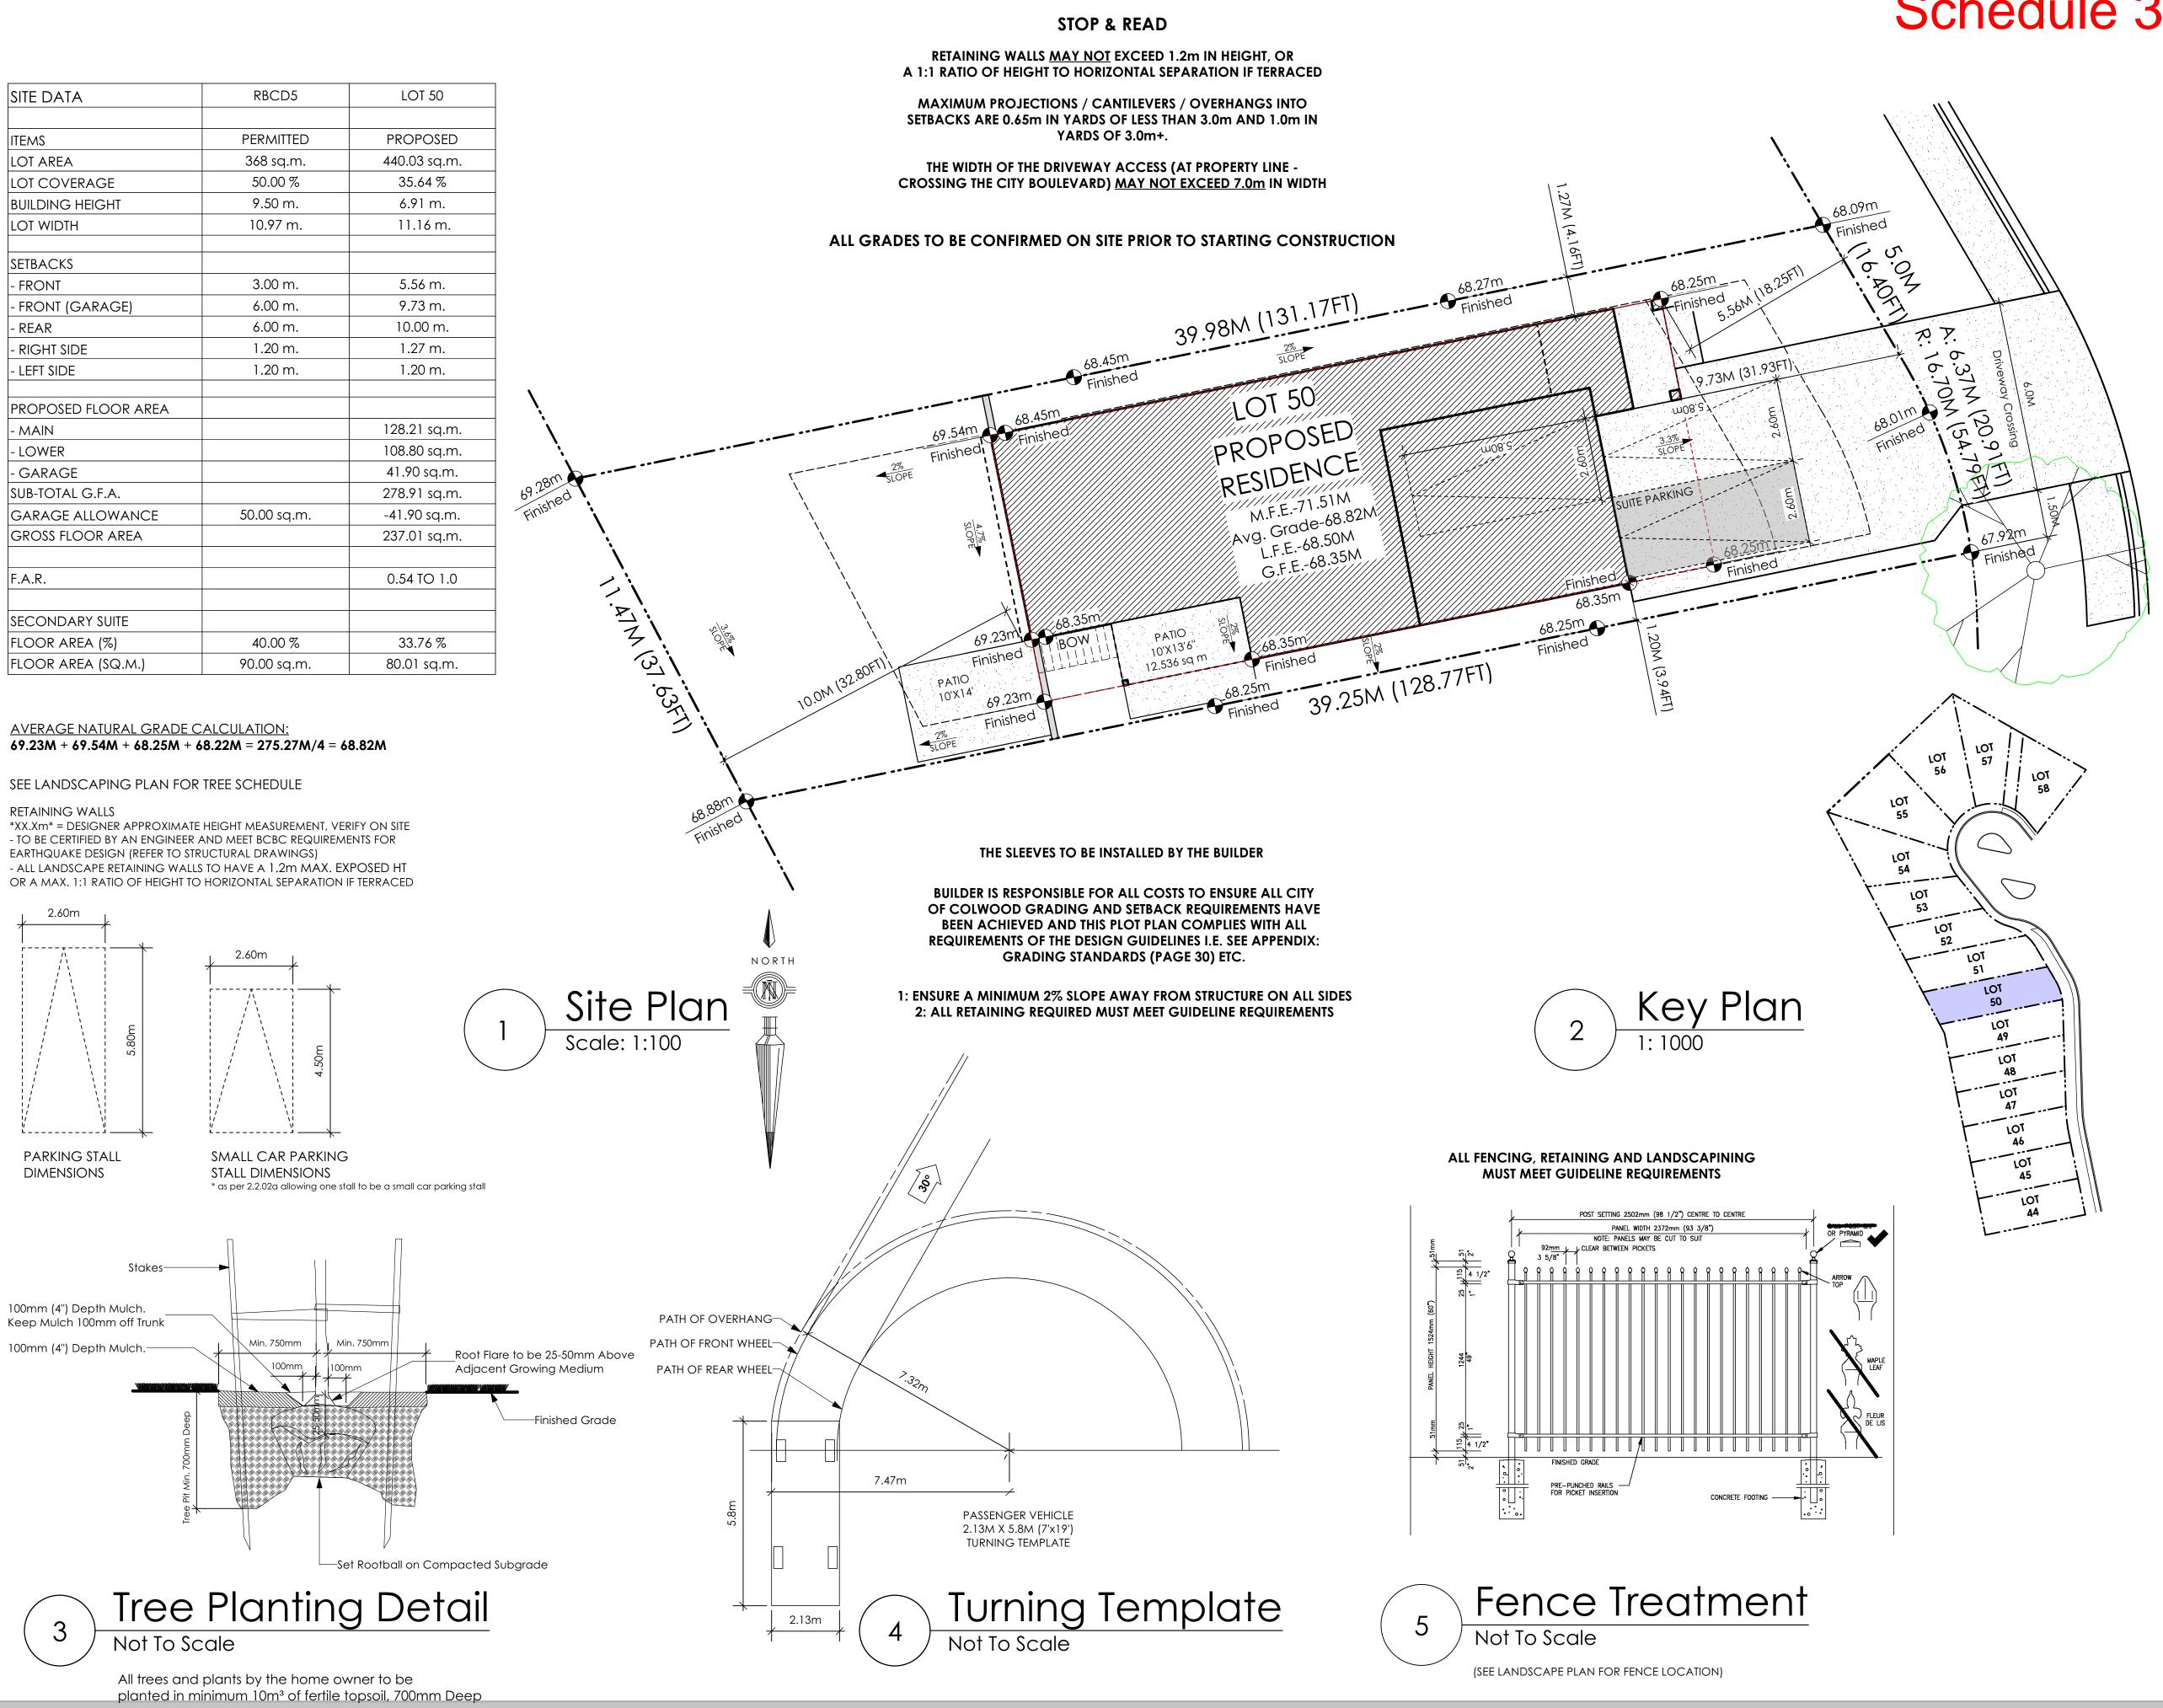

Schedule 3



#103 - 891ATTREE AVENUE VICTORIA, B.C. V9B 0A6 P. 250.382.7374 F. 250.382.7364

'PORT' - COASTAL II

Date Dec 22 2022


Project Address 3473 Trumpeter Street Royal Bay - Sector 7 Colwood, B.C.

Prepared for Verity Construction

> Project # 8298

Scale As Noted

Drawn By MRB

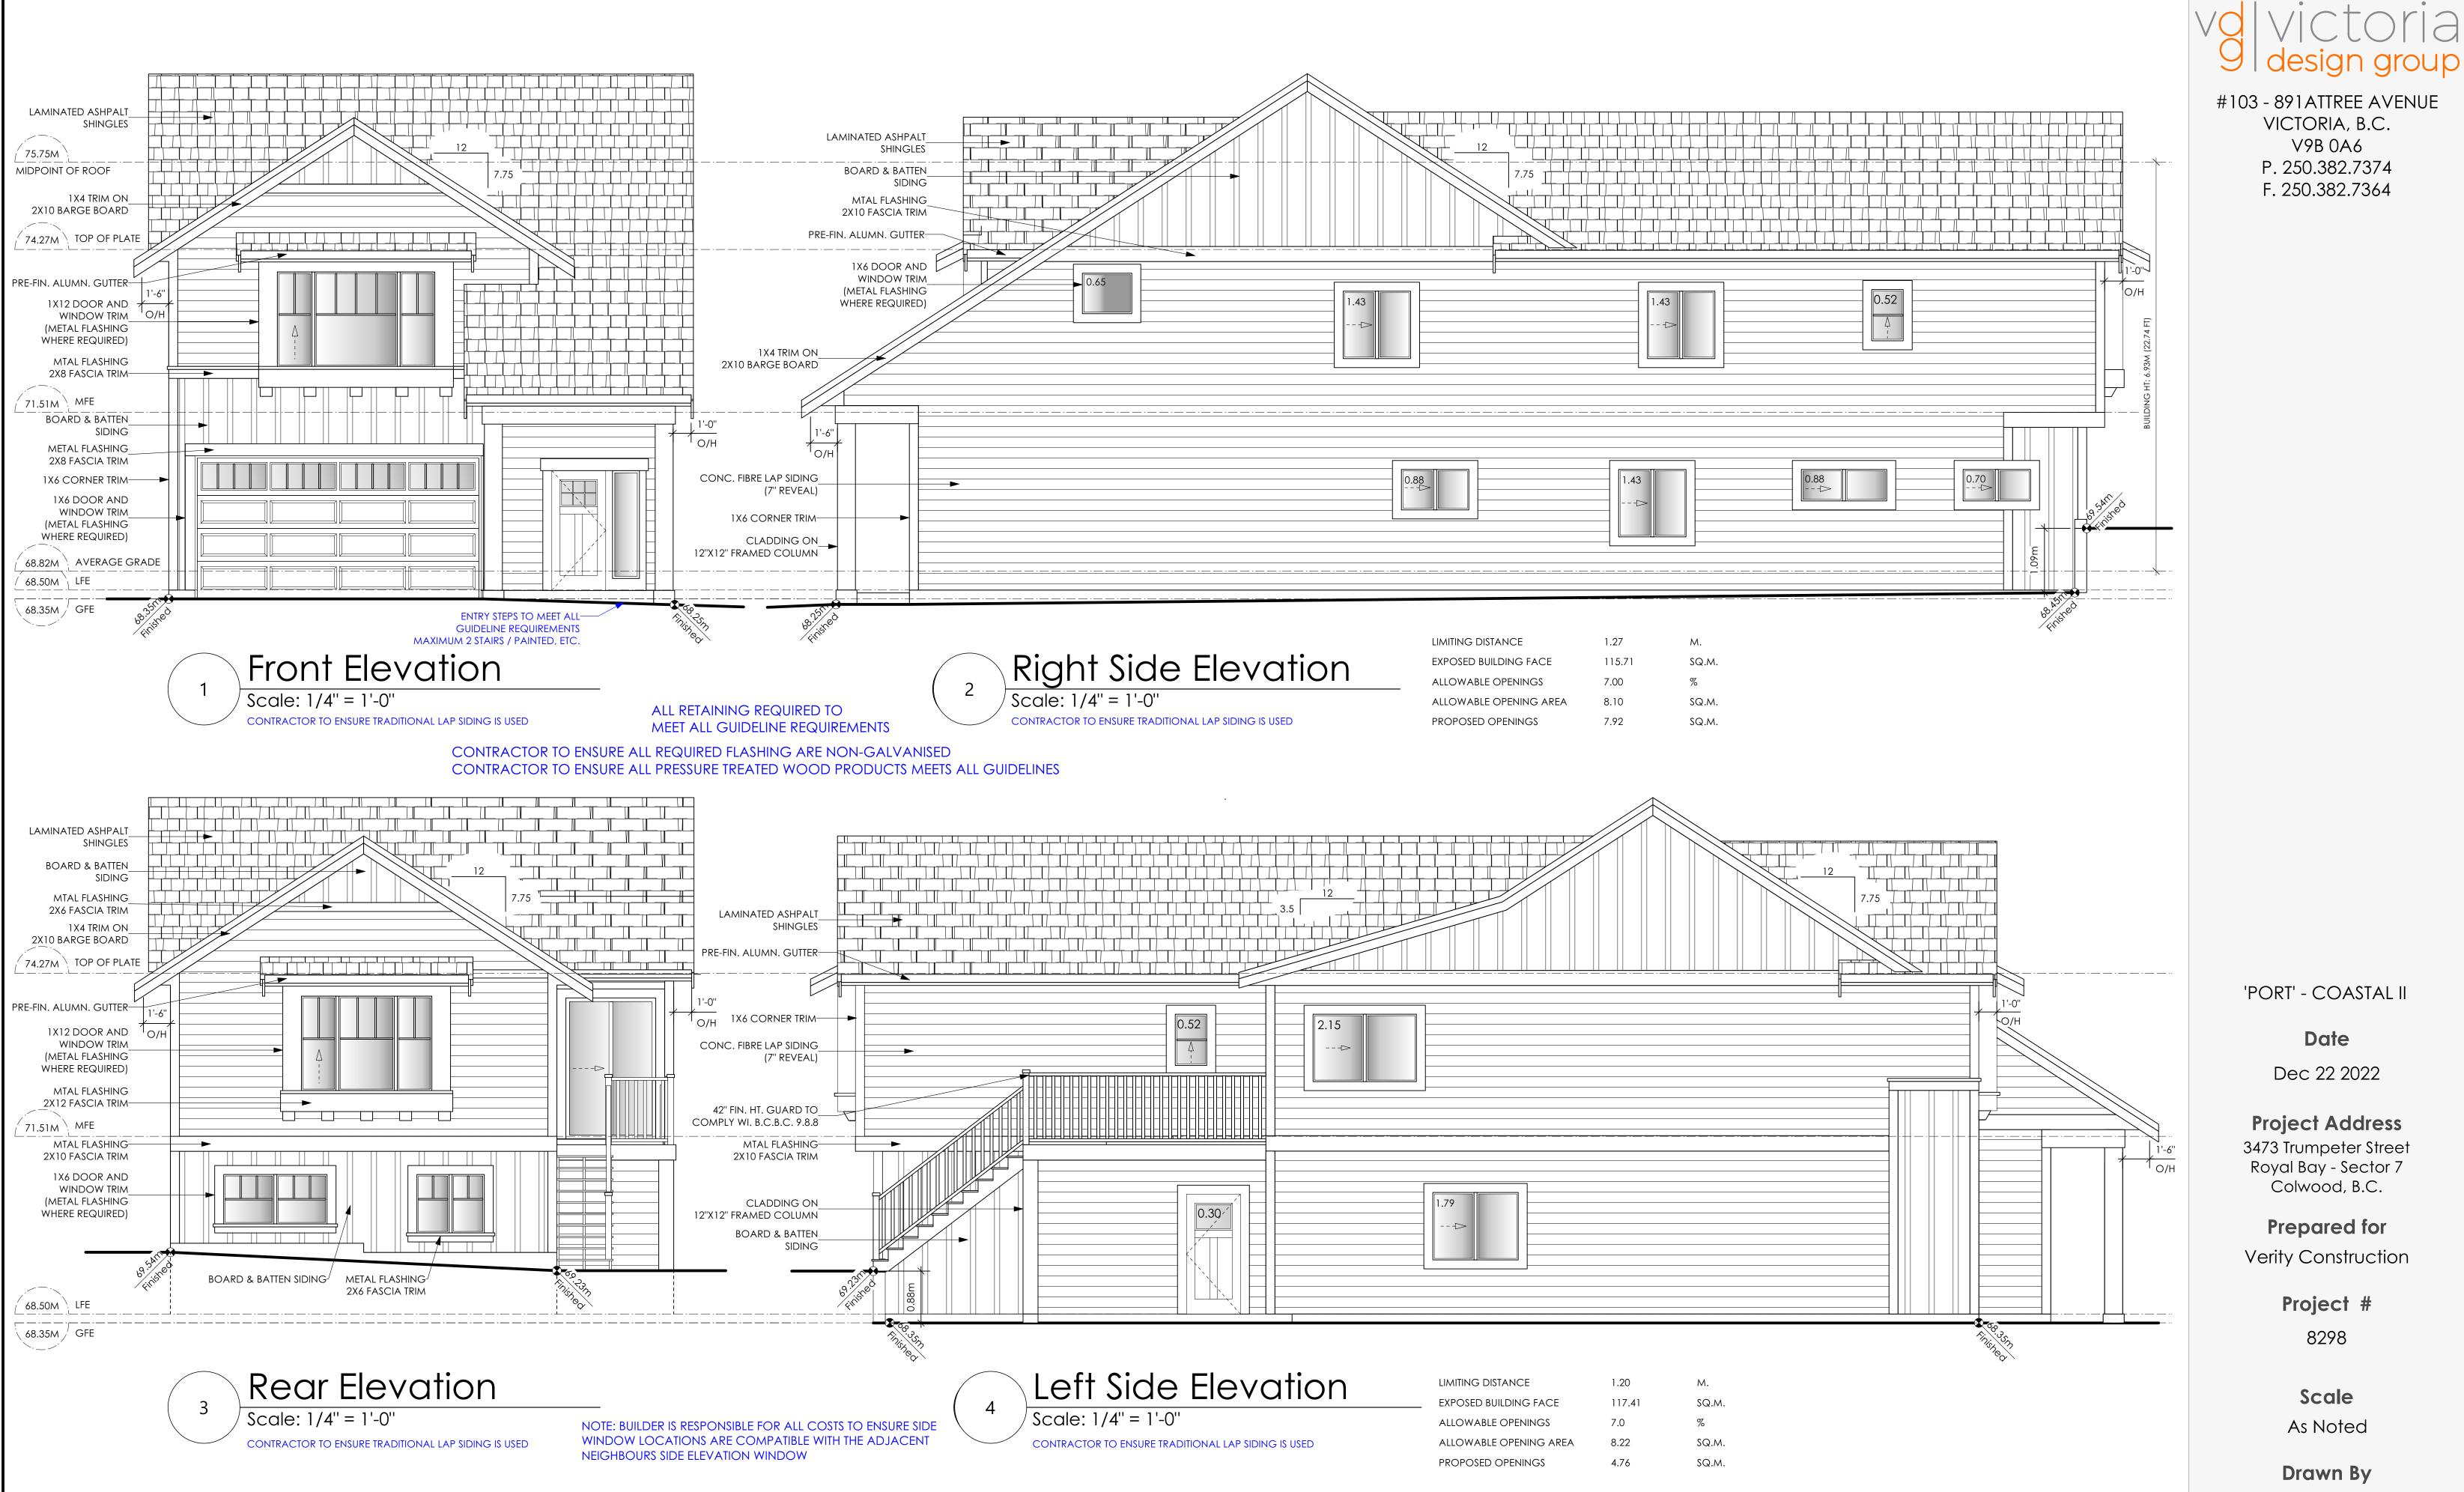

'PORT' - COASTAL II

Date Dec 22 2022


Project Address 3473 Trumpeter Street Royal Bay - Sector 7 Colwood, B.C.


Prepared for Verity Construction

> Project # 8298

Scale As Noted

Drawn By MRB

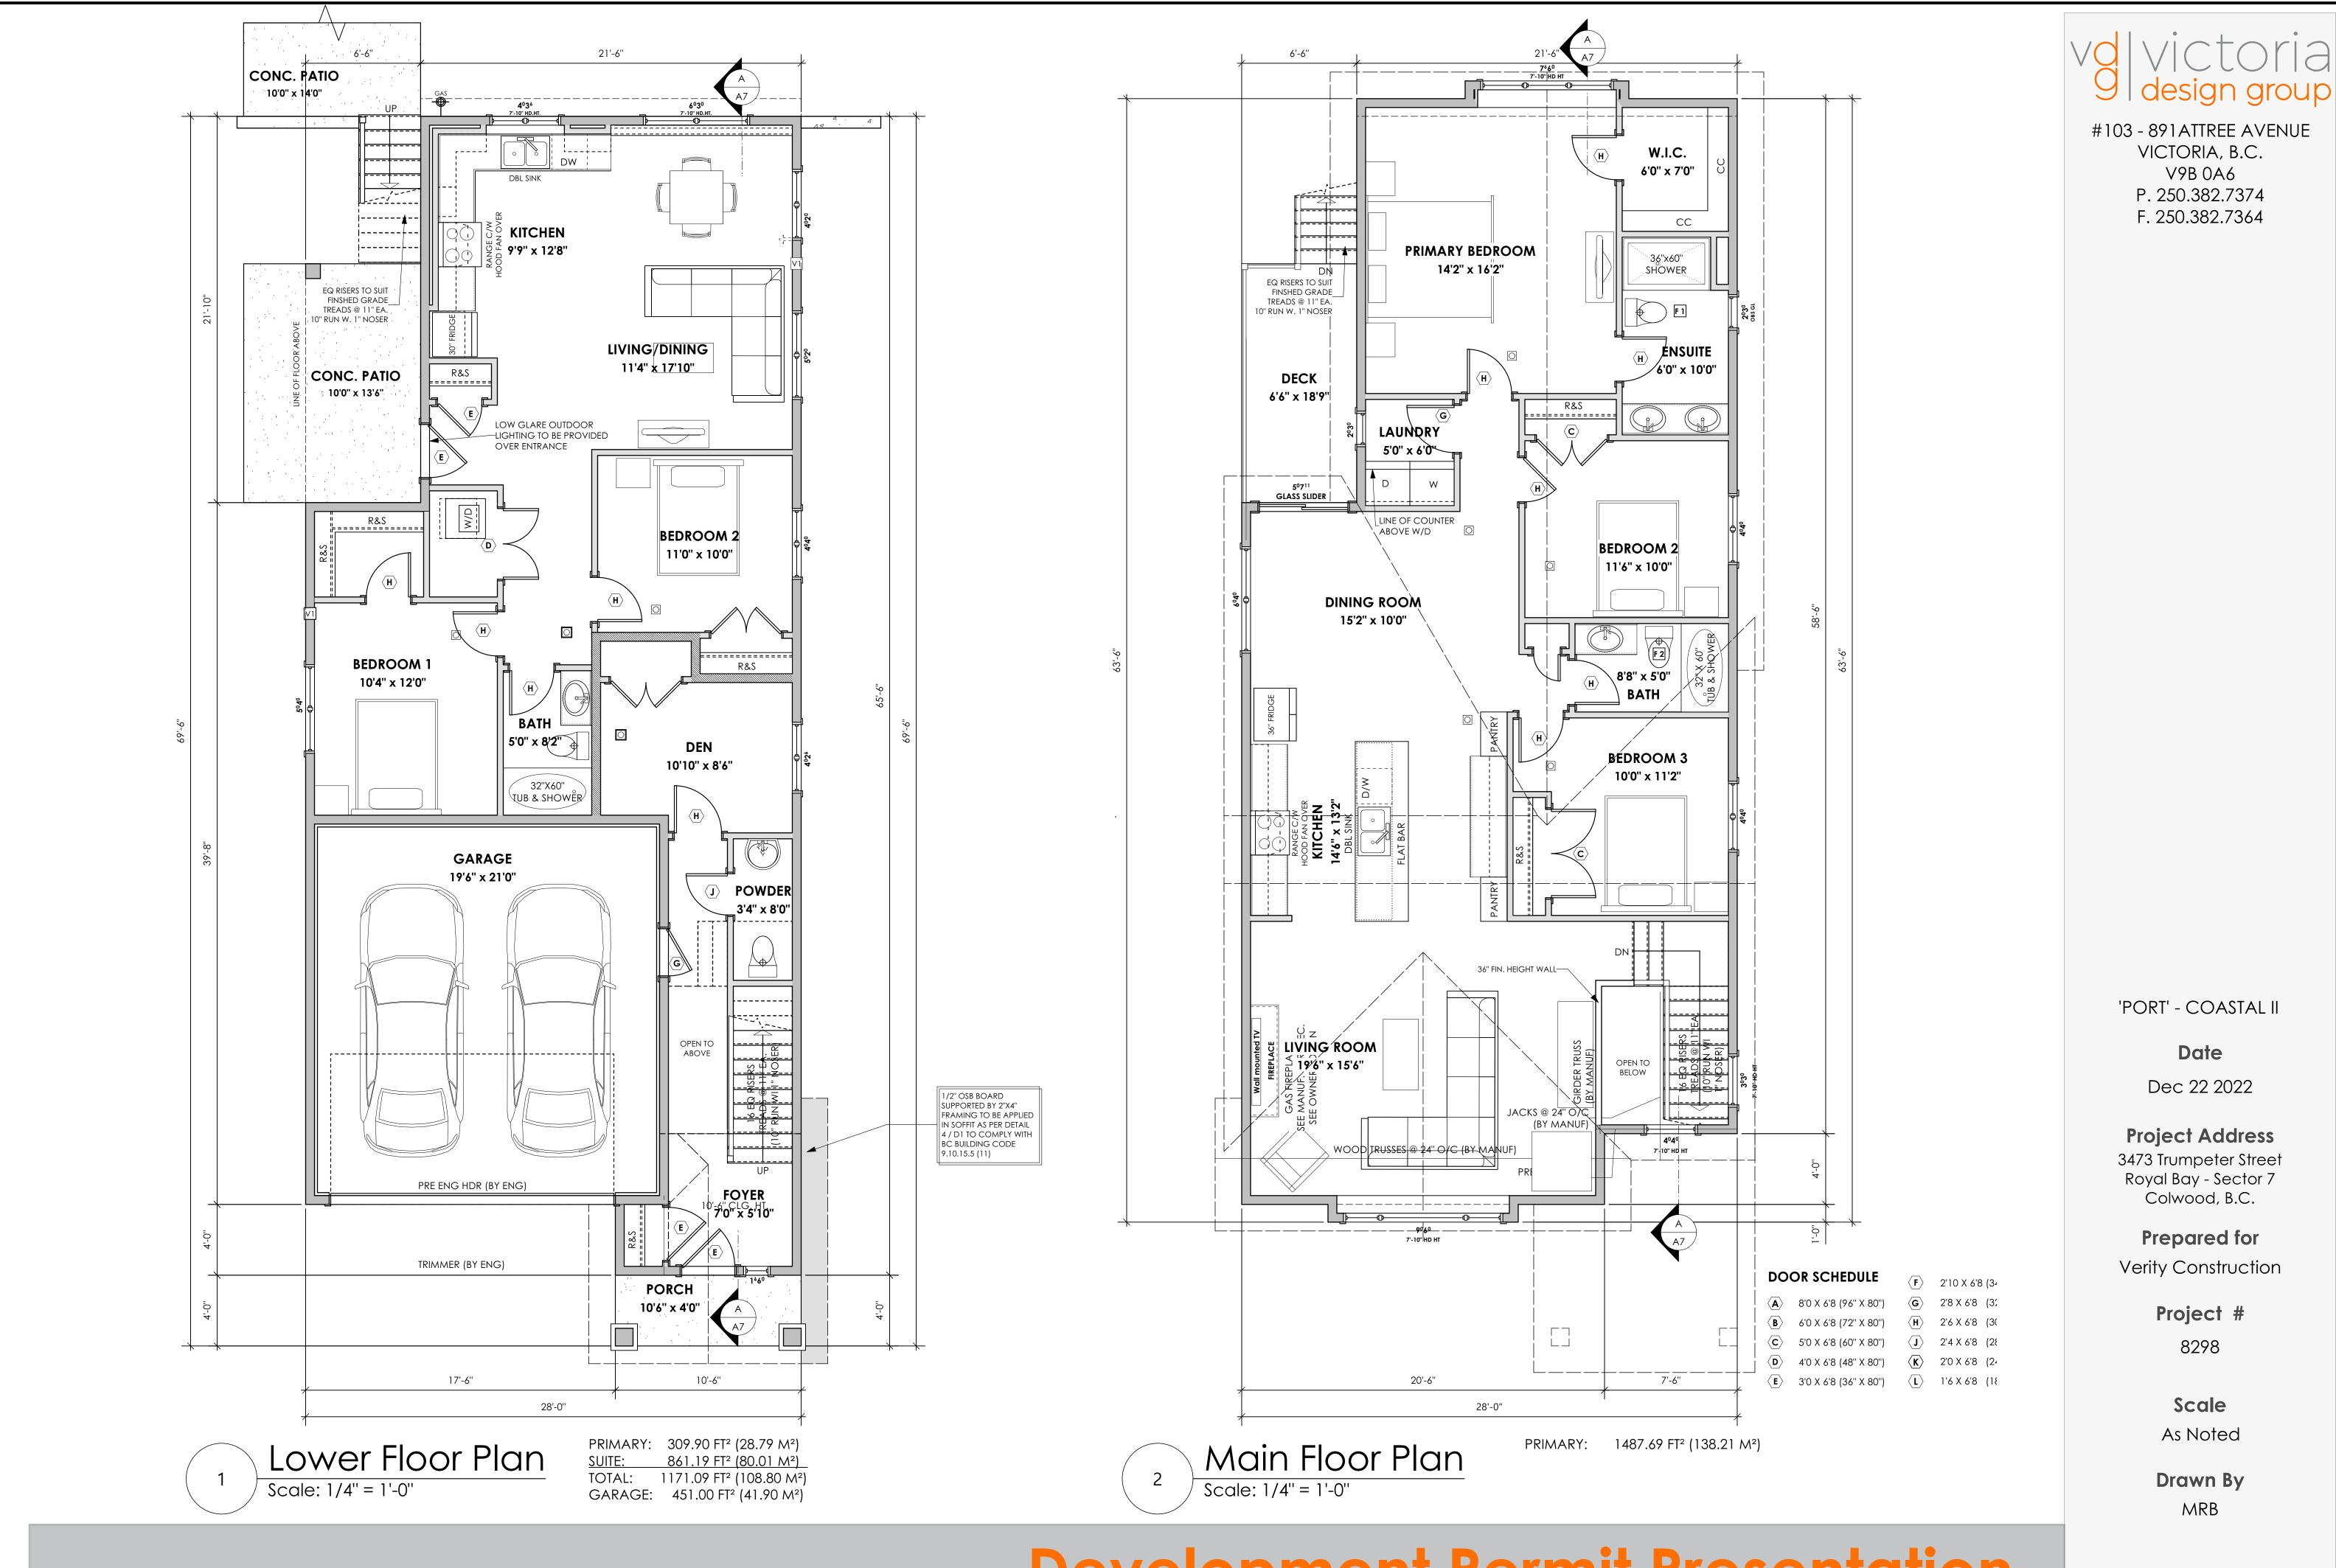

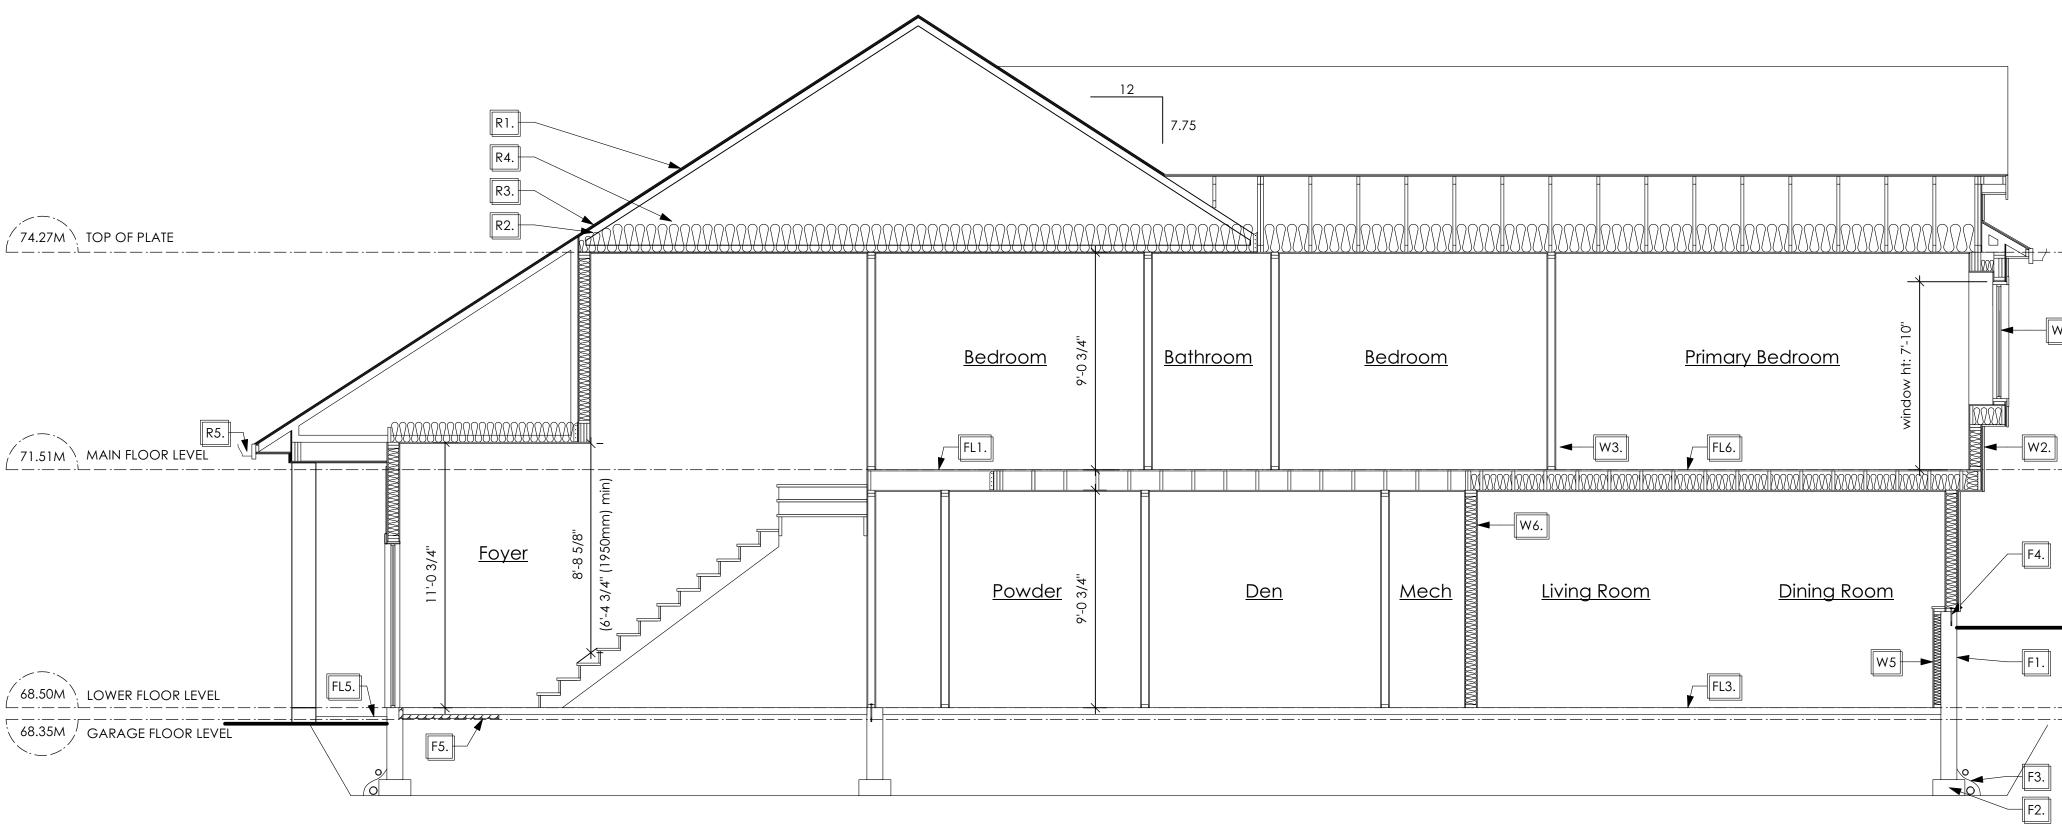



Roofs

- R1. LAMINATED ASPHALT SHINGLES ON 7/16" ORIENTED STRAND BOARD C/W "H" CLIPS WD TRUSSES (DESIGNED BY MANUF.) 14 1/2" FIBRE GLASS LOOSE FILL INSULATION (ALLOW FOR SETTLING) OR R-40 FIBRE GLASS BATT INSULATION 6 MIL POLY'N V.B. 5/8" GYPSUM BOARD
- R2. PROVIDE 2 1/2" (63mm) CLEAR BETWEEN R-20 INSULATION AND SHEATHING. (min. R-20 @ roof-wall connection for 4'-0" (1.2m) around perimeter of building. air ventelation baffles to be installed where required in as per BCBC 9.19.)
- EAVE PROTECTION R3. CONT. UP ROOF SLOPE FOR 12" PAST EXTERIOR WALL.
- R4. PROVIDE 1 SQ.FT. ATTIC VENT PER 300 SQ.FT. OF INSULATED AREA MIN. 25% OF REQUIREDTO BE @ TOP AND BOTTOM (to comply wi. B.C. bldg. code 9.19.1)
- R5. PRE-FN. FASCIA GUTTER 2×8 FASCIA BD. 2×4 SUB. FASCIA BD. VENTED SOFFIT (see contractor)

R6. PRE MANUF SOFFIT 1/2" OSB BOARD SUPPORTED BY 2"X4" FRAMING REFER TO DETAIL 4 / D1 (to be applied in any soffit that has less then 1.20m clearance to any proverty line. To comply with BC BUILDING CODE 9.10.15.5 (11)) (AS REQUIRED, VERIFY ON SITE) (NOT SHOWN IN SECTION)

Floors

	19/32 (NAILEE 2×10 FL C/W 2× 1/2" GY
FL2.	FINISHE 19/32" ((NAILEE 2×10 FL C/W 2× R-31 FIB 5/8" X-T (BETWE (NOT SH
FL3.	3 1/2" C 6 MIL. P 6" CON
FL4.	3 1/2" C 6 MIL. P 6" CON SLOPE 1 (NOT SH
FL5.	3 1/2" C (CONTR EXTERIC (SLOPE 6" CON

FL6. F8d RATED CEILING ASSEMBLY (BC BUILDING CODE TABLE 9.10.3.1.B) FINISHED FLOORING ON 19/32" ORIENTED STRAND BOARD OR EQ. (FASTENED & GLUED TO FLOOR STRUCT. BELOW) ON 2×10 FLOOR JOISTS @ 16" OR 12" O/C C/W 2×2 X-BRIDGING @ 7.0' O/C (MAX) **R-31 INSULATION** RESILIENT METAL CHANNELS @ 24" O/C 1 LAYERS 5/8" X-TYPE GYPSUM BOARD

SECTION NOTES

FL1. FINISHED FLOORING ON 19/32" ORIENTED STRAND BOARD OR EQUAL ED & GLUED TO FLOOR STRUCT. BELOW) ON

LOOR JOISTS @ 16" OR 12" O/C ×2 X-BRIDGING @ 7.0' O/C (MAX) YPSUM BOARD

ED FLOORING ON

- ORIENTED STRAND BOARD OR EQUAL D & GLUED TO FLOOR STRUCT. BELOW) ON LOOR JOISTS @ 16" OR 12" O/C ×2 X-BRIDGING @ 7.0' O/C (MAX) BRE GLASS BATT INSULATION
- type gypsum board EEN GARAGE AND LIVING SPACE)

HOWN IN SECTION)

CONCRETE SLAB POLY'N V.B. MPACTED GRAVEL OR SAND

CONCRETE SLAB

POLY'N V.B. MPACTED GRAVEL OR SAND TO DOORS 1" HOWN IN SECTION)

CONCRETE SLAB

TRACTOR TO VERIFY EXTENT OF OR SLABS AND FINISHES) AWAY FROM BUILDING @ 2% MIN.) 6" COMPACTED GRAVEL OR SAND

30 MINUTE F.R.R., 50 S.T.C.

Walls

W1. DOUBLE GLAZING ENERGY STAR LOW "E" RATING IN THERMAL BREAK FRAMES 2/2"X10" LINTEL OVER (@ BEARING WALLS ONLY) (TYPICAL, WI. 2 1/2" XPS INSULATION) FLASHING OVER @ EXTERIOR (GLAZING IN ALL EXTERIOR DOORS & WITHIN 3 FT. OF EXTERIOR DOORS TO BE SHATTERPROOF (SP)) WINDOW REQUIREMENTS DERIVED FROM BCBC TABLE C-5 AS PER BCBC 9.7.4.3. AND ARE TO BE USED TO SATISFY THE REQUIREMENTS OF AAMA/WDMA/CSA 101/I.S.2/A440, "NAFS": COLWOOD, CLASS R, DP 1440, PG 30, WATER RESIST. 220, A2, RATINGS MUST BE CLEARLY LABELED ON ALL WINDOW UNITS UPON INSTALLATION FOR INSPECTION. W2. CONC. FIBRE BOARD ON 9.5MM (3/8") AIR SPACE / STRAPPING 3/8"×2" BORATE TREATED PLYWOOD STRAPPING

STRUCTURAL WOOD ELEMENTS WITHIN 150MM (6") FROM FINISHED GROUND LEVEL SHALL BE PRESSURE TREATED WITH

A PRESERVATIVE FOR TERMITE AND DECAY PROTECTION B.C.B.C. 2012 9.3.2.9.(3)

- HOUSE WRAP (A.B.) (TYVEK OR EQ.) 7/16" ORIENTED STRAND BOARD SHEATHING 2×6 STUDS (SEE APCING BELOW) **R-20 INSULATION** 6 MIL. POLYETHYLENE VAPOUR BARRIER 1/2" GYPSUM BOARD (REFER TO DETAILS ON D1)
- W3. INTERIOR PARTITION 1/2" GYPSUM BOARD ON EACH SIDE OF 2×4 STUDS (SEE SPACING BELOW) OR 2×6 STUDS (SEE SPACING BELOW) (IF NOTED)

W4.	5/8" X-TYPE GYPSUM BOARD ON 2×6 STUDS (SEE SPACING BELOW) R-20 INSULATION	FI.	04MP 8" THK. C/W 1
	6 MIL. POLY'N V.B 1/2" GYPSUM BOARD (BETWEEN GARAGE & LIVING) (NOT SHOWN IN SECTION)	F2.	16"X 8 C/W 2 ON UN
W5.	1/2" GYPSUM BOARD ON 6 MIL. POLY'N V.B. 2×4 STUDS (SEE SPACING BELOW)	F3.	4" PERI 3" TIGH DRAIN
	OR 2x6 STUDS (SEE SPACING BELOW) (IF NOTED) R-12 BATT INSULATION HOUSE WRAP (A.B.) (TYVEK OR EQ.) OR	F4.	ANCH c/w SI
	12.7MM (1/2") AIR SPACE (PROVIDE REQUIRED FIRE STOPS IN WALL ASSEMBLIES TO COMPLY WITH B.C. BLDG. CODE 9.10.16.)	F5.	UNDER 2 1/2'' RIGID CONT.
W6.	B.C. BUILDING CODE (TABLE 9.10.3.1.A) RATED WALL ASSEMBLY W3C 1 LAYER 1/2" X-TYPE GYPSUM BOARD RESILIENT METAL CHANNELS @ 24" O/C 2×4 STUDS @ 16" O/C OR 2×6 STUDS @ 16" O/C (IF NOTED) C/W 3 1/2" FIBRE GLASS SOUND BATTS 1 LAYER 1/2" X-TYPE GYPSUM BOARD 45 MIN. F.R.R 43 S.T.C (BETWEEM PRIMARY LIVING & SECONDARY SUITE)		SLAB II (VERIF

STUD SPACING	
- UPPER FLOOR:	2"X6" @ 24" O/C
- MAIN FLOOR:	2"X6" @ 24" O/C
- LOWER FLOOR:	2"X6" @ 16" O/C
(if applicable)	
- INTERIOR PARTITION:	2''X4'''' @ 24'' O/C
- LOAD BEARING:	2"X4"" @ 16" O/C
- PARTY WALL	2"X4"" @ 24" O/C
(if applicable)	

W7.

C/11 10 111 D/
16"X 8" CON(C/W 2 (TWO) ON UNDISTUR
4" PERIMETER 3" TIGHT PIPE DRAIN ROCK
anchor bo c/w Sill Gas
UNDER SLAB 2 1/2" (RSI 2.1 RIGID INSULA CONT. AROU SLAB INSTALL

Development Permit Presentation

W1

Foundation Walls

F1. DAMPROOFING (where required) ON . CONC. FOUNDATION WALL / 15 M BARS @ 24" o/c B/W NC. FOOTINGS 15m BARS CONT. 3 IN. FROM BOTT.

JRBED SOIL (SOLID BEARING) R DRAIN E FOR RWL

OLTS @ 4.0 FT. o/c MAX SKETS

3 INSULATION .15) EXTRUDED POLYSTYRENE ATION 4'-0" (1.2M) DUND PERIMETER UNDER LED HORIZONTALLY RIFY WITH MUNICIPALITY DEPTH OF FROST LINE)

aesign group

#103 - 891ATTREE AVENUE VICTORIA, B.C. V9B 0A6 P. 250.382.7374 F. 250.382.7364

'PORT' - COASTAL II

Date Dec 22 2022


Project Address 3473 Trumpeter Street Royal Bay - Sector 7 Colwood, B.C.

Prepared for Verity Construction

> Project # 8298

Scale As Noted

Drawn By MRB

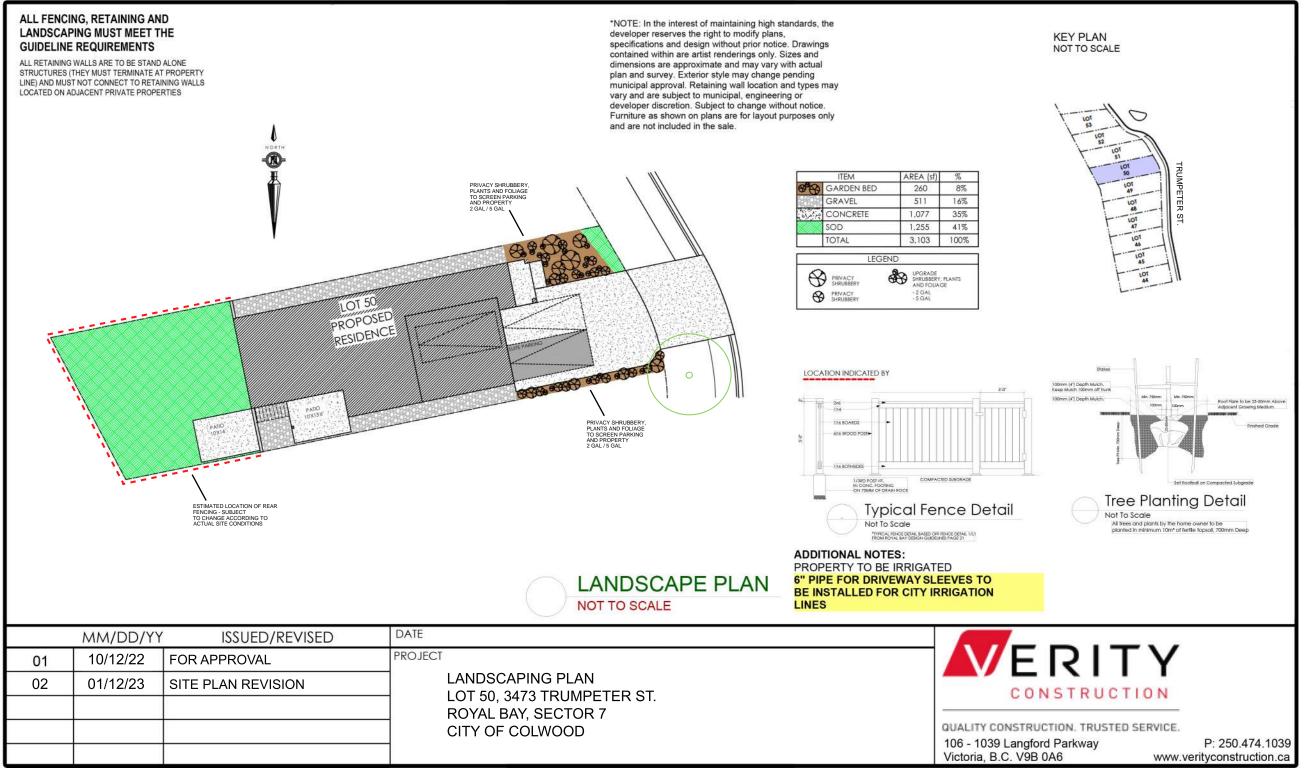


GABLECRAFT HOMES BUILDING GRADE SLIP


WSP Project No: <u>201-08151-00</u>

Issue Date: _____

ADD/633 3473 Trumpeter Street LOF NAM ADD/633 Street PCOPOSED BUILDING GRADES Street ALD ADD/643 Street POOPOSED BUILDING GRADES Street ALD ADD/643 Street POOPOSED BUILDING GRADES Street ALD ADD/643 Street PROPOSED BUILDING GRADES PLAN Non Too Encorna TO PROPOSED FIND TO ENANT Street PROPOSED FIND TO ENANT Street Street Street
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ACORESS DOLLOPH MACKES SERIONAL ILL REPESE ITATIVE PH MACKES SERIONAL ILL PROPOSED BUILDING GRADES ILL MACKES SERIONAL ILL CONSULTANT MACKES SERIONAL ILL MACKES SERIONAL ILL SERVICES FRONT REAR CENTER DEGREES MACKES SERIONAL ILL MACKES SERIONAL ILL SERVICES FRONT REAR CENTER DEGREES MACKES SERIONAL ILL MACKES SERIONAL ILL SERVICES FRONT REAR CENTER DEGREES MACKES SERIONAL ILL MACKES SERIONAL ILL COMMENTS MACKES SERIONAL ILL MACKES SERIONAL ILL MACKES SERIONAL ILL
BETRESENTATIVE F44 CONSULTANT PROPOSED BUILDING GRADES ALL LEARNING AKE WITHE CONSULTANT PLAN ALL LEARNING AKE WITHE CONSULTANT PLAN PLAN MATCHING TERMING AT ALL CRACK CONTROL Image: Consultant of the consu
PROPOSED BUILDING GRADES ALL LEAR TIME ARE INTERCEDENCE
 IT IS THE RESPONSIBILITY OF THE BUILDER TO ENSURE THE FOOTINGS ARE PLACED ON A PROPER BASE THAT IS FREE FROM FROST, EXCESSIVE MOISTURE AND DELETERIOUS MATERIALS AND HAVE APPROPRIATE FROST PROTECTION WHEN COMPLETED. THE INFORMATION CONTAINED HEREIN IS BASED ON THE APPROVED LOT GRADING PLAN FOR THIS SUBDIVISION. UN-AUTHORIZED DEVIATIONS WILL BE THE RESPONSIBILITY OF THE BUILDER TO

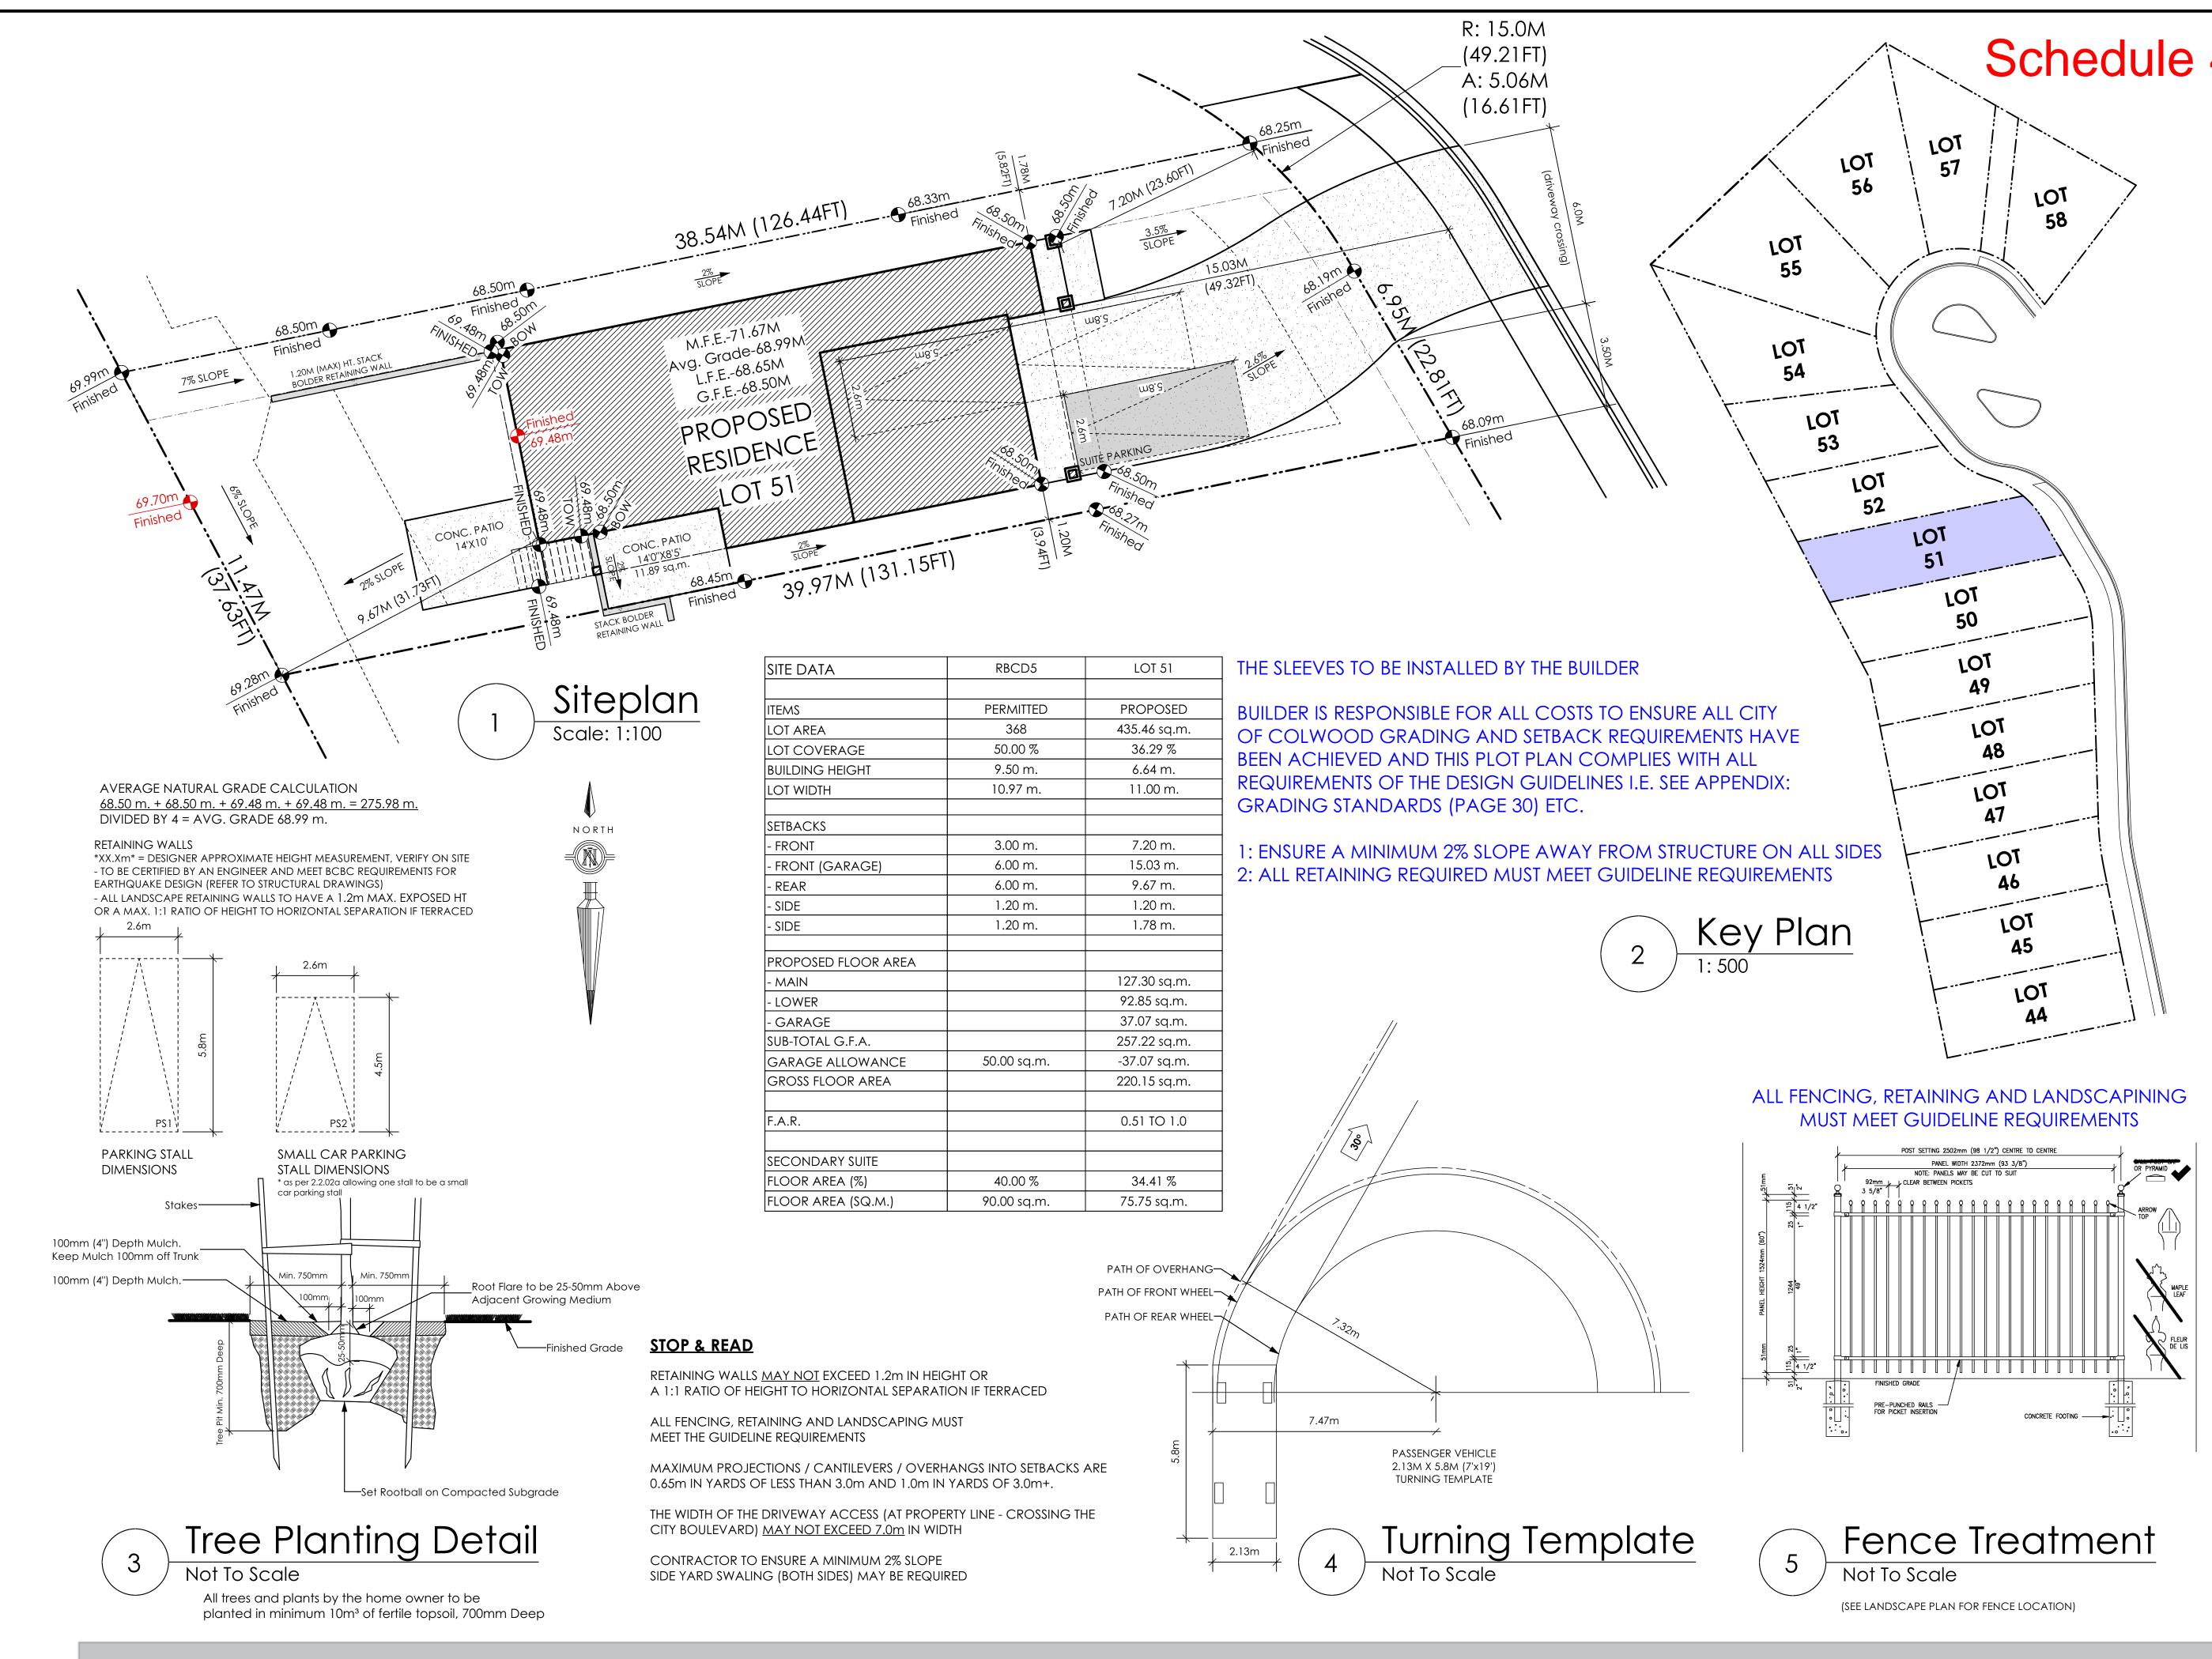

EXCEED 7.0m IN WIDTH	
MINIMUM 2% SLOPE	

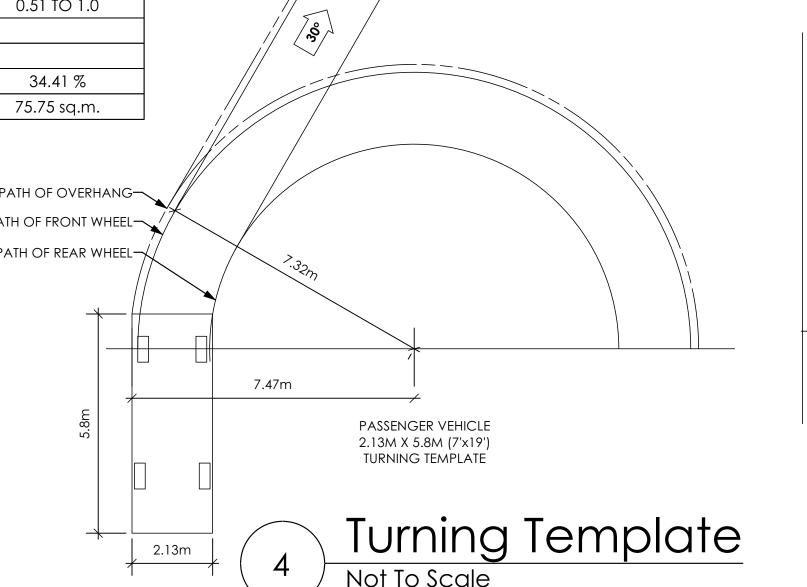

	368	435.46 sq.m.
ERAGE	50.00 %	36.29 %
HEIGHT	9.50 m.	6.64 m.
4	10.97 m.	11.00 m.
	3.00 m.	7.20 m.
GARAGE)	6.00 m.	15.03 m.
	6.00 m.	9.67 m.
	1.20 m.	1.20 m.
	1.20 m.	1.78 m.
D FLOOR AREA		
		127.30 sq.m.
		92.85 sq.m.
E		37.07 sq.m.
L G.F.A.		257.22 sq.m.
ALLOWANCE	50.00 sq.m.	-37.07 sq.m.
OOR AREA		220.15 sq.m.
		0.51 TO 1.0
ARY SUITE		
REA (%)	40.00 %	34.41 %
	90.00 sa m	75 75 sa m





#103 - 891ATTREE AVENUE VICTORIA, B.C. V9B 0A6 P. 250.382.7374 F. 250.382.7364

APPROVED BY VERITY CONSTRUCTION

DATE

APPROVED BY REALTOR

DATE

Helm TL

Date Apr. 27, 2023


Project Address 3475 Trumpeter Street Royal Bay - Sector 7 Colwood, B.C. Prepared for

Verity Construction


Project # 8298

Scale As Noted

Drawn By MRB

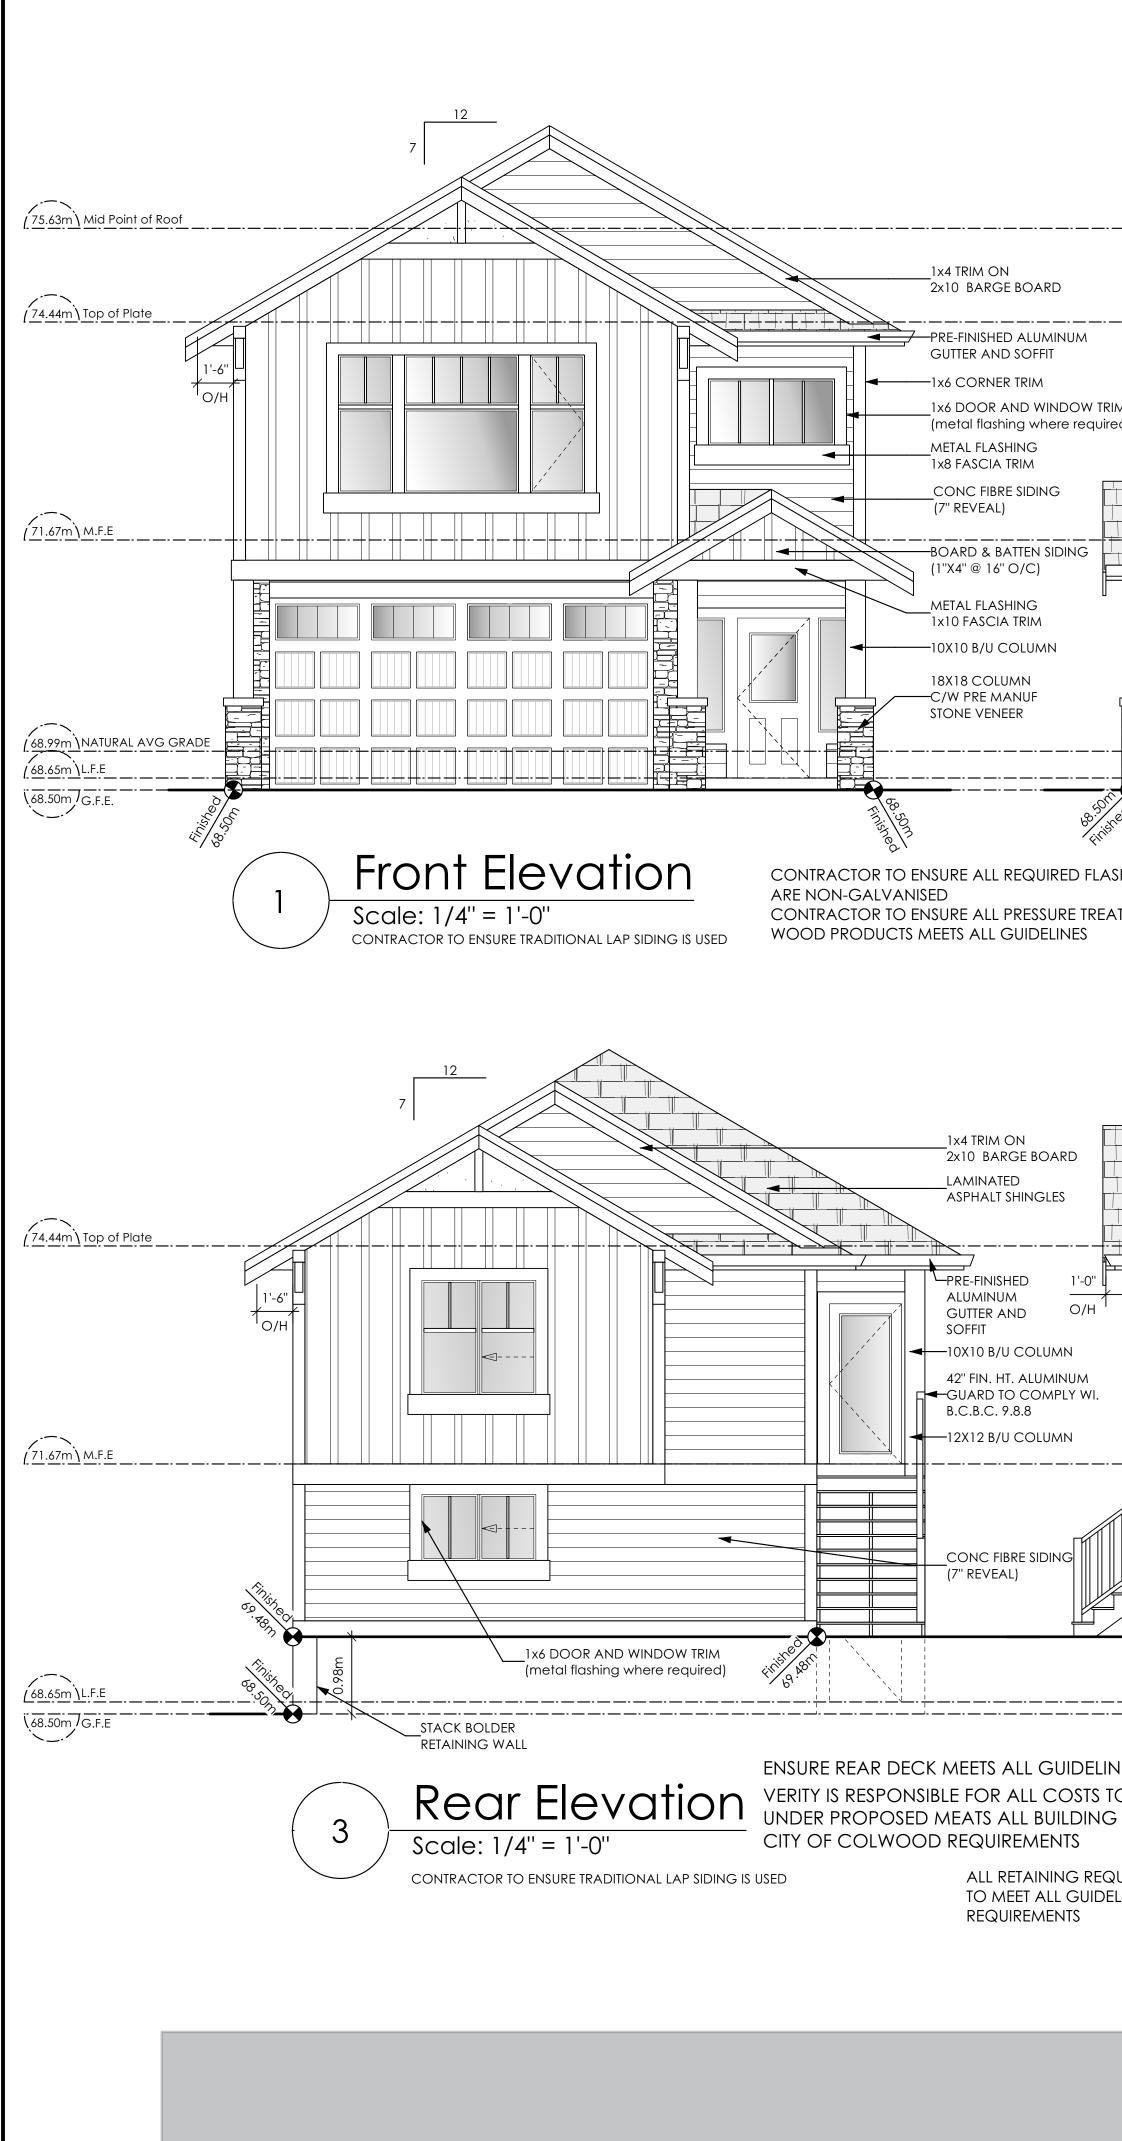

<u>1'-0"</u> О/Н М ed)					1.43
			.70		1.24
SHING TED	Right Side Ele Scale: 1/4" = 1'-0" CONTRACTOR TO ENSURE TRADITIONAL LAP SIE	EVATION EXI AII	oosed Building Face owable Openings owable Opening Area	7.5 % 7.79 sc	n. q.m.
			1.79		
NE REQUIREMENTS O ENSURE THE DRIVE CODE/BYLAWS &	🔿 Left Side E		Limiting Distance Exposed Building Face Allowable Openings Allowable Opening Area Proposed Openings	1.20 102.09 7.0 7.15 6.05	m. sq.m. % sq.m. sq.m.

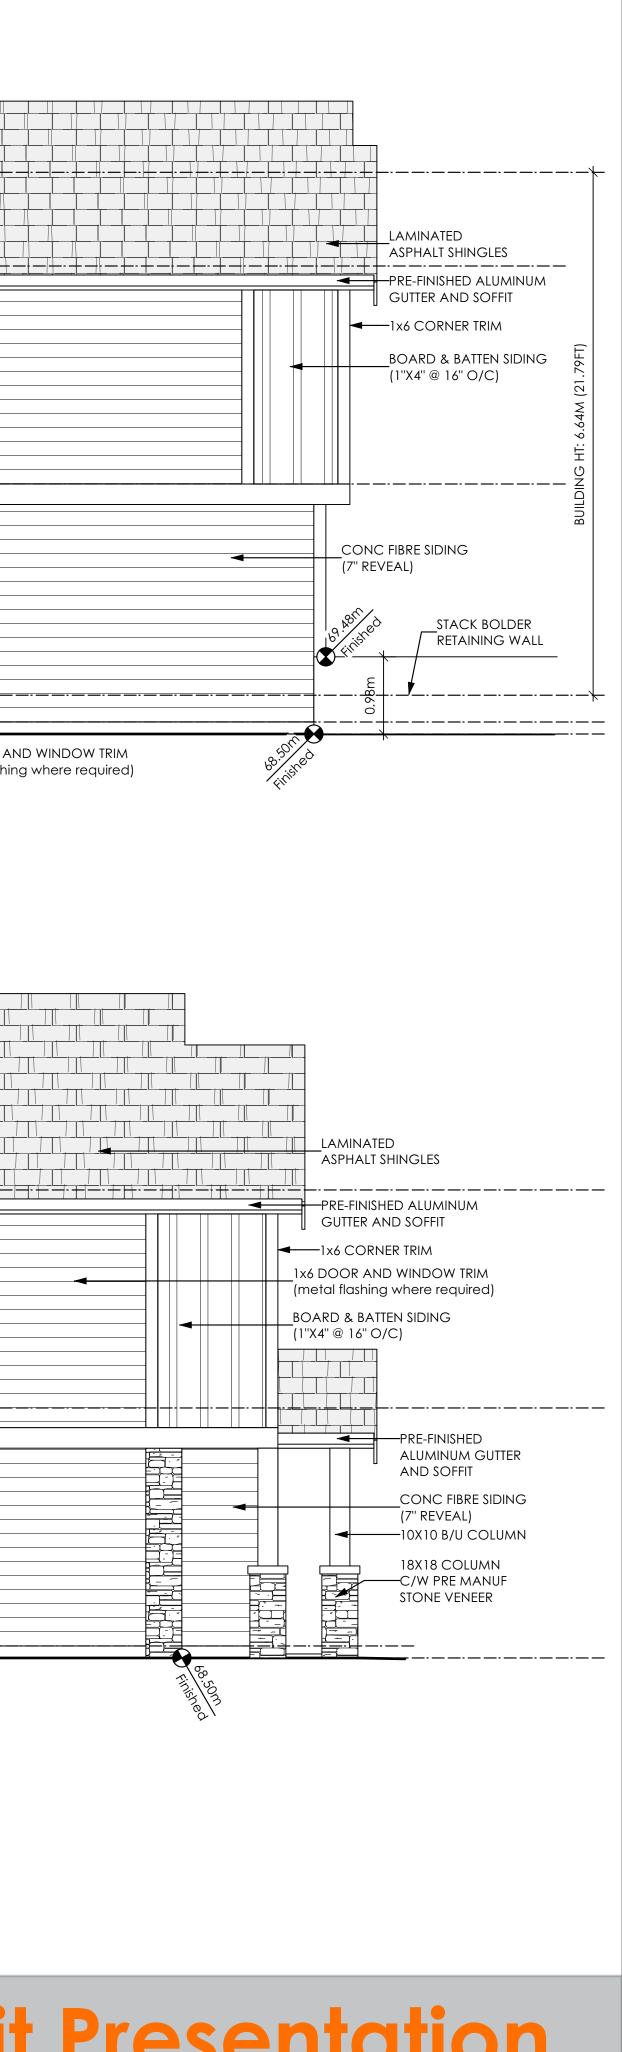

/d|victoria 9|design group

#103 - 891ATTREE AVENUE VICTORIA, B.C. V9B 0A6 P. 250.382.7374 F. 250.382.7364

Helm TL

Date Apr. 27, 2023


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Verity Construction

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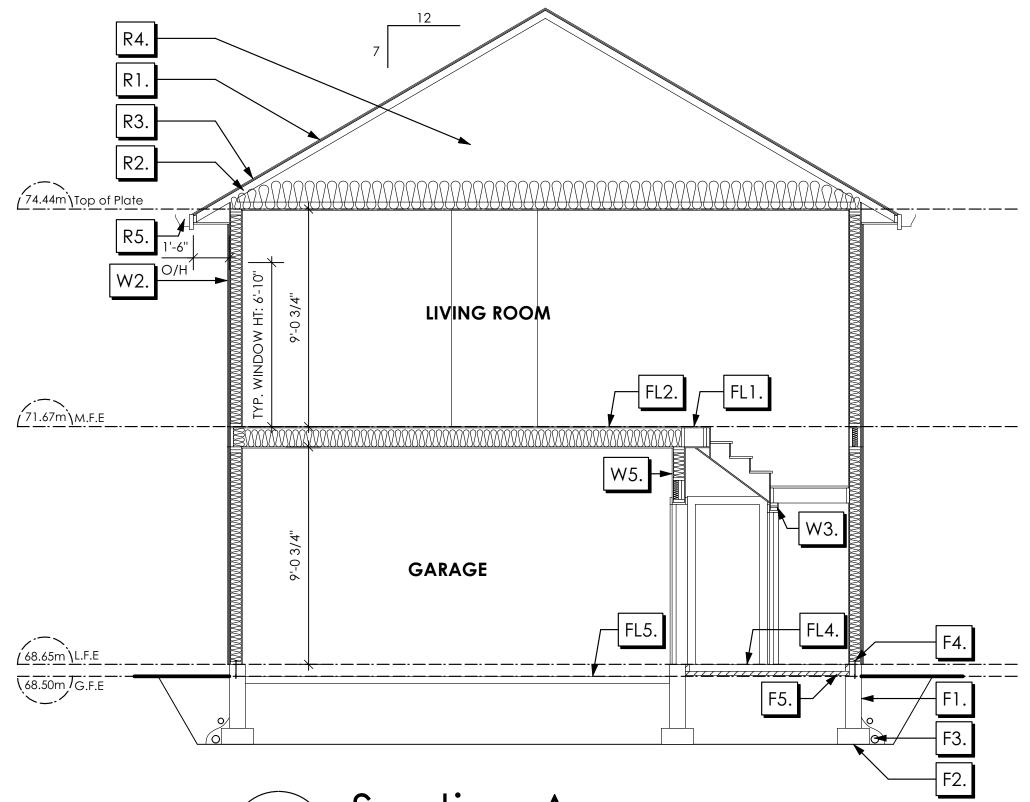
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ALL STRUCTURE TO BE VERIFIED OR DESIGNED BY A STRUCTURAL ENGINEER. STRUCTURAL ENGINEER TO LOCATE AND DESIGN WALLS TO RESIST LATERAL LOADS.

ALL STRUCTURE TO BE VERIFIED OR DESIGNED BY A STRUCTURAL ENGINEER. STRUCTURAL ENGINEER TO LOCATE AND DESIGN REQUIRED EXTERIOR AND INTERIOR BRACED WALL PANELS TO RESIST LATERAL LOADS IN COMPLIANCE WITH B.C. BUILDING CODE 9.23.13.2 AND SUPPLY DETAILS IF REQUIRED

FOUNDATION WALLS

- F1. DAMP PROOFING (WHERE REQUIRED) ON 8" THK. CONC. FOUNDATION WALL C/W 15 M BARS @ 24" O/C B/W
- 16"X 8" CONC. FOOTINGS F2. C/W 2 (TWO) 15M BARS CONT. 3 IN. FROM BOTT. ON UNDISTURBED SOIL (SOLID BEARING)
- F3. 4" PERIMETER DRAIN 3" TIGHT PIPE FOR RWL DRAIN ROCK
- ANCHOR BOLTS @ 4.0 FT. O/C MAX F4. C/W SILL GASKETS
- UNDER SLAB INSULATION F5. 2 1/2" (RSI 2.15) EXTRUDED POLYSTYRENE RIGID INSULATION 4'-0" (1.2M) CONT. AROUND PERIMETER UNDER SLAB INSTALLED HORIZONTALLY (VERIFY WITH MUNICIPALITY DEPTH OF FROST LINE) (NOT IN SECTION)

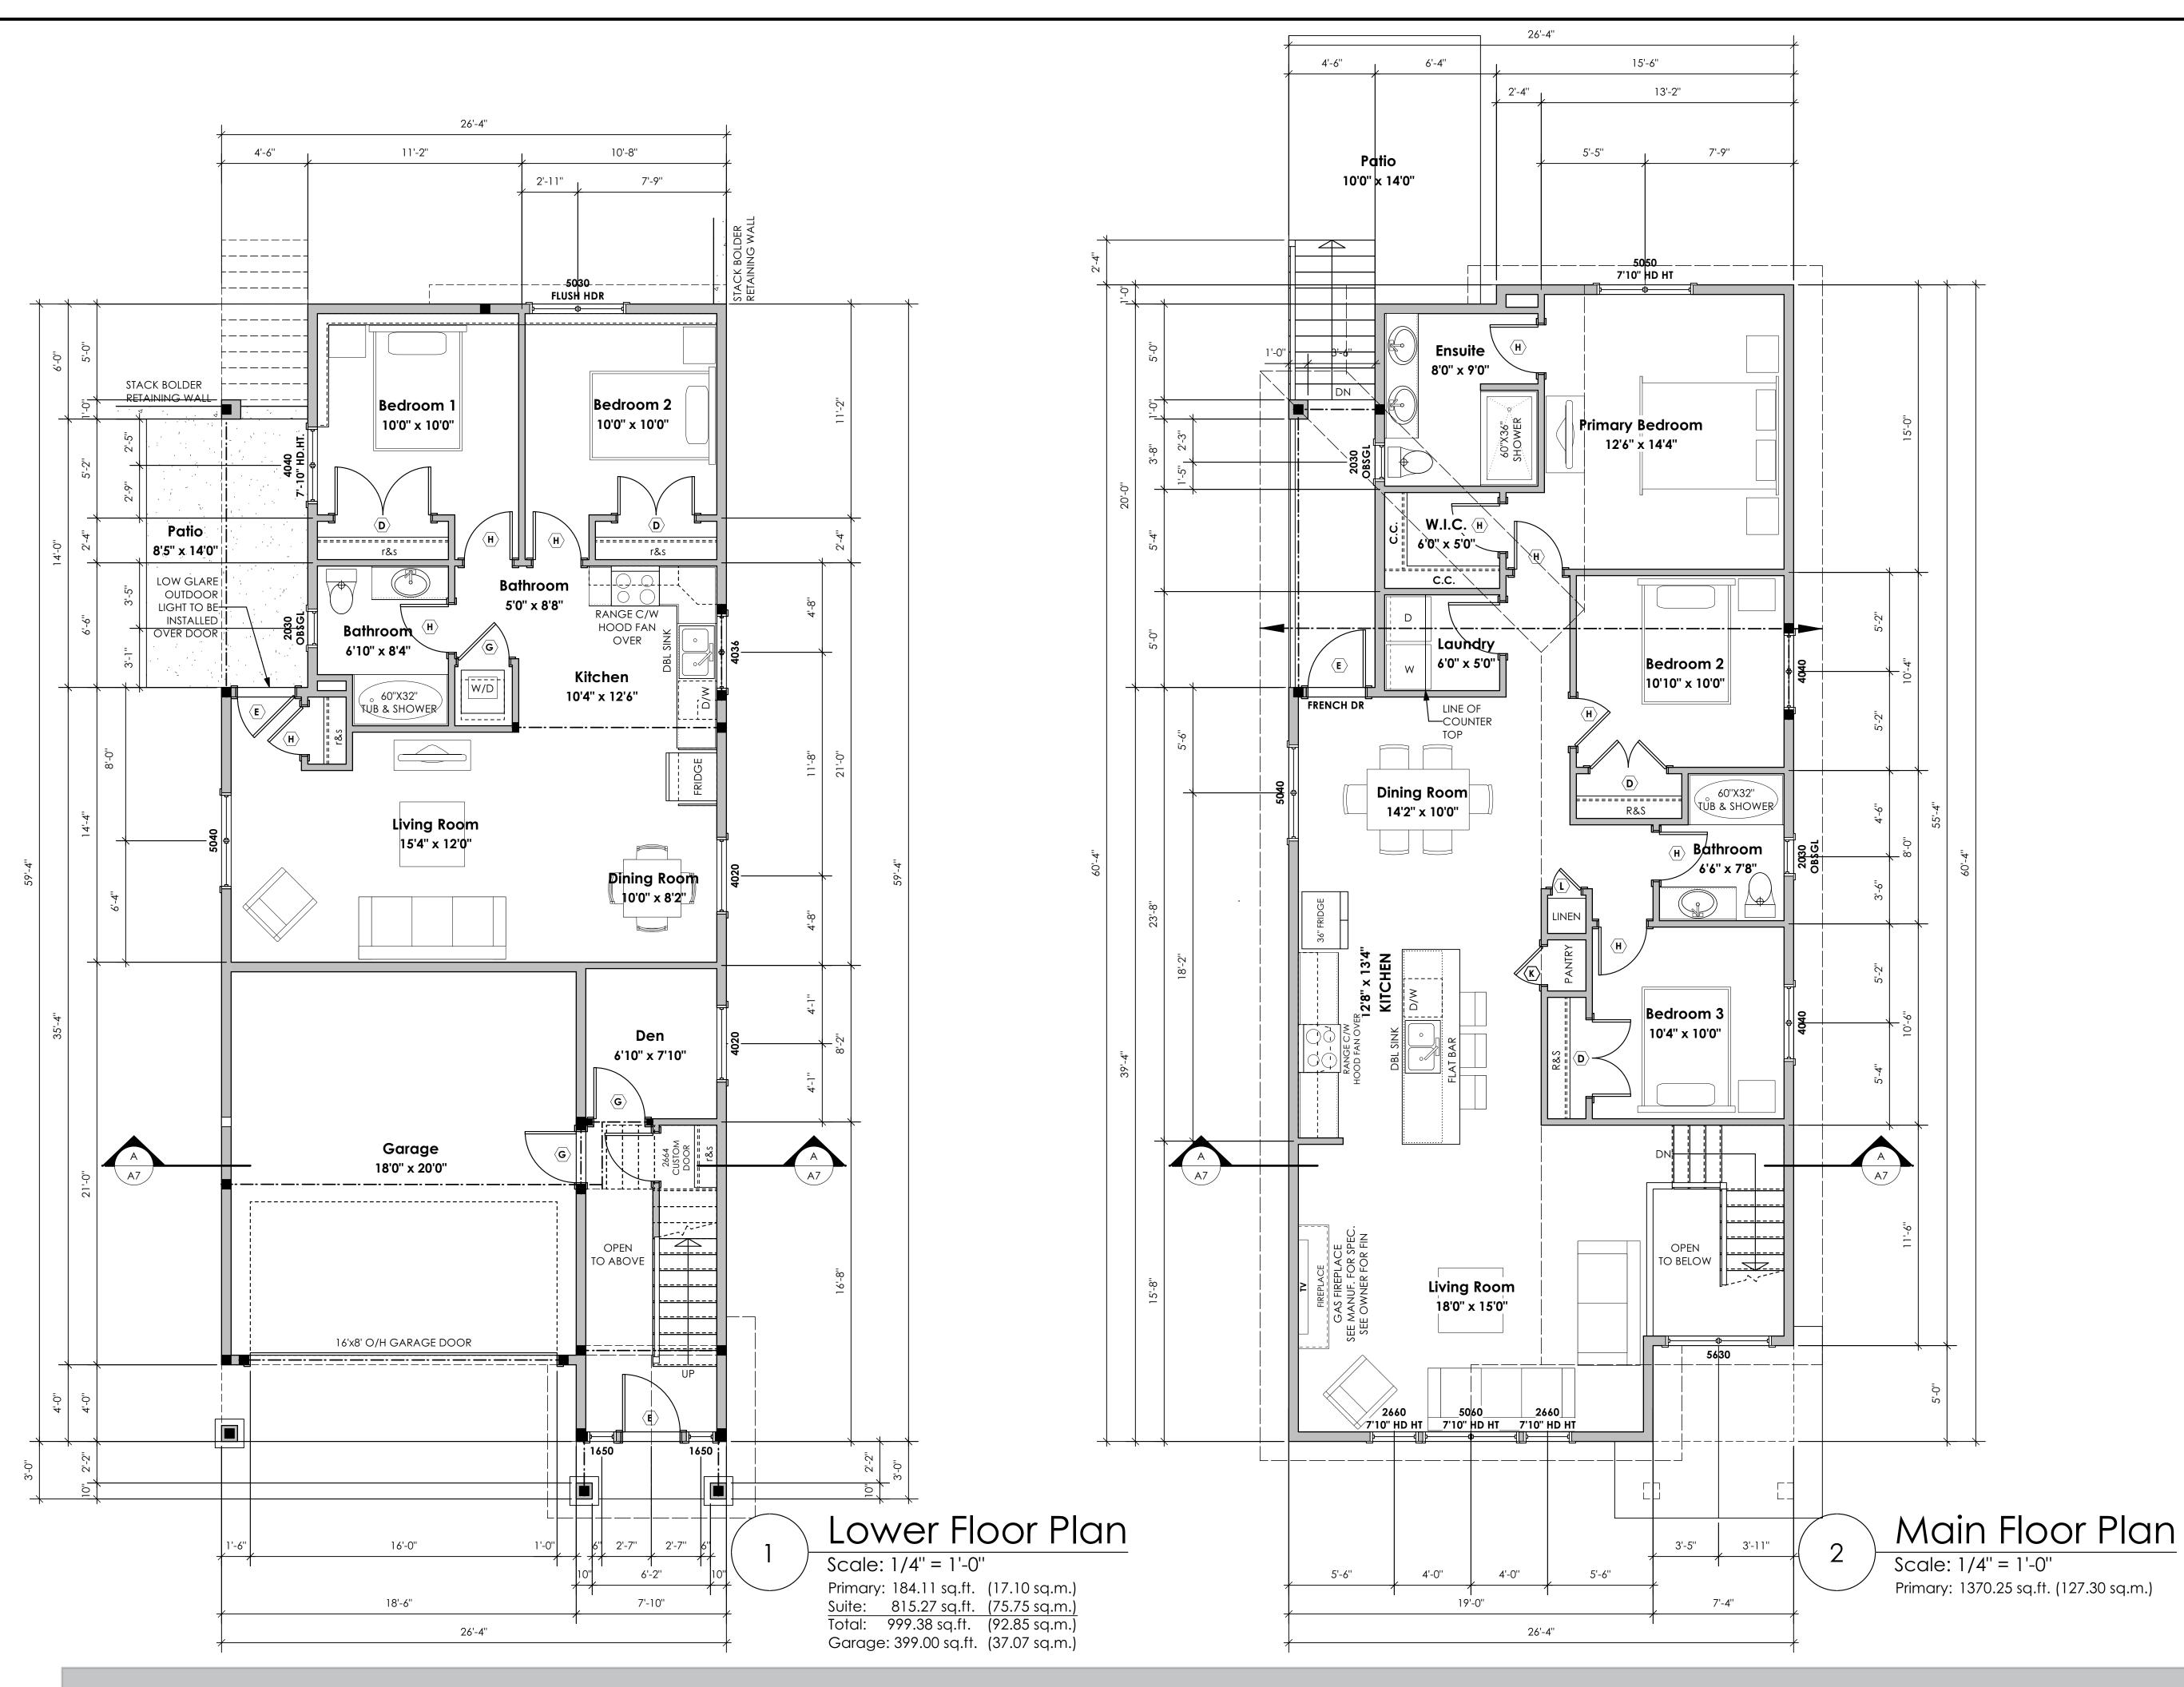ROOFS

- R1. LAMINATED ASPHALT SHINGLES ON 7/16" ORIENTED STRAND BOARD C/W "H" CLIPS WD TRUSSES (DESIGNED BY MANUF.) 14 1/2" FIBRE GLASS LOOSE FILL INSULATION (ALLOW FOR SETTLING) 6 MIL POLY'N V.B. 5/8" GYPSUM BOARD
- R2. PROVIDE 2 1/2" (63MM) CLEAR BETWEEN R-20 INSULATION AND SHEATHING. (MIN. R-20 @ ROOF-WALL CONNECTION FOR 4'-0" (1.2M) AROUND PERIMETER OF BUILDING. AIR VENTILATION BAFFLES TO BE INSTALLED WHERE REQUIRED IN AS PER BCBC 9.19.)
- R3. EAVE PROTECTION CONT. UP ROOF SLOPE FOR 12" PAST EXTERIOR WALL.
- R4. PROVIDE 1 SQ.FT. ATTIC VENT PER 300 SQ.FT. OF INSULATED AREA MIN. 25% OF REQUIRED TO BE @ TOP AND BOTTOM (TO COMPLY WI. B.C. BLDG. CODE 9.19.1)
- R5. PRE-FIN. FASCIA GUTTER 2×8 FASCIA BD. 2×4 SUB. FASCIA BD. VENTED SOFFIT (SEE CONTRACTOR)

Section Notes

FLOORS

- FL1. FINISHED FLOORING ON 11/16" ORIENTED STRAND BOARD (NAILED & GLUED TO FLOOR STRUCT. BELOW) ON 2×10 FLOOR JOISTS @ 16" OR 12" O/C C/W 2×2 X-BRIDGING @ 7.0' O/C (MAX) 1/2" GYPSUM BOARD FL2. FINISHED FLOORING ON 11/16" ORIENTED STRAND BOARD (NAILED & GLUED TO FLOOR STRUCT. BELOW) ON 2×10 FLOOR JOISTS @ 16" OR 12" O/C C/W 2×2 X-BRIDGING @ 7.0' O/C (MAX) **R-31 INSULATION** 5/8" X-TYPE GYPSUM BOARD (BETWEEN GARAGE AND LIVING SPACE) FL3. FINISHED FLOORING ON 19/32" ORIENTED STRAND BOARD (FASTENED & GLUED TO FLOOR STRUCT. BELOW) ON 2×10 FLOOR JOISTS @ 16" OR 12" O/C C/W 2×2 X-BRIDGING @ 7.0' O/C (MAX) PROVIDE R-31 F/G BATT INSULATION IN JOIST CAVITY C/W BUILDING WRAP VENTED SOFFIT (TO OWNERS SPEC'S) TO ALL SUSPENDED FLOOR AREAS (NOT SHOWN IN SECTION) FL4. 3 1/2" CONCRETE SLAB 6 MIL. POLY'N V.B. 6" COMPACTED GRAVEL OR SAND FL5. 3 1/2" CONCRETE SLAB 6 MIL. POLY'N V.B. 6" COMPACTED GRAVEL OR SAND SLOPE TO DOORS 1" FL6. F8d RATED FLOOR ASSEMBLY (BC BUILDING CODE TABLE 9.10.3.1.B) FINISHED FLOORING ON 19/32" ORIENTED STRAND BOARD OR EQ. (FASTENED & GLUED TO FLOOR STRUCT. BELOW) ON 2×10 FLOOR JOISTS @ 16" OR 12" O/C C/W 2×2 X-BRIDGING @ 7.0' O/C (MAX) **R-31 INSULATION** RESILIENT METAL CHANNELS @ 24" O/C 1 LAYERS 5/8" X-TYPE GYPSUM BOARD 30 MINUTE F.R.R., 50 S.T.C. (NOT SHOWN IN SECTION) FL7. DECKING MEMBRANE (TO COMPLY WITH CAN/CGSB 37.54) ON 19/32" ORIENTED STRAND BOARD OR EQ. C/W "H" CLIPS ON 2×10 DECK JOISTS @ 16" O/C C/W (PROVIDE ADEQUATE MEMBRANE "UPSTAND" @ EXT. WALL.) (SLOPE JOISTS OR SLOPED WOOD TAPERS TO PROVIDE MIN.1:50 SLOPE) (NOT SHOWN IN SECTION)

Development Permit Presentation

WALLS

W1. DOUBLE GLAZING ENERGY STAR LOW "E" RATING IN THERMAL BREAK FRAMES 2/2"X10" LINTEL OVER (@ BEARING WALLS ONLY) (TYPICAL, WI. 2 1/2" XPS INSULATION) FLASHING OVER @ EXTERIOR (GLAZING IN ALL EXTERIOR DOORS & WITHIN 3 FT. OF EXTERIOR DOORS TO BE SHATTERPROOF (SP)) WINDOW REQUIREMENTS DERIVED FROM BCBC TABLE C-4 AS PER BCBC 9.7.4.3. AND ARE TO BE USED TO SATISFY THE REQUIREMENTS OF AAMA/WDMA/CSA 101/I.S.2/A440, "NAFS": LANGFORD, CLASS R, DP 960, PG 20, WATER RESIST. 220, A2, RATINGS MUST BE CLEARLY LABELED ON ALL WINDOW UNITS UPON INSTALLATION FOR INSPECTION. (NOT SHOWN IN SECTION) W2. CONC. FIBRE BOARD ON 9.5MM (3/8") AIR SPACE / STRAPPING 3/8"×2" BORATE TREATED PLYWOOD STRAPPING HOUSE WRAP (A.B.) (TYVEK OR EQ.) 7/16" ORIENTED STRAND BOARD SHEATHING 2×6 STUDS @ 16" O/C **R-20 INSULATION** 6 MIL. POLYETHYLENE VAPOUR BARRIER 1/2" GYPSUM BOARD (REFER TO DETAILS ON D1) W3. INTERIOR PARTITION 1/2" GYPSUM BOARD ON EACH SIDE OF 2×4 STUDS @ 16" O/C OR 2×6 STUDS @ 16" O/C (IF NOTED) W4. PRE-MANUFACTURED STONE VENEER (INSTALLED TO MANUF. SPEC) LIME BASED MORTAR SETTING BED ON LIME BASED MORTAR SCRATCH COAST ON METAL LATHE INSTALLED HORIZONTALLY OVERLAP HORIZONTAL AND VERTICAL SEAMS 1" SEMI-RIGID BACK BOARD (HAL-TEX RAINBOARD OR EQ.) 9.5MM (3/8") AIR SPACE / STRAPPING 3/8"×2" BORATE TREATED PLYWOOD STRAPPING HOUSE WRAP (A.B.) (TYVEK OR EQ.) 7/16" ORIENTED STRAND BOARD SHEATHING 2×6 STUDS @ 16" (AS REQUIRED) (NOT SHOWN IN SECTION)

W5. 5/8" X-TYPE GYPSUM BOARD ON 2×6 STUDS @ 16" O/C C/W **R-20 INSULATION** 6 MIL. POLY'N V.B 1/2" GYPSUM BOARD (BETWEEN GARAGE & LIVING)

W6. 1/2" GYPSUM BOARD ON 6 MIL. POLY'N V.B. 2×4 STUDS @ 24" O/C C/W **R-12 BATT INSULATION** 2 PLY 30 MINUTE BUILDING PAPER OR 12.7MM (1/2") AIR SPACE (PROVIDE REQUIRED FIRE STOPS IN WALL ASSEMBLIES TO COMPLY WITH B.C. BLDG. CODE 9.10.16.) (NOT SHOWN IN SECTION)

W7. B.C. BUILDING CODE (TABLE 9.10.3.1.A) RATED WALL ASSEMBLY W3c 1 LAYER 1/2" X-TYPE GYPSUM BOARD RESILIENT METAL CHANNELS @ 24" O/C 2×4 STUDS @ 16" O/C OR 2×6 STUDS @ 16" O/C (IF NOTED) C/W 3 1/2" FIBRE GLASS SOUND BATTS 1 LAYER 1/2" X-TYPE GYPSUM BOARD 45 MIN. F.R.R 43 S.T.C (BETWEEN PRIMARY LIVING / GARAGE & SECONDARY SUITE) (NOT SHOWN IN SECTION)

9 design group

#103 - 891ATTREE AVENUE VICTORIA, B.C. V9B 0A6 P. 250.382.7374 F. 250.382.7364

Helm TL

Date Apr. 27, 2023


Project Address 3475 Trumpeter Street Royal Bay - Sector 7 Colwood, B.C. Prepared for


Verity Construction


Project # 8298

Scale As Noted

Drawn By MRB

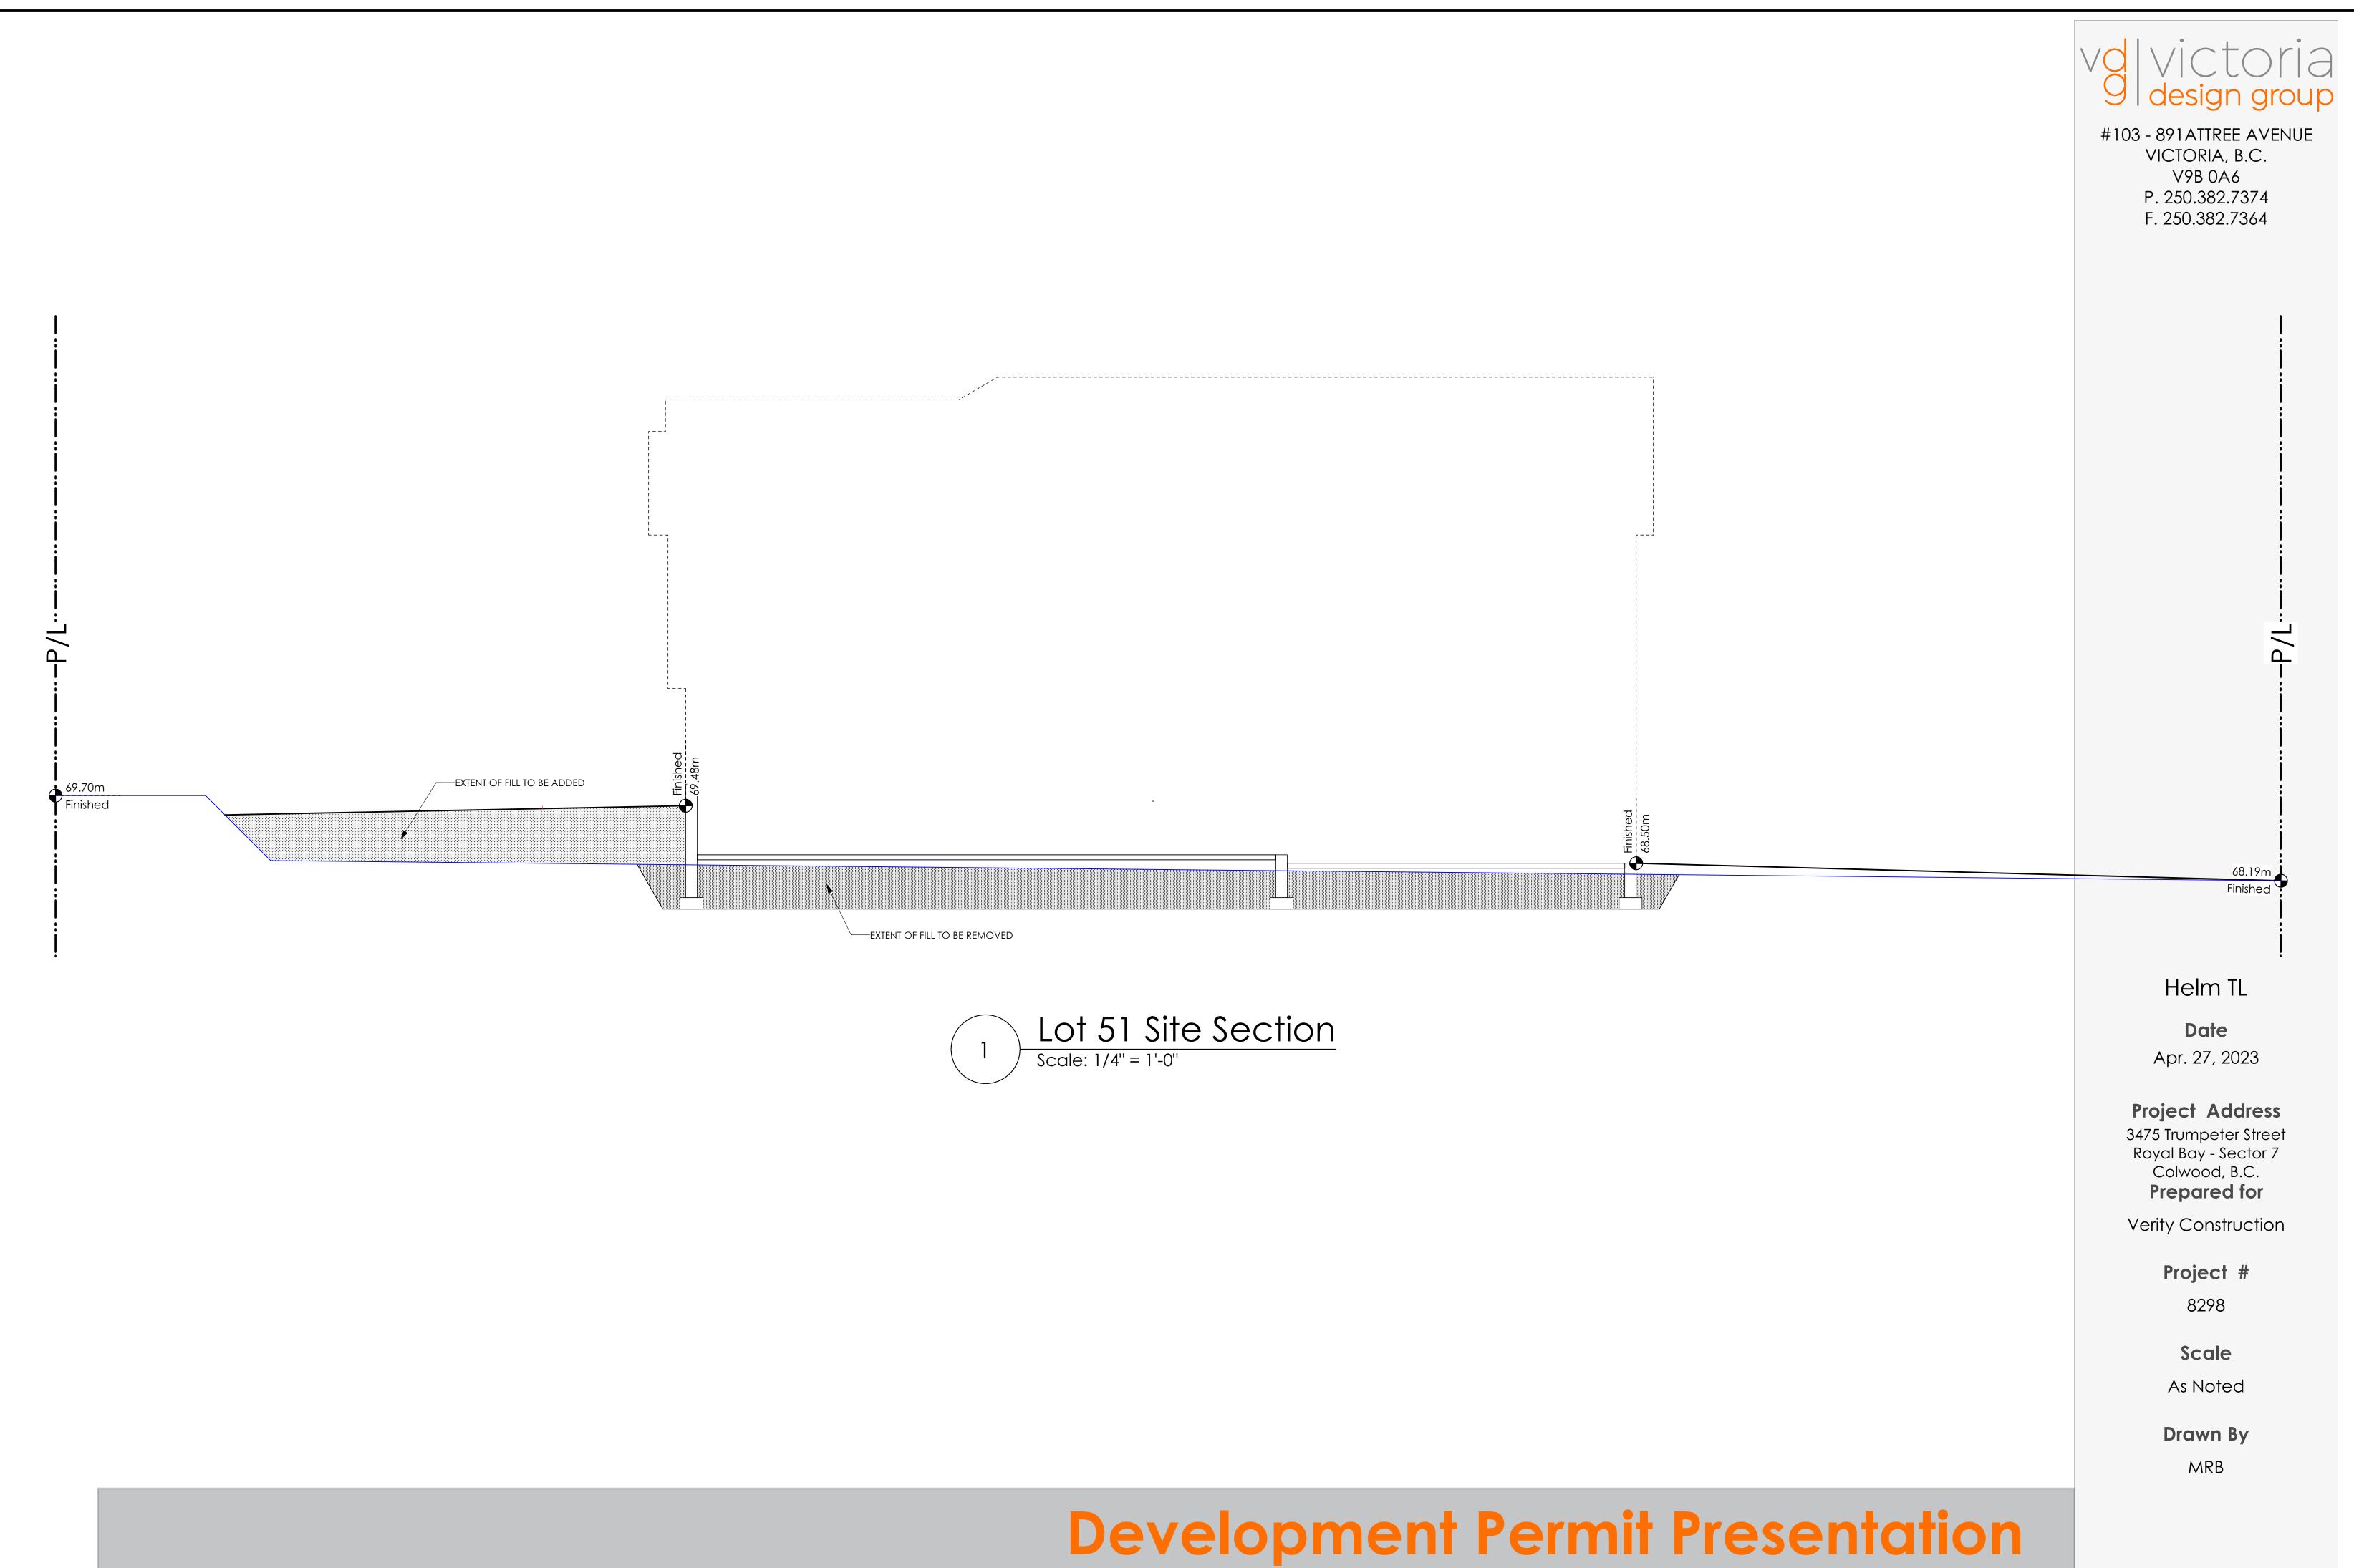

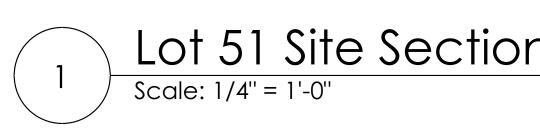

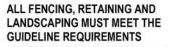

03

04

05

06

07

04/13/23

05/02/23

ALL RETAINING WALLS ARE TO BE STAND ALONE STRUCTURES (THEY MUST TERMINATE AT PROPERTY LINE) AND MUST NOT CONNECT TO RETAINING WALLS LOCATED ON ADJACENT PRIVATE PROPERTIES

NORTH

-00

COMMENTS FROM THE CITY

COMMENTS FROM THE CITY

*NOTE: In the interest of maintaining high standards, the developer reserves the right to modify plans. specifications and design without prior notice. Drawings contained within are artist renderings only. Sizes and dimensions are approximate and may vary with actual plan and survey. Exterior style may change pending municipal approval. Retaining wall location and types may vary and are subject to municipal, engineering or developer discretion. Subject to change without notice. Furniture as shown on plans are for layout purposes only and are not included in the sale.

ITEM

GRAVEL

GARDEN BED

AREA (sf

328


772

%

10%

24%

KEY PLAN NOT TO SCALE

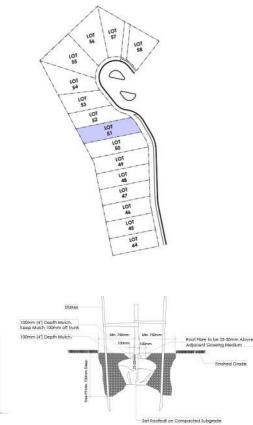

Tree Planting Detail

planted in minimum 10m² of tertile topsoil, 700mm Deep

All trees and plants by the home owner to be

Not To Scale

PRIVACY SHRUBBERY PLANTS AND FOLIAGE TO SCREEN PARKING CONCRETE 1,064 32% AND PROPERTY SOD 1,099 34% 2 GAL / 5 GAL TOTAL 3,263 100% LEGEND UPGRADE SHRUBBERY, PLANTS AND FOLIAGE - 2 GAL - 5 GAL PROPOSED RESIDENCE LOCATION INDICATED BY R LOT 51 1X6 BOARDS CONC. PATIO CONC. PATIO 6X6 WOOD POST PRIVACY SHRUBBERY PLANTS AND FOLIAGE TO SCREEN PARKING AND PROPERTY 2 GAL / 5 GAL 1X6 BOTHSIDES COMPACTED SUBGRADE 1/3RD POST HT. IN CONC. FOOTING ON 75MM OF DRAIN ROCK **Typical Fence Detail** ESTIMATED LOCATION OF REAR Not To Scale FENCING - SUBJECT TO CHANGE ACCORDING TO ACTUAL SITE CONDITIONS *TYPICAL FENCE DETAIL BASED OFF FENCE DETAIL 1/L1 FROM ROYAL BAY DESIGN GUIDELINES PAGE 21 ADDITIONAL NOTES: PROPERTY TO BE IRRIGATED **6" PIPE FOR DRIVEWAY SLEEVES TO** LANDSCAPE PLAN **BE INSTALLED FOR CITY IRRIGATION** NOT TO SCALE LINES DATE MM/DD/YY **ISSUED/REVISED** VERITY PROJECT 10/26/22 GARDEN BED PLANTING LANDSCAPING PLAN 01/13/23 SITE PLAN REVISION CONSTRUCTION LOT 51, 3475 TRUMPETER ST. 03/28/23 COMMENTS FROM THE CITY **ROYAL BAY, SECTOR 7**

CITY OF COLWOOD

QUALITY CONSTRUCTION. TRUSTED SERVICE

106 - 1039 Langford Parkway Victoria, B.C. V9B 0A6


P: 250.474.1039 www.verityconstruction.ca

GABLECRAFT HOMES BUILDING GRADE SLIP

WSP Project No: <u>201-08151-00</u>

Issue Date: _____

ADDRESS 3475 Trumpeter Street	P.I.D.
LOT 51	PLAN
BUILDER VERITY HOMES	SUBDIVISION
ADDRESS	DEVELOPER
REPRESENTATIVE PH.	CONSULTANT WSP CANADA INC
PROPOSED BUILDING GRADES ALL ELEVATIONS ARE METRIC GEODETIC + MAIN FLOOR ELEVATION	PLAN LOT: <u>51</u> PLAN: TRUNNETER ST. CONTRUMPETER ST. CONTRUMPETER ST. CONTRUMPETER ST. CONTRUMPETER ST. CONTRUMPETER ST. CONTRUMPETER ST. CONTRUMPETER ST.
ACTUAL TOP OF FOOTING ELEVATION (ATF) LOWEST PERMITTED TOP OF (BOTTOM OF BASEMENT SLAB FROST WALLS ARE REQUIRED.)	1980 1980
SERVICES FRONT REAR CENTER REFER TO SIZE (mm) WATER Image: Sanitary Im	1989 1980 1980 1980 1980 1980 1980 1980
COMMENTS YES NO	
DRAIN TO SUMP PUMP LIKELY REQUIRED (FOR BASEMENT IF INSTALLED)	STREET STREET II II II II II III IIII IIII IIIIIIIIIIIIIIIIIIIIIIIIIIIIIIIIIIII
 NOTES 1. IT IS THE RESPONSIBILITY OF THE BUILDER TO ENSURE THE FOOTINGS ARE PLACED ON A PROPER BASE THAT IS FREE FROM FROST, EXCESSIVE MOISTURE AND DELETERIOUS MATERIALS AND HAVE APPROPRIATE FROST PROTECTION WHEN COMPLETED. 2. THE INFORMATION CONTAINED HEREIN IS BASED ON THE APPROVED LOT GRADING PLAN FOR THIS SUBDIVISION. UN-AUTHORIZED DEVIATIONS WILL BE THE RESPONSIBILITY OF THE BUILDER TO ENSURE COMPLIANCE WITH ALL LOCAL BYLAWS. 3. OTHER NOTES:	I, THE BUILDER'S REPRESENTATIVE, CERTIFY THAT THE FINAL HOUSE PLANS PROVIDED IN THE BUILDING PERMIT APPLICATION ARE THE SAME AS PROCESSED UNDER THIS GRADE SLIP AND THAT I UNDERSTAND THE INFORMATION AND THE REQUIREMENTS CONTAINED
VSP - May 13, 2022 8:05 AM D:2021/211-00627-00_ROYAL BAY - SECTOR 7/3_TECH/3_CADD/3_SHEETS/211-00627-00-B	HEREIN AND WILL BUILD ACCORDINGLY. AUTHORIZED BUILDER'S REPRESENTATIVE DATE THE INFORMATION CONTAINED HEREIN IS BASED ON THE APPROVED LOT GRADING PLAN FOR THIS SUBDIVISION, DATED C. Hume - Nov. 9/22 ISSUED BY DEVELOPER'S AUTHORIZED REPRESENTATIVE DATE

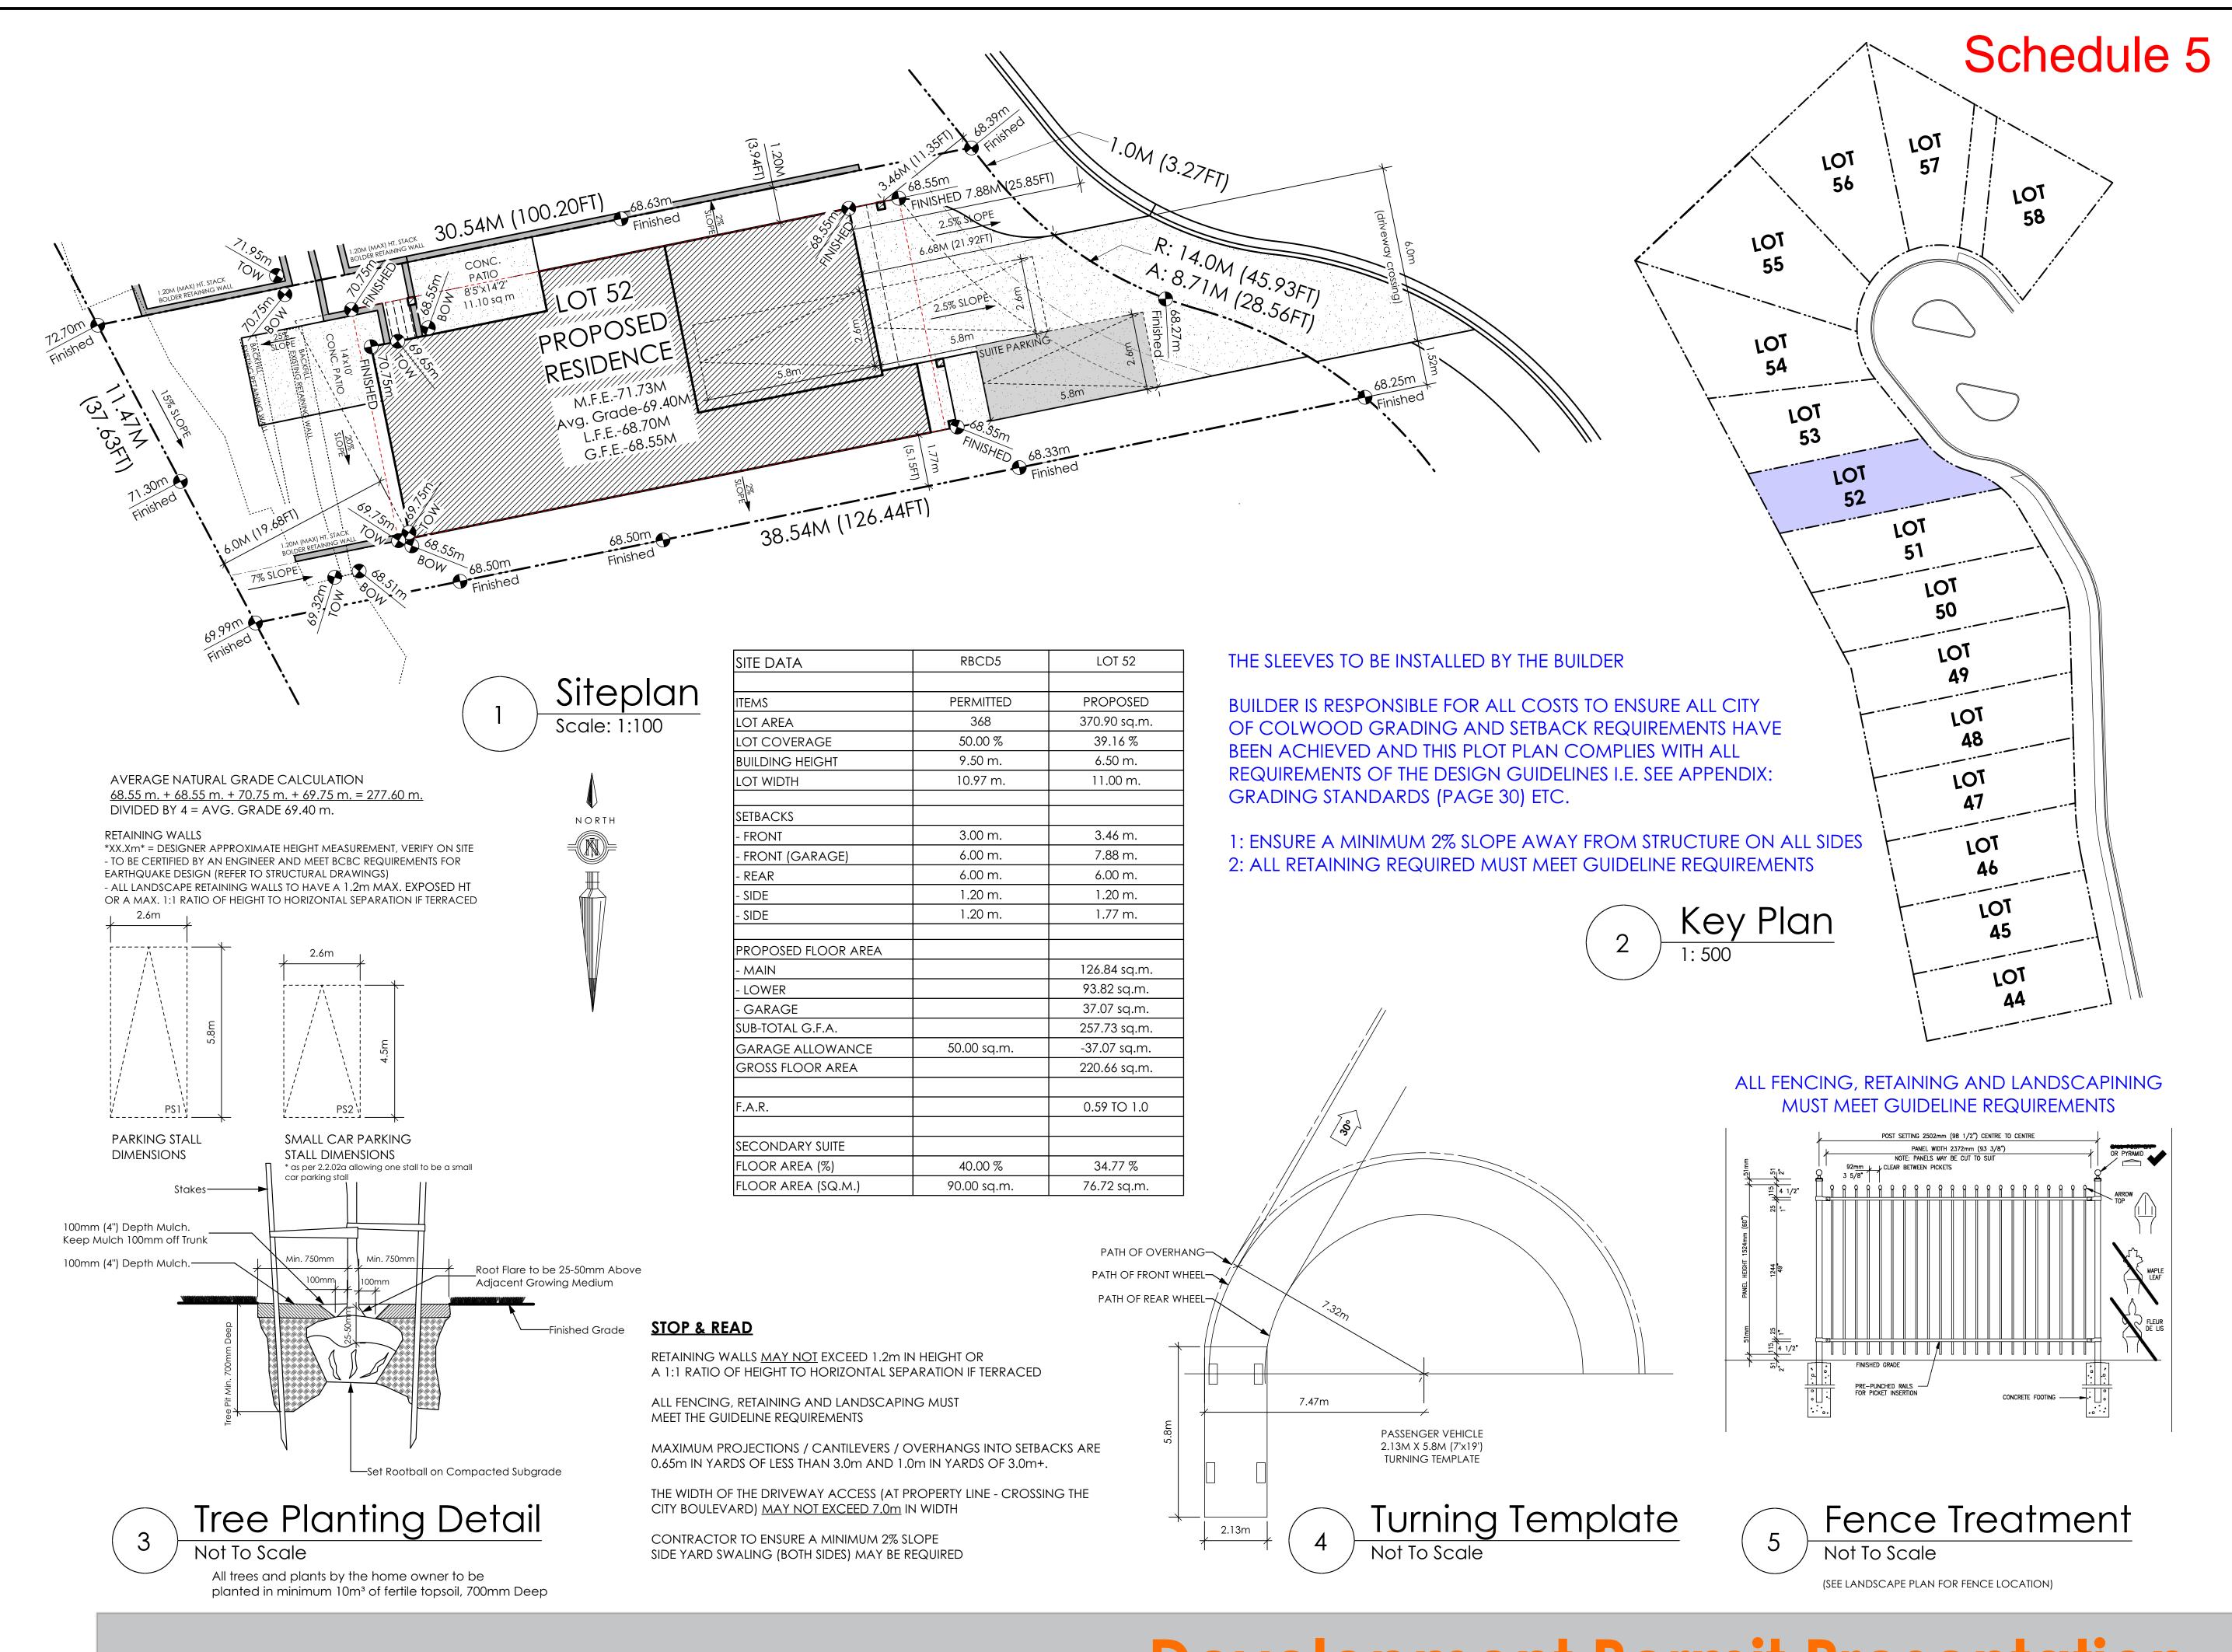

		1
	RBCD5	LOT 52
	PERMITTED	PROPOSED
	368	370.90 sq.m.
	50.00 %	39.16 %
Т	9.50 m.	6.50 m.
	10.97 m.	11.00 m.
	3.00 m.	3.46 m.
€E)	6.00 m.	7.88 m.
	6.00 m.	6.00 m.
	1.20 m.	1.20 m.
	1.20 m.	1.77 m.
DR AREA		
		126.84 sq.m.
		93.82 sq.m.
		37.07 sq.m.
		257.73 sq.m.
/ANCE	50.00 sq.m.	-37.07 sq.m.
REA		220.66 sq.m.
		0.59 TO 1.0
TE		
)	40.00 %	34.77 %
Q.M.)	90.00 sq.m.	76.72 sq.m.





#103 - 891ATTREE AVENUE VICTORIA, B.C. V9B 0A6 P. 250.382.7374 F. 250.382.7364

APPROVED BY VERITY CONSTRUCTION

DATE

APPROVED BY REALTOR

DATE

Helm Westcoast

Date May 2, 2023


Project Address 3477 Trumpeter Street Royal Bay - Sector 7 Colwood, B.C. Prepared for

Verity Construction


Project # 8298

Scale As Noted

Drawn By MRB

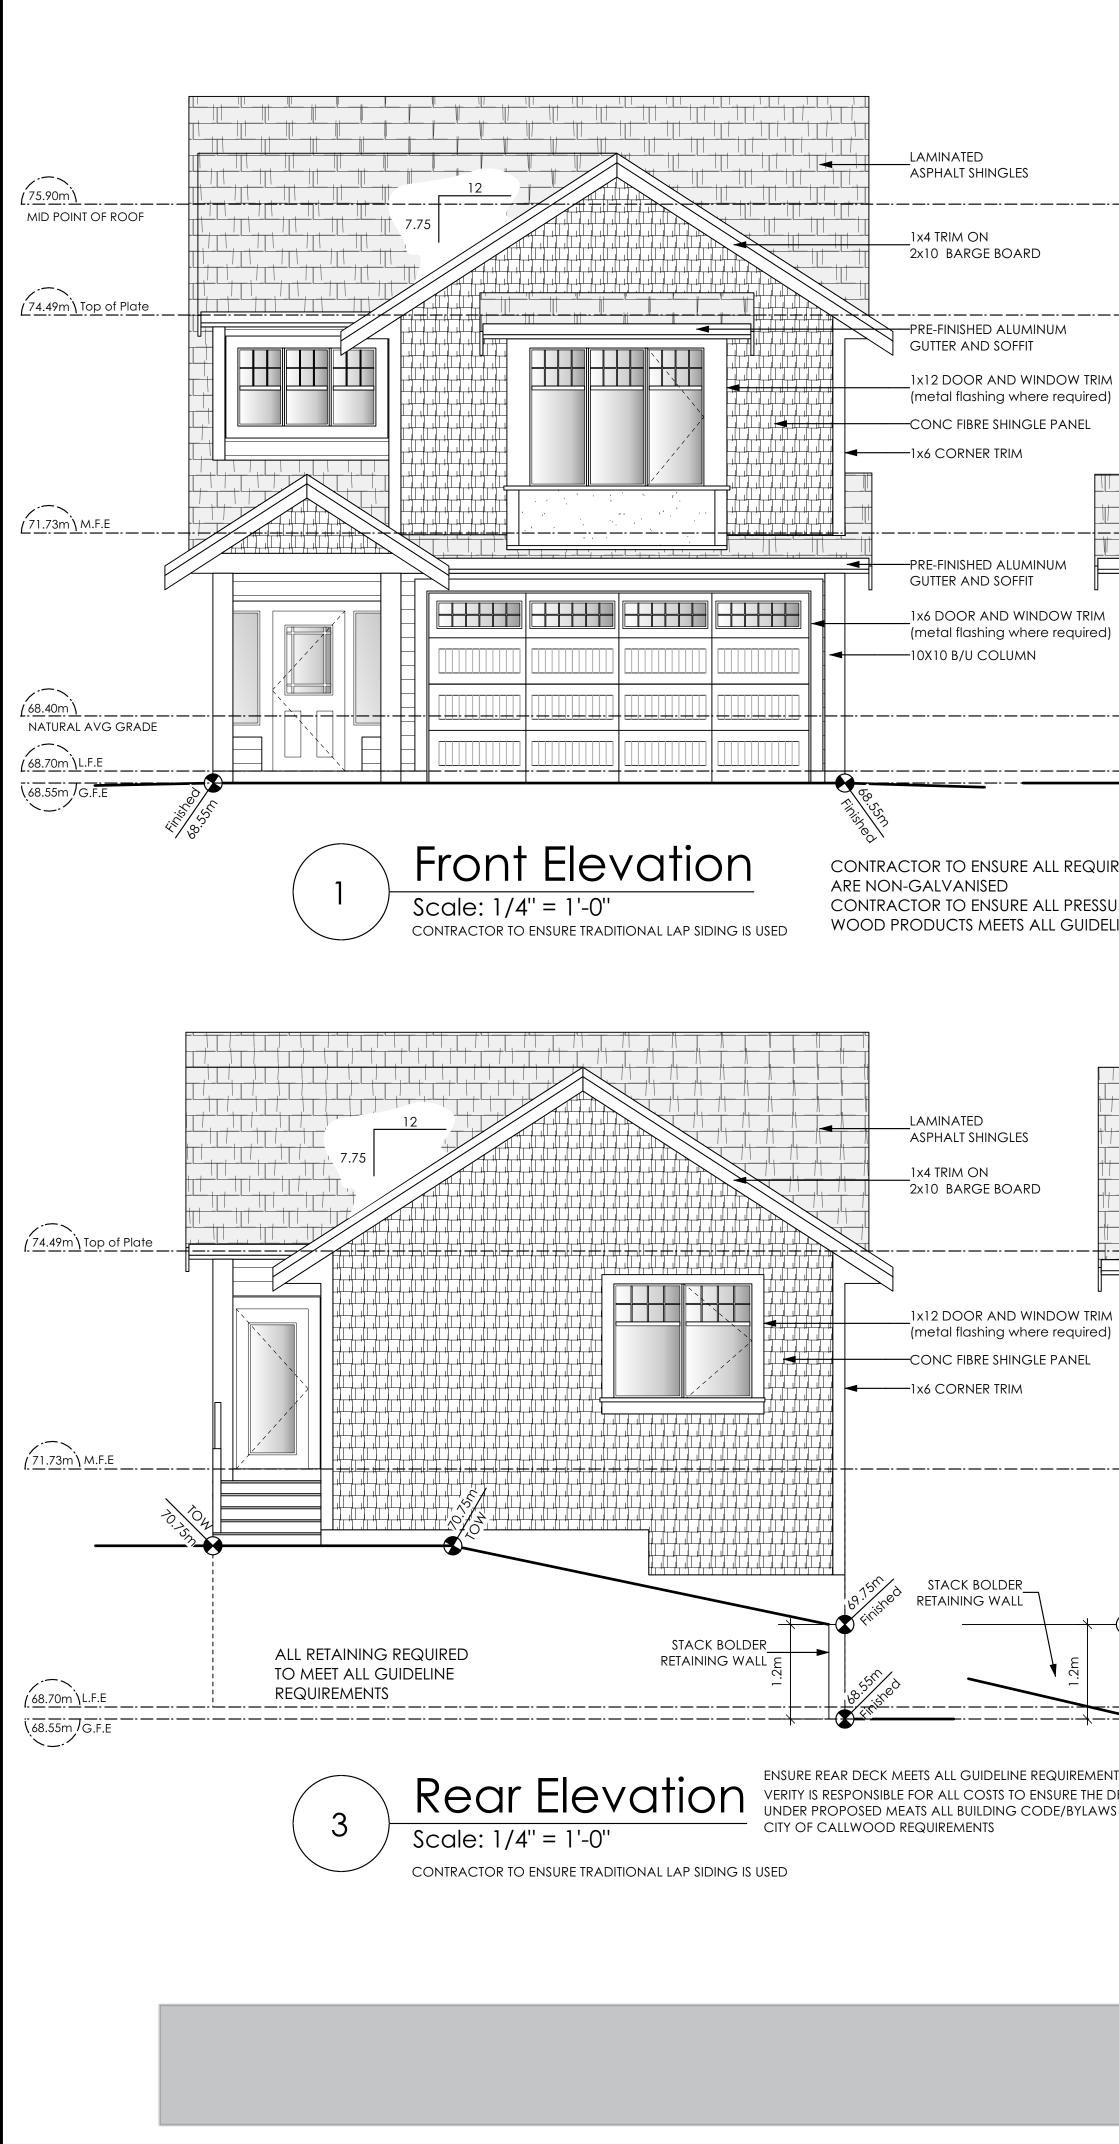

RED FLASHING URE TREATED LINES	$\left(\begin{array}{c} \mathbf{Z} \end{array} \right)$ so	1x6 DOOR AND WINDOW (metal flashing where requ cight Side El cale: 1/4" = 1'-0" NTRACTOR TO ENSURE TRADITIONAL LAF	evation	42" FIN. HT. ALUMI TO COMPLY WI. B Limiting Distance Exposed Building Face Allowable Openings Allowable Opening Area Proposed Openings		۲
NTS DRIVE S &		eft Side Ele cale: 1/4" = 1'-0"	vation	DOOR AND WINDOW TRIM etal flashing where required) Limiting Distance Exposed Building Face Allowable Openings Allowable Opening Area Proposed Openings	1.77 102.09 7.0 7.15 7.12	m. sq.r % sq.r sq.r

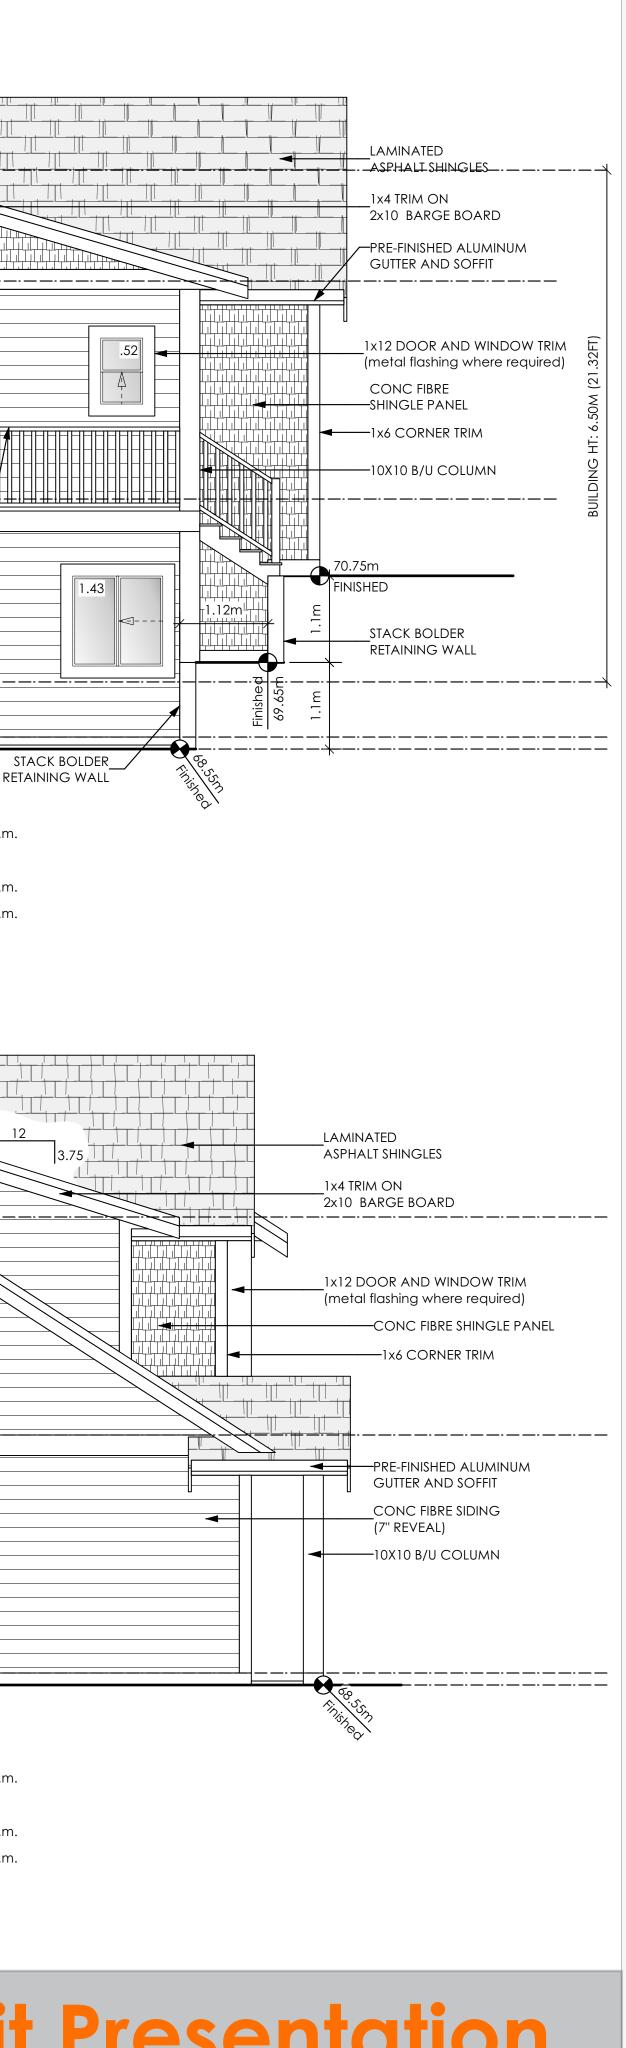

d Victoria design group

#103 - 891ATTREE AVENUE VICTORIA, B.C. V9B 0A6 P. 250.382.7374 F. 250.382.7364

Helm Westcoast

Date May 2, 2023


Project Address 3477 Trumpeter Street Royal Bay - Sector 7 Colwood, B.C. Prepared for


Verity Construction

Project # 8298

Scale As Noted

Drawn By MRB

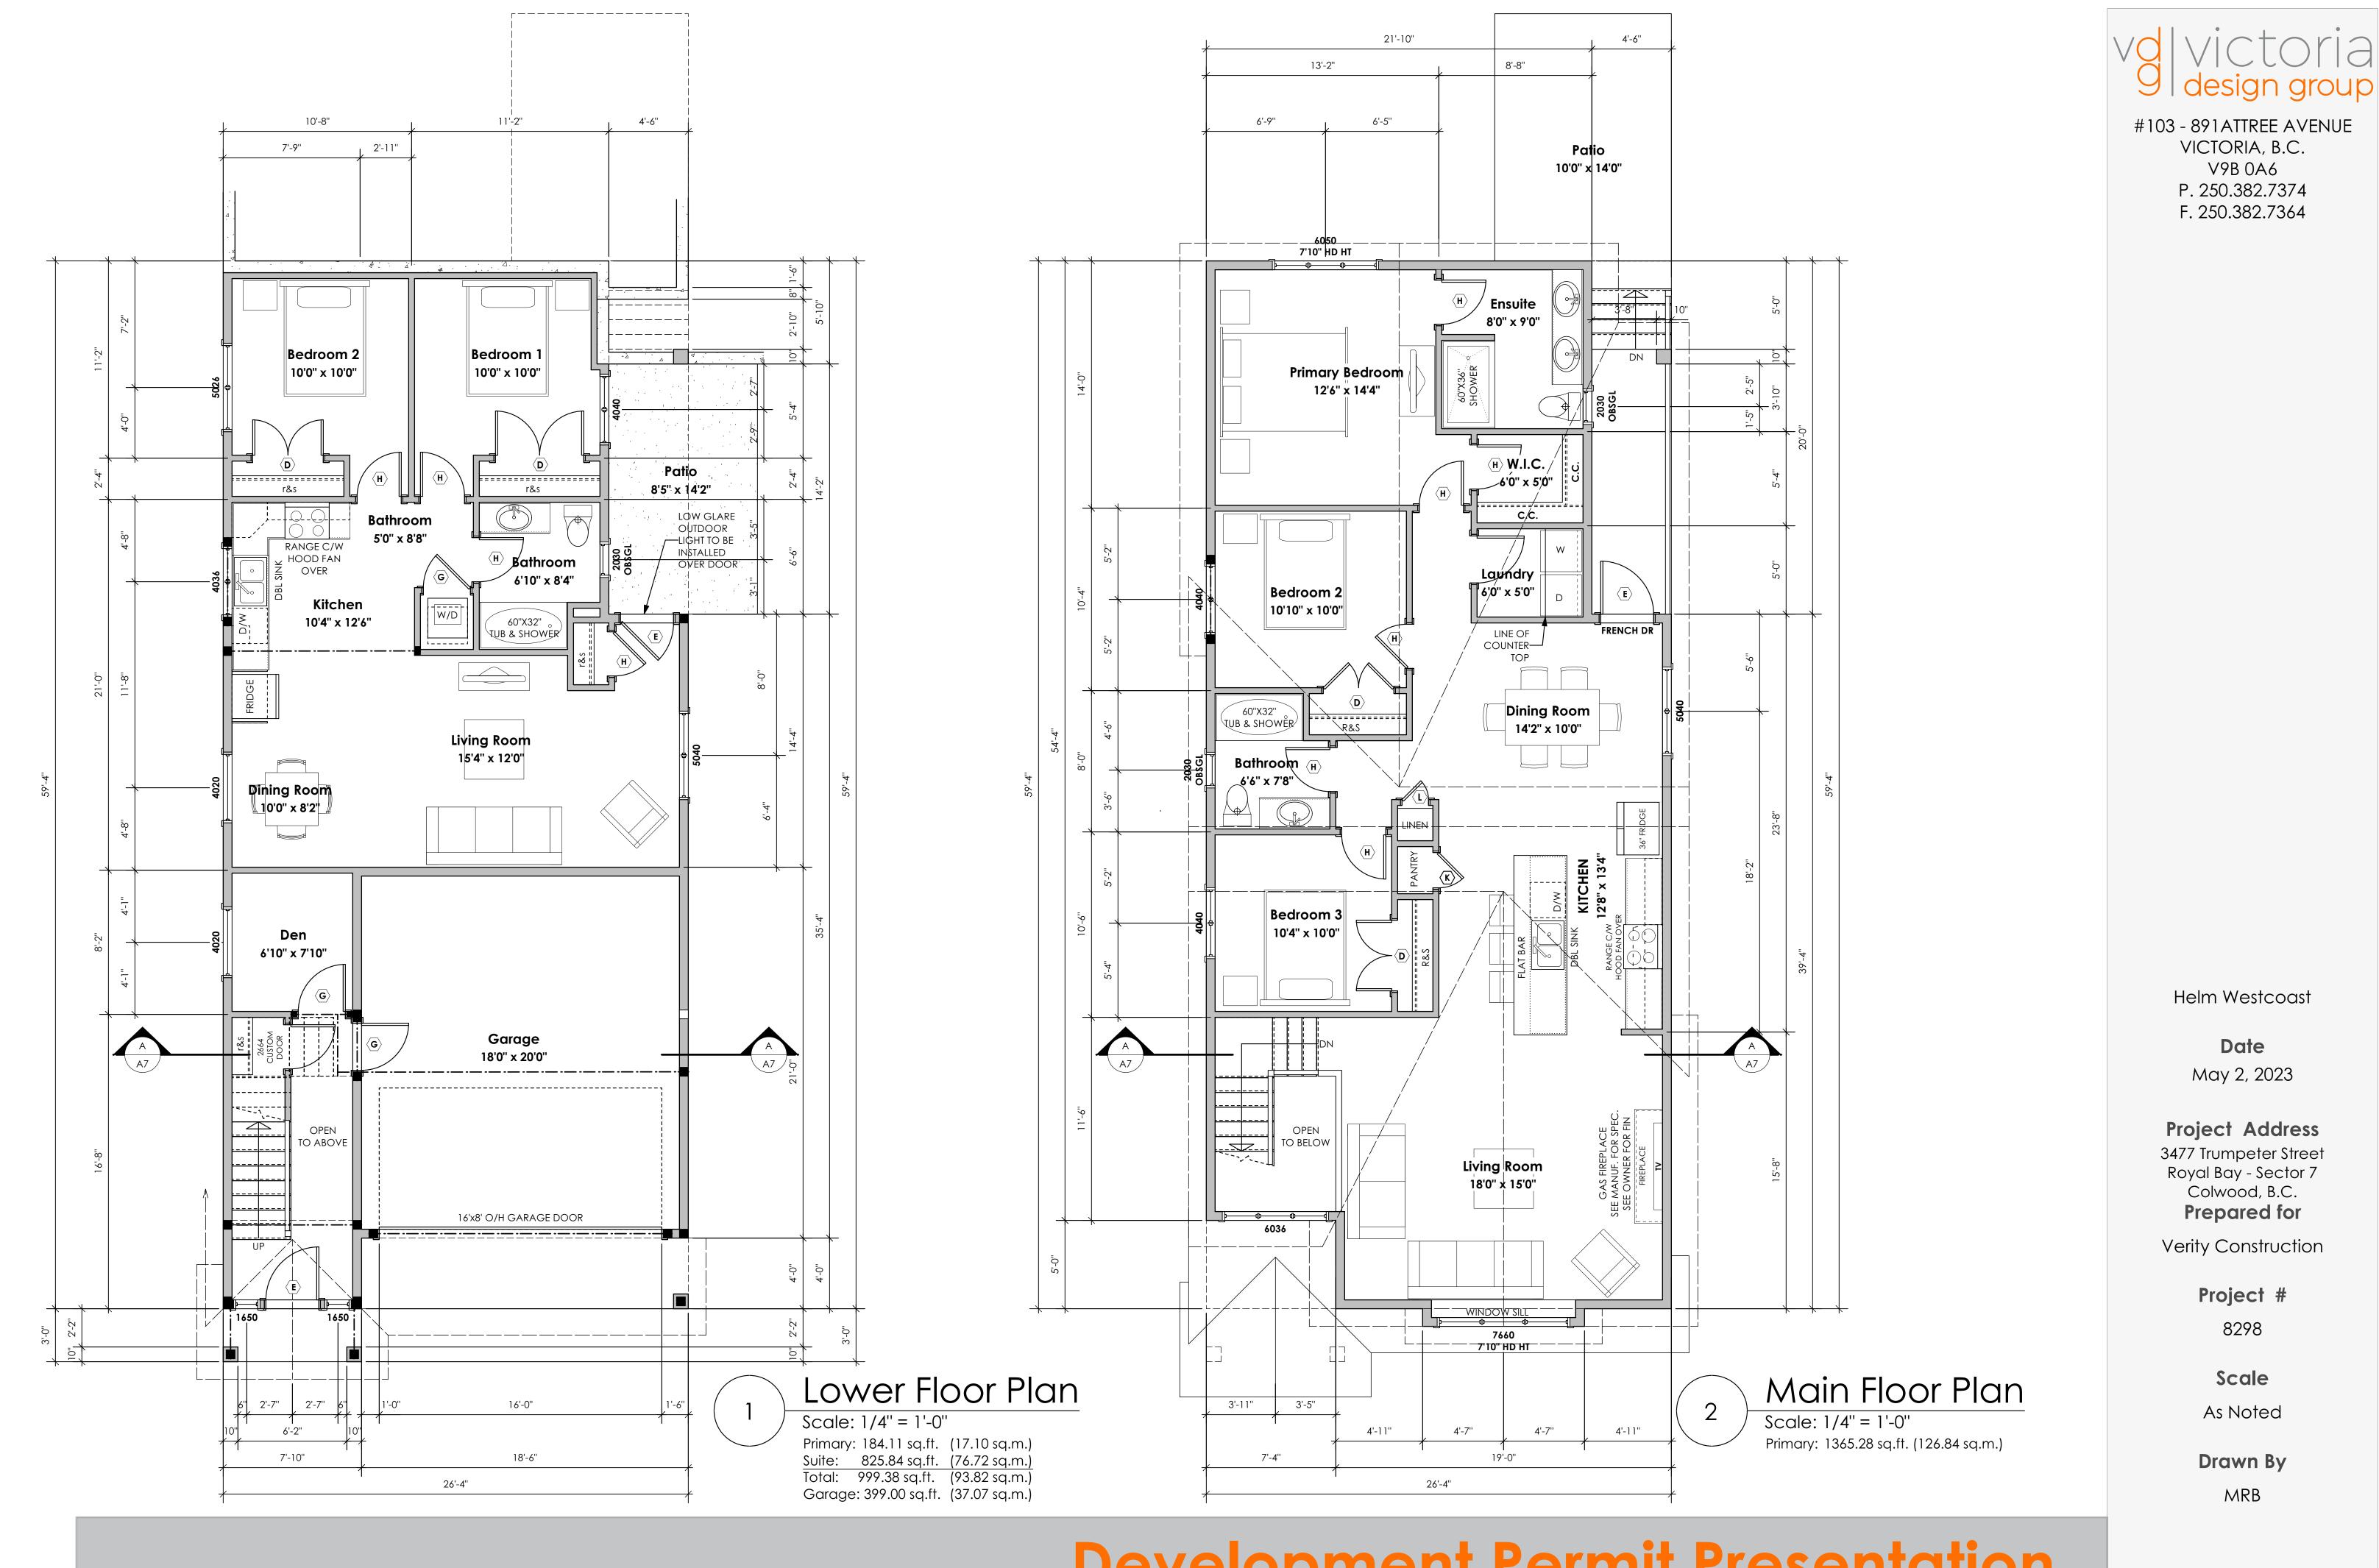

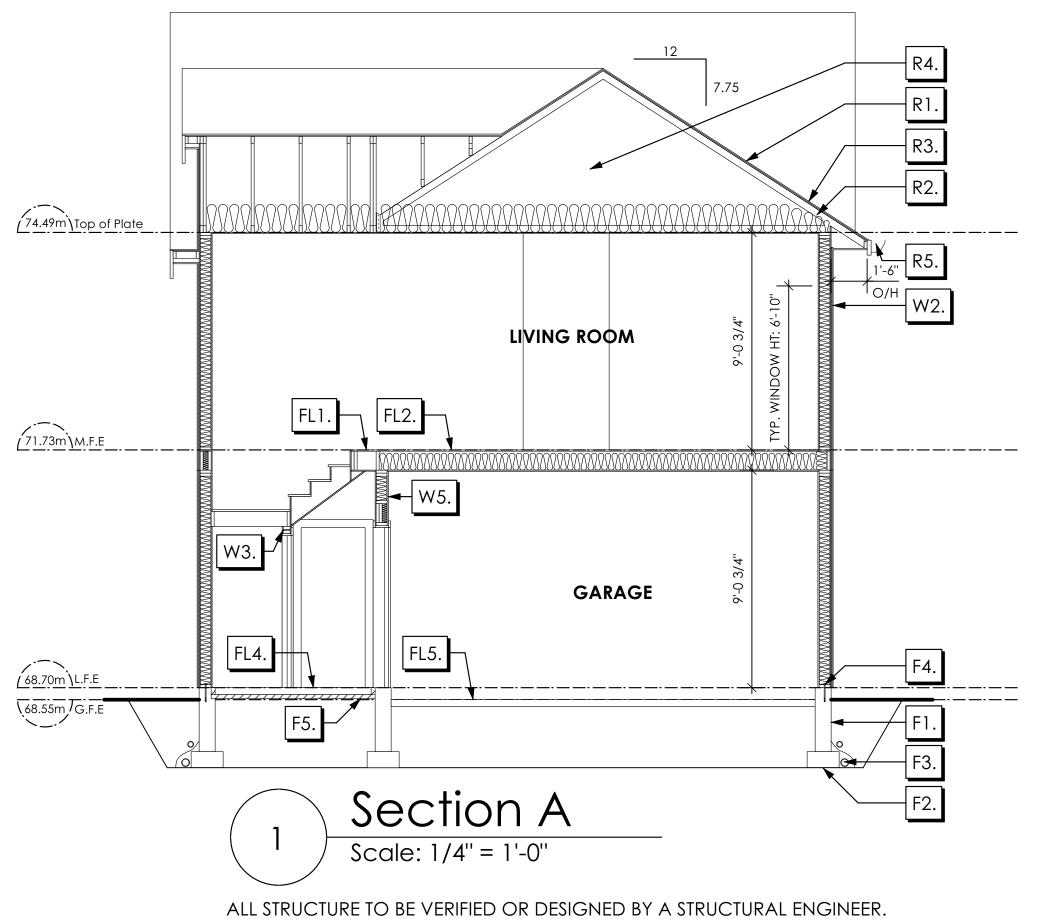

ALL STRUCTURE TO BE VERIFIED OR DESIGNED BY A STRUCTURAL ENGINEER. STRUCTURAL ENGINEER TO LOCATE AND DESIGN WALLS TO RESIST LATERAL LOADS.

ALL STRUCTURE TO BE VERIFIED OR DESIGNED BY A STRUCTURAL ENGINEER. STRUCTURAL ENGINEER TO LOCATE AND DESIGN REQUIRED EXTERIOR AND INTERIOR BRACED WALL PANELS TO RESIST LATERAL LOADS IN COMPLIANCE WITH B.C. BUILDING CODE 9.23.13.2 AND SUPPLY DETAILS IF REQUIRED

FOUNDATION WALLS

- F1. DAMP PROOFING (WHERE REQUIRED) ON 8" THK. CONC. FOUNDATION WALL C/W 15 M BARS @ 24" O/C B/W
- F2. 16"X 8" CONC. FOOTINGS C/W 2 (TWO) 15M BARS CONT. 3 IN. FROM BOTT. ON UNDISTURBED SOIL (SOLID BEARING)
- F3. 4" PERIMETER DRAIN 3" TIGHT PIPE FOR RWL DRAIN ROCK
- F4. ANCHOR BOLTS @ 4.0 FT. O/C MAX C/W SILL GASKETS

F5. UNDER SLAB INSULATION 2 1/2" (RSI 2.15) EXTRUDED POLYSTYRENE RIGID INSULATION 4'-0" (1.2M) CONT. AROUND PERIMETER UNDER SLAB INSTALLED HORIZONTALLY (VERIFY WITH MUNICIPALITY DEPTH OF FROST LINE) (NOT IN SECTION)

ROOFS

- R1. LAMINATED ASPHALT SHINGLES ON 7/16" ORIENTED STRAND BOARD C/W "H" CLIPS WD TRUSSES (DESIGNED BY MANUF.) 14 1/2" FIBRE GLASS LOOSE FILL INSULATION (ALLOW FOR SETTLING) 6 MIL POLY'N V.B. 5/8" GYPSUM BOARD
- R2. PROVIDE 2 1/2" (63MM) CLEAR BETWEEN R-20 INSULATION AND SHEATHING. (MIN. R-20 @ ROOF-WALL CONNECTION FOR 4'-0" (1.2M) AROUND PERIMETER OF BUILDING. AIR VENTILATION BAFFLES TO BE INSTALLED WHERE REQUIRED IN AS PER BCBC 9.19.)
- R3. EAVE PROTECTION CONT. UP ROOF SLOPE FOR 12" PAST EXTERIOR WALL.
- R4. PROVIDE 1 SQ.FT. ATTIC VENT PER 300 SQ.FT. OF INSULATED AREA MIN. 25% OF REQUIRED TO BE @ TOP AND BOTTOM (TO COMPLY WI. B.C. BLDG. CODE 9.19.1)

R5. PRE-FIN. FASCIA GUTTER 2×8 FASCIA BD. 2×4 SUB. FASCIA BD. VENTED SOFFIT (SEE CONTRACTOR)

Section Notes

FLOORS

FL1.	FINISHED FLOORING ON 11/16" ORIENTED STRAND BOARD (NAILED & GLUED TO FLOOR STRUCT. BELOW) ON 2×10 FLOOR JOISTS @ 16" OR 12" O/C C/W 2×2 X-BRIDGING @ 7.0' O/C (MAX) 1/2" GYPSUM BOARD	W1.	DOU ENER THER 2/2"X (TYPI FLASI (GLA
FL2.	FINISHED FLOORING ON 11/16" ORIENTED STRAND BOARD (NAILED & GLUED TO FLOOR STRUCT. BELOW) ON 2×10 FLOOR JOISTS @ 16" OR 12" O/C C/W 2×2 X-BRIDGING @ 7.0' O/C (MAX) R-31 INSULATION 5/8" X-TYPE GYPSUM BOARD (BETWEEN GARAGE AND LIVING SPACE)		OF EX WINE TABLI USED AAM LANC RATIN WINE (NOT
FL3.	FINISHED FLOORING ON 19/32" ORIENTED STRAND BOARD (FASTENED & GLUED TO FLOOR STRUCT. BELOW) ON 2×10 FLOOR JOISTS @ 16" OR 12" O/C C/W 2×2 X-BRIDGING @ 7.0' O/C (MAX) PROVIDE R-31 F/G BATT INSULATION IN JOIST CAVITY C/W BUILDING WRAP VENTED SOFFIT (TO OWNERS SPEC'S) TO ALL SUSPENDED FLOOR AREAS (NOT SHOWN IN SECTION)	W2.	CON 9.5M 3/8"× HOU 7/16' 2×65 R-20 6 MII 1/2" (REFE
FL4.	3 1/2" CONCRETE SLAB 6 MIL. POLY'N V.B. 6" COMPACTED GRAVEL OR SAND	W3.	INTER 1/2" OF 2 2×6 \$
FL5.	3 1/2" CONCRETE SLAB 6 MIL. POLY'N V.B. 6" COMPACTED GRAVEL OR SAND SLOPE TO DOORS 1"	W4.	PRE-/ (INST LIME LIME
FL6.	F8d RATED FLOOR ASSEMBLY (BC BUILDING CODE TABLE 9.10.3.1.B) FINISHED FLOORING ON 19/32" ORIENTED STRAND BOARD OR EQ. (FASTENED & GLUED TO FLOOR STRUCT. BELOW) ON 2×10 FLOOR JOISTS @ 16" OR 12" O/C C/W 2×2 X-BRIDGING @ 7.0' O/C (MAX) R-31 INSULATION RESILIENT METAL CHANNELS @ 24" O/C 1 LAYERS 5/8" X-TYPE GYPSUM BOARD 30 MINUTE F.R.R., 50 S.T.C.		MET/ OVE SEMI (HAL 9.5M 3/8"× HOU 7/16' 2×6 S (NO1
FL7.	(NOT SHOWN IN SECTION) DECKING MEMBRANE (TO COMPLY WITH CAN/CGSB 37.54) ON 19/32" ORIENTED STRAND BOARD OR EQ. C/W "H" CLIPS ON	W5.	5/8" 2×6 S R-20 6 MIL 1/2" (BETV
	2×10 DECK JOISTS @ 16" O/C C/W (PROVIDE ADEQUATE MEMBRANE "UPSTAND" @ EXT. WALL.) (SLOPE JOISTS OR SLOPED WOOD TAPERS TO PROVIDE MIN.1:50 SLOPE) (NOT SHOWN IN SECTION)	W6.	1/2" 6 MIL 2×4 S R-12 2 PLV 12.7h (PRC ASSE B.C. (NO1
		W7.	B.C. Rate 1 La`

Development Permit Presentation

WALLS

UBLE GLAZING ERGY STAR LOW "E" RATING IN ERMAL BREAK FRAMES 2"X10" LINTEL OVER (@ BEARING WALLS ONLY) PICAL, WI. 2 1/2" XPS INSULATION) SHING OVER @ EXTERIOR LAZING IN ALL EXTERIOR DOORS & WITHIN 3 FT. EXTERIOR DOORS TO BE SHATTERPROOF (SP)) NDOW REQUIREMENTS DERIVED FROM BCBC BLE C-4 AS PER BCBC 9.7.4.3. AND ARE TO BE ED TO SATISFY THE REQUIREMENTS OF MA/WDMA/CSA 101/I.S.2/A440, "NAFS": NGFORD, CLASS R, DP 960, PG 20, WATER RESIST. 220, A2, TINGS MUST BE CLEARLY LABELED ON ALL NDOW UNITS UPON INSTALLATION FOR INSPECTION. OT SHOWN IN SECTION) NC. FIBRE BOARD ON MM (3/8") AIR SPACE / STRAPPING 3"×2" BORATE TREATED PLYWOOD STRAPPING DUSE WRAP (A.B.) (TYVEK OR EQ.) 16" ORIENTED STRAND BOARD SHEATHING 6 STUDS @ 16'' O/C 20 INSULATION MIL. POLYETHYLENE VAPOUR BARRIER ' GYPSUM BOARD EFER TO DETAILS ON D1) ERIOR PARTITION " GYPSUM BOARD ON EACH SIDE F 2×4 STUDS @ 16'' O/C OR 6 STUDS @ 16" O/C (IF NOTED) E-MANUFACTURED STONE VENEER STALLED TO MANUF. SPEC) E BASED MORTAR SETTING BED ON E BASED MORTAR SCRATCH COAST ON TAL LATHE INSTALLED HORIZONTALLY ERLAP HORIZONTAL AND VERTICAL SEAMS 1" MI-RIGID BACK BOARD L-TEX RAINBOARD OR EQ.) IMM (3/8") AIR SPACE / STRAPPING 3"×2" BORATE TREATED PLYWOOD STRAPPING DUSE WRAP (A.B.) (TYVEK OR EQ.) 16" ORIENTED STRAND BOARD SHEATHING STUDS @ 16" (AS REQUIRED) OT SHOWN IN SECTION) " X-TYPE GYPSUM BOARD ON 6 STUDS @ 16" O/C C/W 20 INSULATION MIL. POLY'N V.B " GYPSUM BOARD TWEEN GARAGE & LIVING) " GYPSUM BOARD ON MIL. POLY'N V.B. 4 STUDS @ 24" O/C C/W 2 BATT INSULATION PLY 30 MINUTE BUILDING PAPER OR 7MM (1/2") AIR SPACE ROVIDE REQUIRED FIRE STOPS IN WALL EMBLIES TO COMPLY WITH . BLDG. CODE 9.10.16.) DT SHOWN IN SECTION) . BUILDING CODE (TABLE 9.10.3.1.A) TED WALL ASSEMBLY W3c 1 LAYER 1/2" X-TYPE GYPSUM BOARD RESILIENT METAL CHANNELS @ 24" O/C

2×4 STUDS @ 16" O/C OR 2×6 STUDS @ 16" O/C (IF NOTED) C/W 3 1/2" FIBRE GLASS SOUND BATTS 1 LAYER 1/2" X-TYPE GYPSUM BOARD 45 MIN. F.R.R 43 S.T.C (BETWEEN PRIMARY LIVING / GARAGE & SECONDARY SUITE) (NOT SHOWN IN SECTION)

/d|victoria g|design group

#103 - 891ATTREE AVENUE VICTORIA, B.C. V9B 0A6 P. 250.382.7374 F. 250.382.7364

Helm Westcoast

Date May 2, 2023


Project Address 3477 Trumpeter Street Royal Bay - Sector 7 Colwood, B.C. Prepared for

Verity Construction

Project # 8298

Scale As Noted

Drawn By MRB

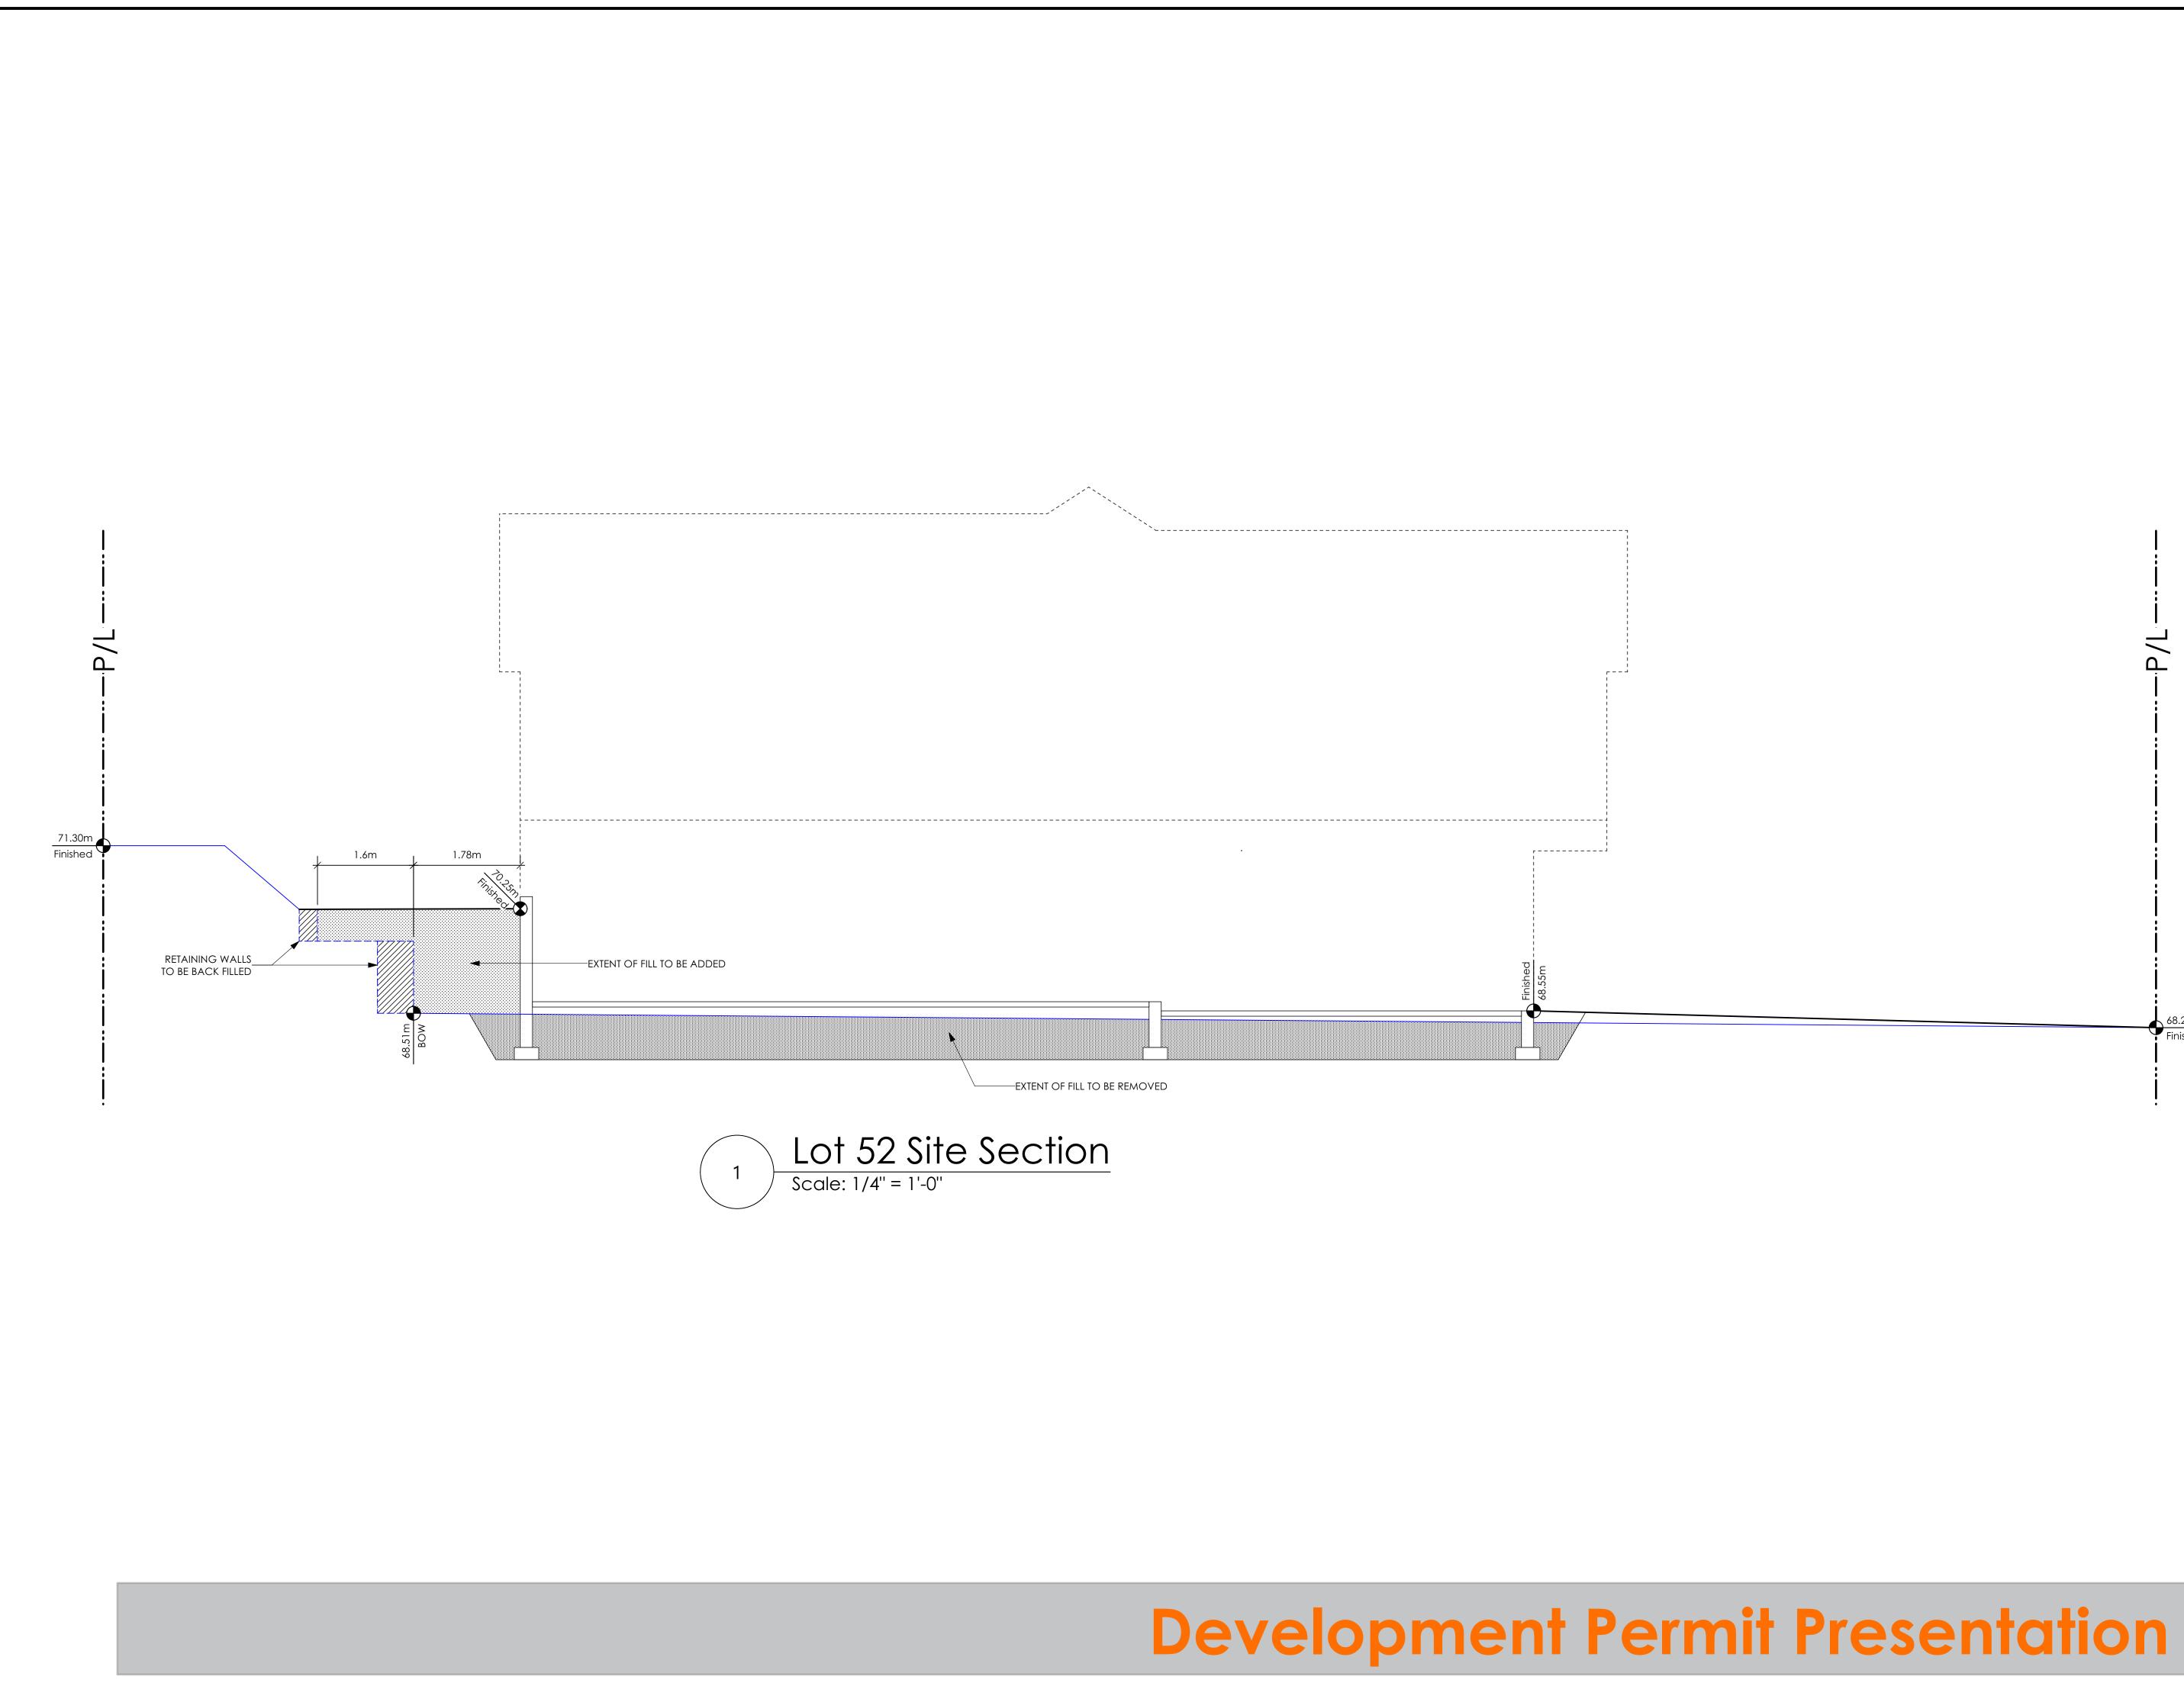



#103 - 891ATTREE AVENUE VICTORIA, B.C. V9B 0A6 P. 250.382.7374 F. 250.382.7364

68.27m Finished

Helm Westcoast

Date May 2, 2023

Project Address 3477 Trumpeter Street Royal Bay - Sector 7 Colwood, B.C. **Prepared for**

Verity Construction

Project # 8298

Scale As Noted

Drawn By MRB

ALL FENCING, RETAINING AND LANDSCAPING MUST MEET THE **GUIDELINE REQUIREMENTS**

03

04


05

06

ALL RETAINING WALLS ARE TO BE STAND ALONE STRUCTURES (THEY MUST TERMINATE AT PROPERTY LINE) AND MUST NOT CONNECT TO RETAINING WALLS LOCATED ON ADJACENT PRIVATE PROPERTIES

*NOTE: In the interest of maintaining high standards, the developer reserves the right to modify plans. specifications and design without prior notice. Drawings contained within are artist renderings only. Sizes and dimensions are approximate and may vary with actual

KEY PLAN NOT TO SCALE

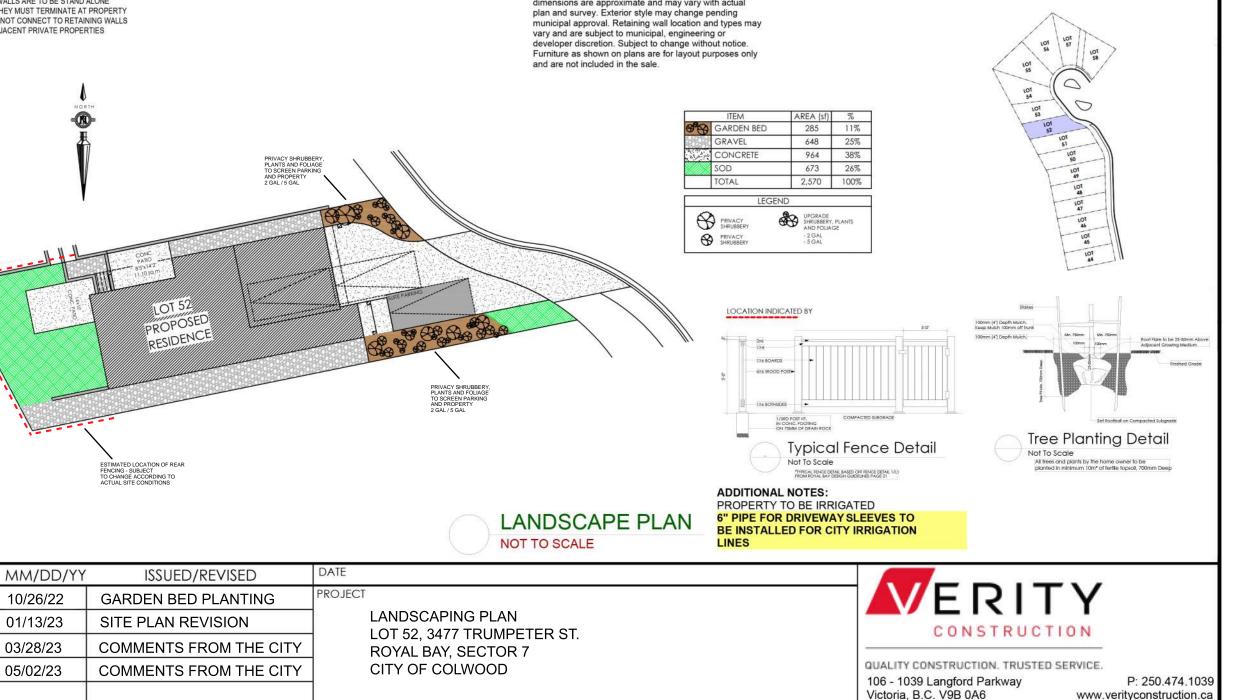



GABLECRAFT HOMES BUILDING GRADE SLIP

WSP Project No: <u>201-08151-00</u>

Issue Date: _____

ADDRESS 3477 Trumpeter Street	P.I.D.
LOT	PLAN
BUILDER VERITY HOMES	SUBDIVISION
ADDRESS	ROYAL BAY SECTOR 7 DEVELOPER
REPRESENTATIVE PH.	CONSULTANT
PROPOSED BUILDING GRADES	PLAN
ALL ELEVATIONS ARE METRIC GEODETIC +	LOT: <u>52</u> PLAN:
MAIN FLOOR ELEVATION	
FRONT ELEV. 68.50 REAR ELEV. 70.30/71.51/70.50 JOIST DEPTH (FINISHED GRADE) (FINISHED GRADE) (FINISHED GRADE) (FINISHED GRADE) (FINISHED GRADE)	The second se
FINISHED GRADE) (FINISHED GRADE)	
W	
HEADROOM	
-	
ELEVATION (ATF)	
LOWEST PERMITTED TOP OF <u>not provided</u> FLOOR SLAB FOOTING ELEVATION (LTF) (BOTTOM OF BASEMENT SLAB	$\begin{array}{cccccccccccccccccccccccccccccccccccc$
FROST WALLS ARE REQUIRED.)	Grad bit with the second sec
SERVICES FRONT REAR CENTER REFER SIZE TO PLAN (mm)	BF SROW
WATER	
SANITARY X	
STORM	12-72.7 TO.O
COMMENTS YES NO	
DRAIN TO SUMP PUMP LIKELY REQUIRED (FOR BASEMENT IF INSTALLED)	
SEWER TO SUMP PUMP LIKELY REQUIRED	<u>LEGEND</u> STREET
(FOR BASEMENT IF INSTALLED)	
FOUNDATION SOIL BEARING INVESTIGATION	II I II I – SERVICE LOCATION (SHOWN ON ABOVE PLAN)
GEOTECHNICAL RESTRICTIONS APPLY	$\left[-\frac{\omega}{\omega}\right] - \frac{\omega}{\omega} - \frac{\omega}{\omega} - \frac{\omega}{\omega} - \frac{\omega}{\omega}$
(SEE GEOTECHNICAL REPORT)	
ENVIRONMENTAL RESTRICTIONS APPLY (SEE ENVIRONMENTAL REPORT)	$\begin{array}{cccc} & & & \\ & & & & \\ & & & \\ & & $
UTILITY EASEMENTS AFFECT THIS LOT	LFE/MFE 47.70 - LOWER/MAIN FLOOR ELEVATION GFE 47.55 - GARAGE FLOOR ELEVATION
	MSE 52.20 - MINIMUM SANITARY SERVICABLE
	S 49.12 (P) – SAN SERVICE INV.
	(P) DENOTES PUMP IS LIKELY REQUIRED FOR BASEMENT IF INSTALLED FOR STORM SERVICE INV.
	(P) DENOTES PUMP IS LIKELY REQUIRED
	L CONTRACTOR - PROPOSED REAR SIDE YARD GRADES
NOTES	– LOT TYPE (L/LB/LBT) PROPOSED REAR_CORNER_ELEVATIONS
 IT IS THE RESPONSIBILITY OF THE BUILDER TO ENSURE THE FOOTINGS ARE PLACED ON A PROPER BASE THAT IS FREE FROM FROST, EXCESSIVE MOISTURE AND DELETERIOUS MATERIALS AND HAVE APPROPRIATE FROST PROTECTION WHEN COMPLETED. 	LANE/LOT
 THE INFORMATION CONTAINED HEREIN IS BASED ON THE APPROVED LOT GRADING PLAN FOR THIS SUBDIVISION. UN-AUTHORIZED DEVIATIONS WILL BE THE RESPONSIBILITY OF THE BUILDER TO ENSURE COMPLIANCE WITH ALL LOCAL BYLAWS. 	I, THE BUILDER'S REPRESENTATIVE,
3. OTHER NOTES:	CERTIFY THAT THE FINAL HOUSE PLANS PROVIDED IN THE BUILDING PERMIT APPLICATION ARE THE SAME AS PROCESSED UNDER THIS GRADE SLIP AND THAT I UNDERSTAND THE INFORMATION AND THE REQUIREMENTS CONTAINED
	HEREIN AND WILL BUILD ACCORDINGLY.
	AUTHORIZED BUILDER'S REPRESENTATIVE DATE
	THE INFORMATION CONTAINED HEREIN IS BASED ON THE APPROVED LOT GRADING PLAN FOR THIS SUBDIVISION, DATED
	C. Hume - Nov. 9/22
WSP - May 13, 2022 8:06 AM D:\2021\211-00627-00_ROYAL BAY - SECTOR 7\3_TECH\3_CADD\3_SHEETS\211-00627-00-R	ISSUED BY DEVELOPER'S AUTHORIZED REPRESENTATIVE DATE UILDING-GRADE-SLIPS.DWG

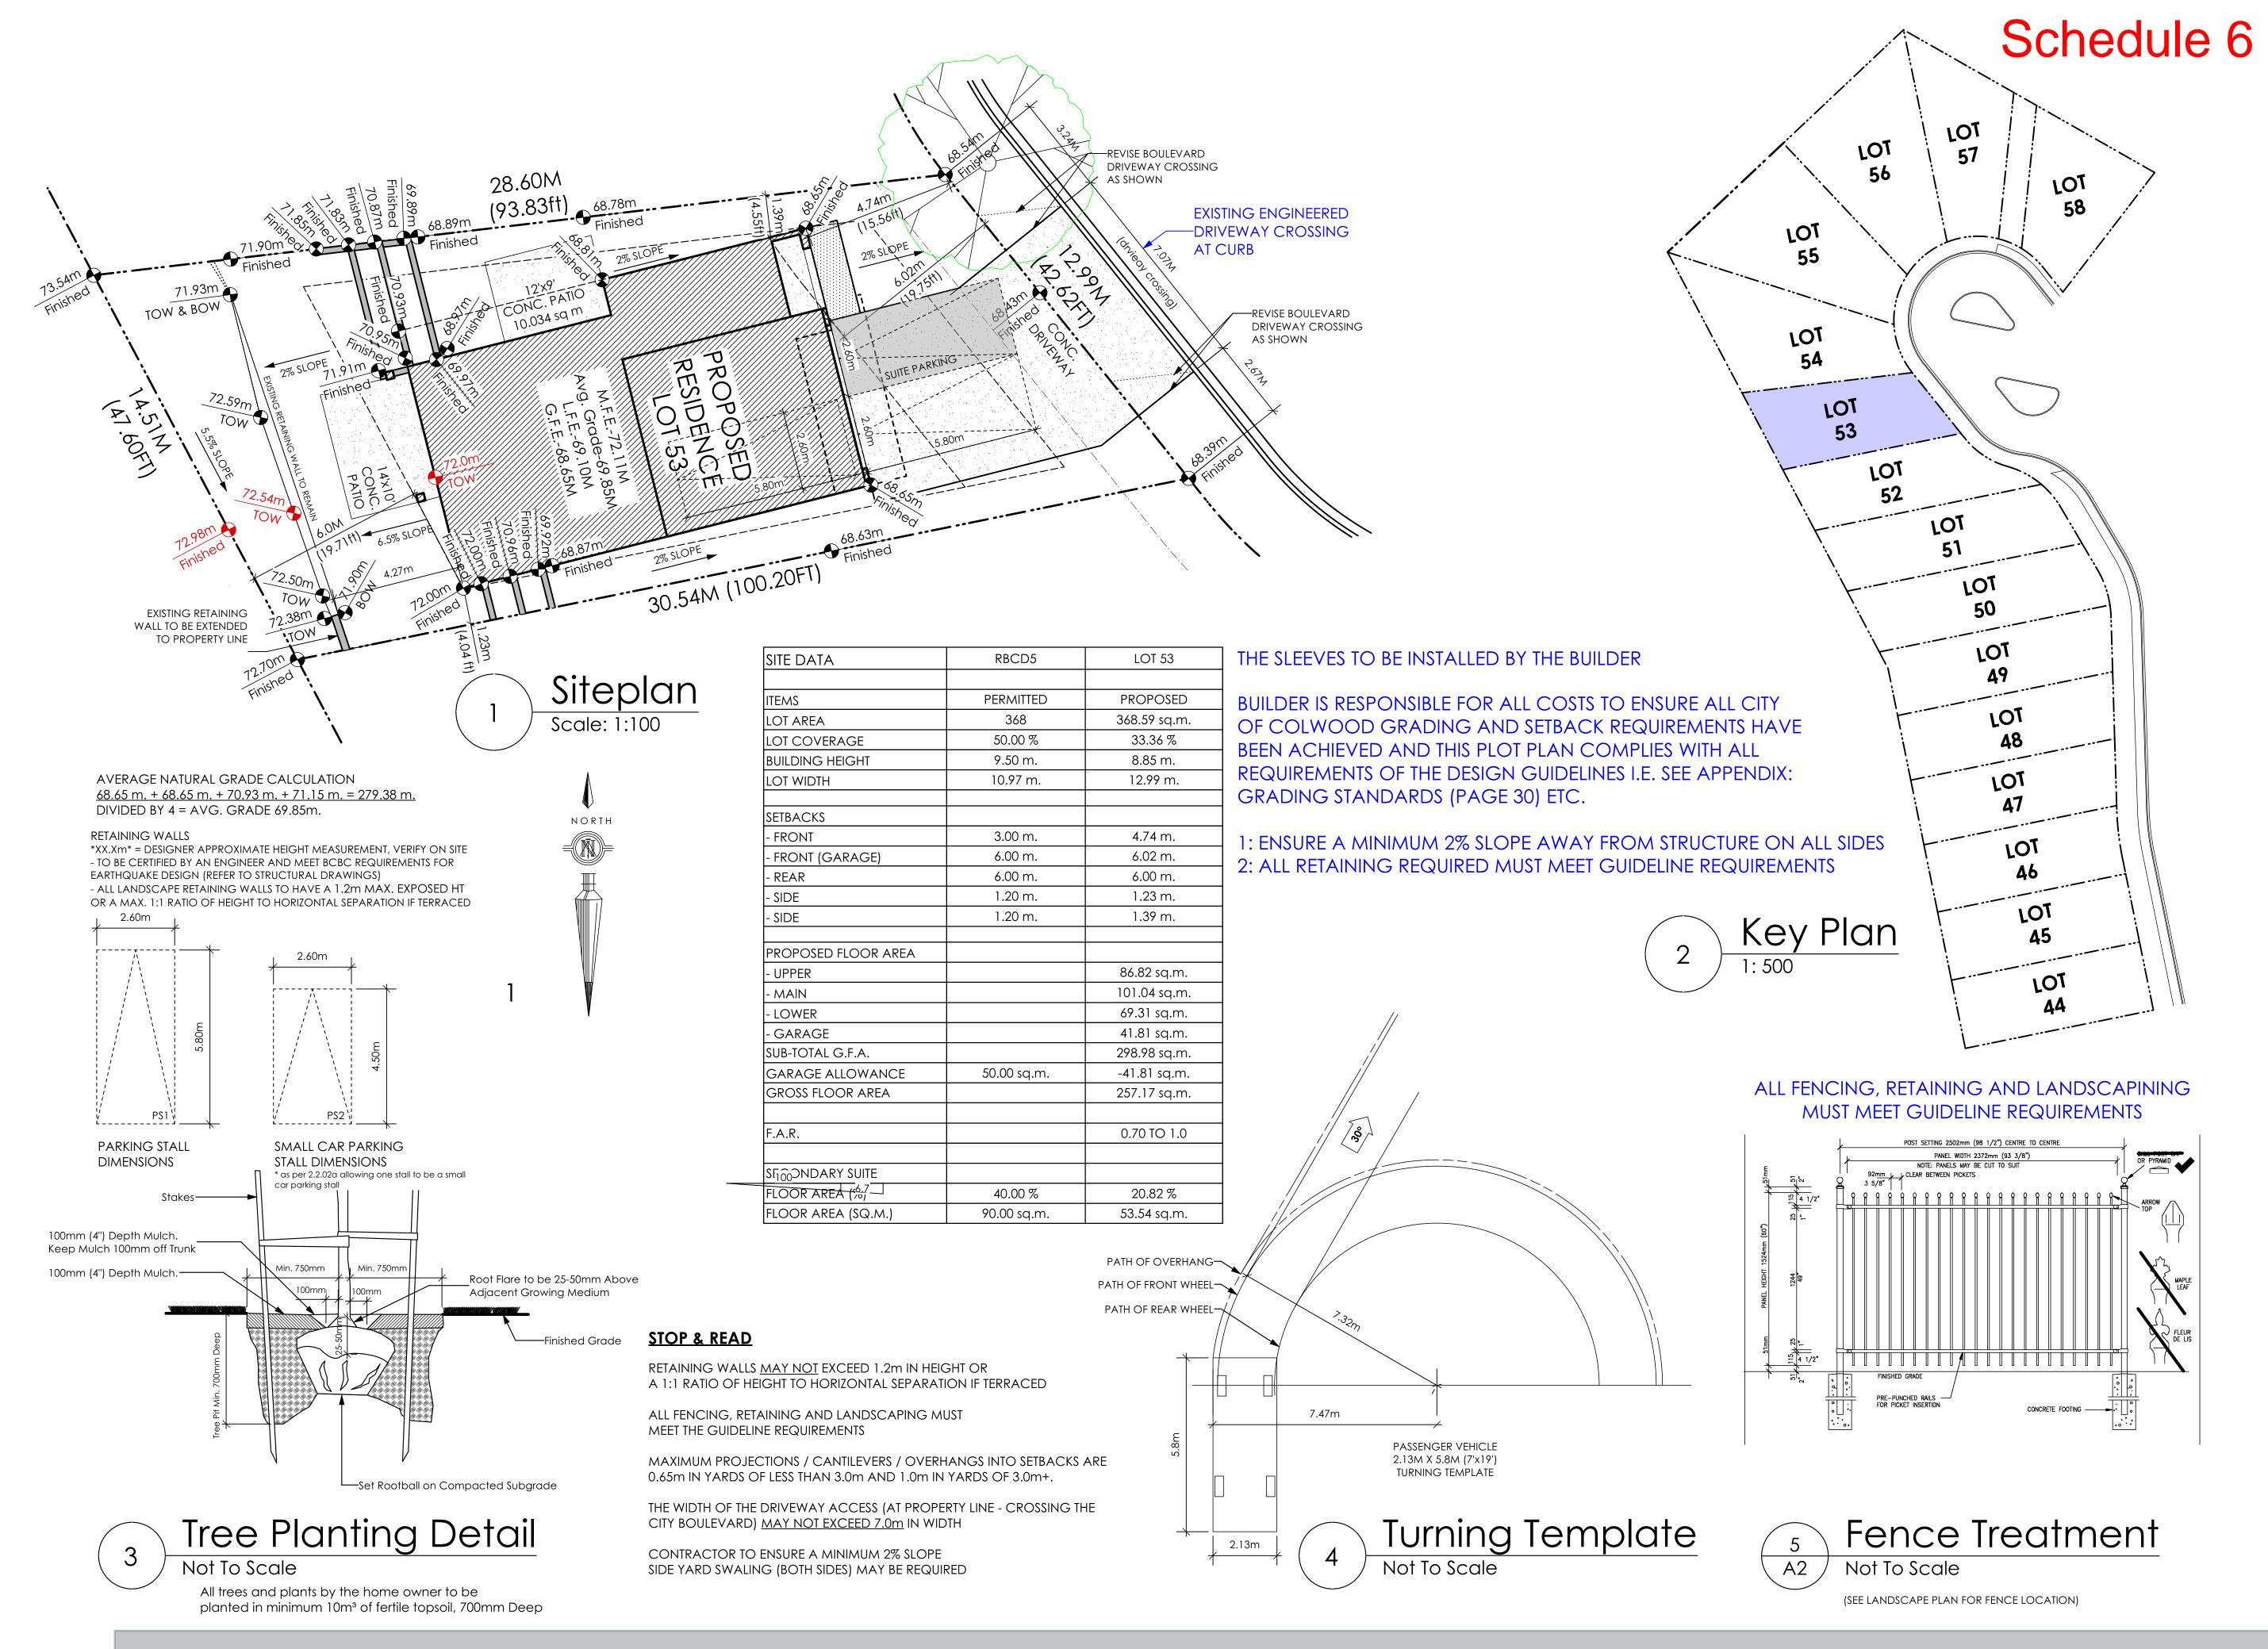

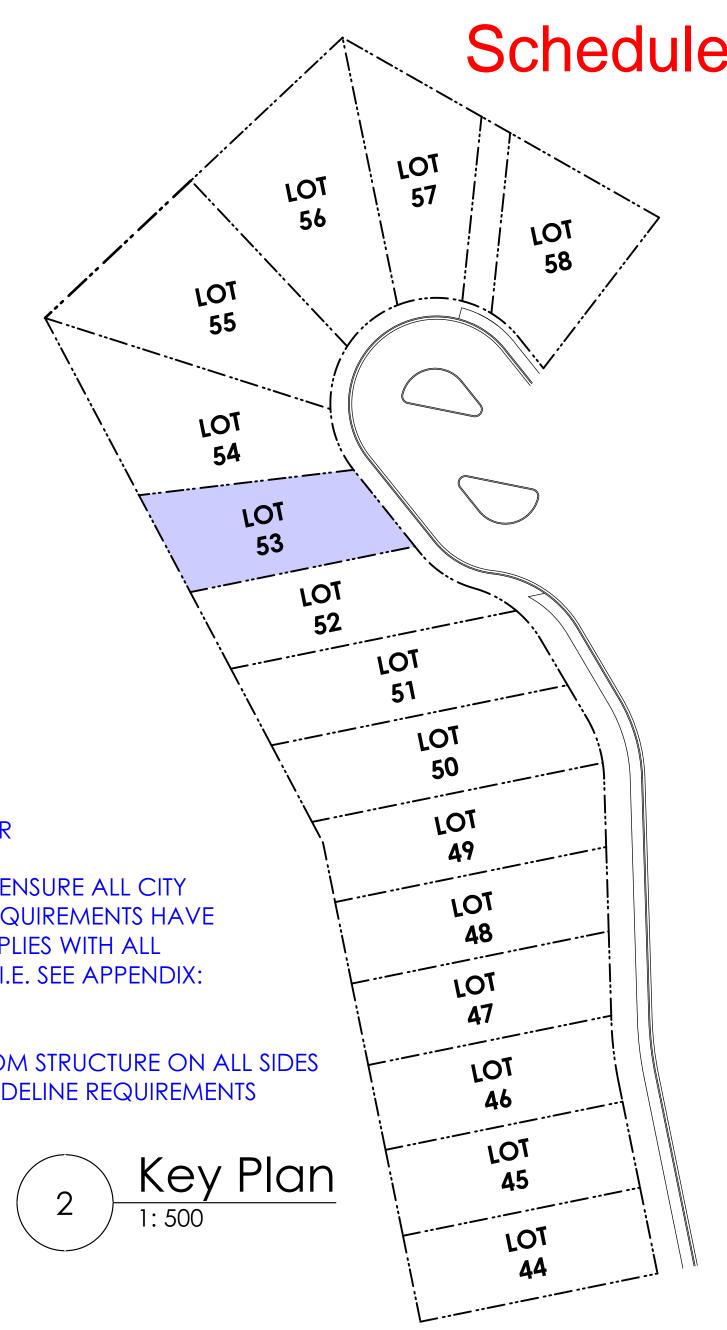

	RBCD5	LOT 53
	PERMITTED	PROPOSED
	368	368.59 sq.m.
	50.00 %	33.36 %
łT	9.50 m.	8.85 m.
	10.97 m.	12.99 m.
	3.00 m.	4.74 m.
GE)	6.00 m.	6.02 m.
	6.00 m.	6.00 m.
	1.20 m.	1.23 m.
	1.20 m.	1.39 m.
OR AREA		
		86.82 sq.m.
		101.04 sq.m.
		69.31 sq.m.
		41.81 sq.m.
۹.		298.98 sq.m.
VANCE	50.00 sq.m.	-41.81 sq.m.
AREA		257.17 sq.m.
		0.70 TO 1.0
ITE		
7	40.00 %	20.82 %
Q.M.)	90.00 sq.m.	53.54 sq.m.



#103 - 891ATTREE AVENUE VICTORIA, B.C. V9B 0A6 P. 250.382.7374 F. 250.382.7364

APPROVED BY VERITY CONSTRUCTION

DATE

APPROVED BY REALTOR

DATE

Leeward Traditional

Date Apr. 21, 2023


Project Address 3479 Trumpeter Street Royal Bay - Sector 7 Colwood, B.C. Prepared for

Verity Construction

Project # 8298

Scale As Noted

Drawn By MRB

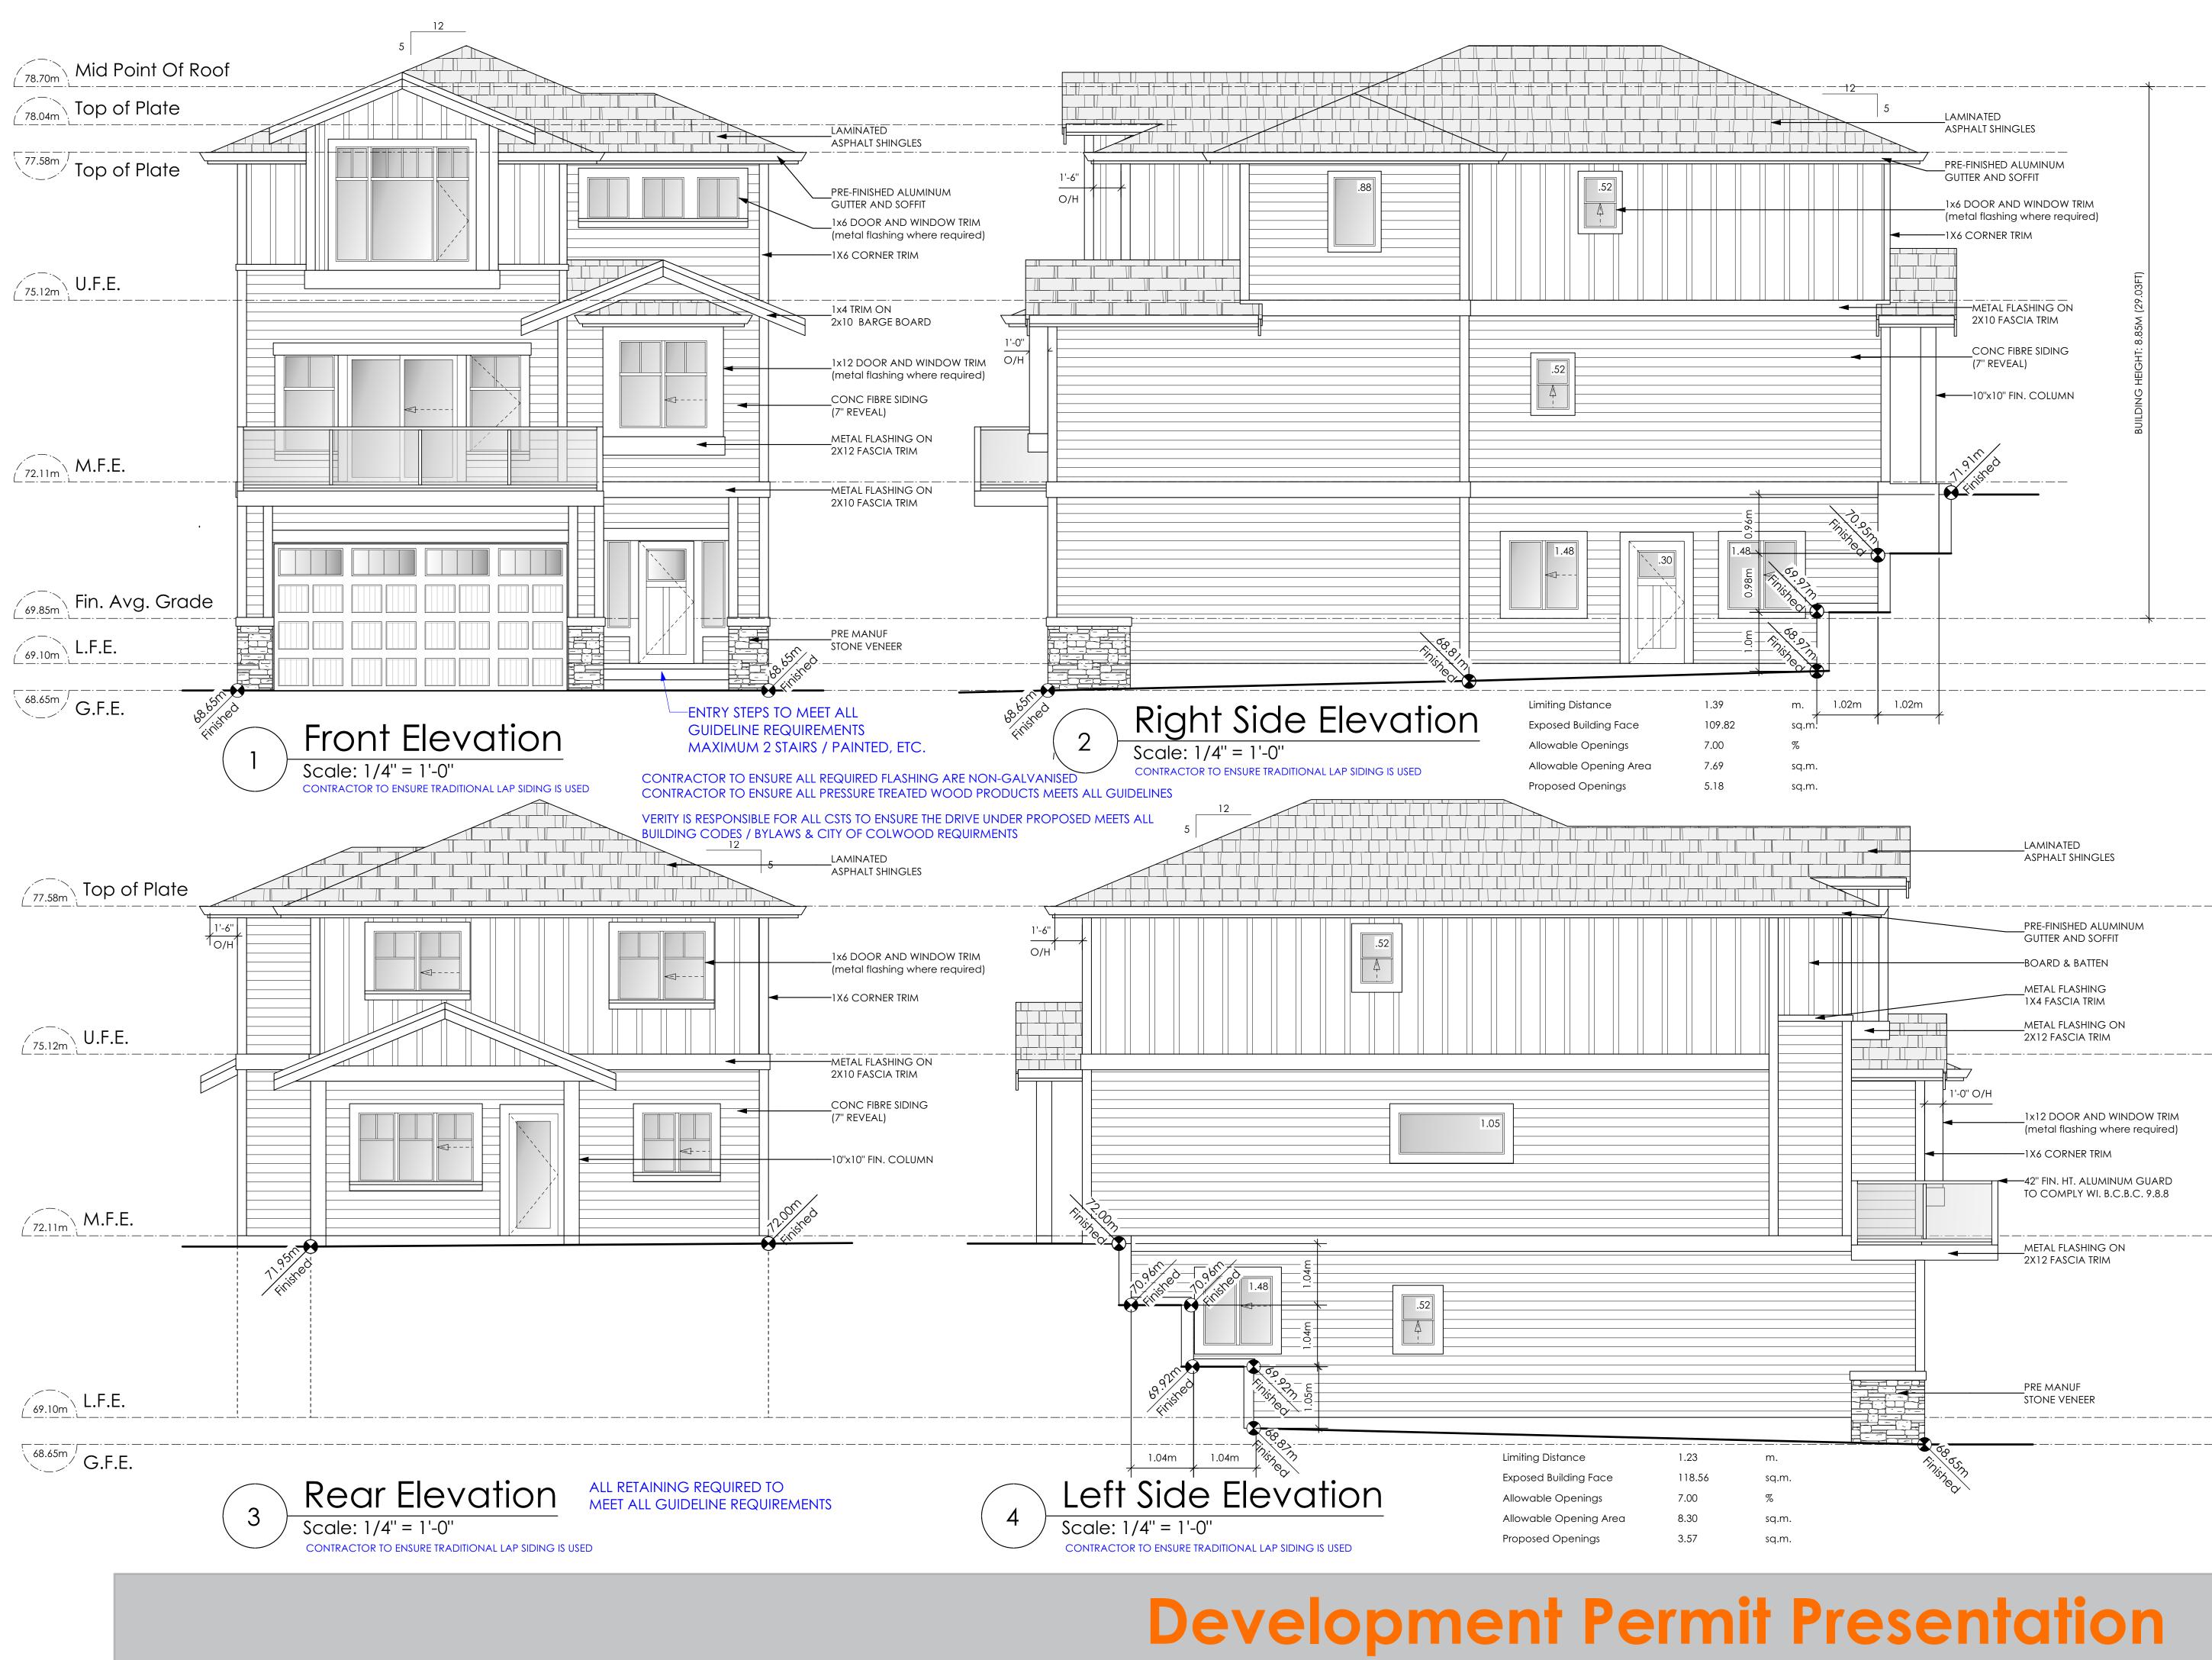

9 design group

#103 - 891ATTREE AVENUE VICTORIA, B.C. V9B 0A6 P. 250.382.7374 F. 250.382.7364

Leeward Traditional

Date Apr. 21, 2023


Project Address 3479 Trumpeter Street Royal Bay - Sector 7 Colwood, B.C. Prepared for


Verity Construction

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Leeward Traditional

Date Apr. 21, 2023


Project Address 3479 Trumpeter Street Royal Bay - Sector 7 Colwood, B.C. Prepared for

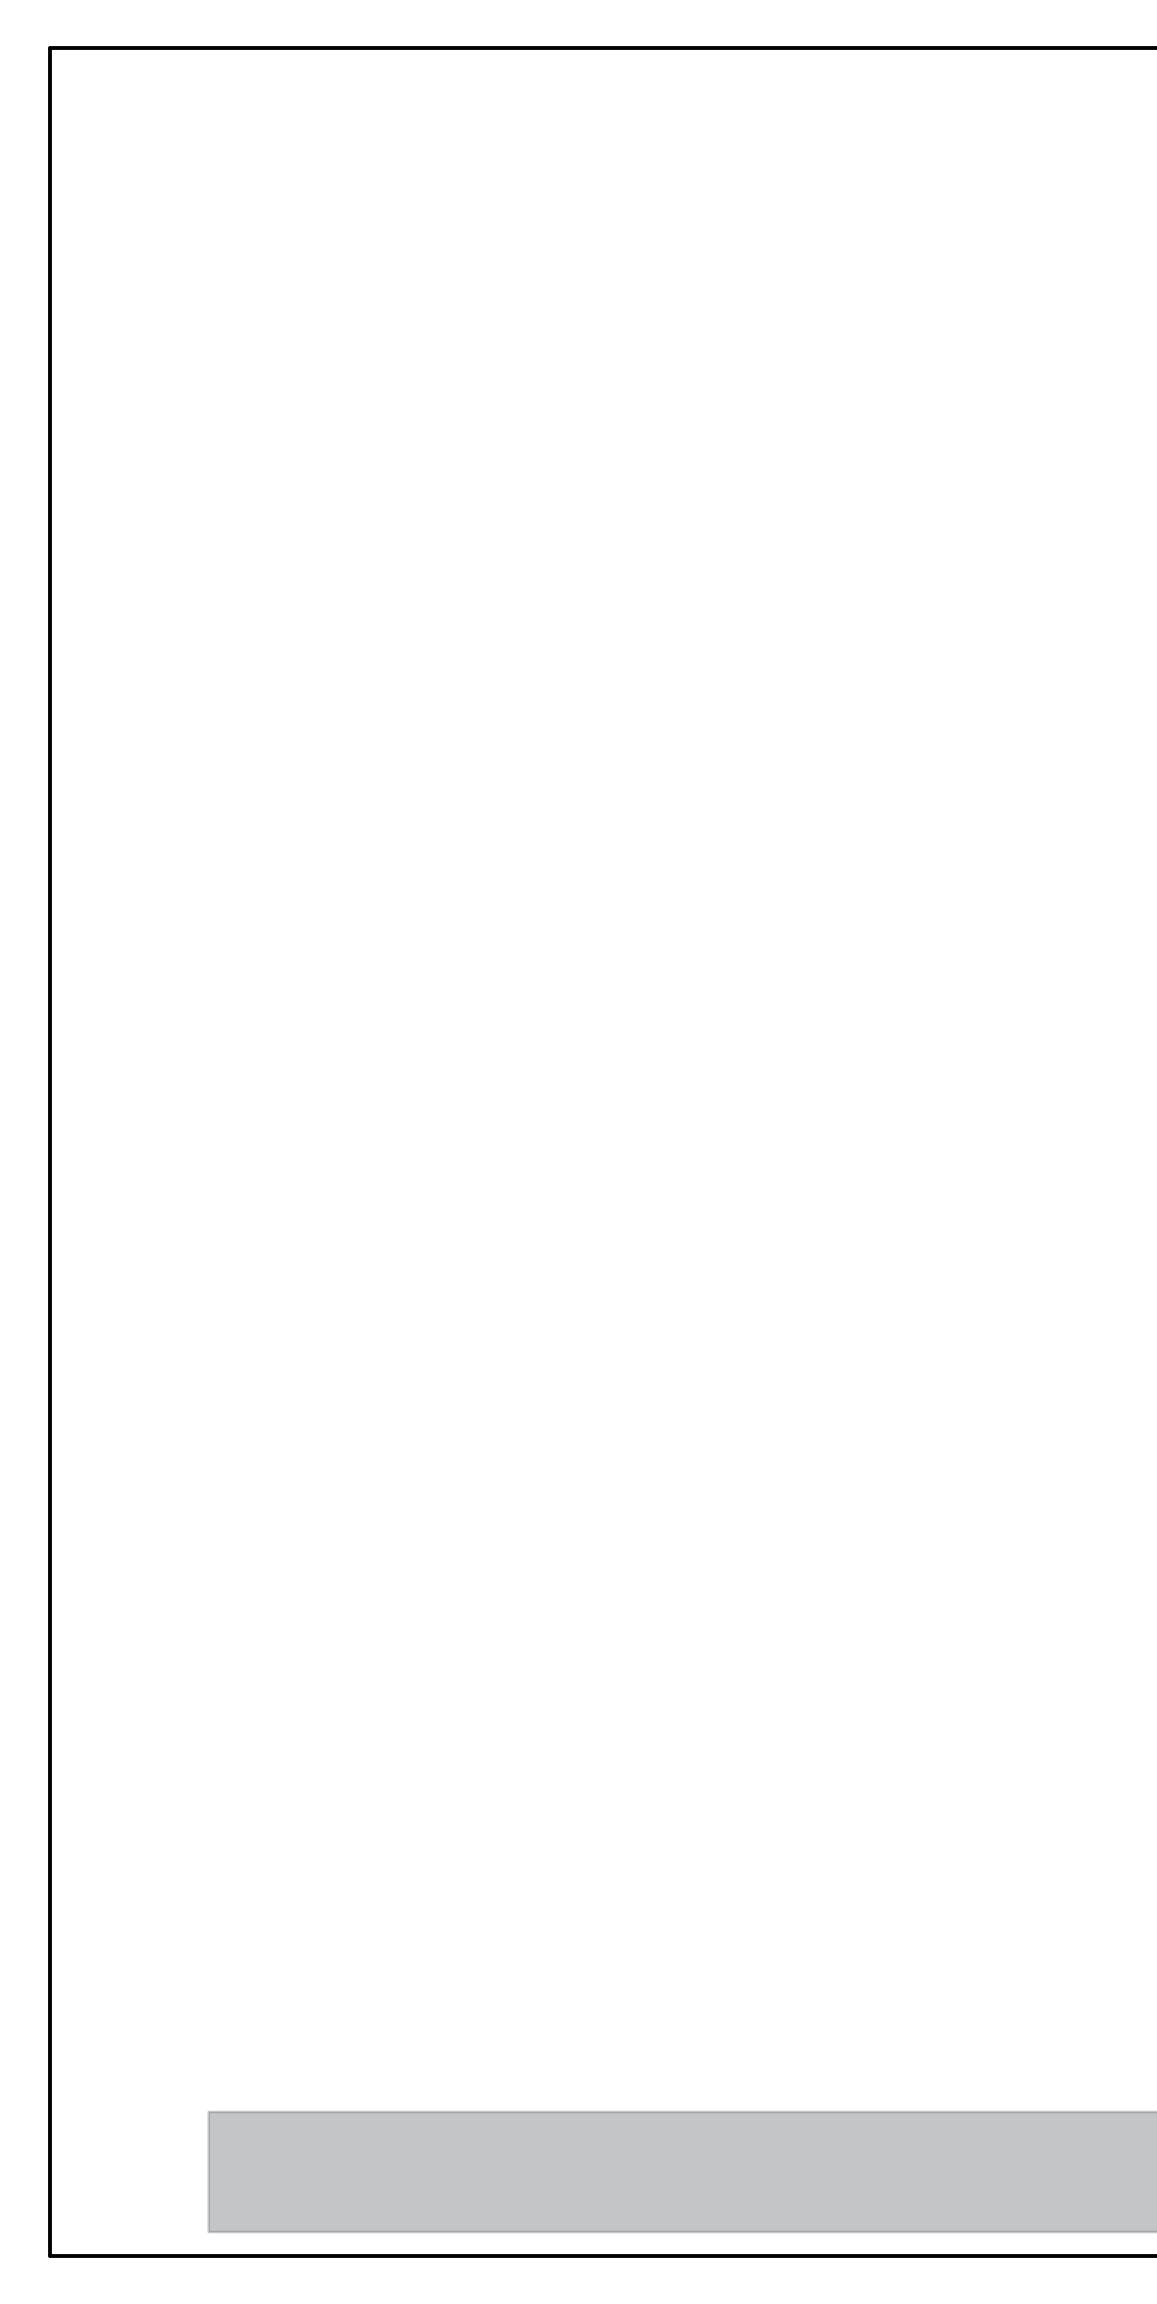Verity Construction

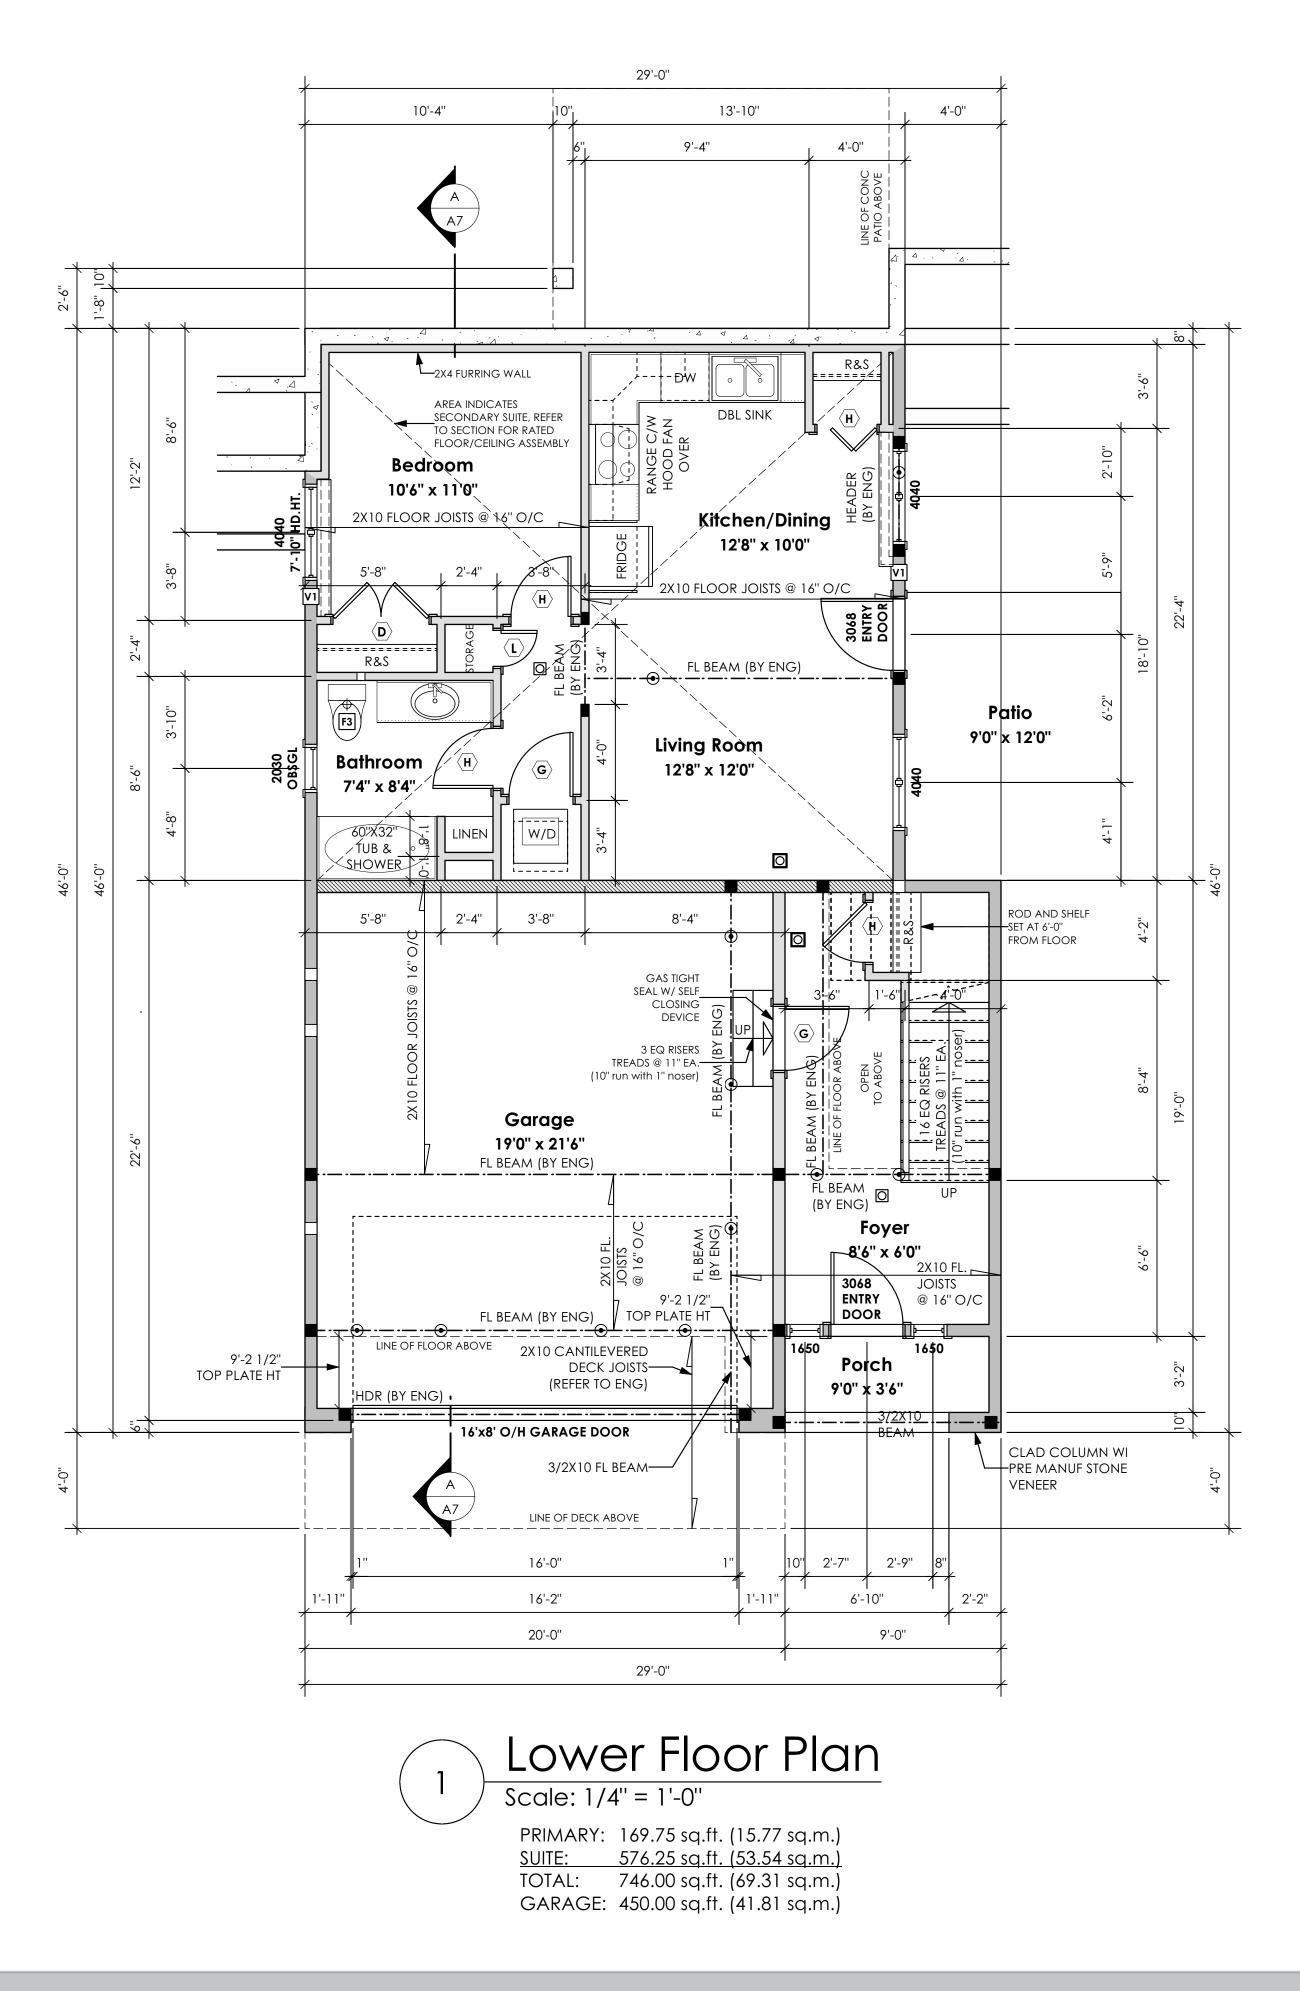Project # 8298

Scale As Noted

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Leeward Traditional

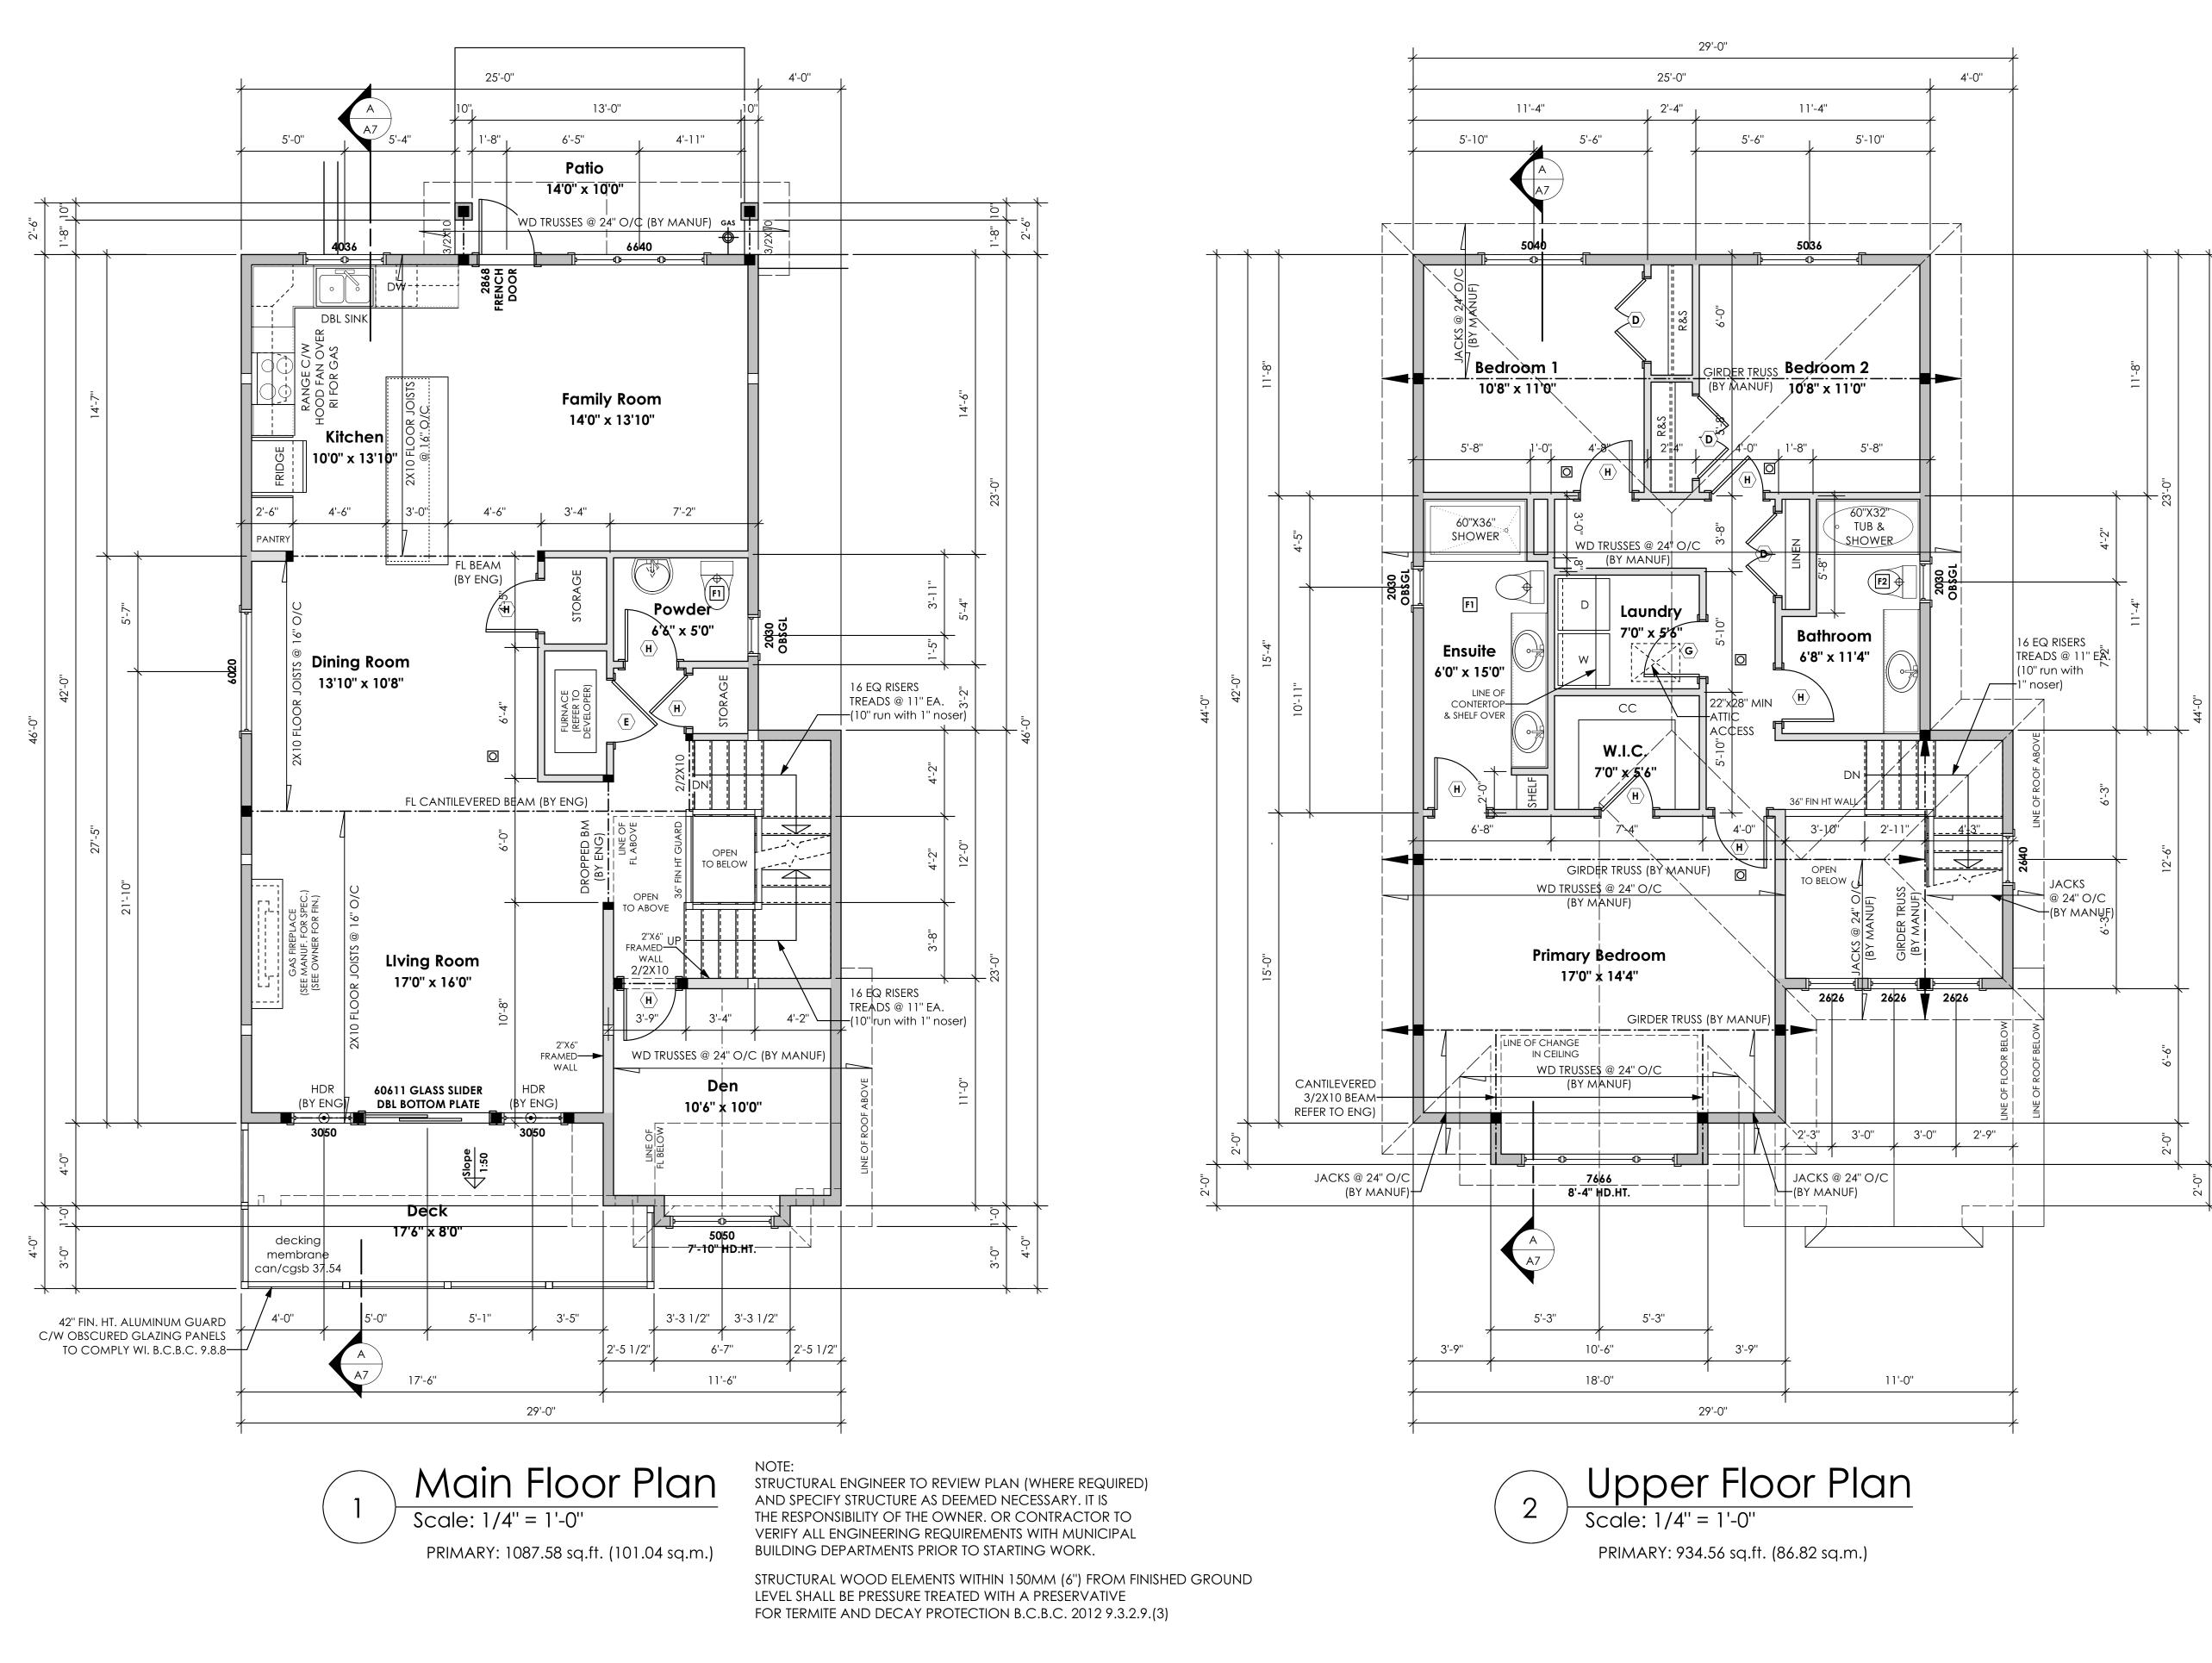Date Apr. 21, 2023


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ROOFS

- R1. LAMINATED ASPHALT SHINGLES ON 7/16" ORIENTED STRAND BOARD C/W "H" CLIPS WD TRUSSES (DESIGNED BY MANUF.) 14 1/2" FIBRE GLASS LOOSE FILL INSULATION (ALLOW FOR SETTLING) 6 MIL POLY'N V.B. 5/8" GYPSUM BOARD
- R2. PROVIDE 2 1/2" (63MM) CLEAR BETWEEN R-20 INSULATION AND SHEATHING. (MIN. R-20 @ ROOF-WALL CONNECTION FOR 4'-0" (1.2M) AROUND PERIMETER OF BUILDING. AIR VENTILATION BAFFLES TO BE INSTALLED WHERE REQUIRED IN AS PER BCBC 9.19.)
- R3. EAVE PROTECTION CONT. UP ROOF SLOPE FOR 12" PAST EXTERIOR WALL.
- R4. PROVIDE 1 SQ.FT. ATTIC VENT PER 300 SQ.FT. OF INSULATED AREA MIN. 25% OF REQUIRED TO BE @ TOP AND BOTTOM (TO COMPLY WI. B.C. BLDG. CODE 9.19.1)
- R5. PRE-FIN. FASCIA GUTTER 2×8 FASCIA BD. 2×4 SUB. FASCIA BD. VENTED SOFFIT (SEE CONTRACTOR)

Development Permit Presentation



#103 - 891ATTREE AVENUE VICTORIA, B.C. V9B 0A6 P. 250.382.7374 F. 250.382.7364

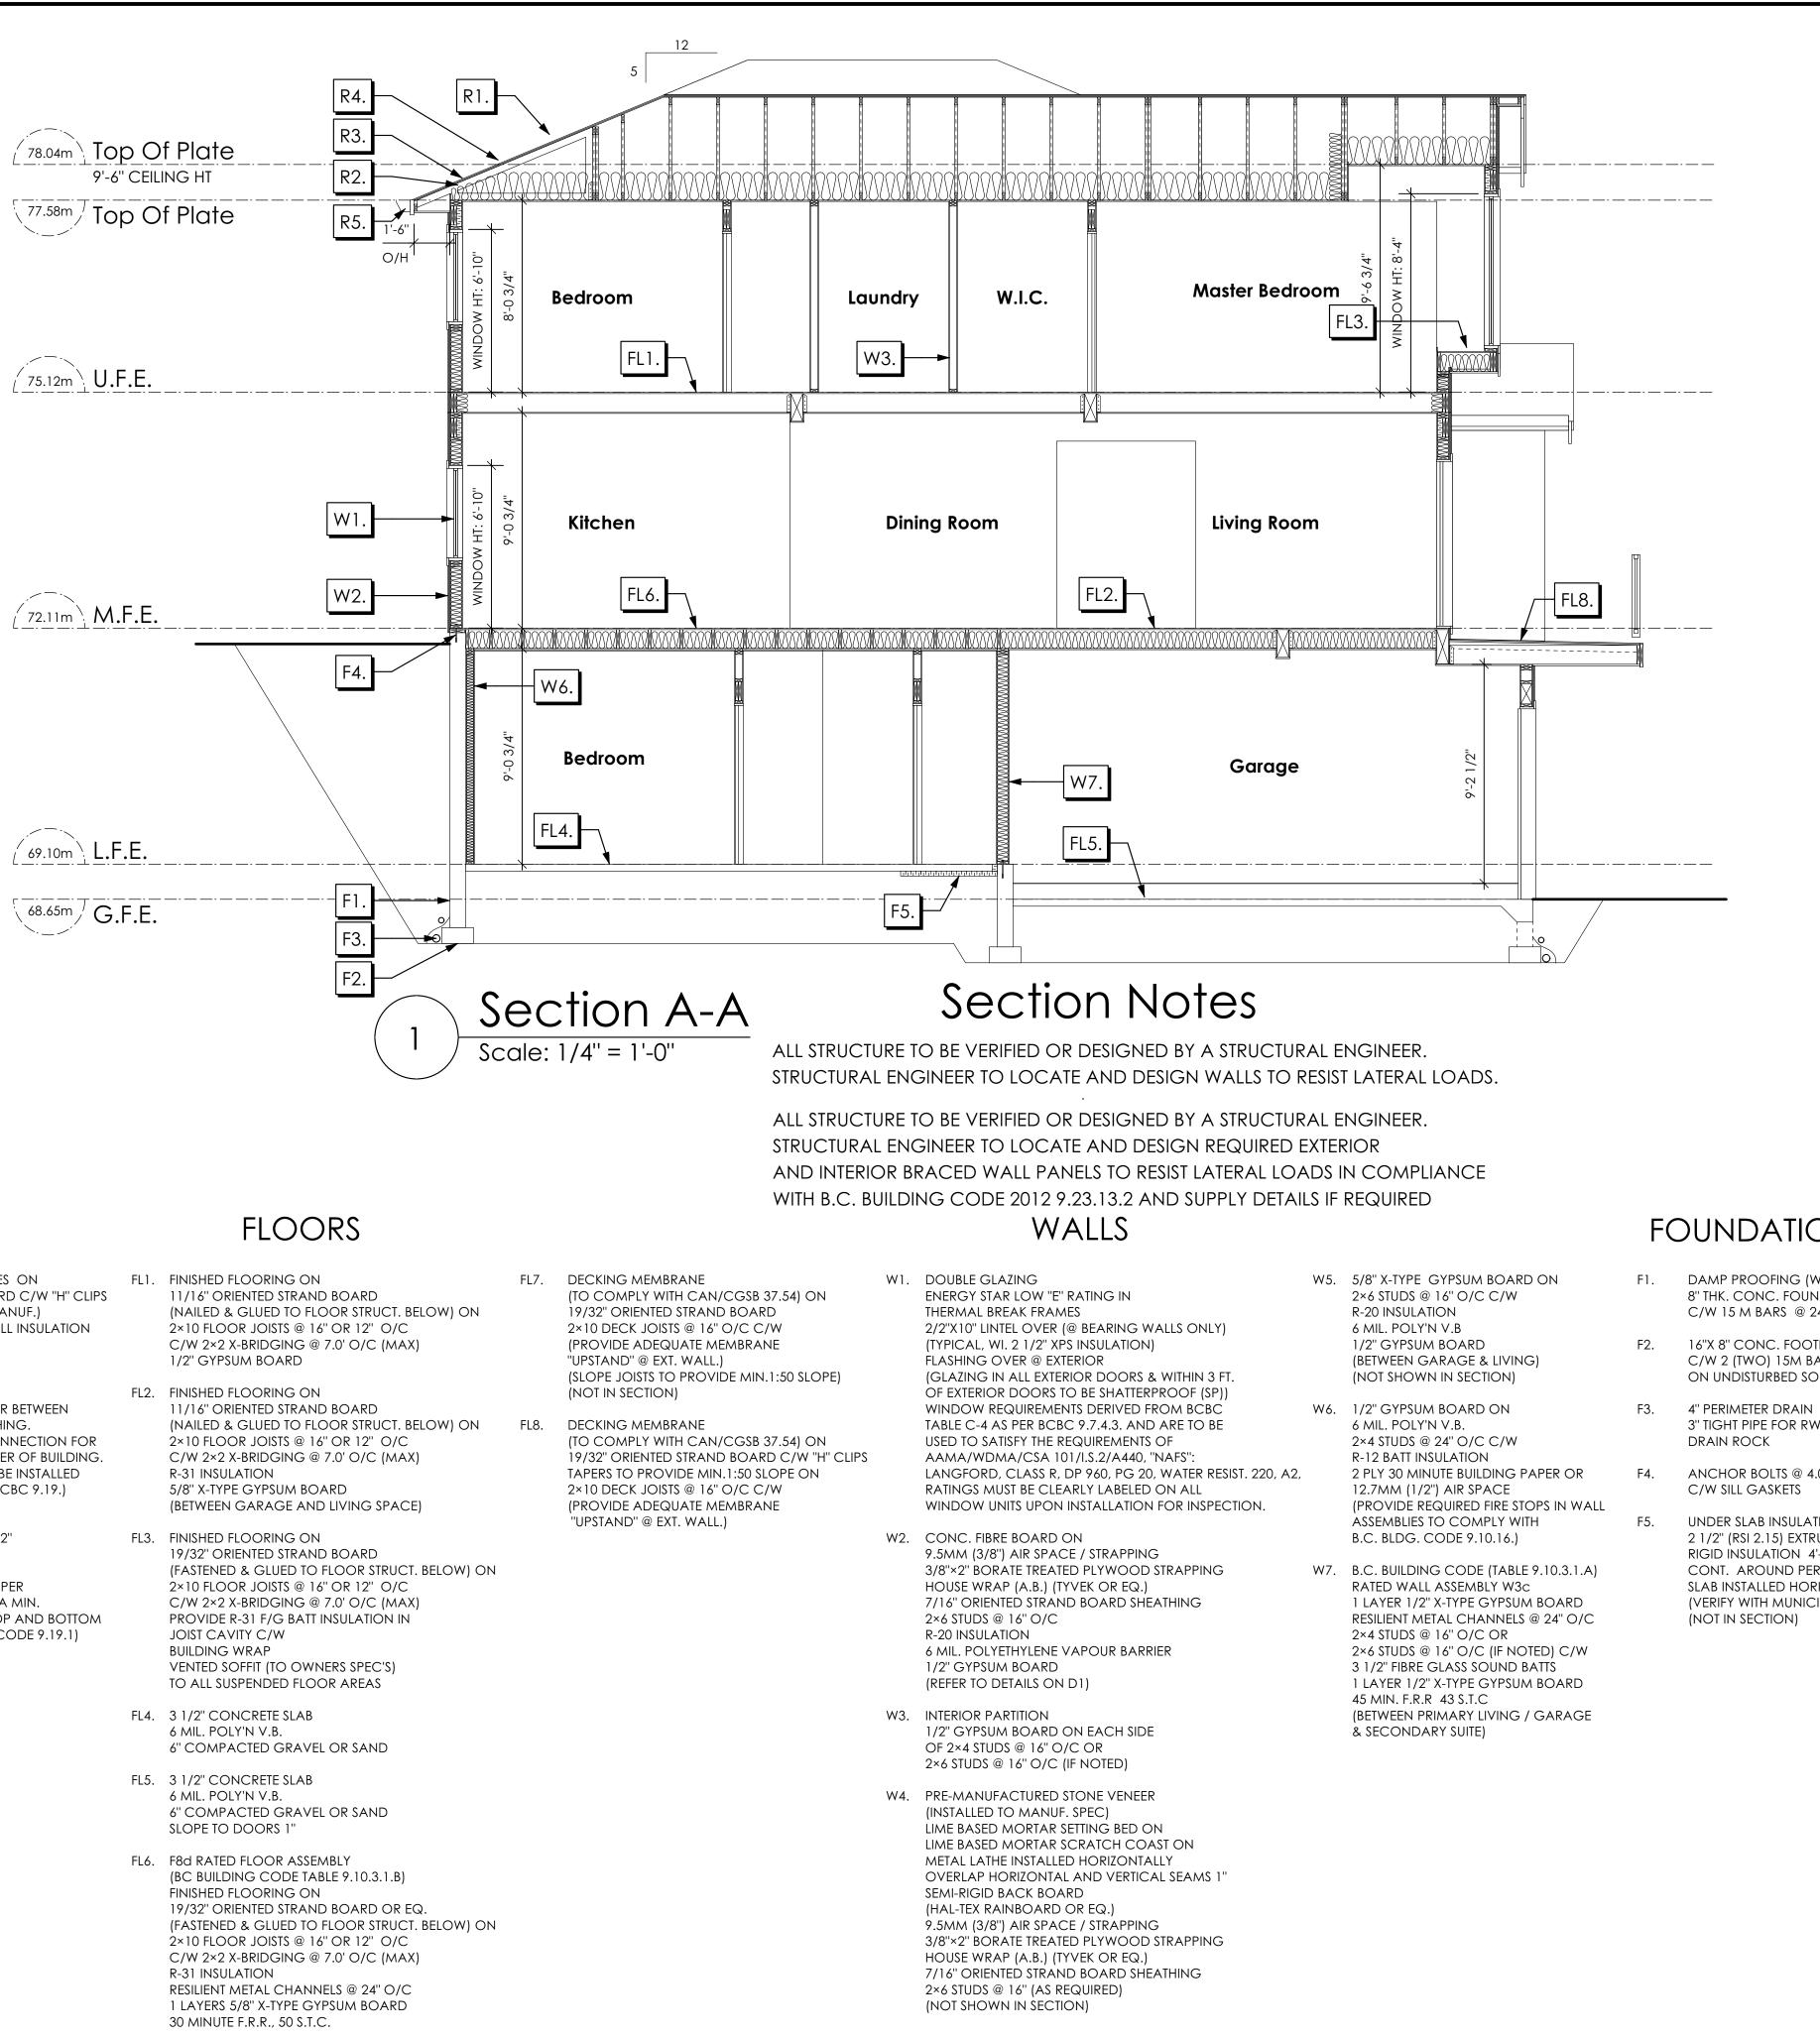FOUNDATION WALLS

F1. DAMP PROOFING (WHERE REQUIRED) ON 8" THK. CONC. FOUNDATION WALL C/W 15 M BARS @ 24" O/C B/W

> 16"X 8" CONC. FOOTINGS C/W 2 (TWO) 15M BARS CONT. 3 IN. FROM BOTT. ON UNDISTURBED SOIL (SOLID BEARING)

3" TIGHT PIPE FOR RWL

ANCHOR BOLTS @ 4.0 FT. O/C MAX

UNDER SLAB INSULATION 2 1/2" (RSI 2.15) EXTRUDED POLYSTYRENE RIGID INSULATION 4'-0" (1.2M) CONT. AROUND PERIMETER UNDER SLAB INSTALLED HORIZONTALLY (VERIFY WITH MUNICIPALITY DEPTH OF FROST LINE) Leeward Traditional

Date Apr. 21, 2023


Project Address 3479 Trumpeter Street Royal Bay - Sector 7 Colwood, B.C. Prepared for

Verity Construction

Project # 8298

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Leeward Traditional

68.43m Finished
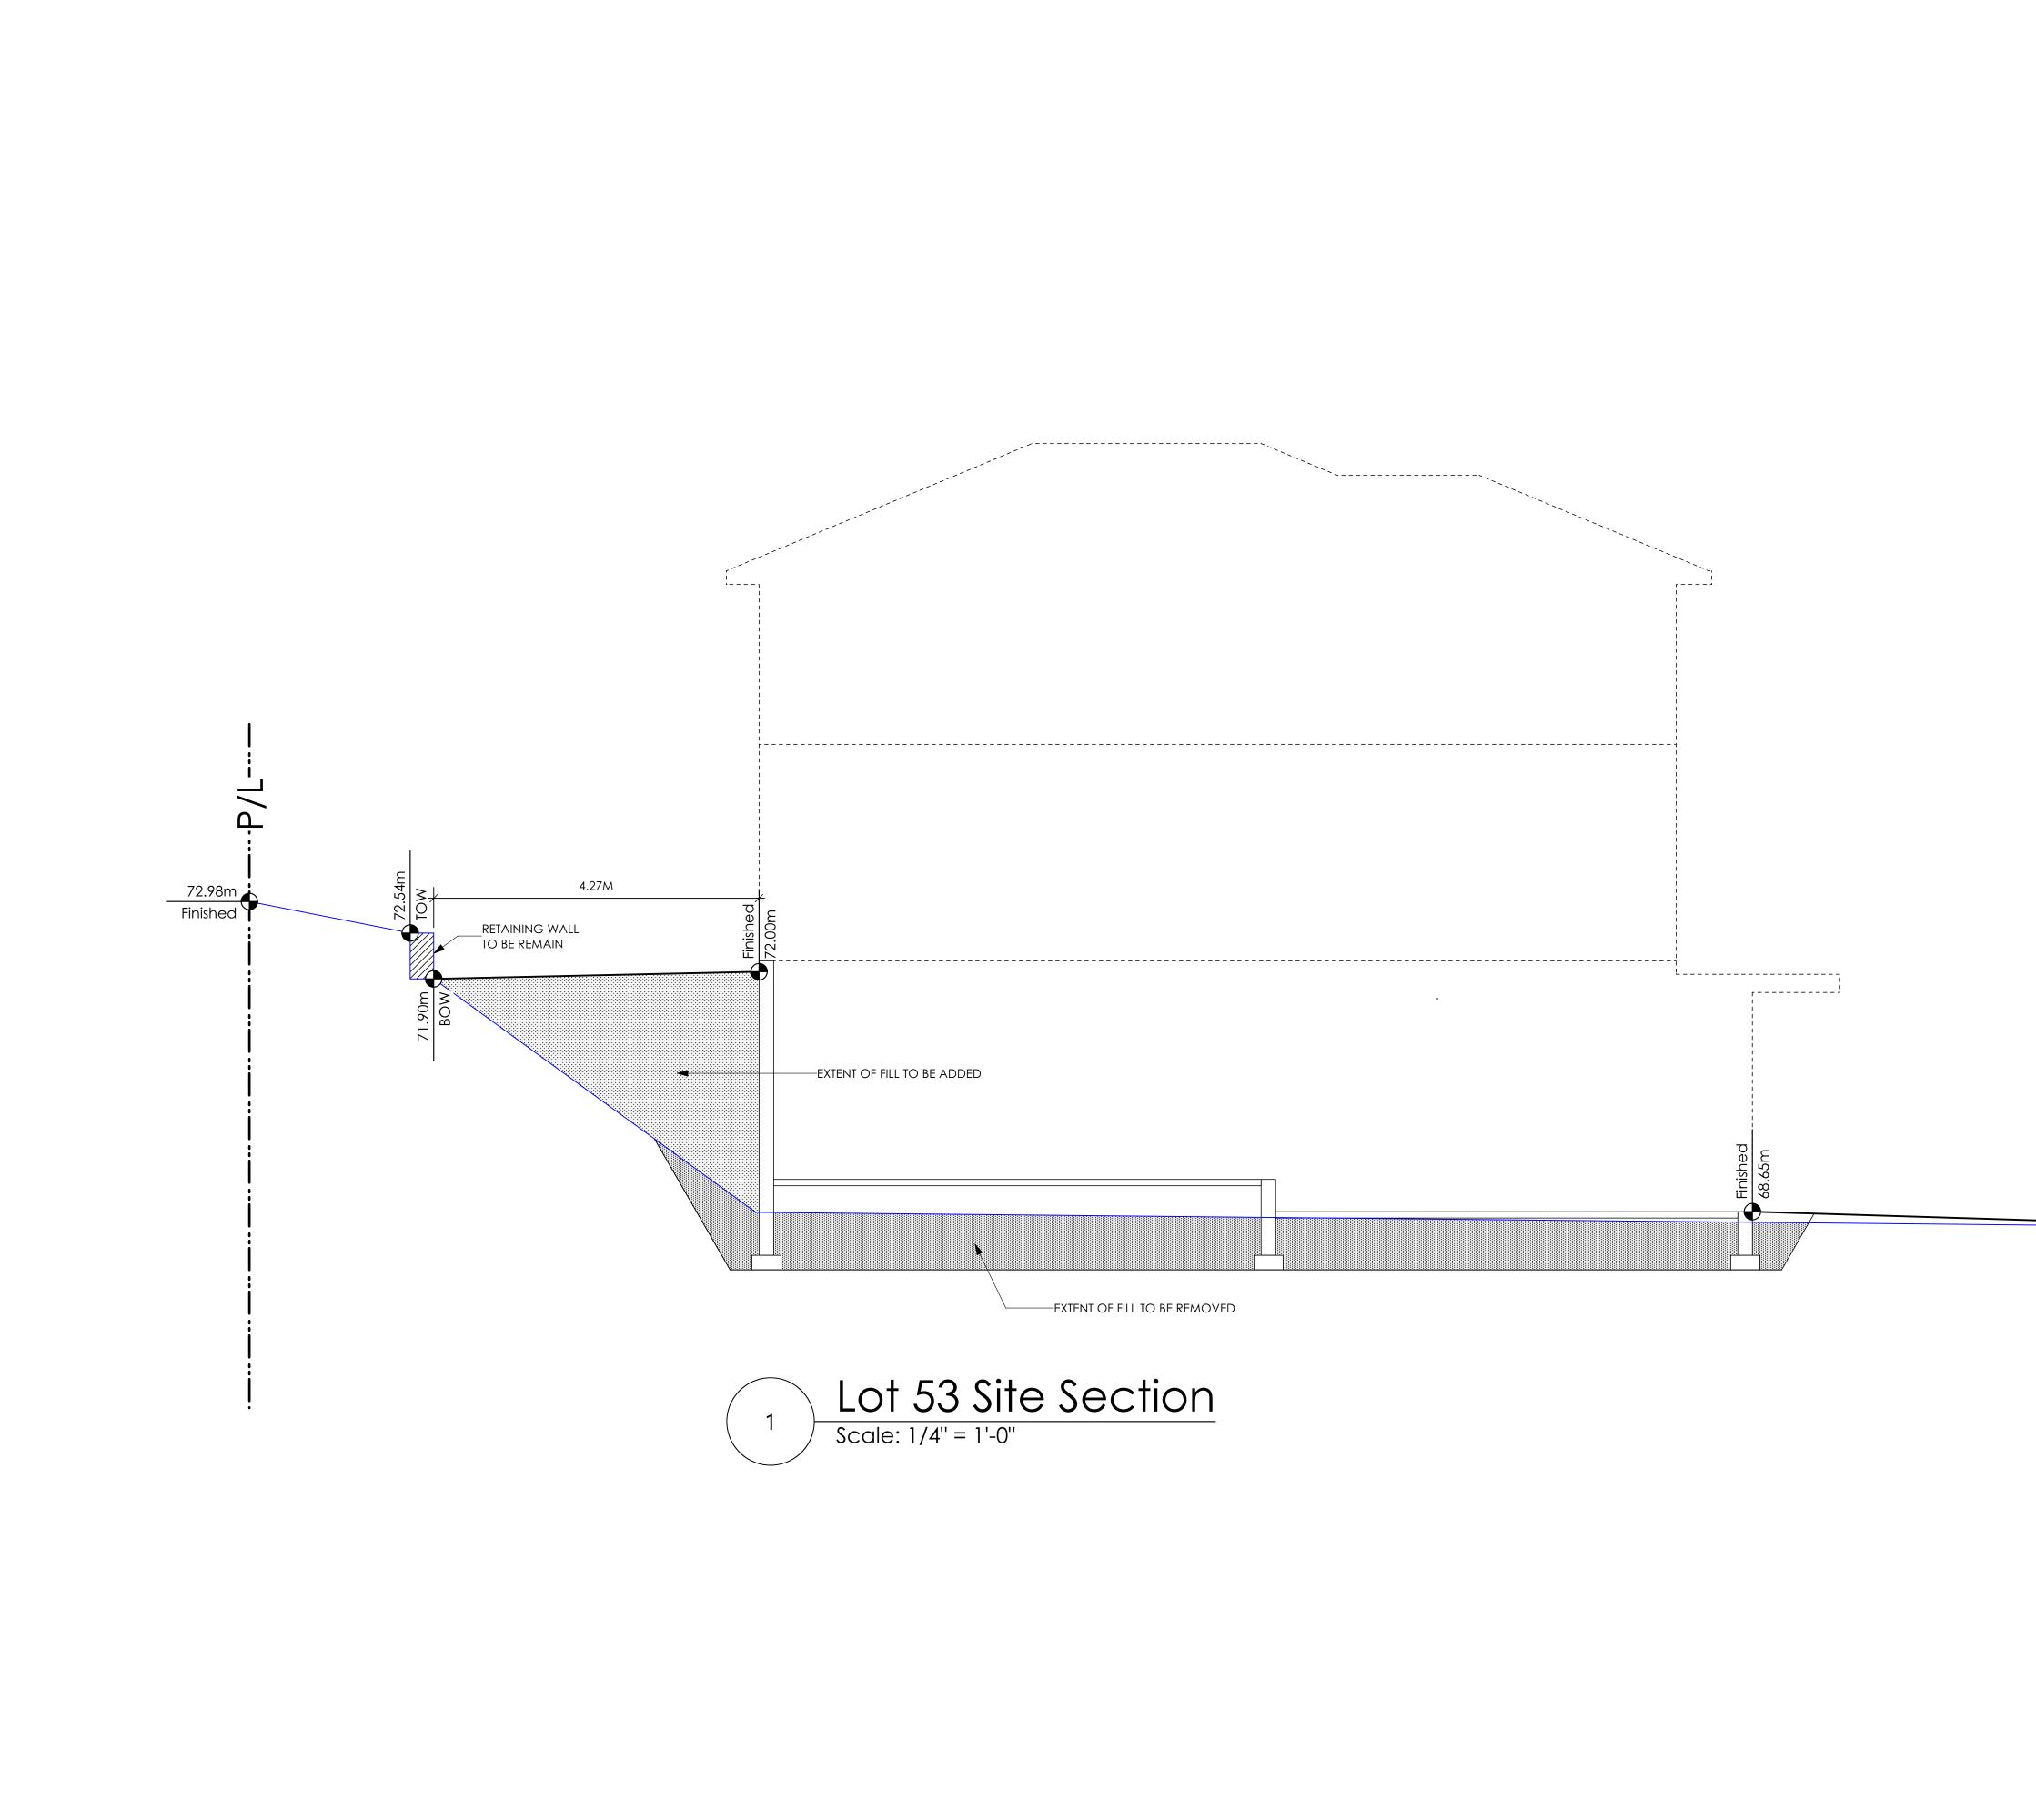
> Date Apr. 21, 2023

Project Address 3479 Trumpeter Street Royal Bay - Sector 7 Colwood, B.C. **Prepared for**

Verity Construction

Project # 8298

Scale As Noted

Drawn By MRB

ALL FENCING, RETAINING AND LANDSCAPING MUST MEET THE **GUIDELINE REQUIREMENTS**

NORTH - (R)-

MM/DD/YY

06/27/22

08/04/22

01/17/23

01

02

03

ALL RETAINING WALLS ARE TO BE STAND ALONE STRUCTURES (THEY MUST TERMINATE AT PROPERTY LINE) AND MUST NOT CONNECT TO RETAINING WALLS LOCATED ON ADJACENT PRIVATE PROPERTIES


PAT

*NOTE: In the interest of maintaining high standards, the developer reserves the right to modify plans. specifications and design without prior notice. Drawings contained within are artist renderings only. Sizes and dimensions are approximate and may vary with actual plan and survey. Exterior style may change pending municipal approval. Retaining wall location and types may

KEY PLAN NOT TO SCALE

Victoria, B.C. V9B 0A6

www.verityconstruction.ca

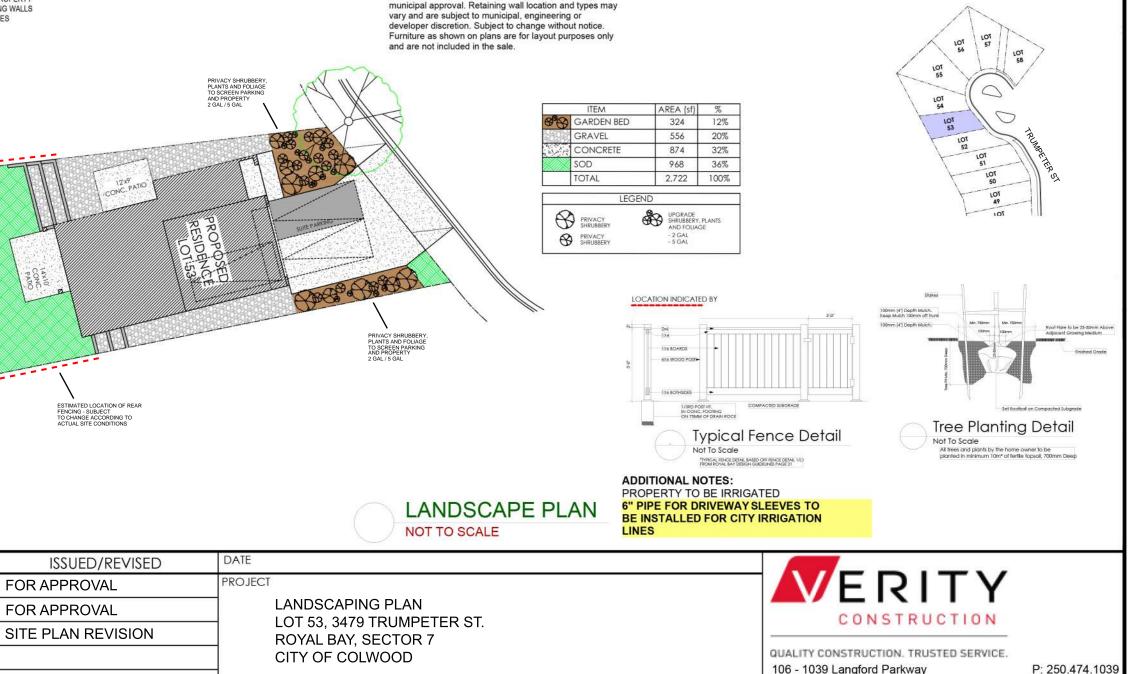

GABLECRAFT HOMES BUILDING GRADE SLIP

WSP Project No: <u>201-08151-00</u>

Issue Date: _____

MUNICIPAL ADDRESS 3479 Trumpeter Street	P.I.D.
LOT 53	PLAN
	SUBDIVISION ROYAL BAY SECTOR 7
ADDRESS	DEVELOPER MEADOWS DEVELOPMENT LP
REPRESENTATIVE PH.	CONSULTANT WSP CANADA INC
PROPOSED BUILDING GRADES	PLAN
ALL ELEVATIONS ARE METRIC GEODETIC +	LOT: <u>53</u> PLAN:
MAIN FLOOR ELEVATION //a JOIST JOIST	et.
FRONT ELEV. 68.65 REAR ELEV. 70.00/71.15/72.00/71.91/70.95 DEPTH (FINISHED GRADE) (FINISHED GRADE) </th <th>TRUMPETER ST.</th>	TRUMPETER ST.
FINISHED GRADE AT GARAGE 68.65	TRU. G
HEADROOM	
HEAL	
ACTUAL TOP OF FOOTING	
LOWEST PERMITTED TOP OF not provided FLOOR SLAB	33 60 EG 68.4 80 LFE 69.05 0
(BOTTOM OF BASEMENT ŚLAB FROST WALLS ARE REQUIRED.)	GFE 68.85 ★ MSE 65.52 ↓ ≤ 85.06
SERVICES FRONT REAR CENTER REFER SIZE	
TO PLAN (mm) WATER	
SANITARY SANITARY	
STORM	
COMMENTS YES NO	
DRAIN TO SUMP PUMP LIKELY REQUIRED	
(FOR BASEMENT IF INSTALLED)	<u>LEGEND</u> STREET
(FOR BASEMENT IF INSTALLED)	
FOUNDATION SOIL BEARING INVESTIGATION	IIII SERVICE LOCATION (SHOWN ON ABOVE PLAN)
	[(ຫ] SROW (ຫ] ໂ
(SEE GEOTECHNICAL REPORT)	2000
ENVIRONMENTAL RESTRICTIONS APPLY (SEE ENVIRONMENTAL REPORT)	L# 6 C# 256 G 49.90 C# 290 C# 290
UTILITY EASEMENTS AFFECT THIS LOT	LG 43.50 LFE/MFE 47.70 - LOWER/MAIN FLOOR ELEVATION GFE 47.55 - GARAGE FLOOR ELEVATION
	MFGE 47.70 - MAXIMUM FINAL GROUND ELEVATION MSE 52.20 - MINIMUM SANITARY SERVICABLE ELEVATION BY GRAVITY
	S 49.12 (P) D 49.12 (P) - SAN SERVICE INV. (P) DENOTES PUMP IS LIKELY REQUIRED
	FOR BASEMENT IF INSTALLED
	(P) DENOTES PUMP IS LIKELY REQUIRED FOR BASEMENT IF INSTALLED - PROPOSED REAR SIDE YARD GRADES
	L AXIMUM BASEMENT SLAB DEPTH ELEVATION L
NOTES	
 IT IS THE RESPONSIBILITY OF THE BUILDER TO ENSURE THE FOOTINGS ARE PLACED ON A PROPER BASE THAT IS FREE FROM FROST, EXCESSIVE MOISTURE AND DELETERIOUS MATERIALS AND HAVE APPROPRIATE FROST PROTECTION WHEN COMPLETED. 	
 THE INFORMATION CONTAINED HEREIN IS BASED ON THE APPROVED LOT GRADING PLAN FOR THIS SUBDIVISION. UN-AUTHORIZED DEVIATIONS WILL BE THE RESPONSIBILITY OF THE BUILDER TO ENSURE COMPLIANCE WITH ALL LOCAL BYLAWS. 	I, THE BUILDER'S REPRESENTATIVE,, CERTIFY THAT THE FINAL HOUSE PLANS PROVIDED IN THE BUILDING PERMIT
3. OTHER NOTES:	APPLICATION ARE THE SAME AS PROCESSED UNDER THIS GRADE SLIP AND THAT I UNDERSTAND THE INFORMATION AND THE REQUIREMENTS CONTAINED HEREIN AND WILL BUILD ACCORDINGLY.
	AUTHORIZED BUILDER'S REPRESENTATIVE DATE
	THE INFORMATION CONTAINED HEREIN IS BASED ON THE APPROVED LOT GRADING PLAN FOR THIS SUBDIVISION, DATED
	C. Hume - August 16/22
WSP - Wednesday, June 15, 2022 12:54 PM P:\2021\211-00627-00_ROYAL BAY - SECTOR 7\3_TECH\3_CADD\3_SHEETS\.	ISSUED BY DEVELOPER'S AUTHORIZED REPRESENTATIVE DATE


SITE DATA	RBCD5	LOT 54
ITEMS	PERMITTED	PROPOSED
LOT AREA	550 sq.m.	483.10 sq.m.
LOT COVERAGE	50.00 %	24.96 %
BUILDING HEIGHT	9.50 m.	8.30 m.
LOT WIDTH	16.50 m.	12.95 m.
Setbacks		
- FRONT	4.50 m.	6.41 m.
- FRONT (GARAGE)	6.00 m.	6.41 m.
- REAR	6.00 m.	8.07 m.
- SIDE	1.20 m.	1.95 m.
- SIDE	1.20 m.	1.31 m.
PROPOSED FLOOR AREA		
- UPPER		89.48 sq.m.
- MAIN		116.38 sq.m.
- LOWER		66.93 sq.m.
- GARAGE		40.88 sq.m.
SUB-TOTAL G.F.A.		313.67 sq.m.
GARAGE ALLOWANCE	50.00 sq.m.	-40.88 sq.m.
GROSS FLOOR AREA		272.79 sq.m.
F.A.R.		0.56 TO 1.0
Secondary suite		
FLOOR AREA (%)	40.00 %	20.13 %
FLOOR AREA (SQ.M.)	90.00 sq.m.	54.91 sq.m.


AVERAGE NATURAL GRADE CALCULATION <u>68.85 m. + 68.78m. + 72.00 m. + 71.94 m. = 281.57 m.</u> divided by 4 = ave. grade 70.39 m.

SEE LANDSCAPING PLAN FOR TREE SCHEDULE

RETAINING WALLS *XX.Xm* = DESIGNER APPROXIMATE HEIGHT MEASUREMENT, VERIFY ON SITE - TO BE CERTIFIED BY AN ENGINEER AND MEET BCBC REQUIREMENTS FOR EARTHQUAKE DESIGN (REFER TO STRUCTURAL DRAWINGS)


- ALL LANDSCAPE RETAINING WALLS TO HAVE A 1.2m MAX. EXPOSED HT OR A MAX. 1:1 RATIO OF HEIGHT TO HORIZONTAL SEPARATION IF TERRACED

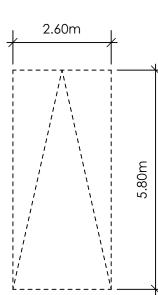

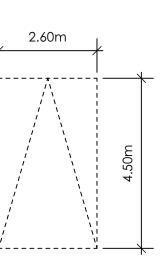

PARKING STALL DIMENSIONS



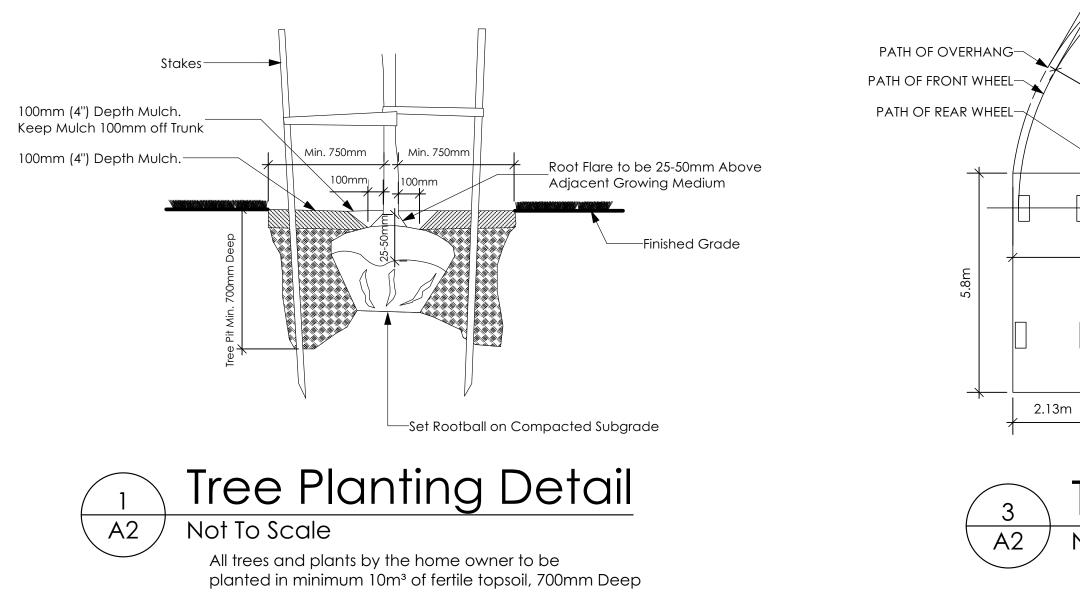


VERITY IS RESPONSIBLE FOR ALL COSTS TO ENSURE ALL REQUIREMENTS RE: GFE ARE ACHIEVED

ALL RETAINING WALLS REQUIRED ARE SUBJECT TO GEOECHNICAL, CITY OF CALWOOD APPROVAL AND MUST FALLOW ALL APPLICABLE DESIGN GUIDELINES

> ALL RETAINING WALLS ARE TO -BE STAND ALONE STRUCTURES (THEY MUST TERMINATE AT PROPERTY LINE) AND MUST NOT CONNECT TO RETAINING WALLS LOCATED ON ADJACENT PRIVATE PROPERTIES

26.5311 (81

. R.

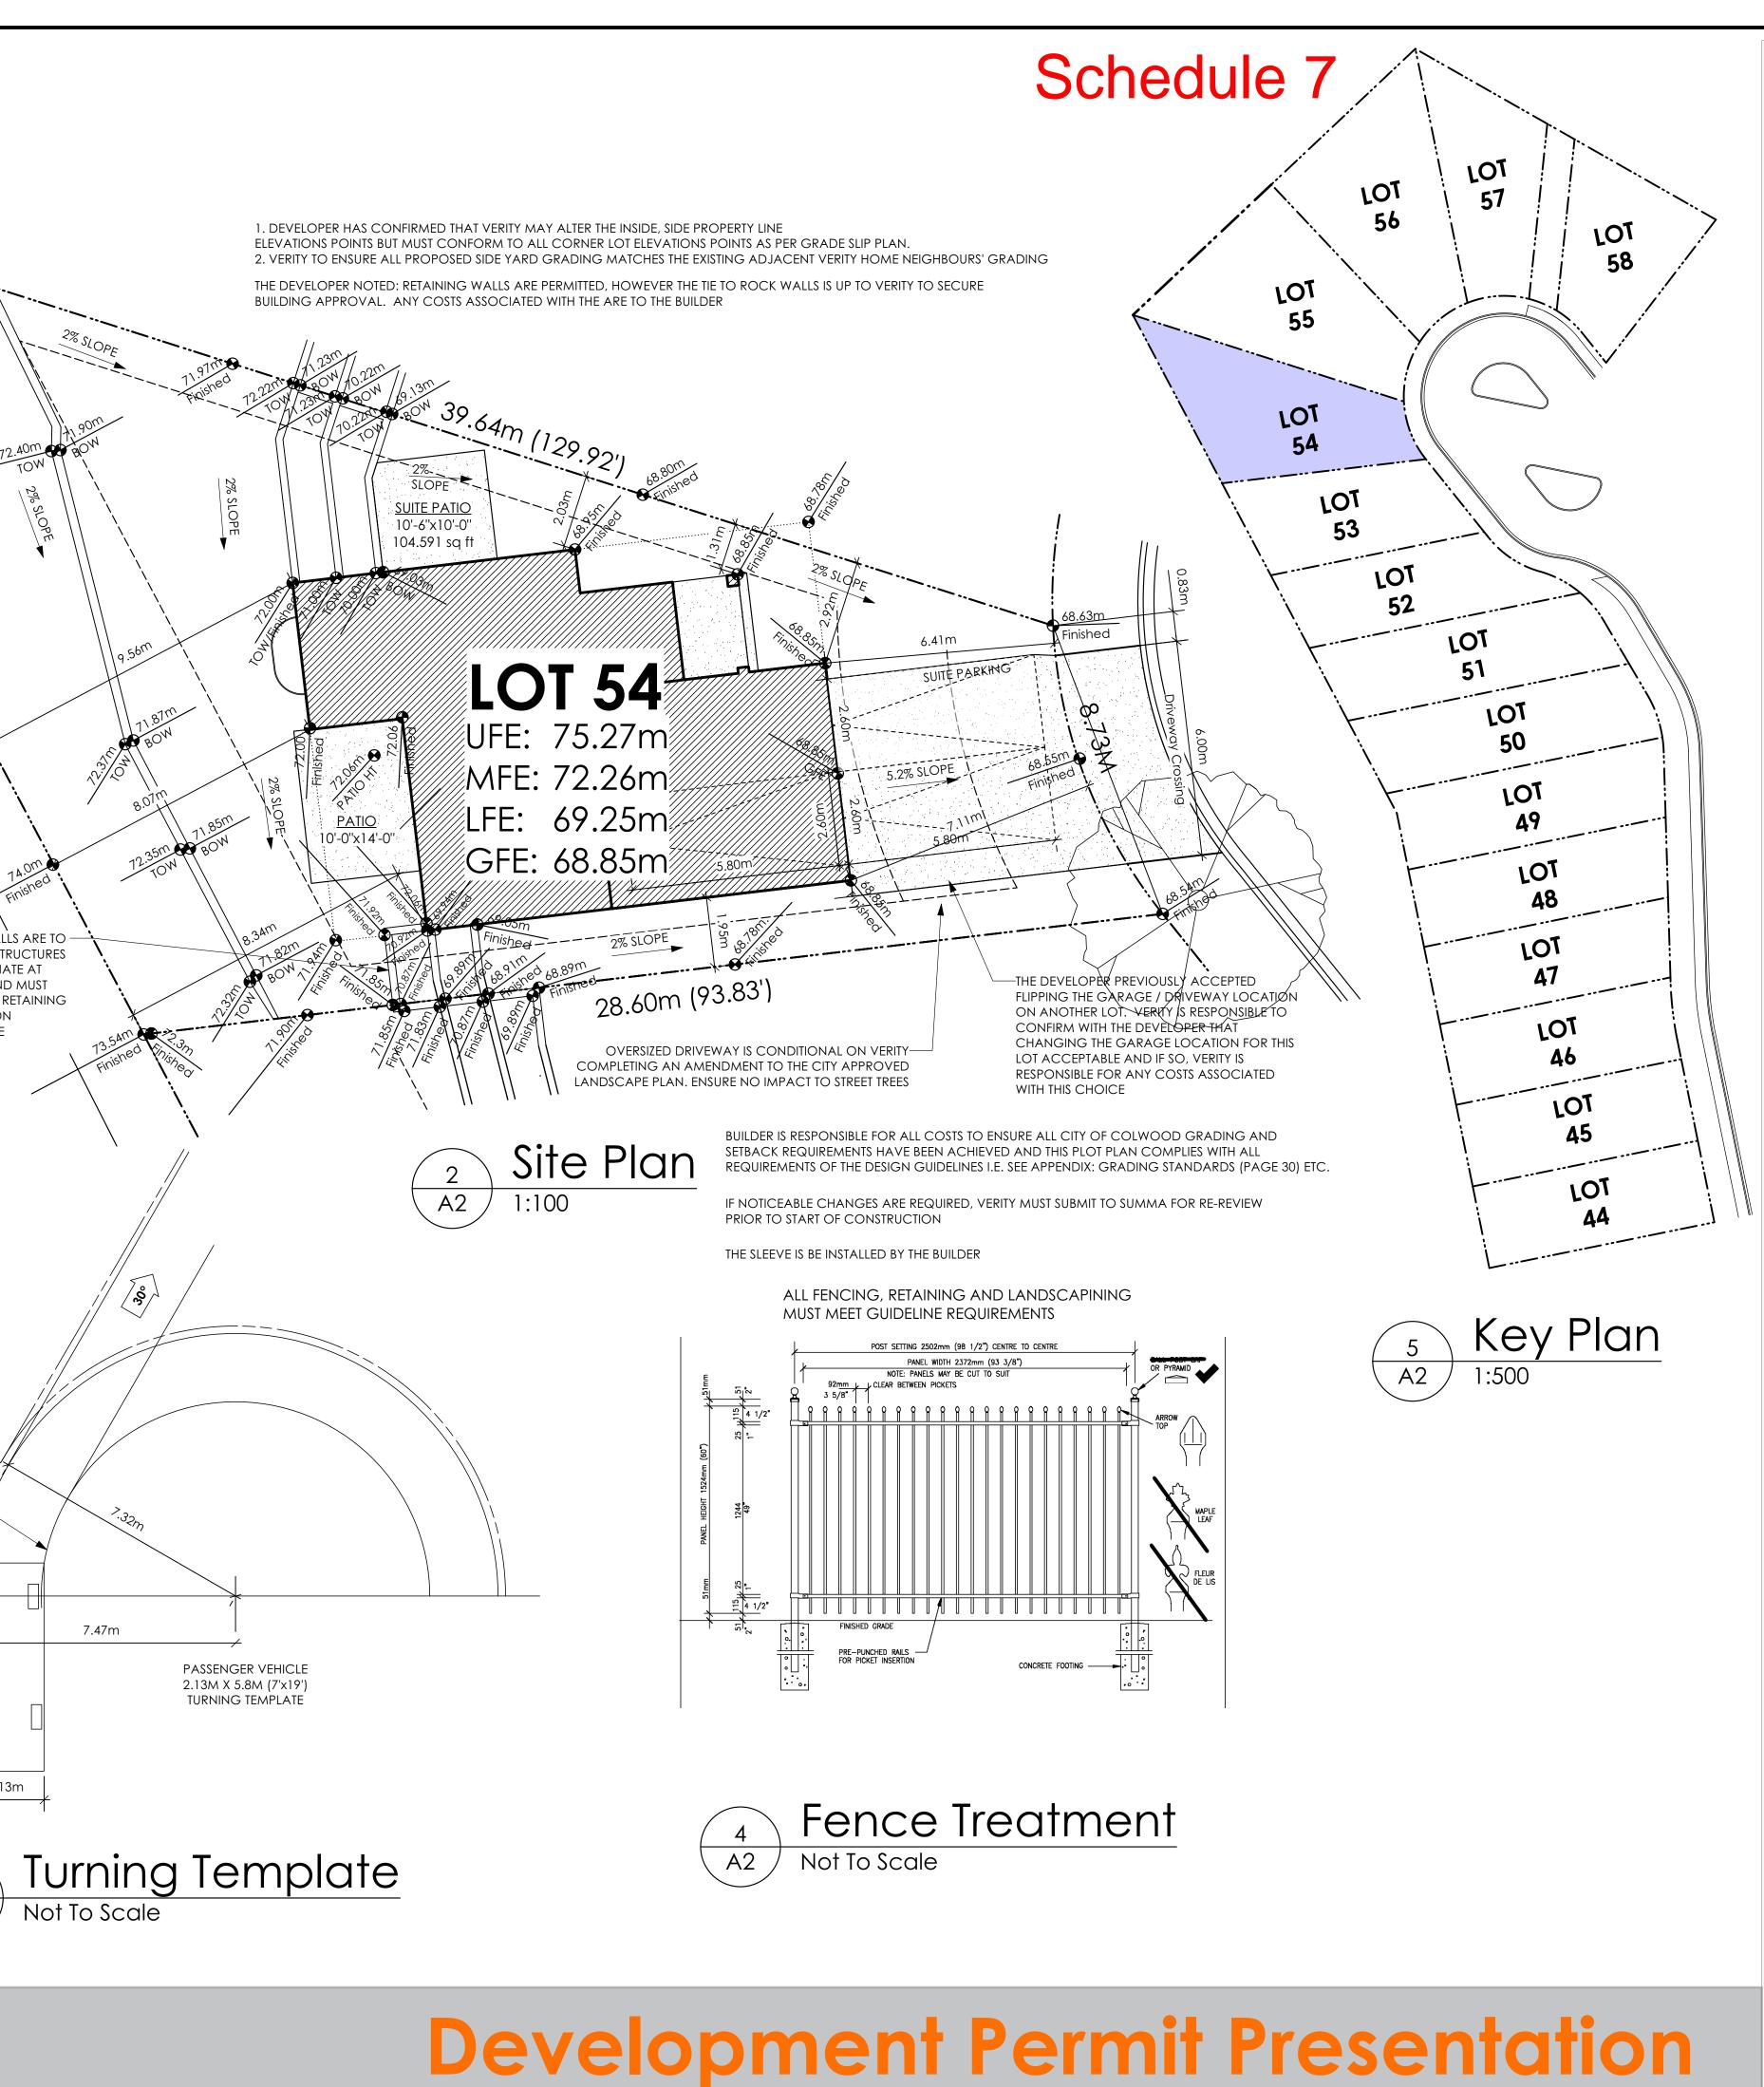



#103 - 891ATTREE AVENUE VICTORIA, B.C. V9B 0A6 P. 250.382.7374 F. 250.382.7364

GENOA WESTCOAST

Date March 15, 2023


Project Address 3481 Trumpeter Street Royal Bay - Sector 7 Colwood, B.C. Prepared for

Verity Construction

Project # 8298-54

Scale As Noted

Drawn By MDK

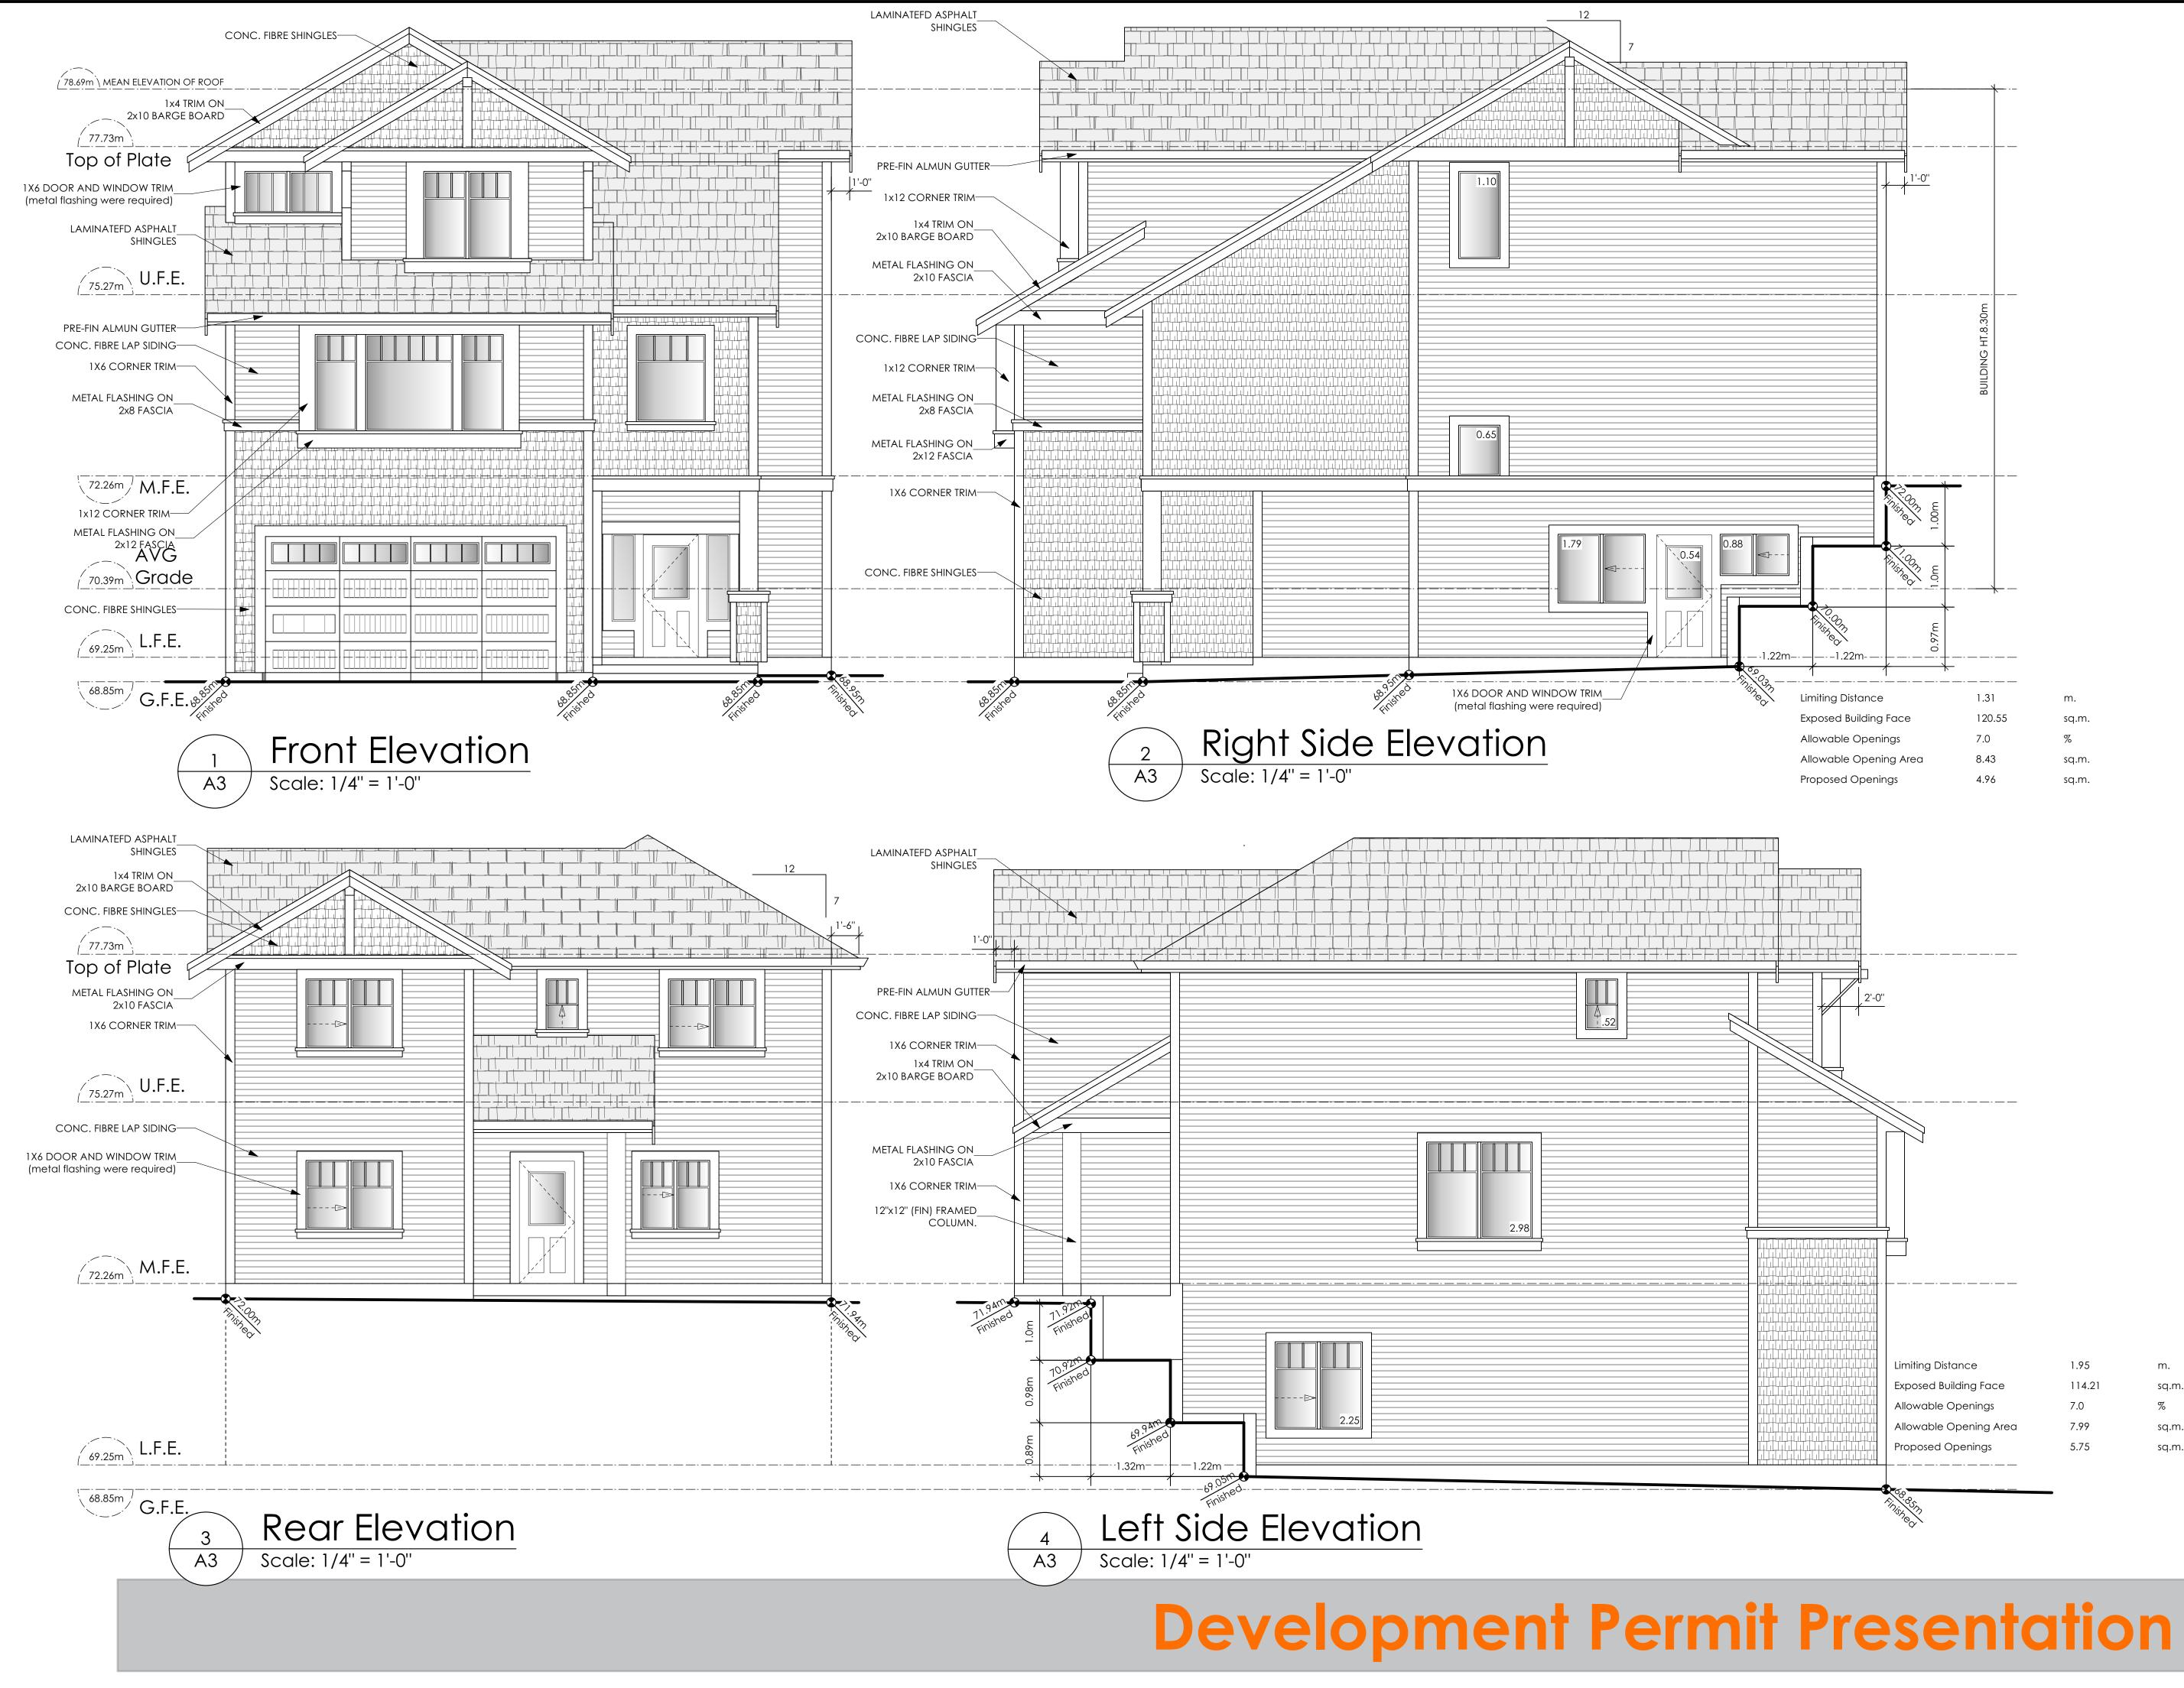



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GENOA WESTCOAST

Date March 15, 2023

Project Address 3481 Trumpeter Street Royal Bay - Sector 7 Colwood, B.C. **Prepared for**

Verity Construction

Project #

m.

%

sq.m.


sq.m.


sq.m.

8298-54

Scale As Noted

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/d Victoria design group
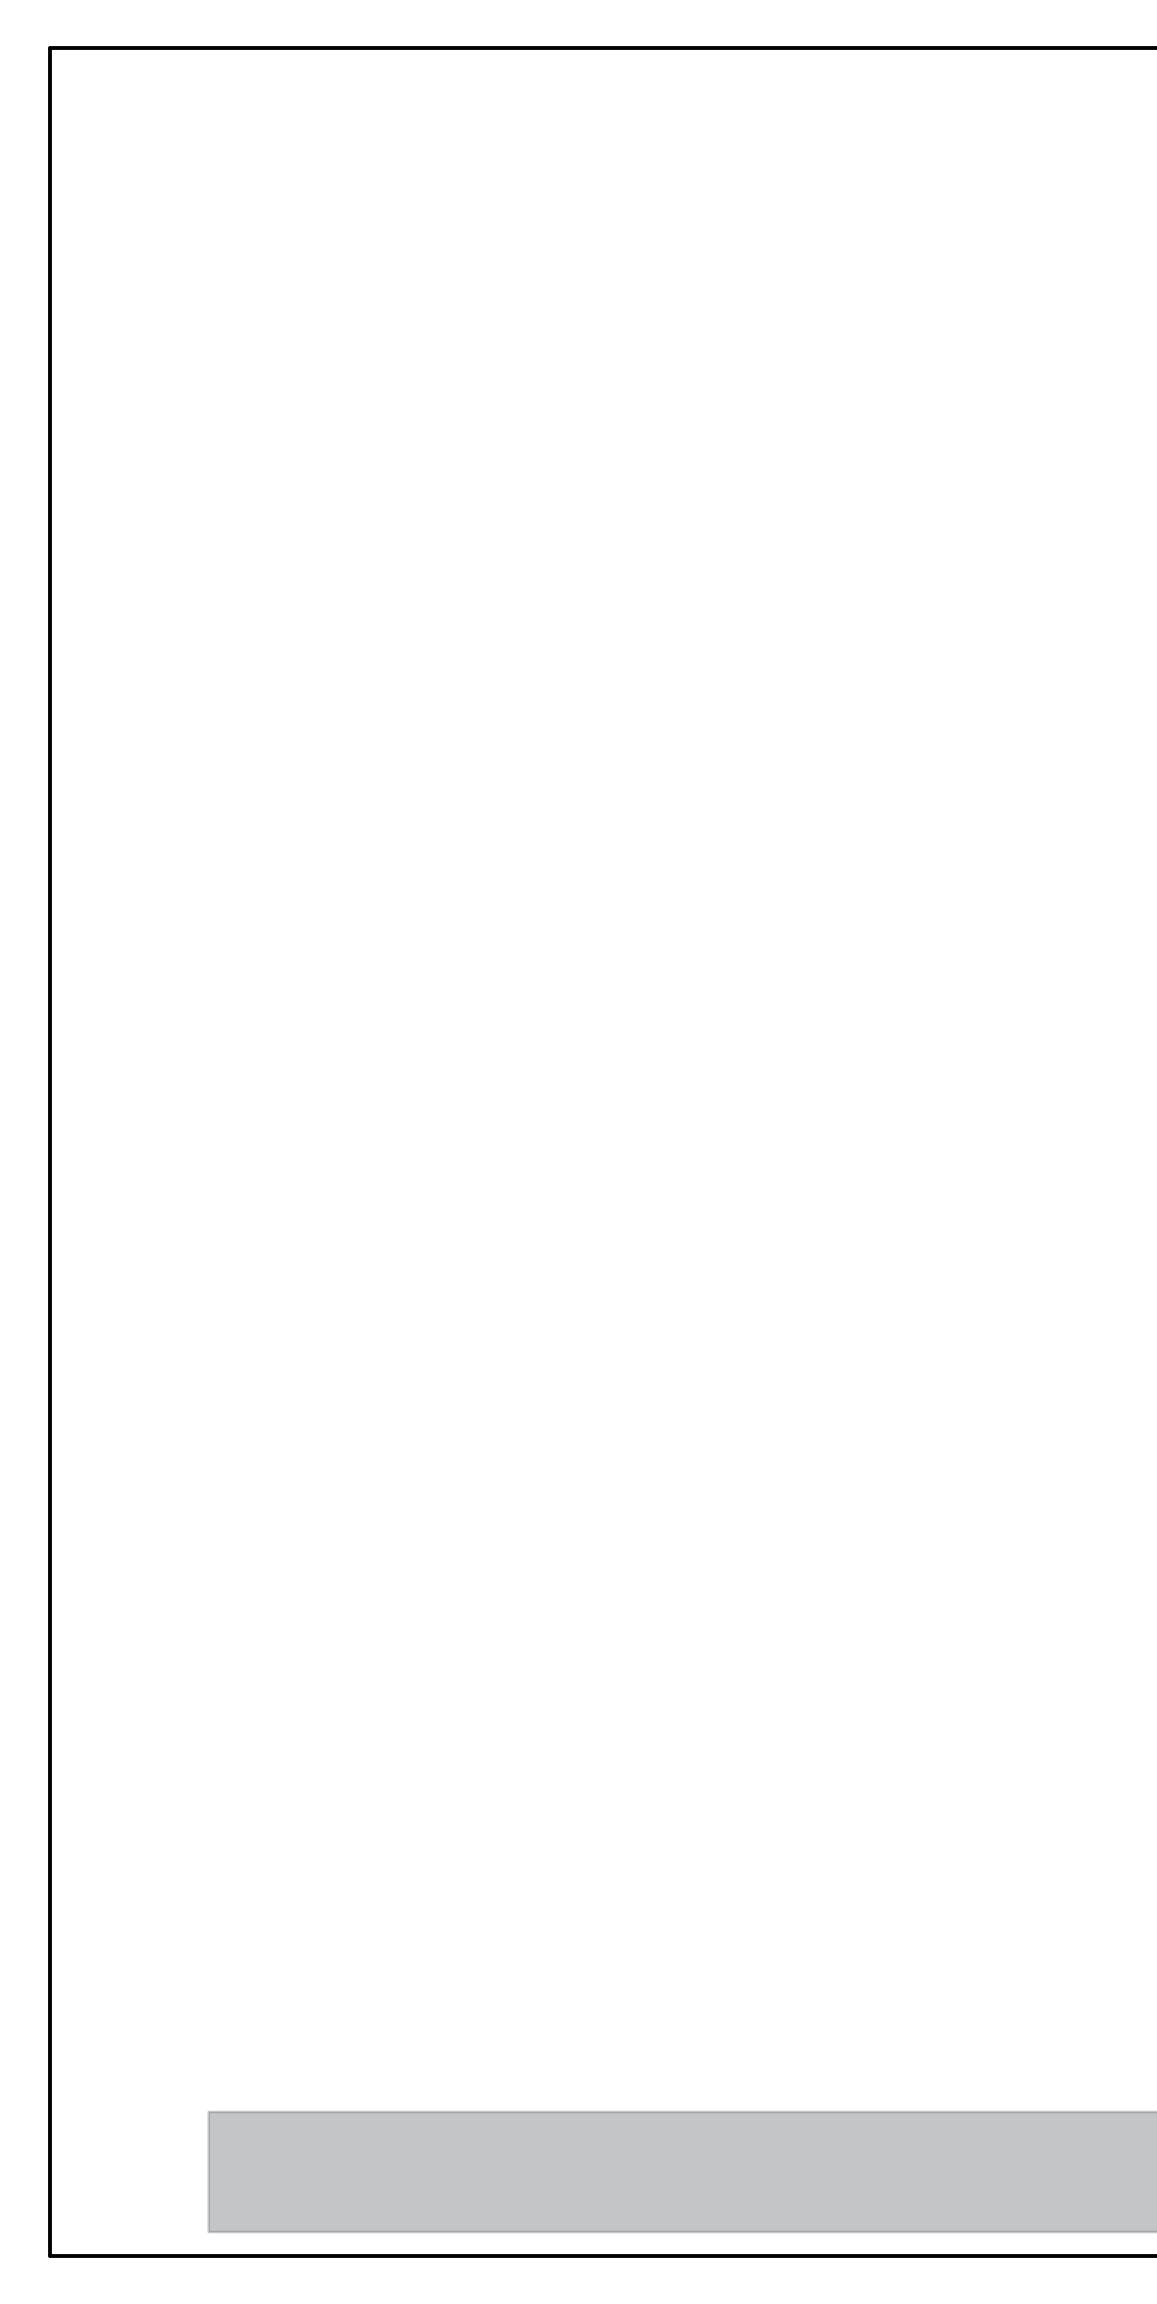
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GENOA WESTCOAST

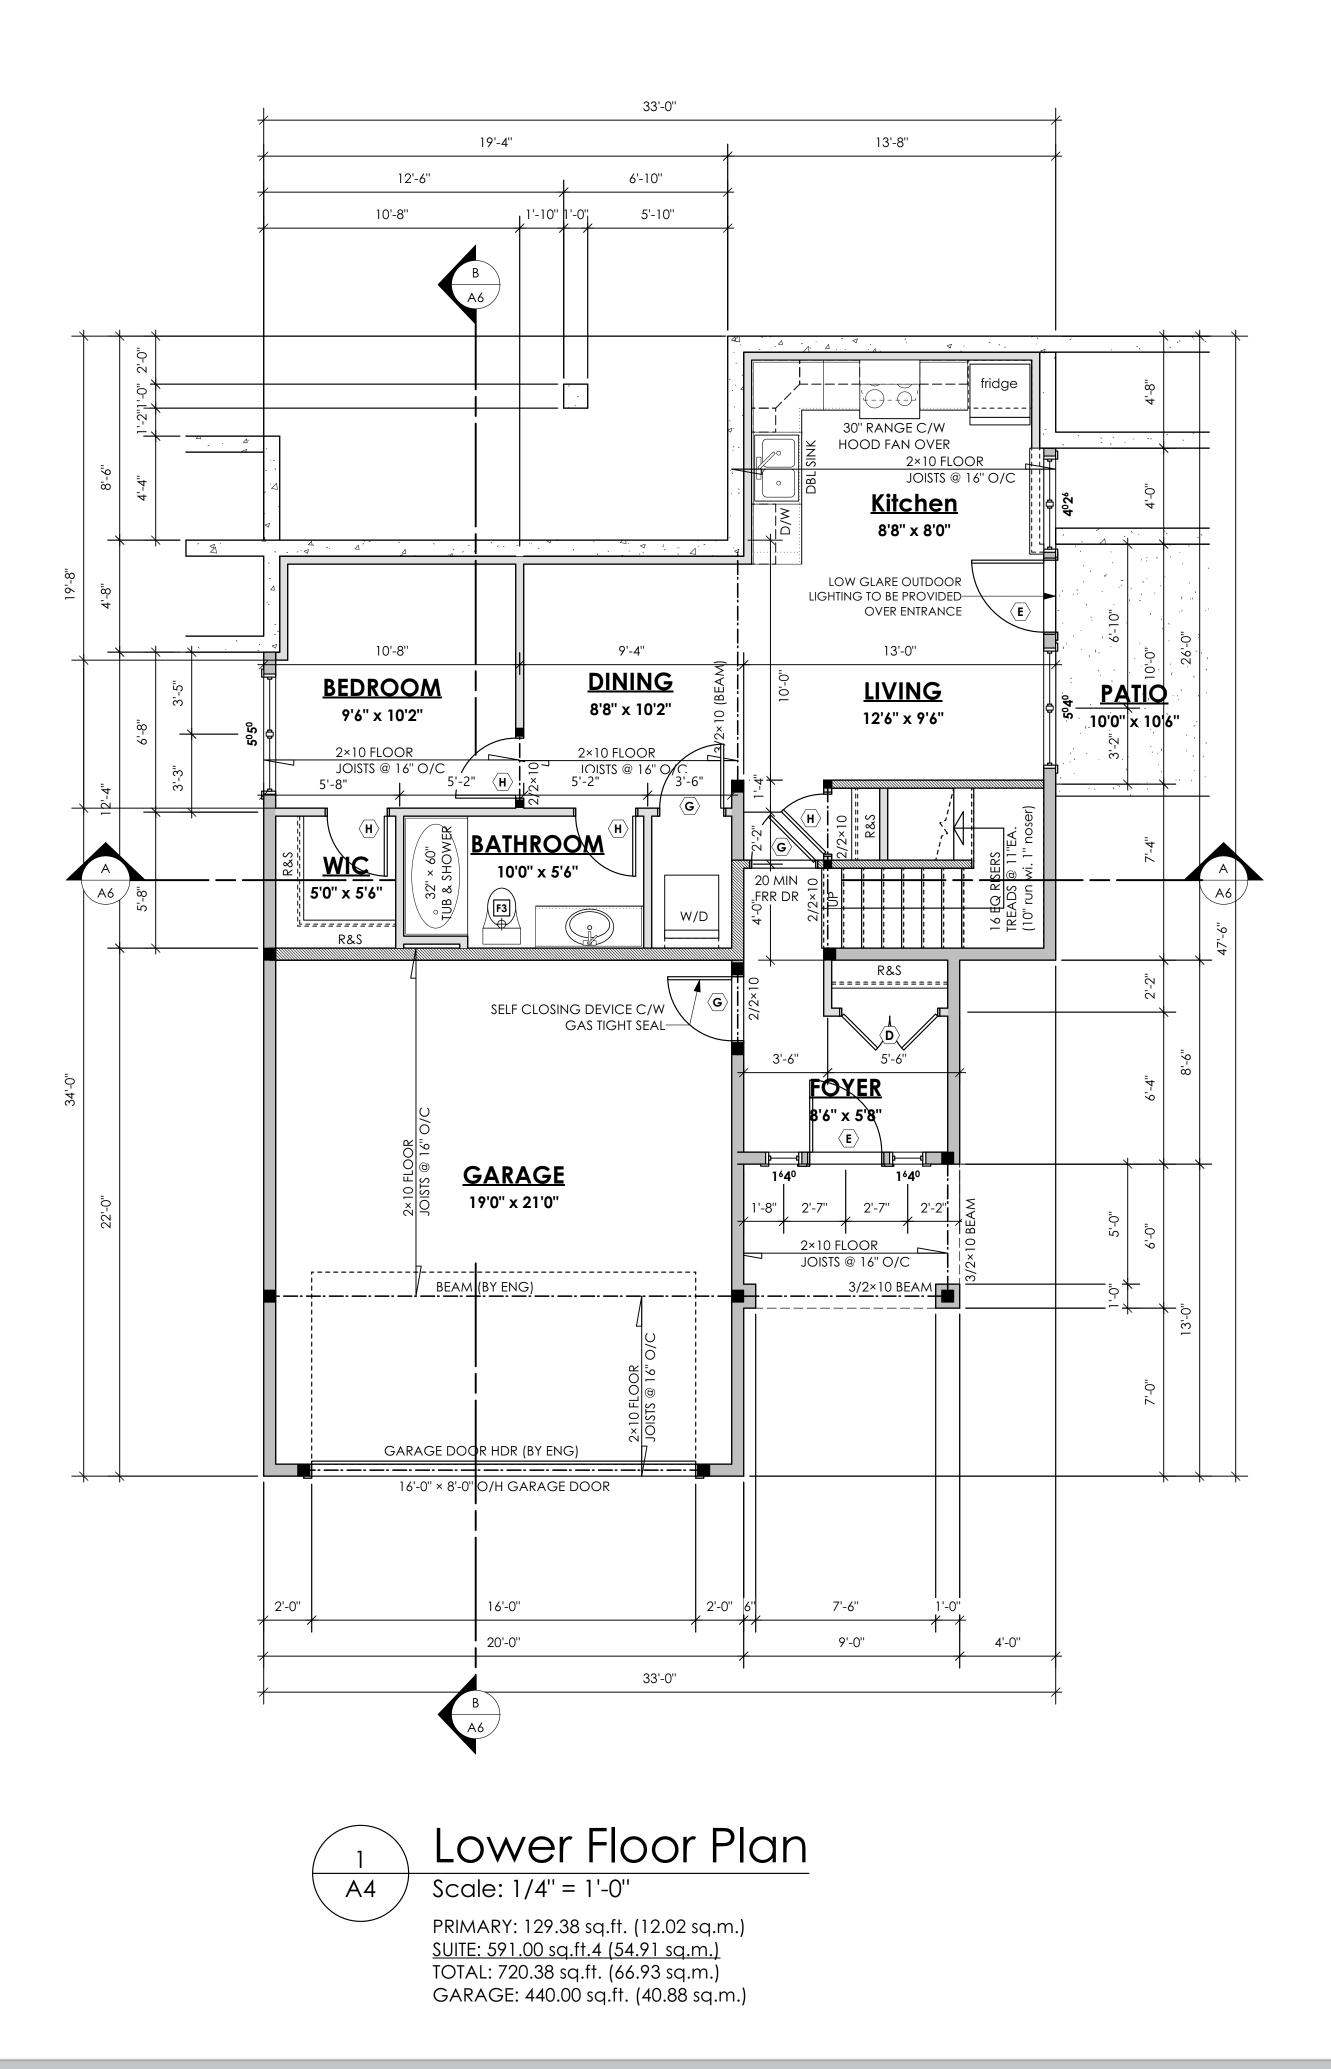Date March 15, 2023


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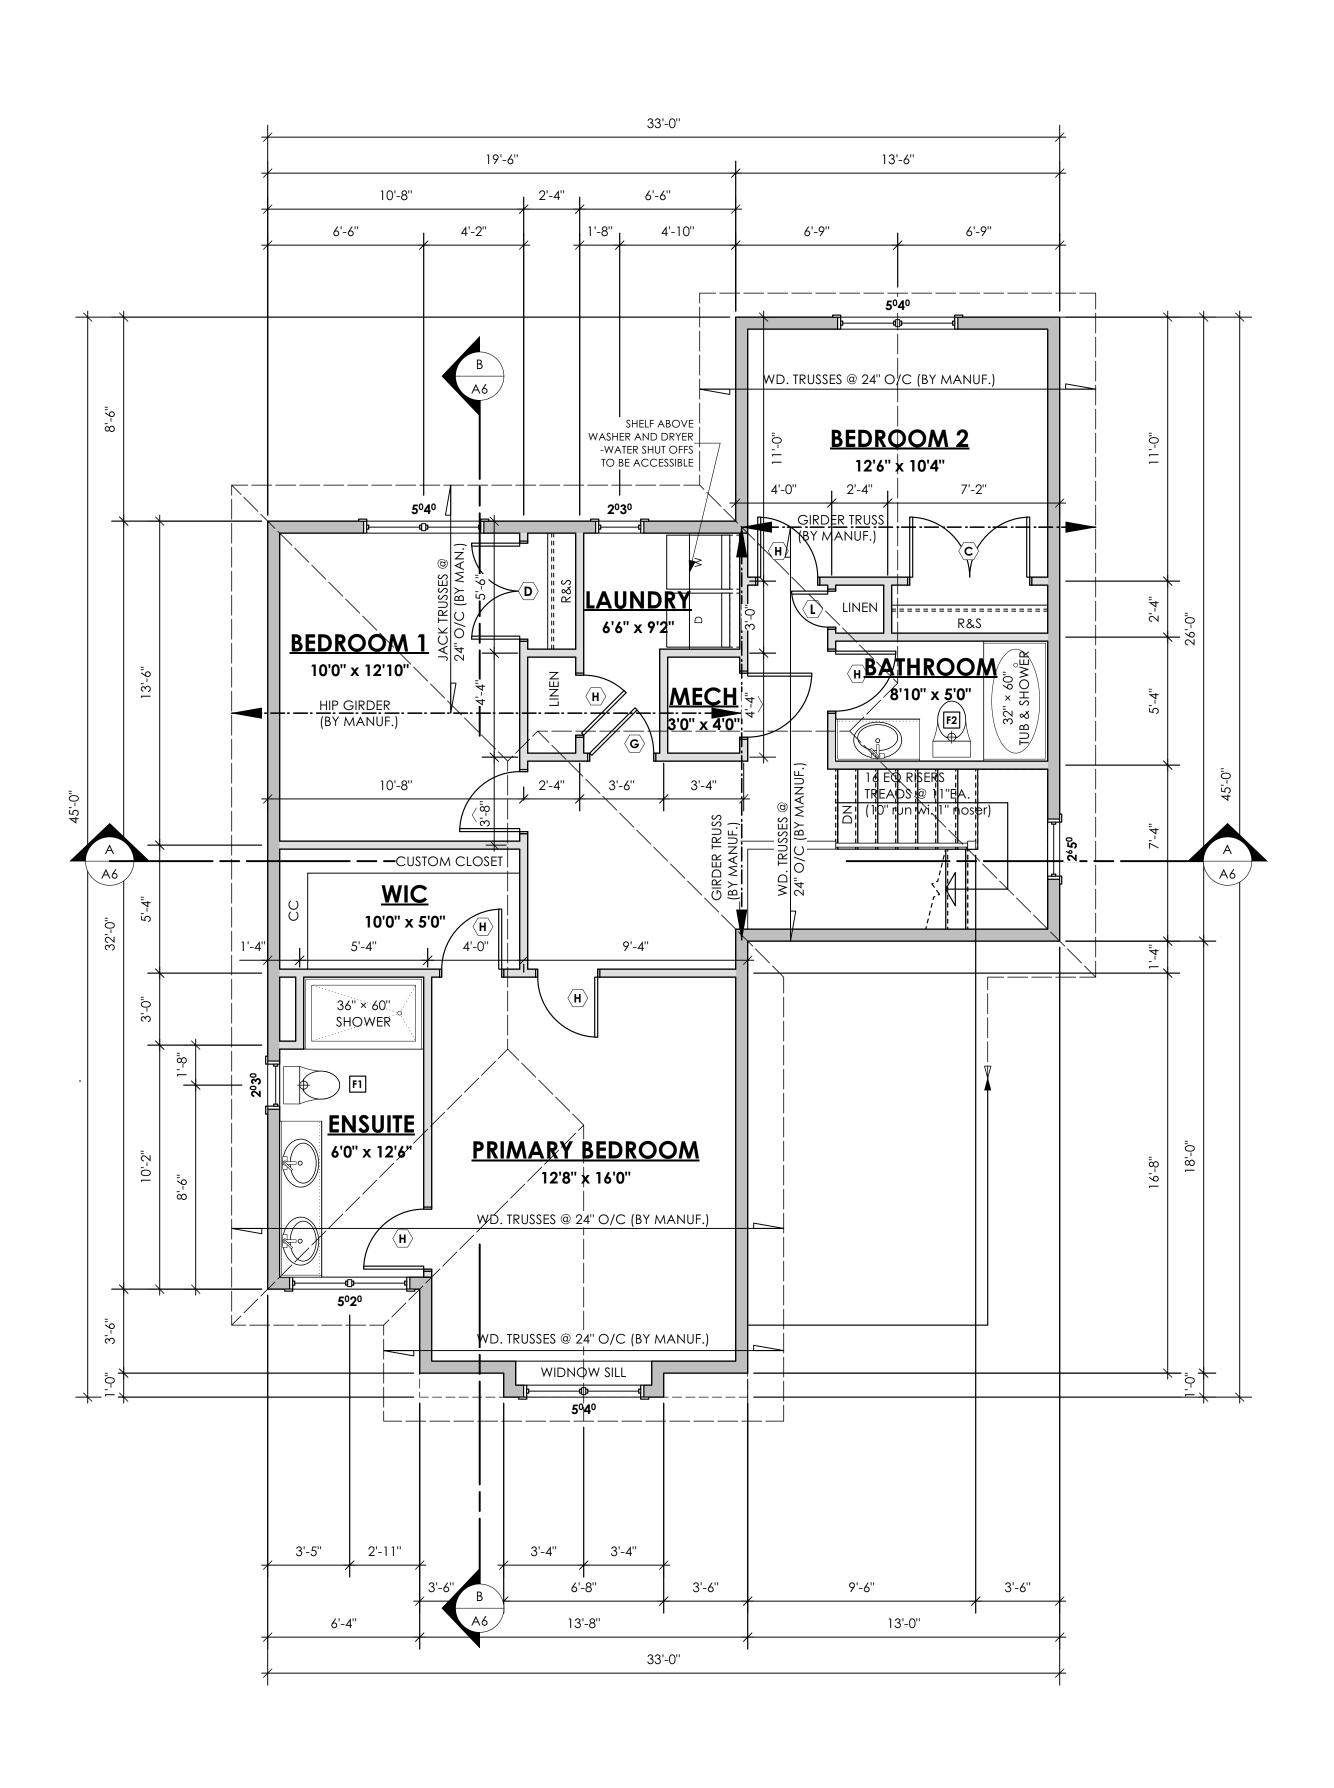
Verity Construction

Project # 8298-54

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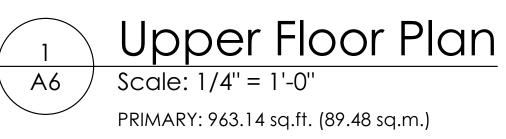
Drawn By MDK



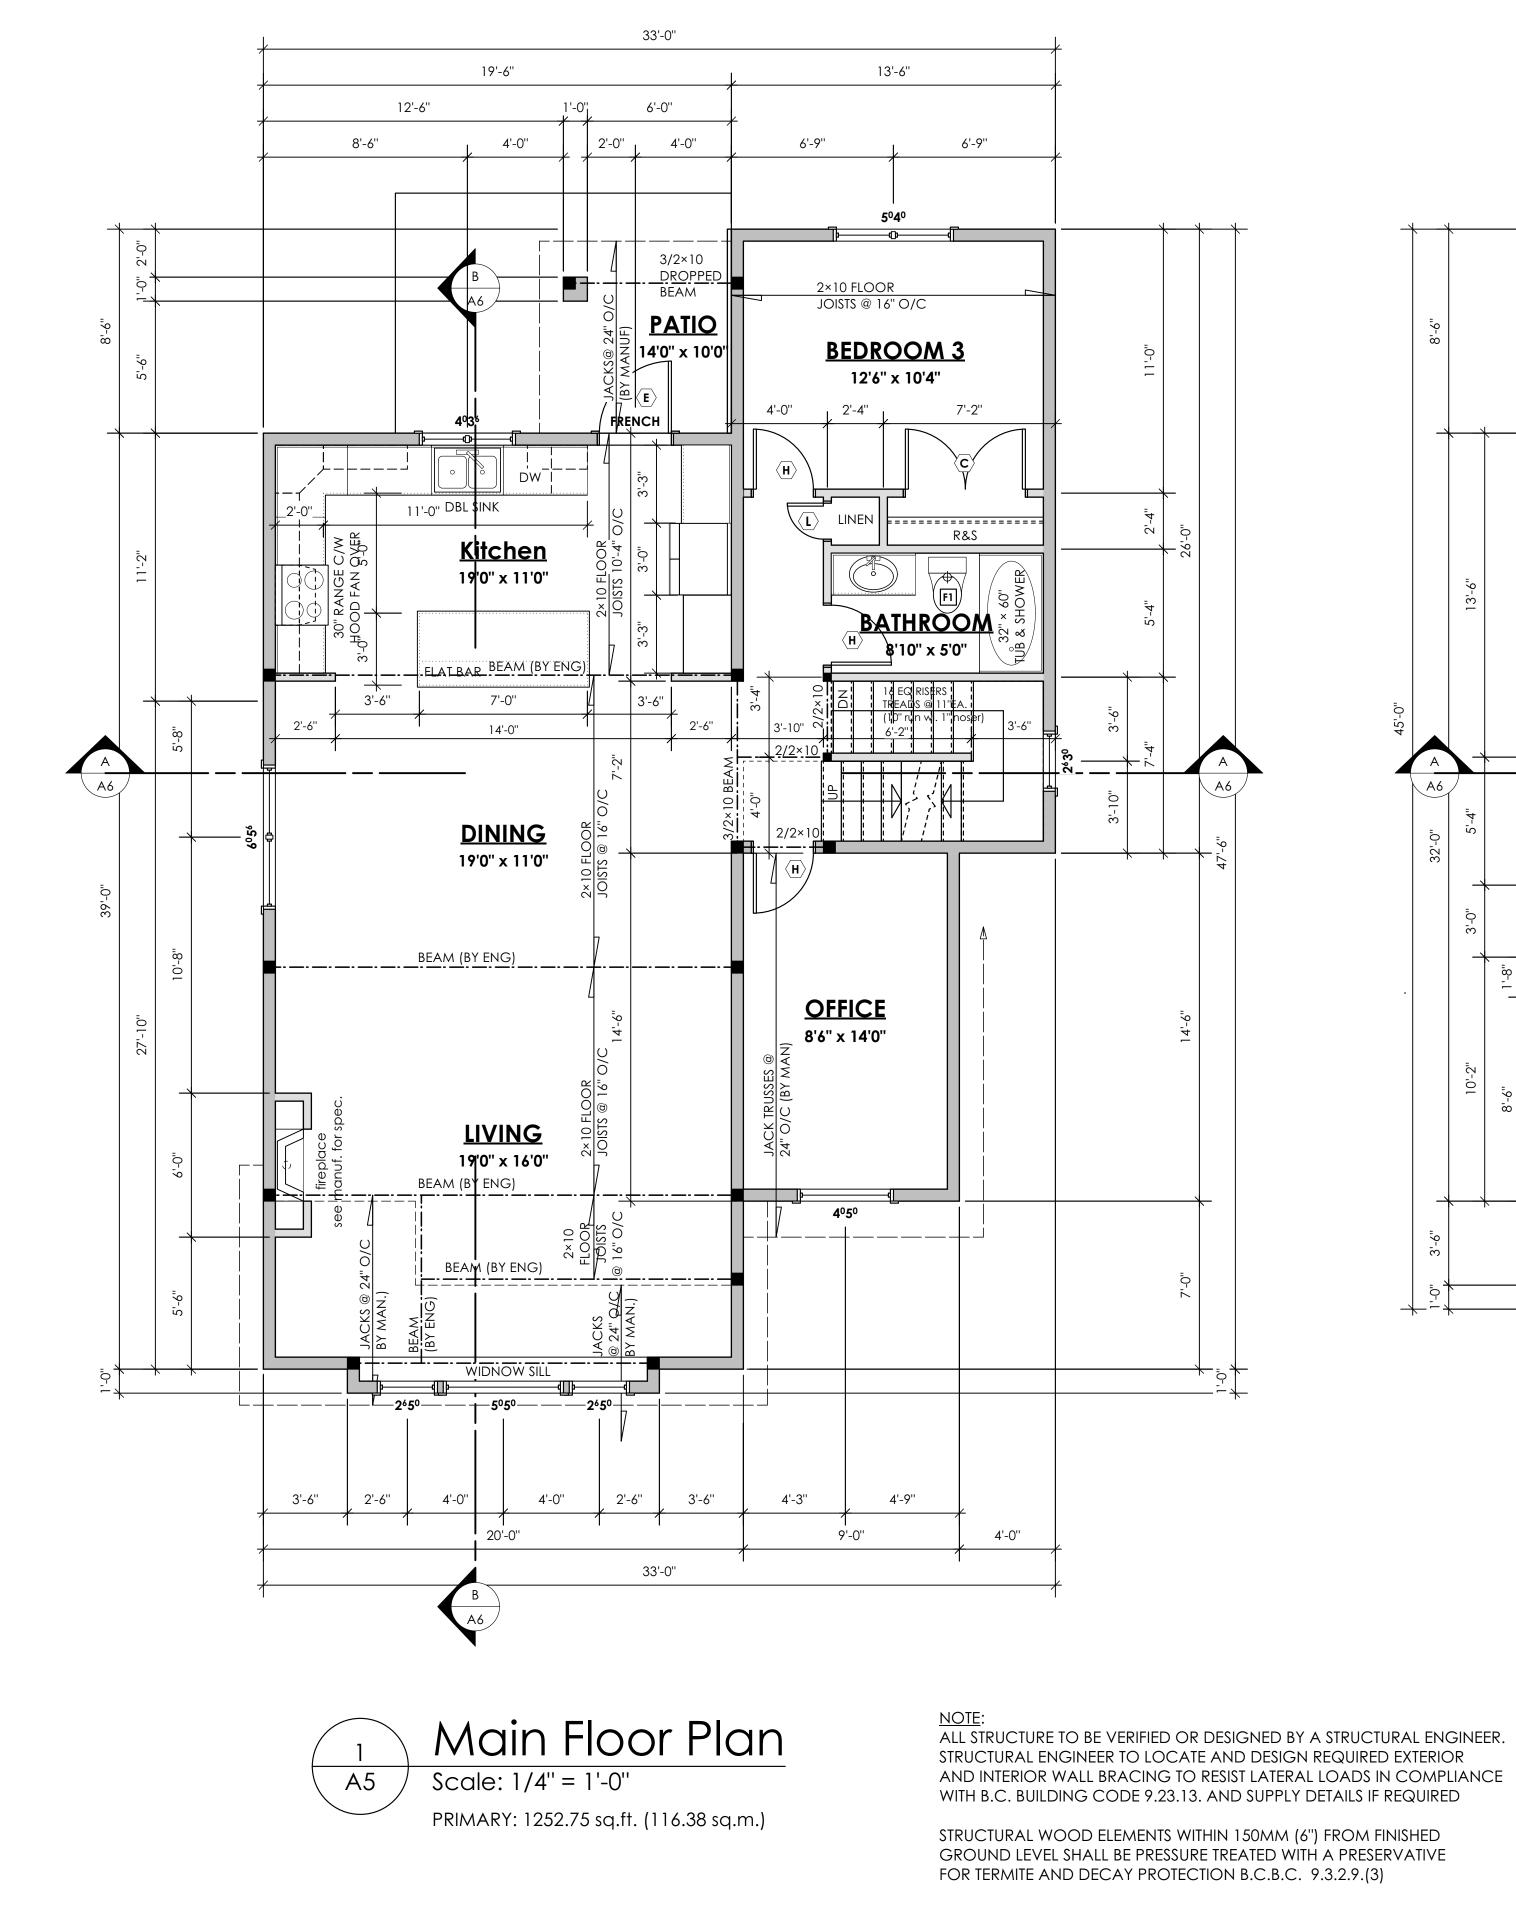

STRUCTURAL ENGINEER TO LOCATE AND DESIGN REQUIRED EXTERIOR AND INTERIOR WALL BRACING TO RESIST LATERAL LOADS IN COMPLIANCE WITH B.C. BUILDING CODE 9.23.13. AND SUPPLY DETAILS IF REQUIRED

STRUCTURAL WOOD ELEMENTS WITHIN 150MM (6") FROM FINISHED GROUND LEVEL SHALL BE PRESSURE TREATED WITH A PRESERVATIVE FOR TERMITE AND DECAY PROTECTION B.C.B.C. 9.3.2.9.(3)



Development Permit Presentation





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GENOA WESTCOAST

Date March 15, 2023


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Date March 15, 2023


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68.55m Finished

GENOA WESTCOAST

Date March 15, 2023


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Verity Construction

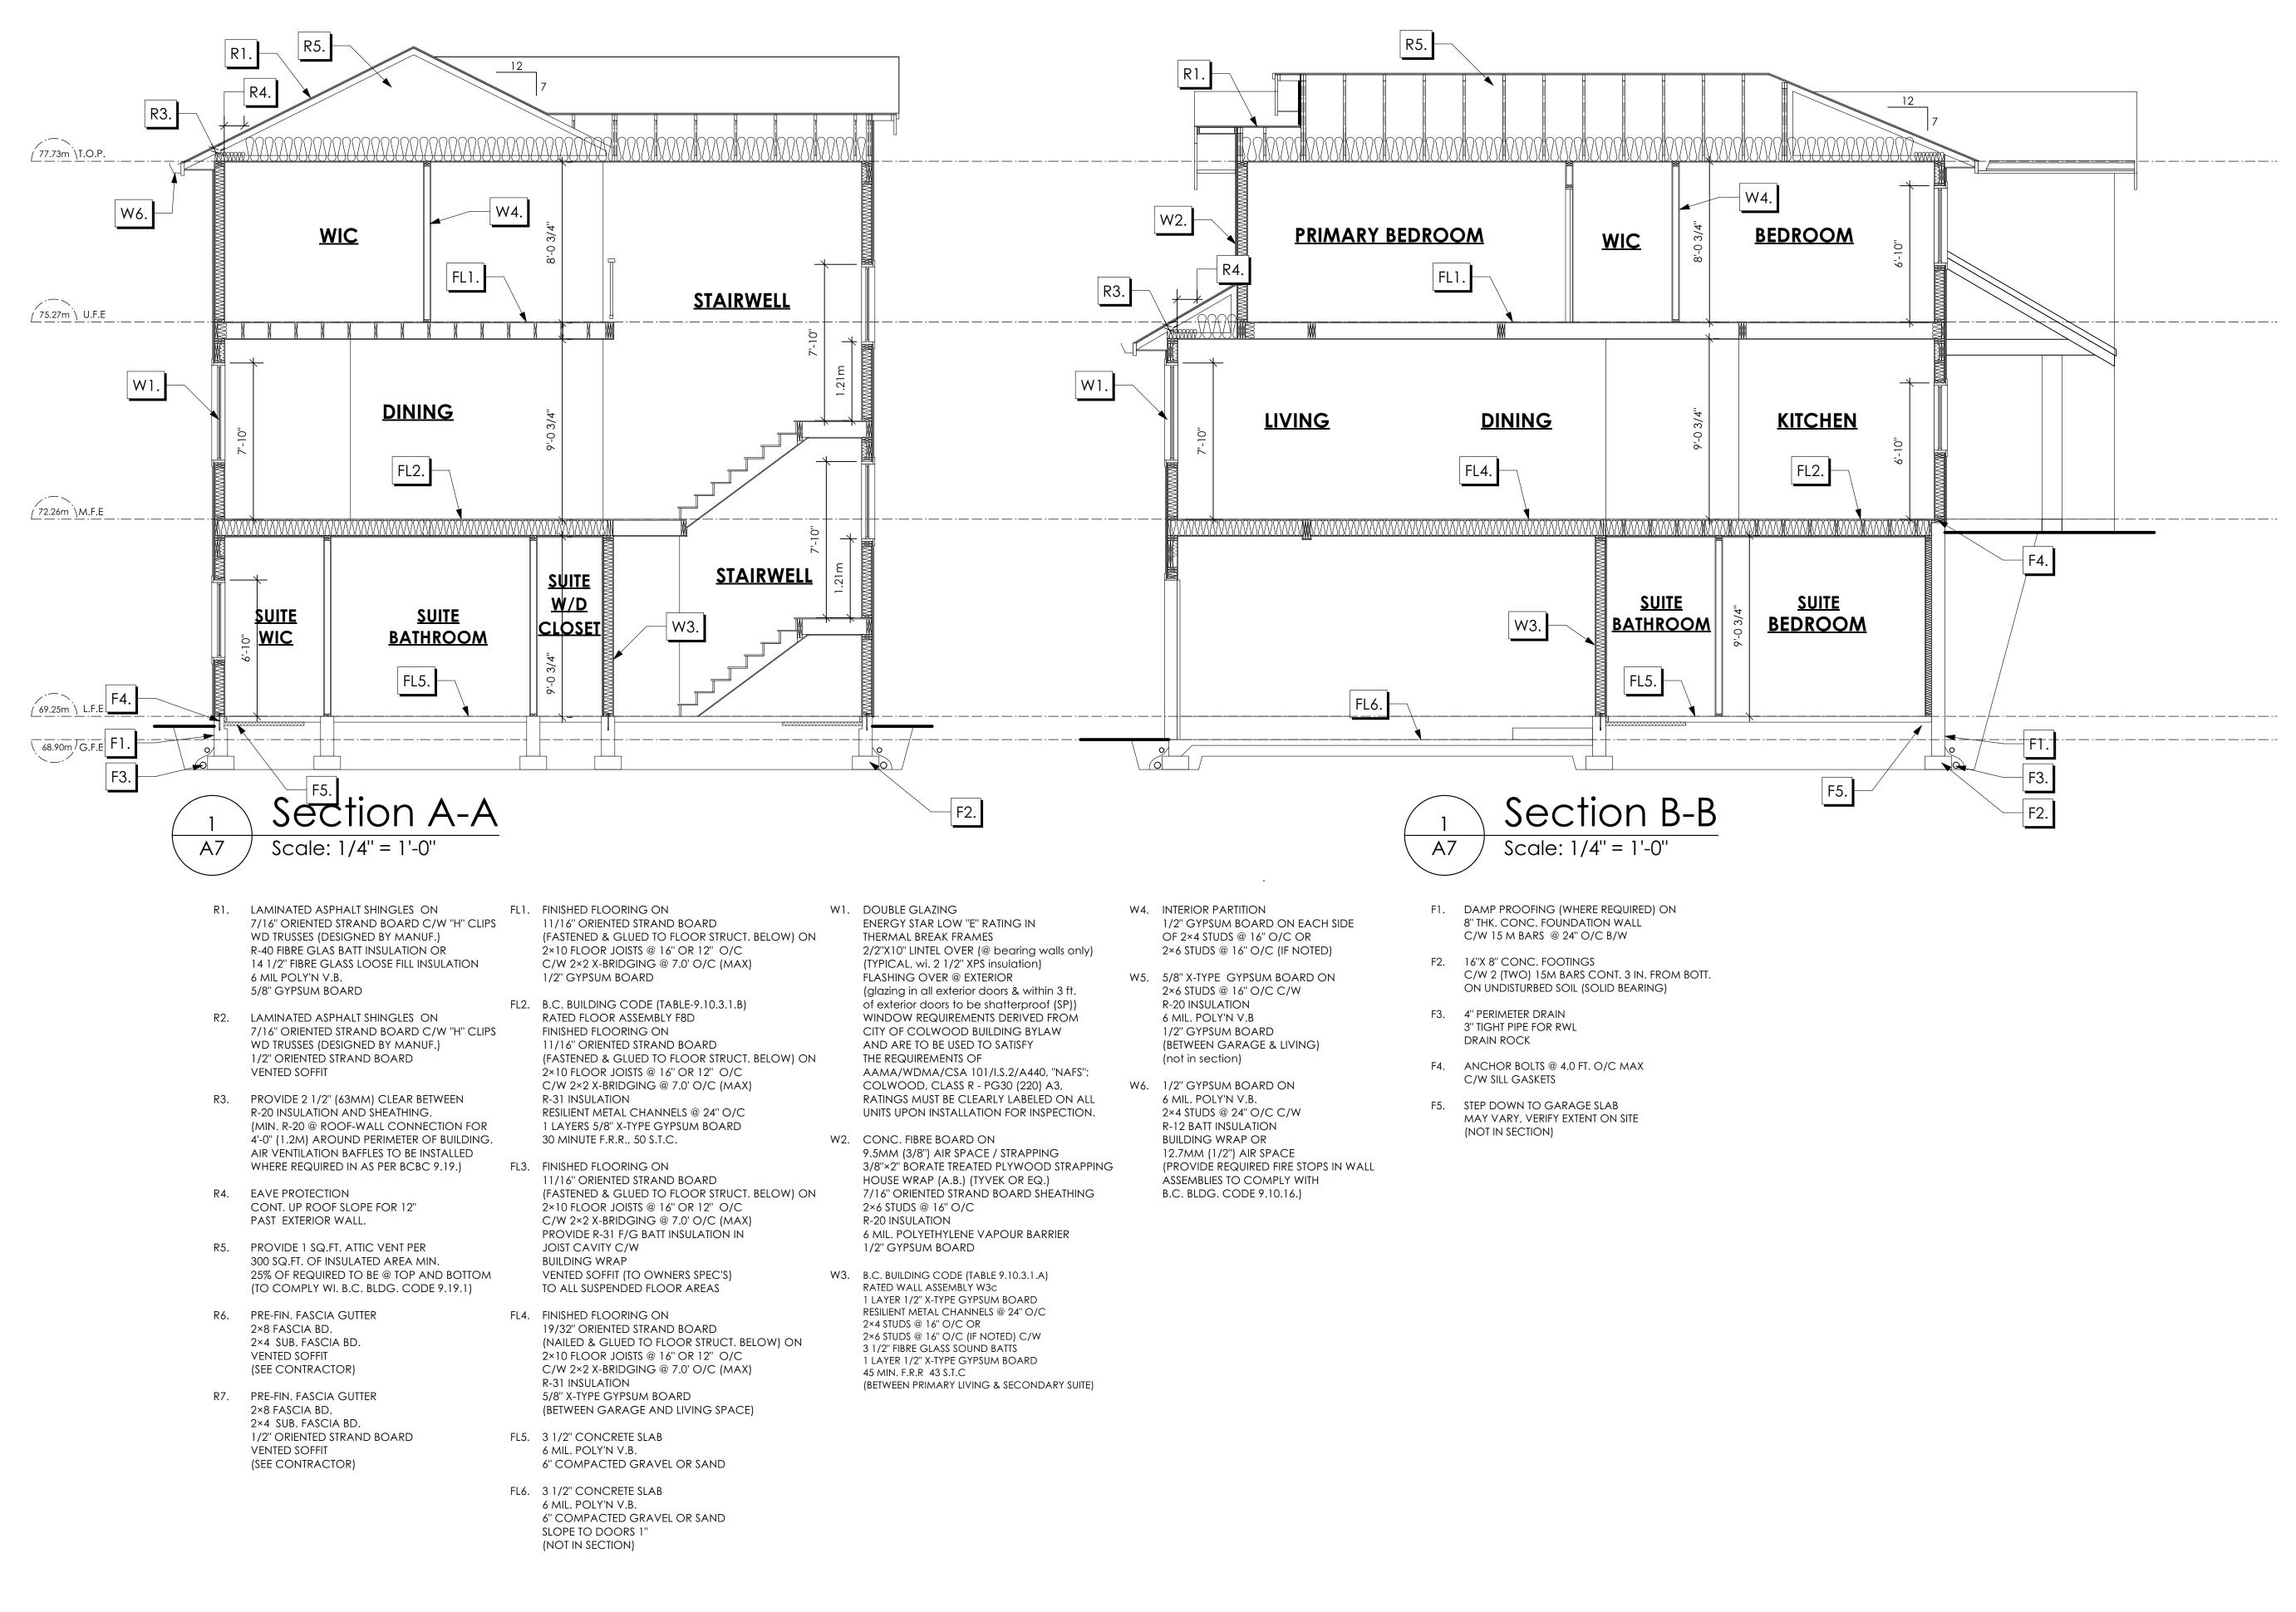Project # 8298-54

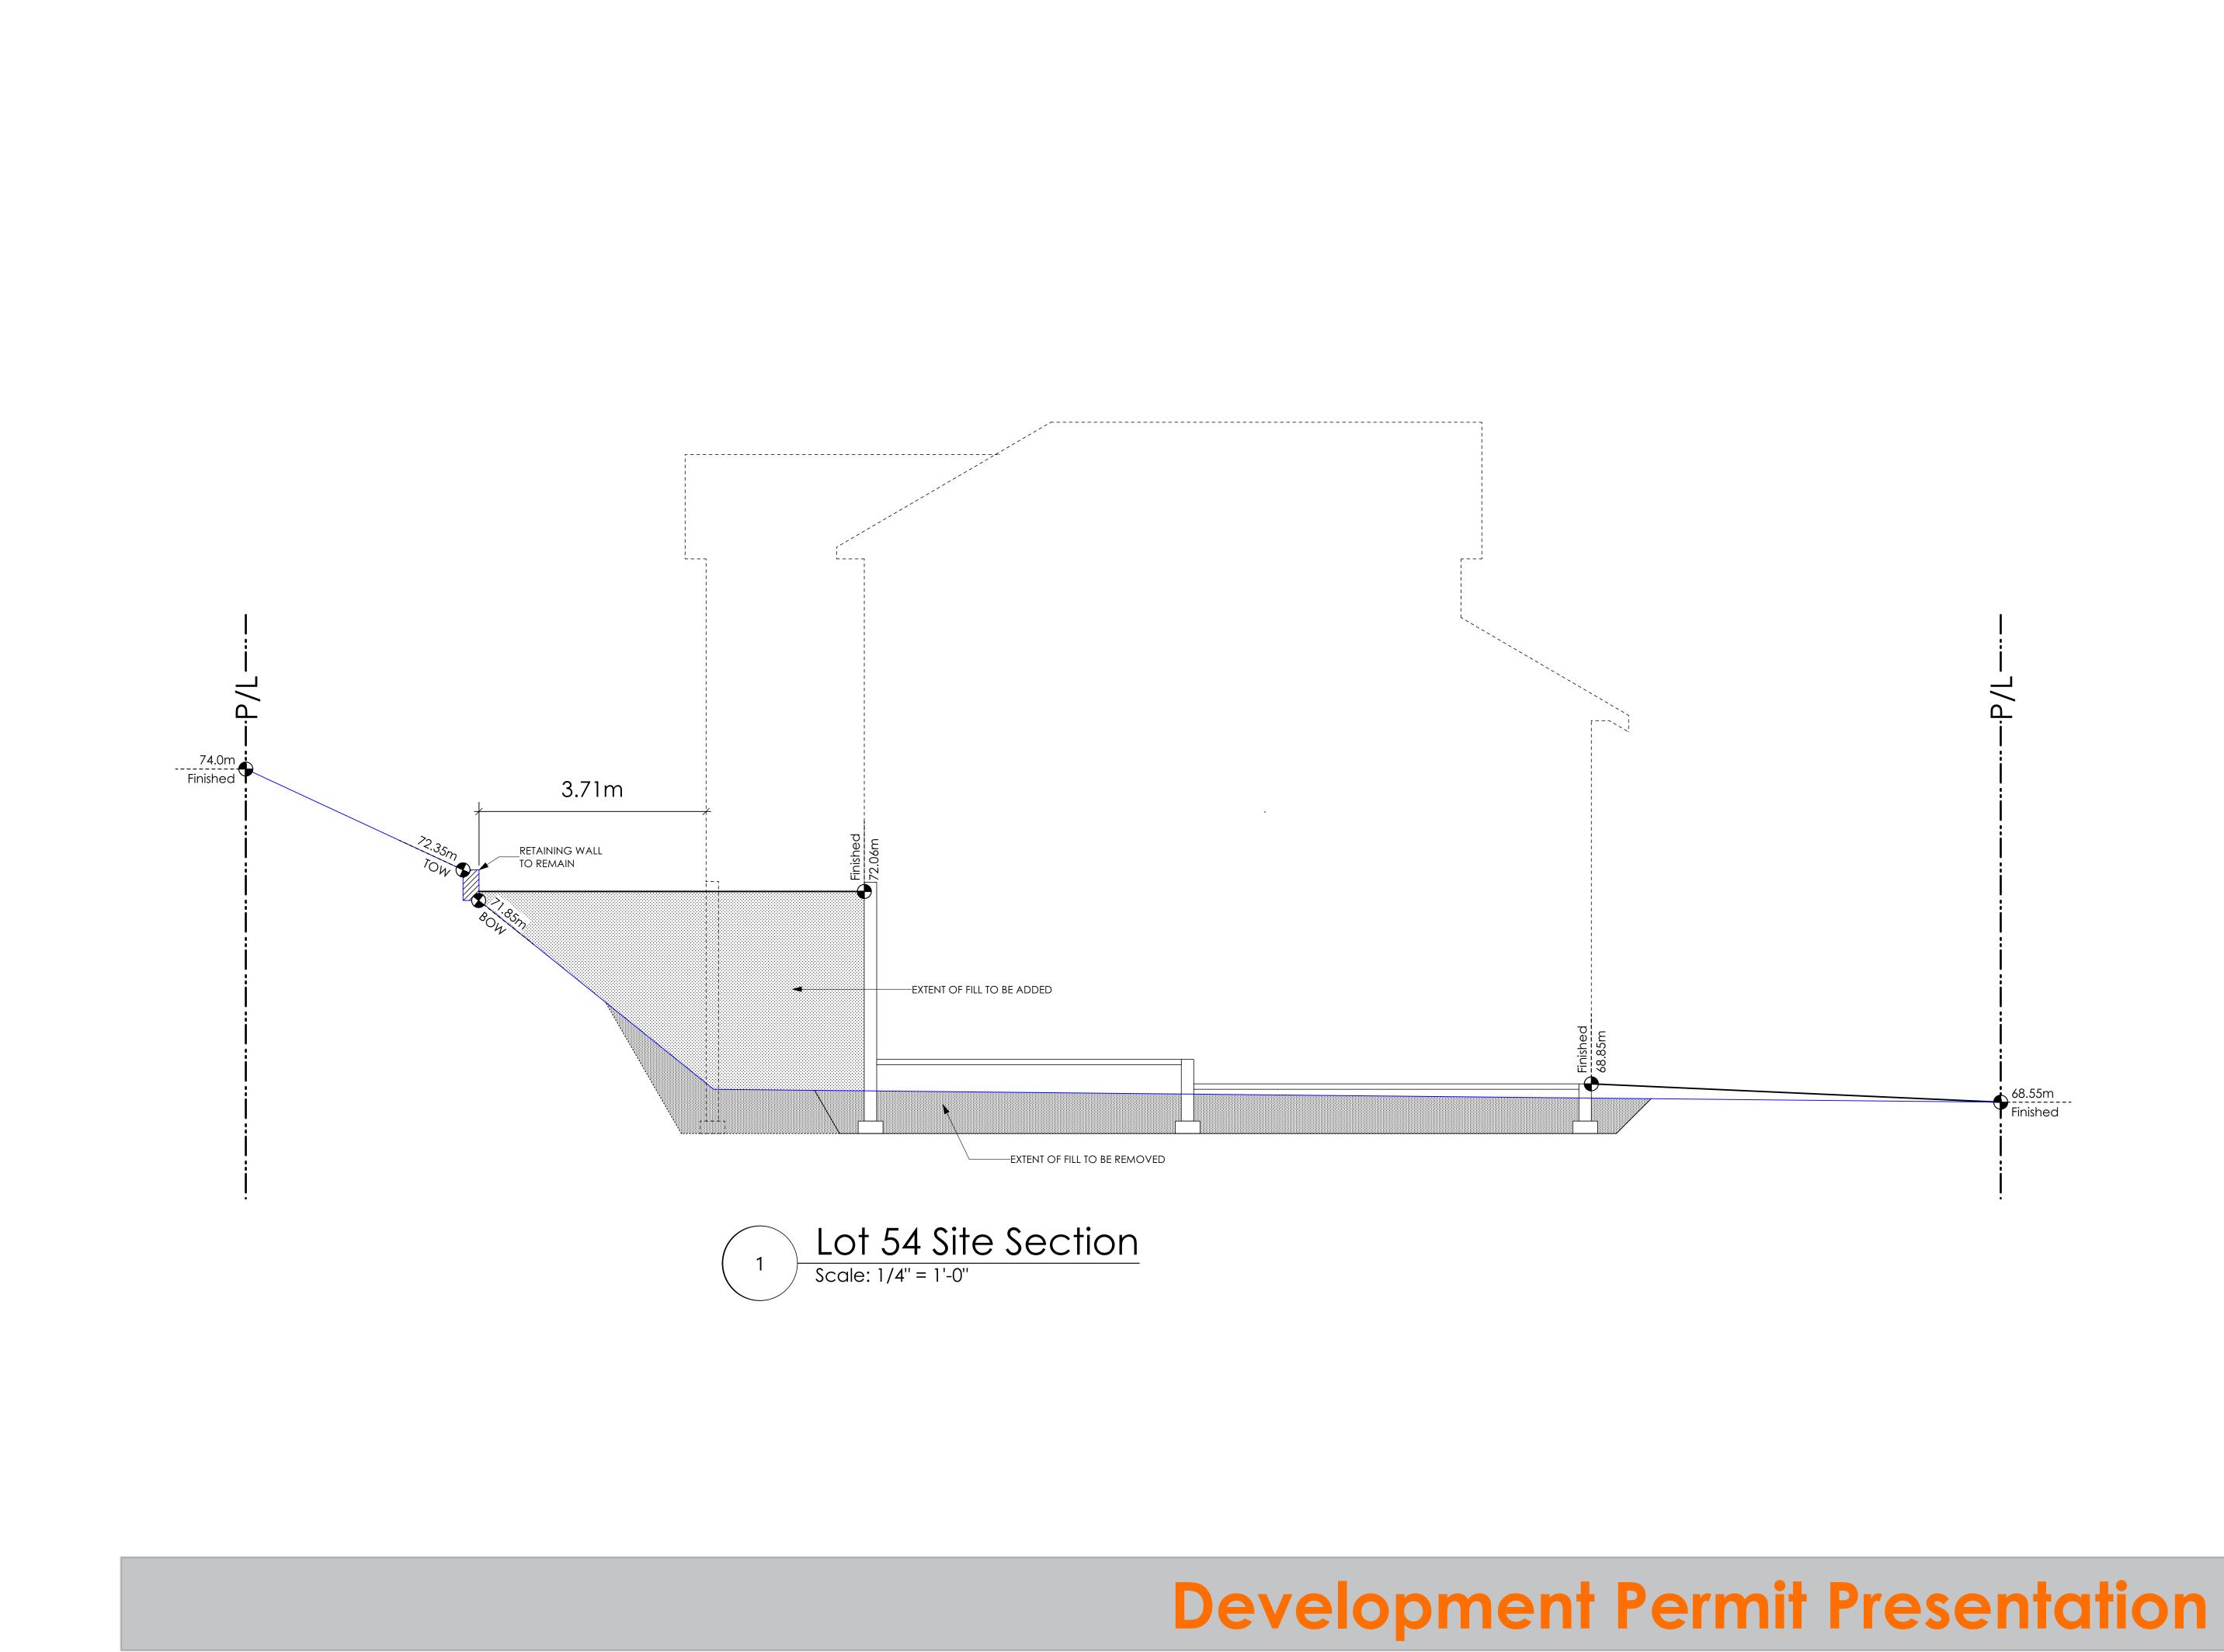Scale As Noted

Drawn By MDK

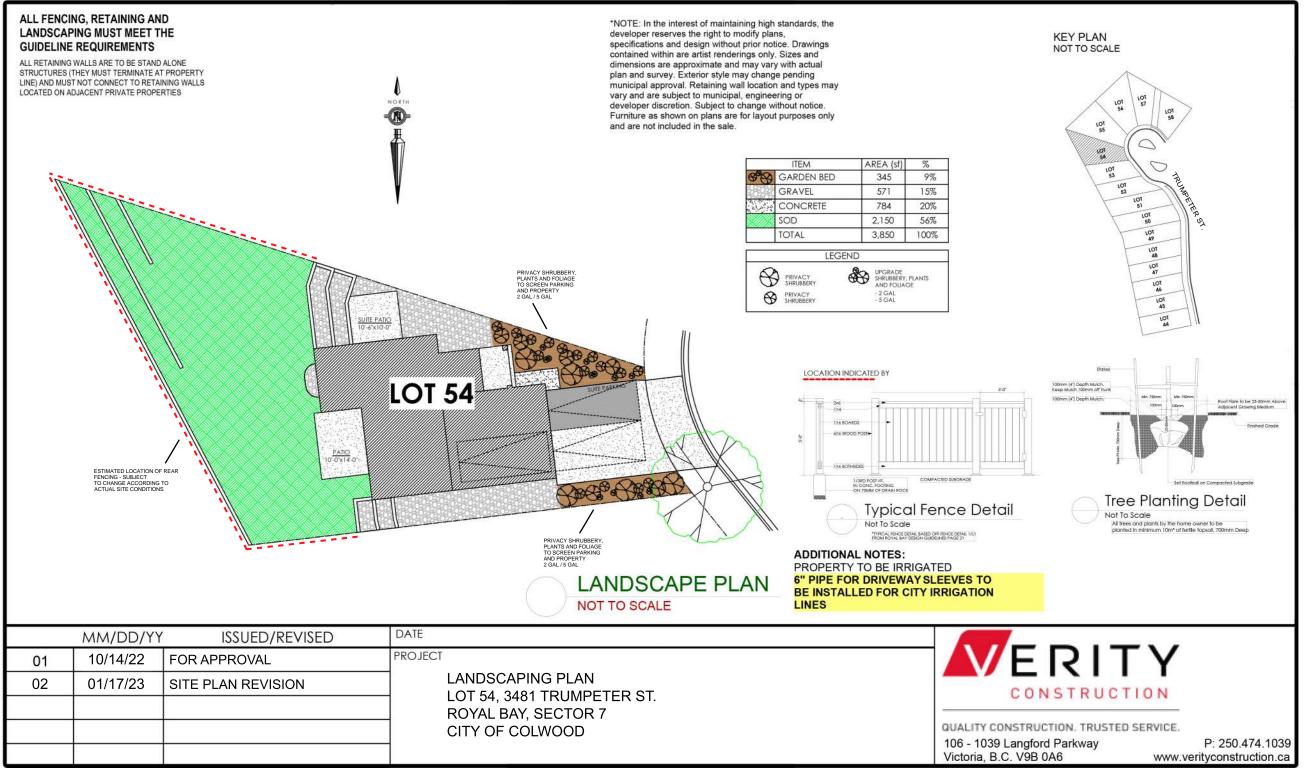

GABLECRAFT HOMES BUILDING GRADE SLIP

WSP Project No: <u>201-08151-00</u>

Issue Date: _____

MUNICIPAL ADDRESS	P.I.D.
LOT 54	PLAN
BUILDER VERITY HOMES	SUBDIVISION ROYAL BAY SECTOR 7
ADDRESS	DEVELOPER MEADOWS DEVELOPMENT LP
REPRESENTATIVE PH.	CONSULTANT WSP CANADA INC
REPRESENTATIVE PH. PROPOSED BUILDING GRADES ALL ELEVATIONS ARE METRIC GEODETIC +	CONSULTANT
SEWER TO SUMP PUMP LIKELY REQUIRED	STREET STREET

L J L J WSP - May 13, 2022 8:07 AM D:\2021\211-00627-00_ROYAL BAY - SECTOR 7\3_TECH\3_CADD\3_SHEETS\211-00627-00-BUILDING-GRADE-SLIPS.DWG