

### CITY OF COLWOOD

3300 Wishart Road | Colwood | BC V9C 1R1 | 250-294-8153 planning@colwood.ca | www.colwood.ca

File: DP-22-023A

### **DEVELOPMENT PERMIT DP-22-023A**

THIS PERMIT, issued April \_\_\_ 2023 is,

ISSUED BY:

CITY OF COLWOOD, a municipality incorporated under the Local Government Act,

3300 Wishart Road, Victoria, BC, V9C 1R1

(the "City")

**PURSUANT TO:** 

Section 490 of the Local Government Act, RSBC 2015, Chapter 1

ISSUED TO:

Verity Construction Ltd 106-1039 Langford Parkway

Victoria, BC V9B 0A6

(the "Permittee")

 This Natural Hazards and Form and Character Development Permit applies to those lands within the City of Colwood described below, and any and all buildings, structures, and other development thereon:

Lots 44 – 48, PLAN EPP117070 SECTION 38 ESQUIMALT 3461, 3463, 3465, 3467 & 3469 Trumpeter Street (the "Lands")

- This Development Permit regulates the development and alterations of the Land, and supplements the "Colwood Land Use Bylaw, 1989" (Bylaw No. 151), to ensure the steep slope and form & character considerations for 5 single family homes with secondary suites and associated site improvements, including altering the existing retaining wall, are consistent with the guidelines for areas designated as "Natural Hazards Steeply Sloped" and "Neighbourhood Intensive Residential" in the City of Colwood Official Community Plan (Bylaw No. 1700).
- 3. This Development Permit is **NOT** a Building Permit or a subdivision approval.
- 4. This Development Permit is issued subject to compliance with all of the bylaws of the City of Colwood that apply to the development of the Lands, except as specifically varied by Council or supplemented by this Permit. This permit supersedes DP-22-023 and DP-21-008.
- 5. The Director of Development Services or their delegate may approve minor variations to the schedules attached to and forming part of this Development Permit, provided that such minor

variations are consistent with the overall intent of the original plans and do not alter the form and character or steeply sloped nature of the development authorized by those plans.

- If the Permittee does not substantially start the construction permitted by this Permit within 24
  months of the date of this Permit, the Permit shall lapse and be of no further force and effect.
- 7. The development is to be constructed in accordance with the following plans and specifications, which are attached to and form as part of this permit:

Schedule 1	Geotechnical Assessment Report by MGE Services Inc. revised April 13, 2023.
Schedule 2	Site Plan, Architectural Drawings, Elevation Drawings, Landscape Plan, and
	Grading Plan for 3461 Trumpeter Street dated February 2, 2023
Schedule 3	Site Plan, Architectural Drawings, Elevation Drawings, Landscape Plan, and
	Grading Plan for 3463 Trumpeter Street dated February 2, 2023
Schedule 4	Site Plan, Architectural Drawings, Elevation Drawings, Landscape Plan, and
	Grading Plan for 3465 Trumpeter Street dated February 2, 2023
Schedule 5	Site Plan, Architectural Drawings, Elevation Drawings, Landscape Plan, and
	Grading Plan for 3467 Trumpeter Street dated December 19, 2022
Schedule 6	Site Plan, Architectural Drawings, Elevation Drawings, Landscape Plan, and
	Grading Plan for 3469 Trumpeter Street dated December 22, 2022

8. This Development Permit authorizes land alterations for the construction of 5 single family homes with secondary suites along with any associated site works including altering the existing retaining wall. The Land shall not be altered, nor any buildings or structures constructed, except in accordance with the following conditions:

### FORM AND CHARACTER CONDITIONS

### General

8.1. The form and character of the buildings to be constructed on the Lands shall conform to the drawings attached to this permit as schedules.

### **Building Features**

- 8.2. The form and character of the buildings to be constructed on the Lands shall conform to the Site Plan, Architectural Drawings and Elevation Drawings prepared by Victoria Design Group (Schedules 2-6).
- 8.3. Within any group of three adjacent homes on the lands, no two houses shall have the same dwelling unit design.
- 8.4. Any future additions of telecommunications antennas or equipment to the exterior of the buildings and/or structures included in this Permit shall be architecturally integrated into the buildings and/or structures they are mounted on or screened from views so as not to be visually obtrusive, to the satisfaction of the Director of Development Services.
- 8.5. No future construction/installation of unenclosed or enclosed outdoor storage areas, and recycling/refuse collection and storage areas shall be undertaken without the issuance of a further Development Permit or amendment to this Permit.

8.6. All mechanical roof elements, including mechanical equipment, elevator housings, and vents shall be visually screened with sloped roofs or parapets, or other forms of solid screening to the satisfaction of the Director of Development Services.

### Landscaping

8.7. The design and construction of the proposed landscaping shall be in substantial compliance with the Landscape Plan prepared by Verity Construction (Schedules 2-6).

### Stormwater Management

8.8. Issuance of a Building Permit is subject to the City of Colwood's approval of a site-specific stormwater management plan.

### Grading

8.9. Lot preparations shall be in compliance with the site-specific grading plan by Gablecraft Homes as part of Schedules 2-6.

### **Retaining Walls**

- 8.10. All geotechnical recommendations must be followed as outlined in the Geotechnical Assessment forming as part of Schedule 1.
- 8.11. All retaining walls must be less than 1.2m in height and must not connect with neighbouring lots.

ISSUED ON THIS 27 DAY OF APRIL, 2023.

Yazmin Hernandez

**Director of Development Services** 

Revised April 13, 2023

Schedule 1

March 13, 2023

File: 23V-003

Verity Construction Ltd. 106-1039 Langford Parkway

Victoria, BC

V9B 0A5

Attention:

Ms. Patricia Gomes

MGEservices@shaw.ca

RE:

**Proposed House Construction** 

Lots 44 to 48, Trumpeter Street (Sector 7, Royal Bay), Colwood

**Geotechnical Assessment Report** 

### INTRODUCTION

As requested by Verity Construction Ltd. (the Client), MGE Services Inc. (MGE) has carried out a geotechnical assessment for five lots within the residential subdivision at the above-referenced site. The site was developed as part of the Royal Bay subdivision in Colwood, BC. Review of the Geotechnical Assessment Report for the Sector 7 Subdivision where the subject lots are located (prepared by Thurber Engineering Ltd. (Thurber) dated February 4, 2022) was carried out as part of our site review. This geotechnical report has been prepared as part of the development permit application specifically for Lots 44 to 48 within Sector 7 at the Royal Bay subdivision in Colwood. It is noted that this report will replace the landslide and slope stability assessment done at the time of subdivision for the Hazard Conditions – Steeply Sloped Development Permit Area as part of Covenant CA9829107.

The Royal Bay subdivision is located within a former gravel pit within the Colwood Outwash deposit. The subgrade within the subject sites consist of well-graded, pit run sand and gravel that was placed as part of the gravel pit reclamation following closure in 2008. MGE conducted site walkover of the subject lots in January and February 2023, at which time the lots were prepared to the approximate footing grade, with slopes extending up at the rear of the site. Grading of the existing slopes was prepared by the developer of the Royal Bay subdivision, which is proposed to be altered by the Client to achieve the house designs prepared for Lots 44 to 48.

MGE has conducted visual review of the subject lots, as documented in the attached Table 1-Site Photos. The lot layout is shown in the attached site plan provided by the Client, with cross sections of the final grading on Lots 44, 45 and 46 (where existing retaining walls are located) also attached to this report. This geotechnical assessment has been prepared in support of the development permit application prepared by the Client for single family houses to be constructed on the five subject lots.

### **PROJECT / SITE CONDITIONS**

The proposed development includes five detached, single family homes that will be constructed with slabon-grade foundations and with either full or partial step up backyards. Due to the grading, which slopes down from west to east, the houses are to be constructed with foundation walls increased to provide



MGE Services Inc.
EGBC Permit to Practice No. 1003085

740 Cowper Street, Victoria, BC V9A 2E9 250-661-8335

MGEservices@shaw.ca

March 13, 2023

File: 23V-003

support for backyards that will be approx. 3m above the front yard elevations at Lot 44 and approx. 1m above the front yard at Lot 48. It is understood that there will be retaining walls required between the house foundations at accommodate the grade changes between the front and rear yards of the subject lots. The design for these walls consists of stacked boulder walls constructed close to the rear of the house foundations and abutting into the concrete foundation walls on either side. The walls will be constructed in tiers to a maximum height of 1.2m, as per City of Colwood requirements. Backfilling of the walls will be carried out with site-excavated pit run sand and gravel that is free-draining and suitable for positive drainage. A cross section schematic of the boulder wall is provided as Drawing 1.

Our review of open excavations onsite indicate that the lots are underlain by dense, native sand and gravel, which is consistent with the local geology mapping that shows the site to be within the Colwood Outwash deposit. The surface of the pit run sand and gravel has been disturbed since initial subdivision development and will require further site preparation, as per recommendations provided herein.

### **GEOTECHNICAL RECOMMENDATIONS**

Based on our review of the subsurface conditions, the development of five single family houses is considered geotechnically appropriate. The native sand and gravel is considered suitable for providing bearing of the house foundations and associated retaining walls. It is recommended that building foundation design be based on a 100 kPa allowable bearing capacity, as determined by independent calculations. The sand and gravel subgrade is expected to require re-compaction, which is recommended to be carried out with a 10 tonne, steel drum, vibratory roller. MGE should be contacted to carry out review of the sand and gravel subgrade prior to foundation construction or structural filling, as needed by final grading.

If structural filling is required, the excavated sand and gravel material from the site is considered suitable for re-use based on past experience with the Colwood Outwash deposit. It is recommended that the sand and gravel is placed in maximum 300mm thickness lifts and thoroughly compacted with the vibratory roller. The extent of structural filling should be outside the building footprint or road alignment by at least the thickness of the fill, ie. a 1H:1V splay. As per the BC Building Code, MGE needs to carry out continuous monitoring of structural fill placement procedures to provide subgrade approval for the building foundations.

As discussed above, existing boulder walls are to be removed at the rear of Lots 44, 45 and 46 as part of the grading plan. New retaining wall construction will be necessary and is proposed to be limited to a maximum height of 1.2m to meet City of Colwood bylaw requirements. It is proposed to construct the retaining walls proposed on the site with stacked boulders, which are recommended to be sloped back at ½H:1V and oriented such that the long axis of the boulder extends back into the slope. Use of the free-draining pit run sand and gravel as backfill is suitable such that a toe drain is not needed as part of boulder wall design. The attached Drawing 1 provides details on stacked boulder wall construction.



March 13, 2023

File: 23V-003

### CLOSURE

Our geotechnical assessment of the project site and the proposed development indicates that the lands are considered safe and suitable for the use intended. MGE to carry out field reviews during site preparation to confirm the intent of our geotechnical recommendations is met.

MGE has also completed the Landslide Assessment Assurance Statement (Appendix D of the EGBC Guidelines for Legislated Landslide Assessments for Proposed Residential Development in British Columbia), which is attached to this report.

This letter has been prepared exclusively for Verity Construction Ltd. in accordance with the January 3, 2023 contract between MGE and Verity Construction Ltd. No third party can rely on this report, except for the City of Colwood, which is considered to be an authorized user, subject to the terms and conditions under which the work was completed.

We trust this meets your current requirements and ask that you contact the undersigned if there are any questions or concerns.

Yours truly,

MGE Services Inc.

Per: Alec Morse, P.Eng.

Attach: Table 1 – Site Photos Site Plan

Cross Sections - Lots 44, 45 and 46

Drawing 1 – Boulder Wall Schematic

Appendix D - Landslide Assessment Assurance Statement



### Table 1 – Site Photos Project: Lots 44 – 48, Trumpeter Street, Royal Bay

Verity Construction Ltd. File: 23V-003



Mar. 2, 2023: Current condition of Lot 44, with boulder wall above cut slope in pit run sand and gravel, which will also compose subgrade.



Mar. 2, 2023: Current condition of Lot 45, with boulder wall above cut slope in pit run sand and gravel, which will also compose subgrade.



Mar. 2, 2023: Current condition of Lot 46, with end of boulder wall above pit run sand and gravel, which will compose subgrade..




Mar. 2, 2023: Current condition of Lot 47, with pit run sand and gravel exposed as subgrade.





Mar. 2, 2023: Current condition of Lot 47, with pit run sand and gravel exposed as subgrade.





Mar. 2, 2023: Pit run slope at rear of Lots 44-48, with existing boulder wall on Lots 44-46.

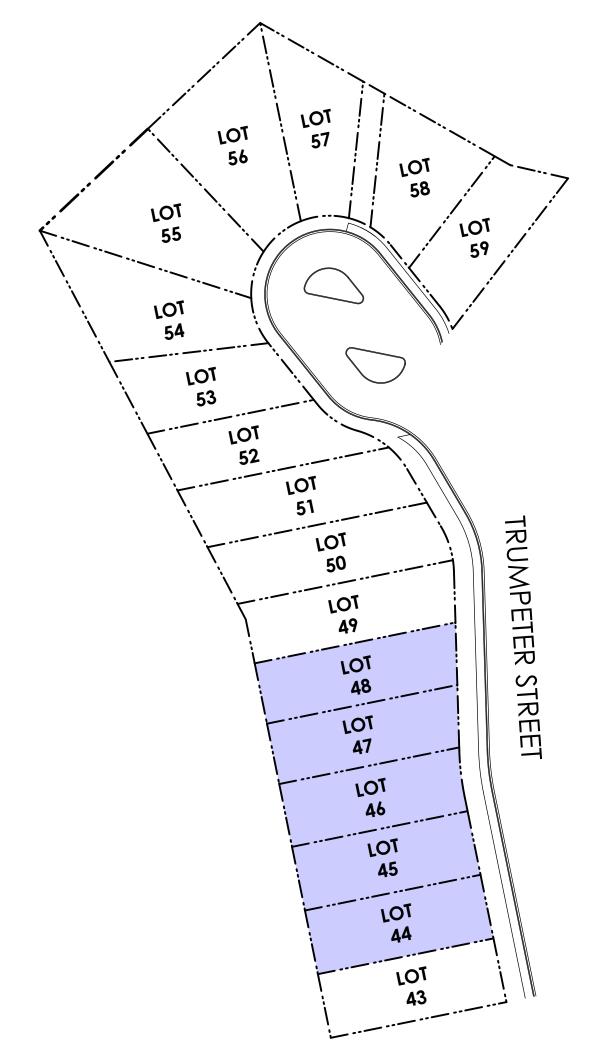

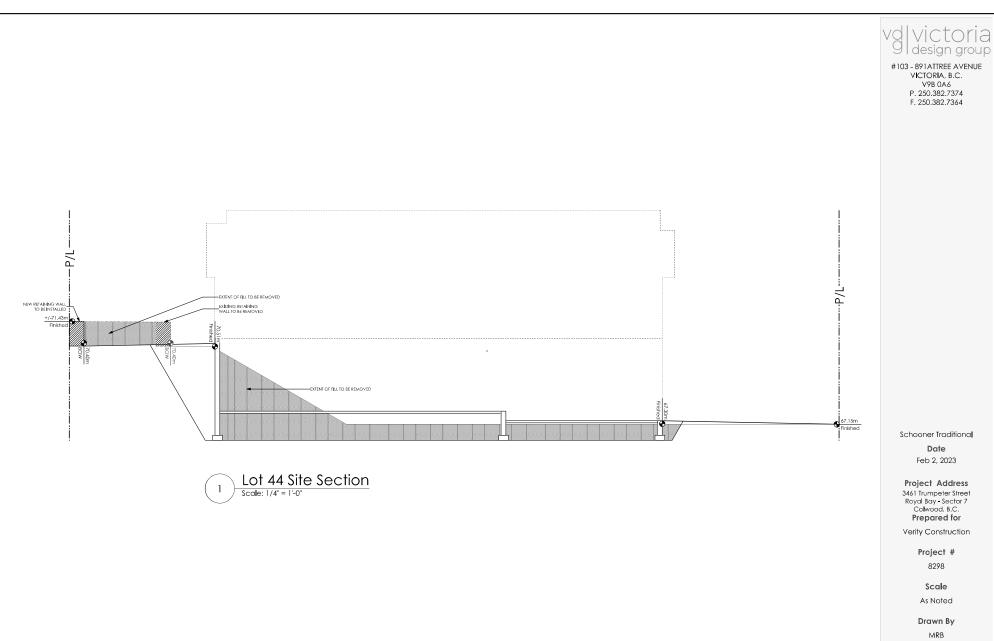

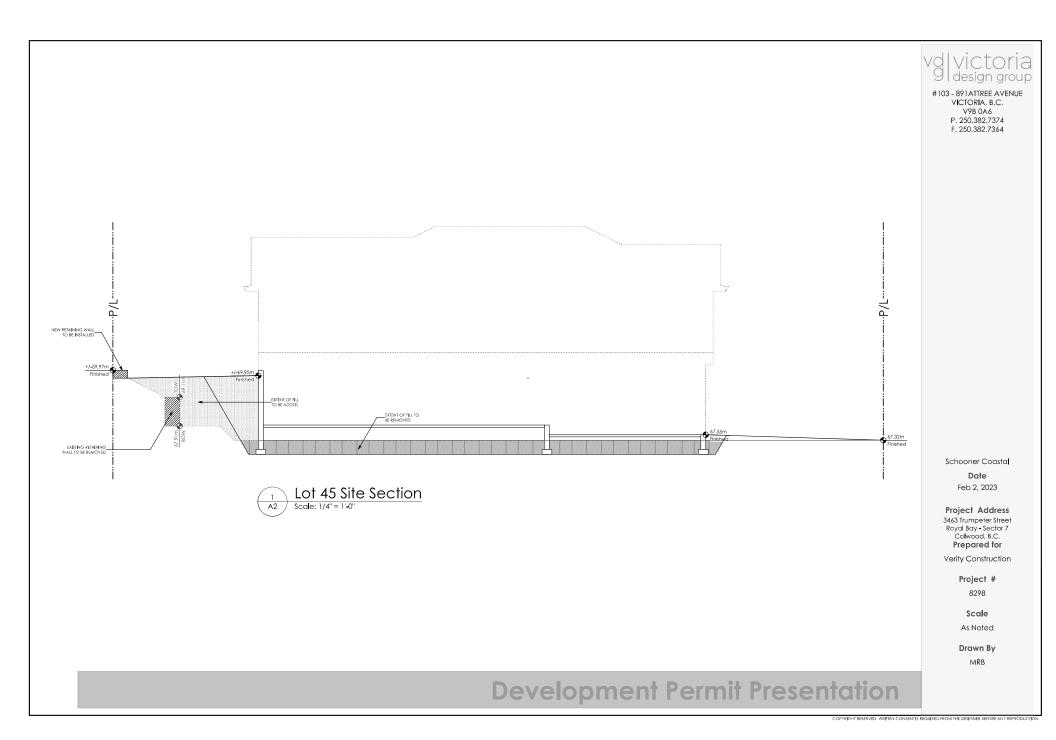

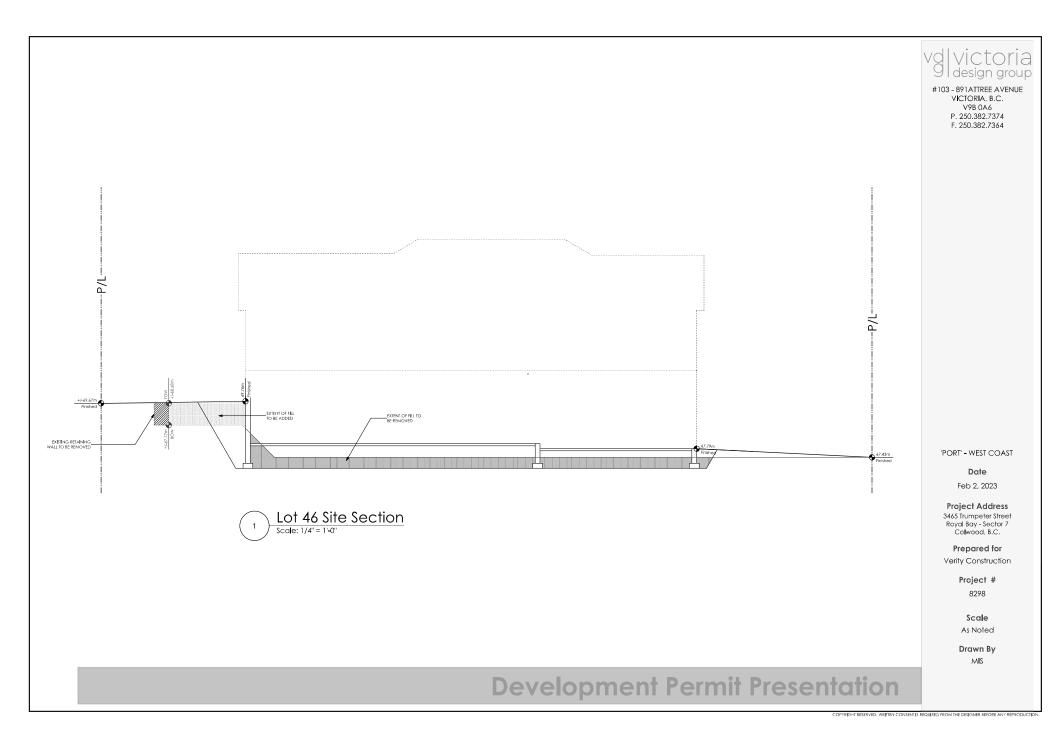

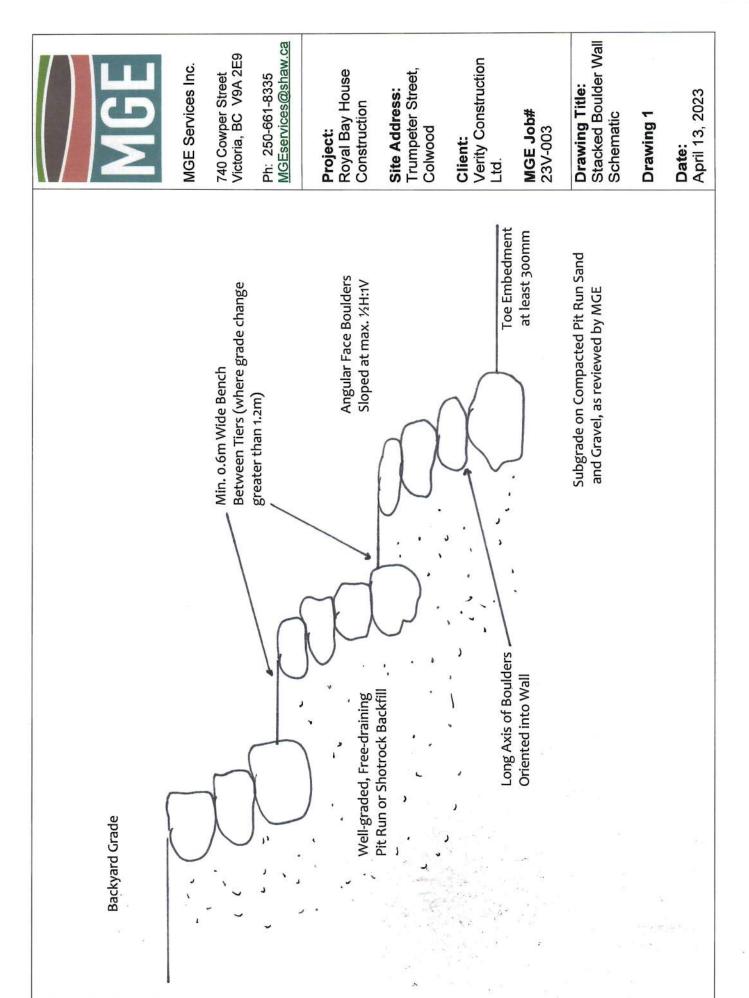

# APPENDIX D: LANDSLIDE ASSESSMENT ASSURANCE STATEMENT

Note: This Statement is to be read and completed in conjunction with the "APEGBC Guidelines for Legislated Landslide Assessments for Proposed Residential Development in British Columbia", March 2006/Revised September 2008 ("APEGBC Guidelines") and the "2006 BC Building Code (BCBC 2006)" and is to be provided for landslide assessments (not floods or flood controls) for the purposes of the Land Title Act, Community Charter or the Local Government Act. Italicized words are defined in the APEGBC Guidelines.


To: The Approving Authority  City of Columnod Building Dept.  Date: April 13 2023.
Jurisdiction and address
With reference to (check one):  □ Land Title Act (Section 86) – Subdivision Approval  Local Government Act (Sections 919.1 and 920) – Development Permit  □ Community Charter (Section 56) – Building Permit  □ Local Government Act (Section 910) – Flood Plain Bylaw Variance  □ Local Government Act (Section 910) – Flood Plain Bylaw Exemption  □ British Columbia Building Code 2006 sentences 4.1.8.16 (8) and 9.4 4.4.(2) (Refer to BC Building and Safety Policy Branch Information Bulletin B10-01 issued January 18, 2010)
For the Property:  Lots 44-48 Section 16 Esquinost District Plan EPP 117070 (34613463 3465 3467 34  Legal description and civic address of the Property  Tocupater Street
The undersigned hereby gives assurance that he/she is a Qualified Professional and is a Professional Engineer or Professional Geoscientist.
I have signed, sealed and dated, and thereby certified, the attached <i>landslide assessment</i> report on the Property in accordance with the <i>APEGBC Guidelines</i> . That report must be read in conjunction with this Statement. In preparing that report I have:
Check to the left of applicable items
Collected and reviewed appropriate background information Reviewed the proposed residential development on the Property Conducted field work on and, if required, beyond the Property Reported on the results of the field work on and, if required, beyond the Property Considered any changed conditions on and, if required, beyond the Property  6. For a landslide hazard analysis or landslide risk analysis of landslide hazard analysis or landslide risk analysis or landslide hazard analysis or l
Reported on the results of the field work on and, if required, beyond the Property
5. Considered any changed conditions on and, if required, beyond the Property
6.1 reviewed and characterized, if appropriate, any landslide that may affect the Property estimated the landslide hazard
6.3 identified existing and anticipated future <i>elements at risk</i> on and, if required, beyond the Property
6.4 estimated the potential consequences to those elements at risk
<ol> <li>vvnere tne Approving Authority has adopted a level of landslide safety I have:</li> </ol>
7.2 made a finding on the level of landslide safety on the Property based on the comparison
7.3 made recommendations to reduce landslide hazards and/or landslide risks
8. Where the Approving Authority has not adopted a level of landslide safety I have:

	described the method of landslide hazard analysis or landslide risk analysis used
<u>/</u> 8.2	referred to an appropriate and identified provincial, national or international guideline for level of landslide safety
× 8.3	compared this guideline with the findings of my investigation
18.4	made a finding on the level of landslide safety on the Property based on the comparison
8.5	made recommendations to reduce landslide hazards and/or landslide risks
9. Rep	ported on the requirements for future inspections of the Property and recommended who should duct those inspections.
Based on I	my comparison between
Check o	ne
	the findings from the investigation and the adopted <i>level of landslide safety</i> (item 7.2 above) the appropriate and identified provincial, national or international guideline for <i>level of landslide safety</i> (item 8.4 above)
I hereby of	give my assurance that, based on the conditions $^{[1]}$ contained in the attached landslide at report,
Check o	
	for <u>subdivision approval</u> , as required by the Land Title Act (Section 86), "that the land may be used safely for the use intended"
	Check one
	<ul> <li>with one or more recommended registered covenants.</li> <li>without any registered covenant.</li> </ul>
D	for a <u>development permit</u> , as required by the Local Government Act (Sections 919.1 and 920), my report will "assist the local government in determining what conditions or requirements under [Section 920] subsection (7.1) it will impose in the permit".
	for a <u>building permit</u> , as required by the Community Charter (Section 56), "the land may be used safely for the use intended"
	Check one
	<ul> <li>with one or more recommended registered covenants.</li> <li>without any registered covenant.</li> </ul>
	for flood plain bylaw variance, as required by the "Flood Hazard Area Land Use Management Guidelines" associated with the Local Government Act (Section 910), "the development may occur safely".
	for flood plain bylaw exemption, as required by the Local Government Act (Section 910), "the land may be used safely for the use intended".
Alec	Morse, P. Eng. April 13,2023
Alec Name (print)	Date
_ 9	
Signature/	


When seismic slope stability assessments are involved, level of landslide safety is considered to be a "life safety" criteria as described in the National Building Code of Canada (NBCC 2005), Commentary on Design for Seismic Effects in the User's Guide, Structural Commentaries, Part 4 of Division B. This states:


"The primary objective of seismic design is to provide an acceptable level of safety for building occupants and the general public as the building responds to strong ground motion; in other words, to minimize loss of life. This implies that, although there will likely be extensive structural and non-structural damage, during the DGM (design ground motion), there is a reasonable degree of confidence that the building will not collapse nor will its attachments break off and fall on people near the building. This performance level is termed 'extensive damage' because, although the structure may be heavily damaged and may have lost a substantial amount of its initial strength and stiffness, it retains some margin of resistance against collapse".

740 Couper Street			T. A. MORSE #,29660
Victoria BC			Sunsila
250-661-8335			(Affix Professional seal here)
elephone			
f the Qualified Professional is a m	nember of a firm,	complete the fo	ollowing.
am a member of the firm	ME	Services	he
and I sign this letter on behalf of the	C. C.	(Print nam	

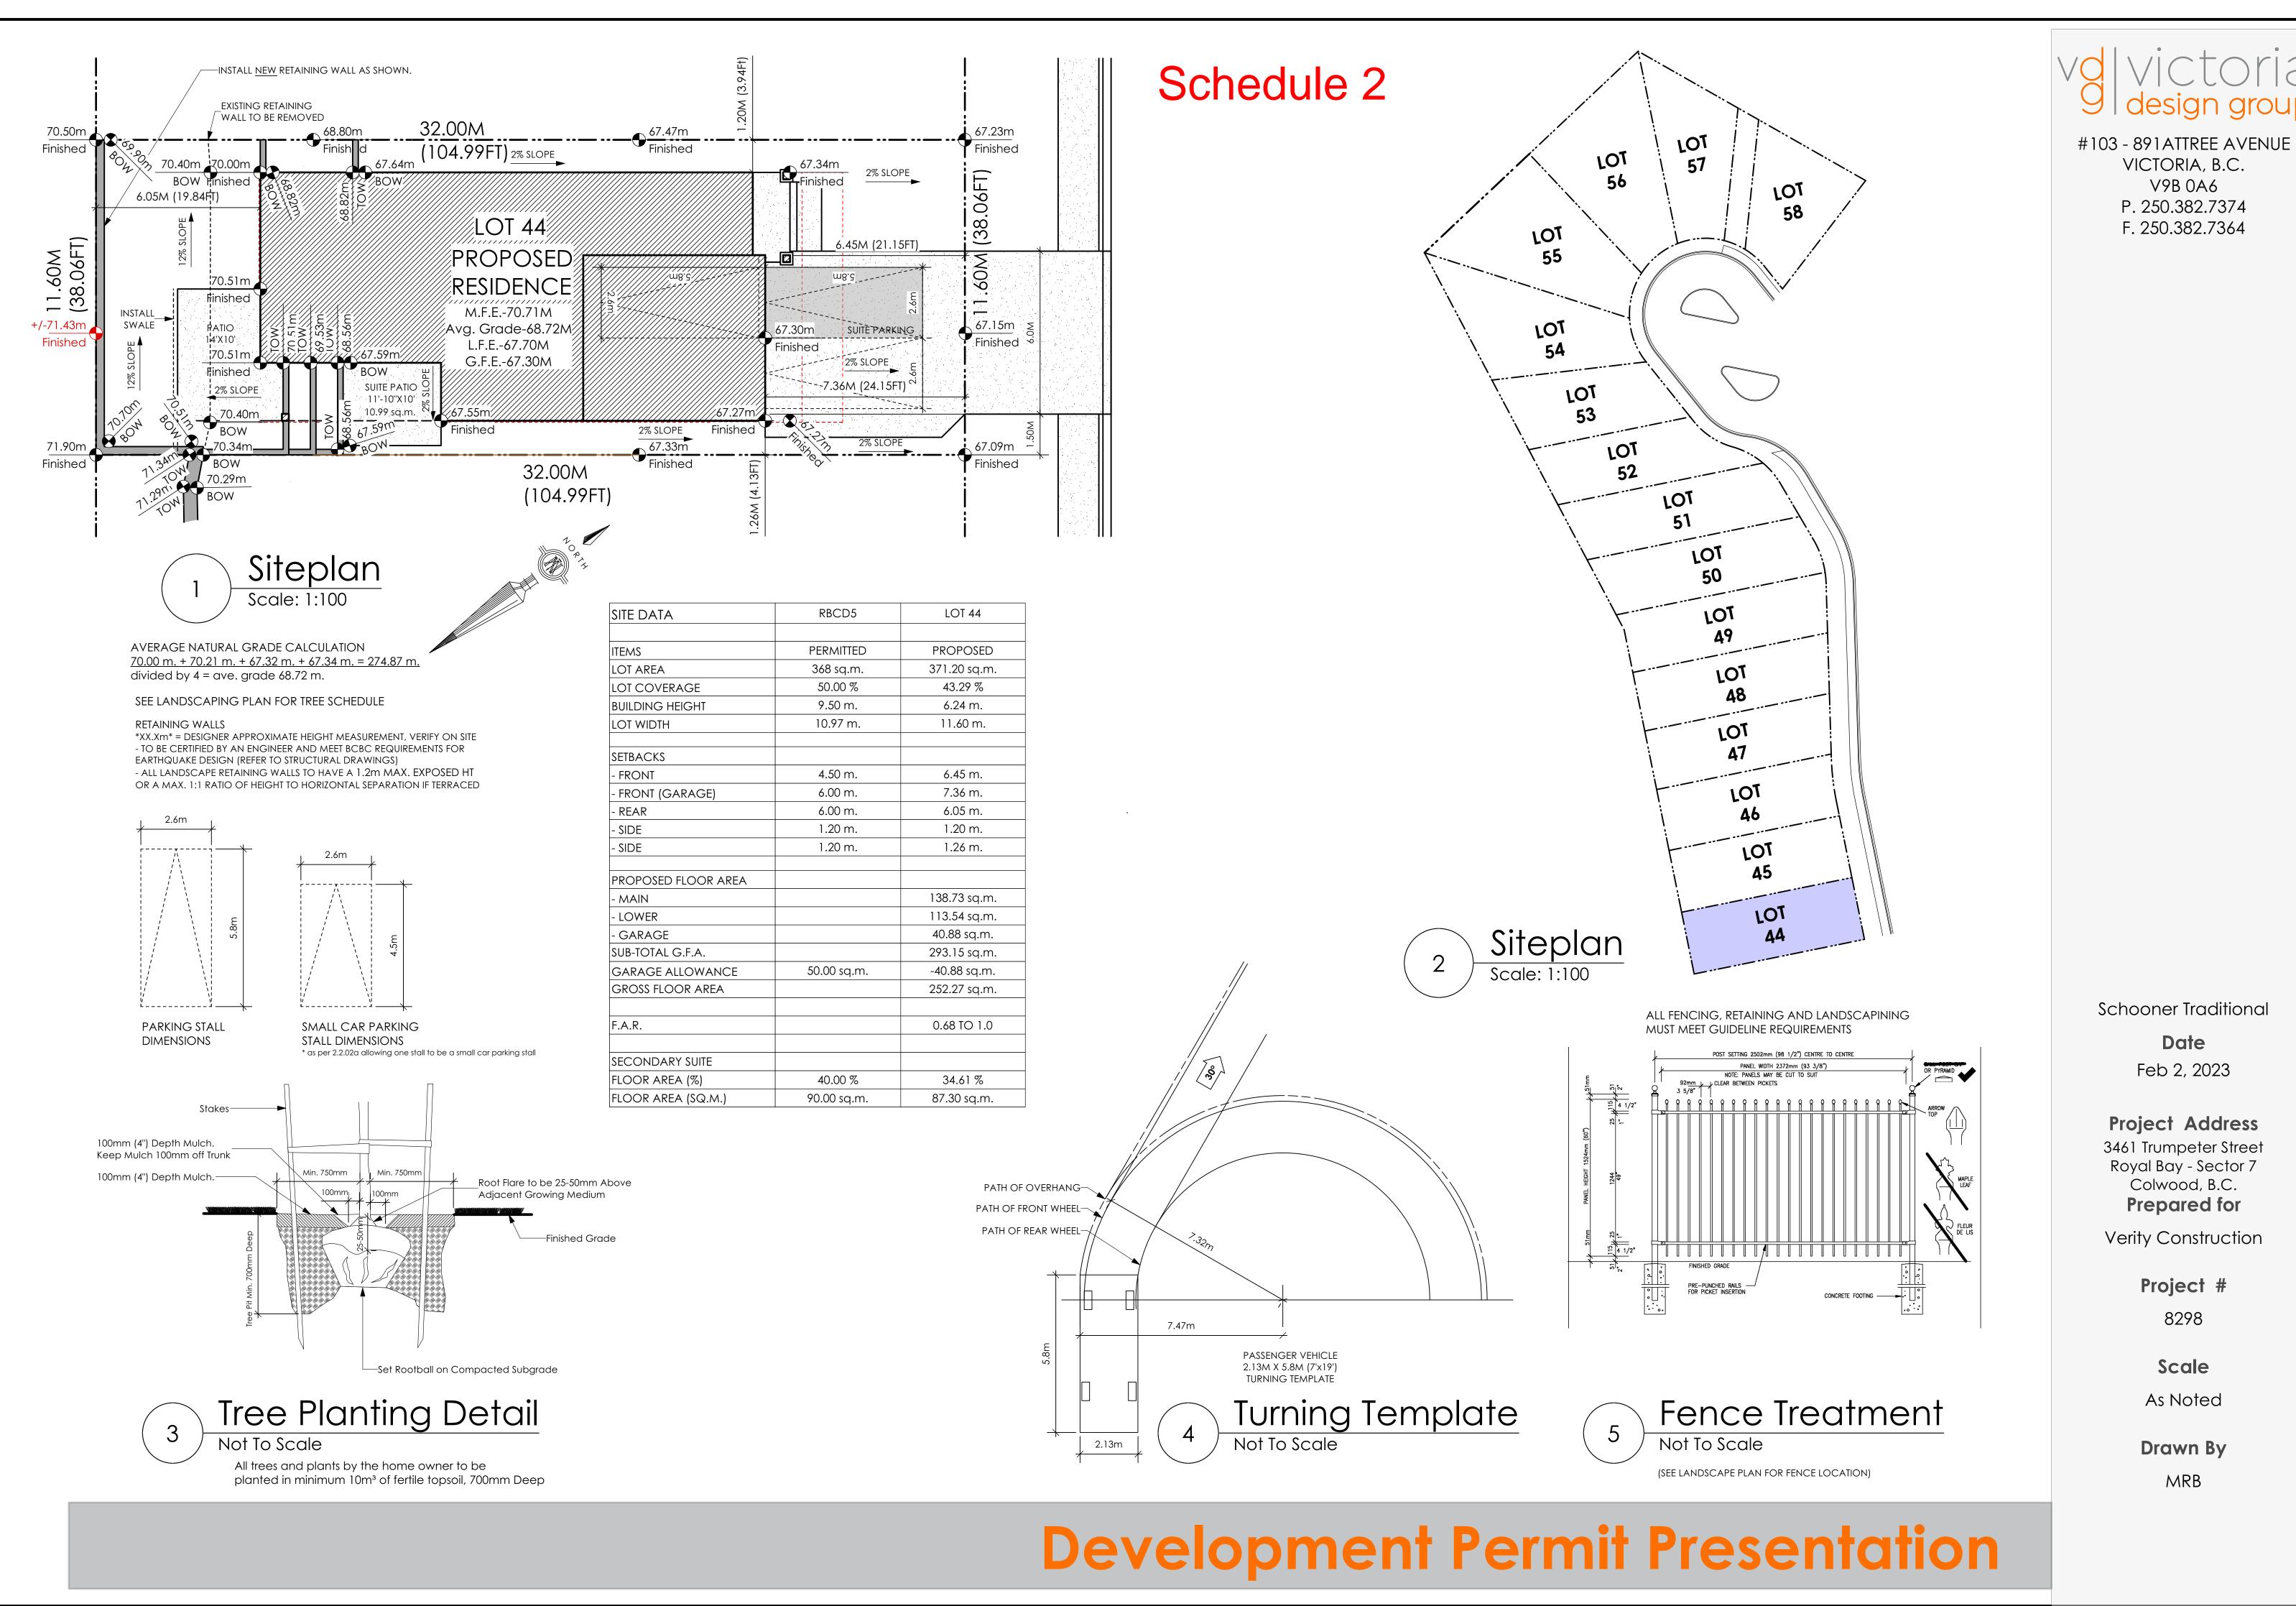


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# ROOFS

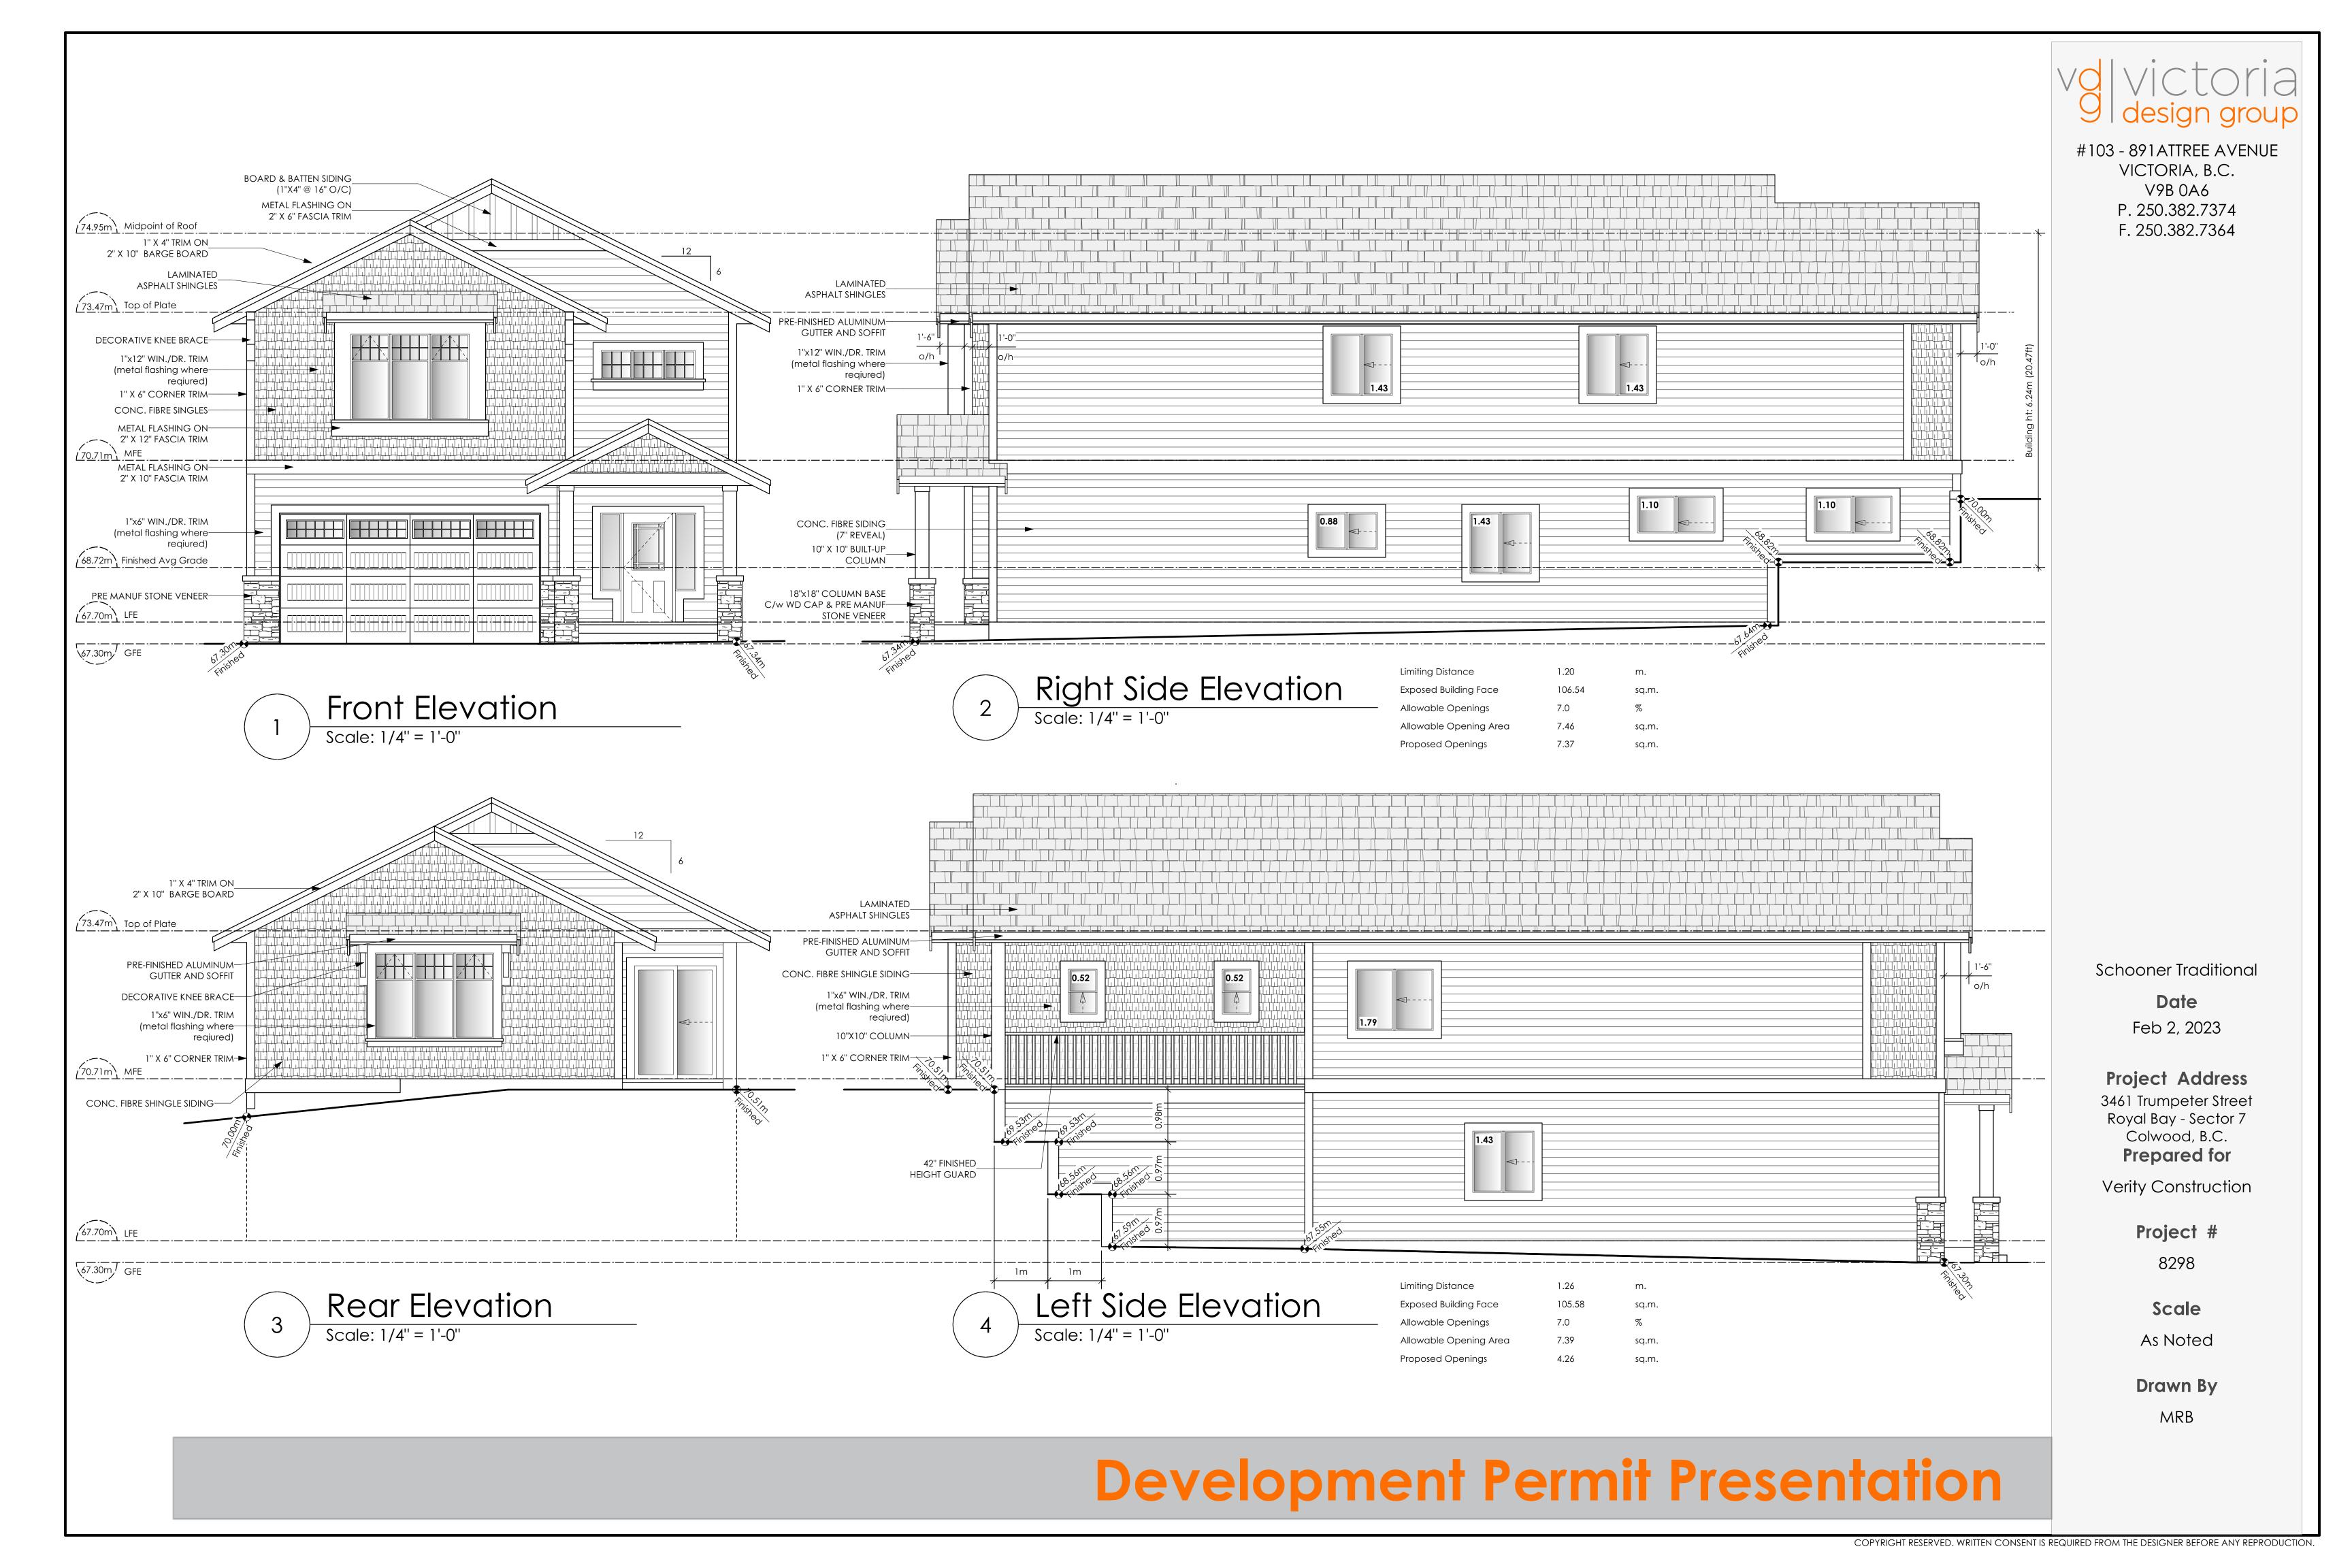- R1. LAMINATED ASPHALT SHINGLES ON
  7/16" ORIENTED STRAND BOARD
  WD TRUSSES (DESIGNED BY MANUF.)
  R-40 FIBRE GLAS BATT INSULATION OR
  14 1/2" FIBRE GLASS LOOSE FILL INSULATION
  (ALLOW FOR SETTLING)
  6 MIL POLY'N V.B.
  5/8" GYPSUM BOARD
- R2. PROVIDE 2 1/2" (63MM) CLEAR BETWEEN
  R-20 INSULATION AND SHEATHING.
  (MIN. R-20 @ ROOF-WALL CONNECTION FOR
  4'-0" (1.2M) AROUND PERIMETER OF BUILDING.
  AIR VENTILATION BAFFLES TO BE INSTALLED
  WHERE REQUIRED IN AS PER BCBC 9.19.)
- R3. EAVE PROTECTION

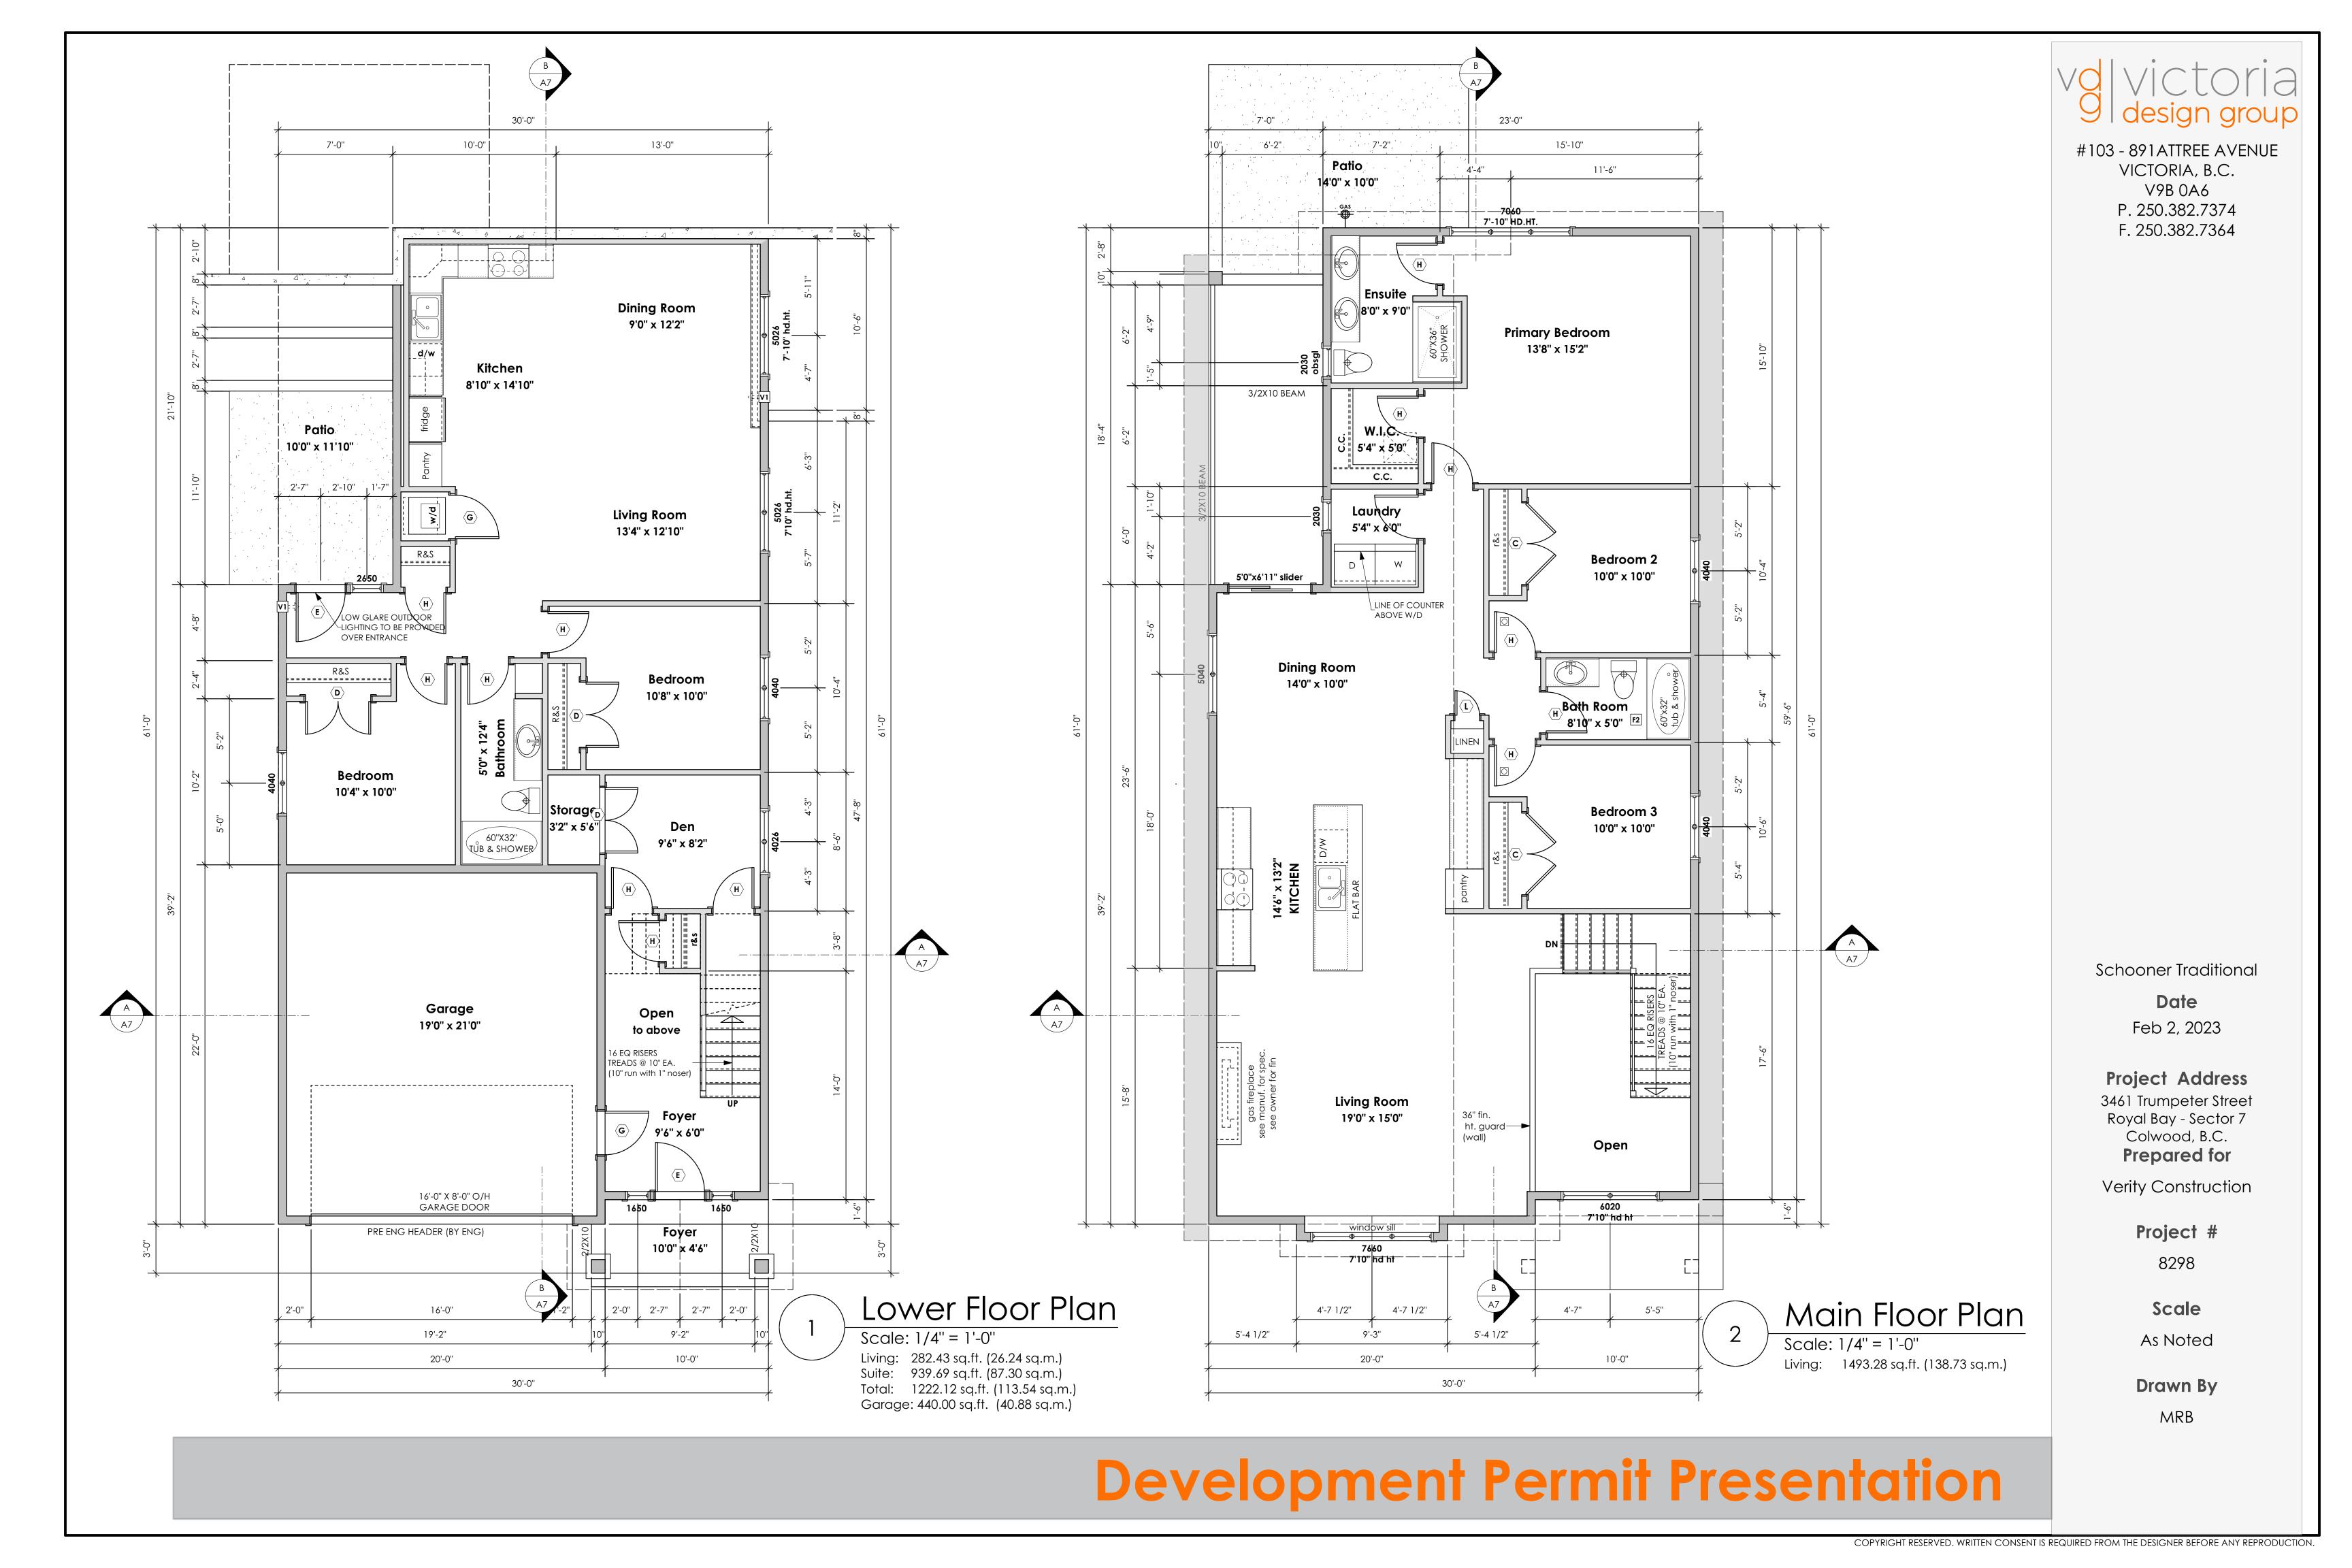  CONT. UP ROOF SLOPE FOR 12"

  PAST EXTERIOR WALL.
- R4. PROVIDE 1 SQ.FT. ATTIC VENT PER
  300 SQ.FT. OF INSULATED AREA MIN.
  25% OF REQUIRED TO BE @ TOP AND BOTTOM
  (TO COMPLY WI. B.C. BLDG. CODE 9.19.1)
- R5. PRE-FIN. FASCIA GUTTER
  2×8 FASCIA BD.
  2×4 SUB. FASCIA BD.
  VENTED SOFFIT
  (SEE CONTRACTOR)
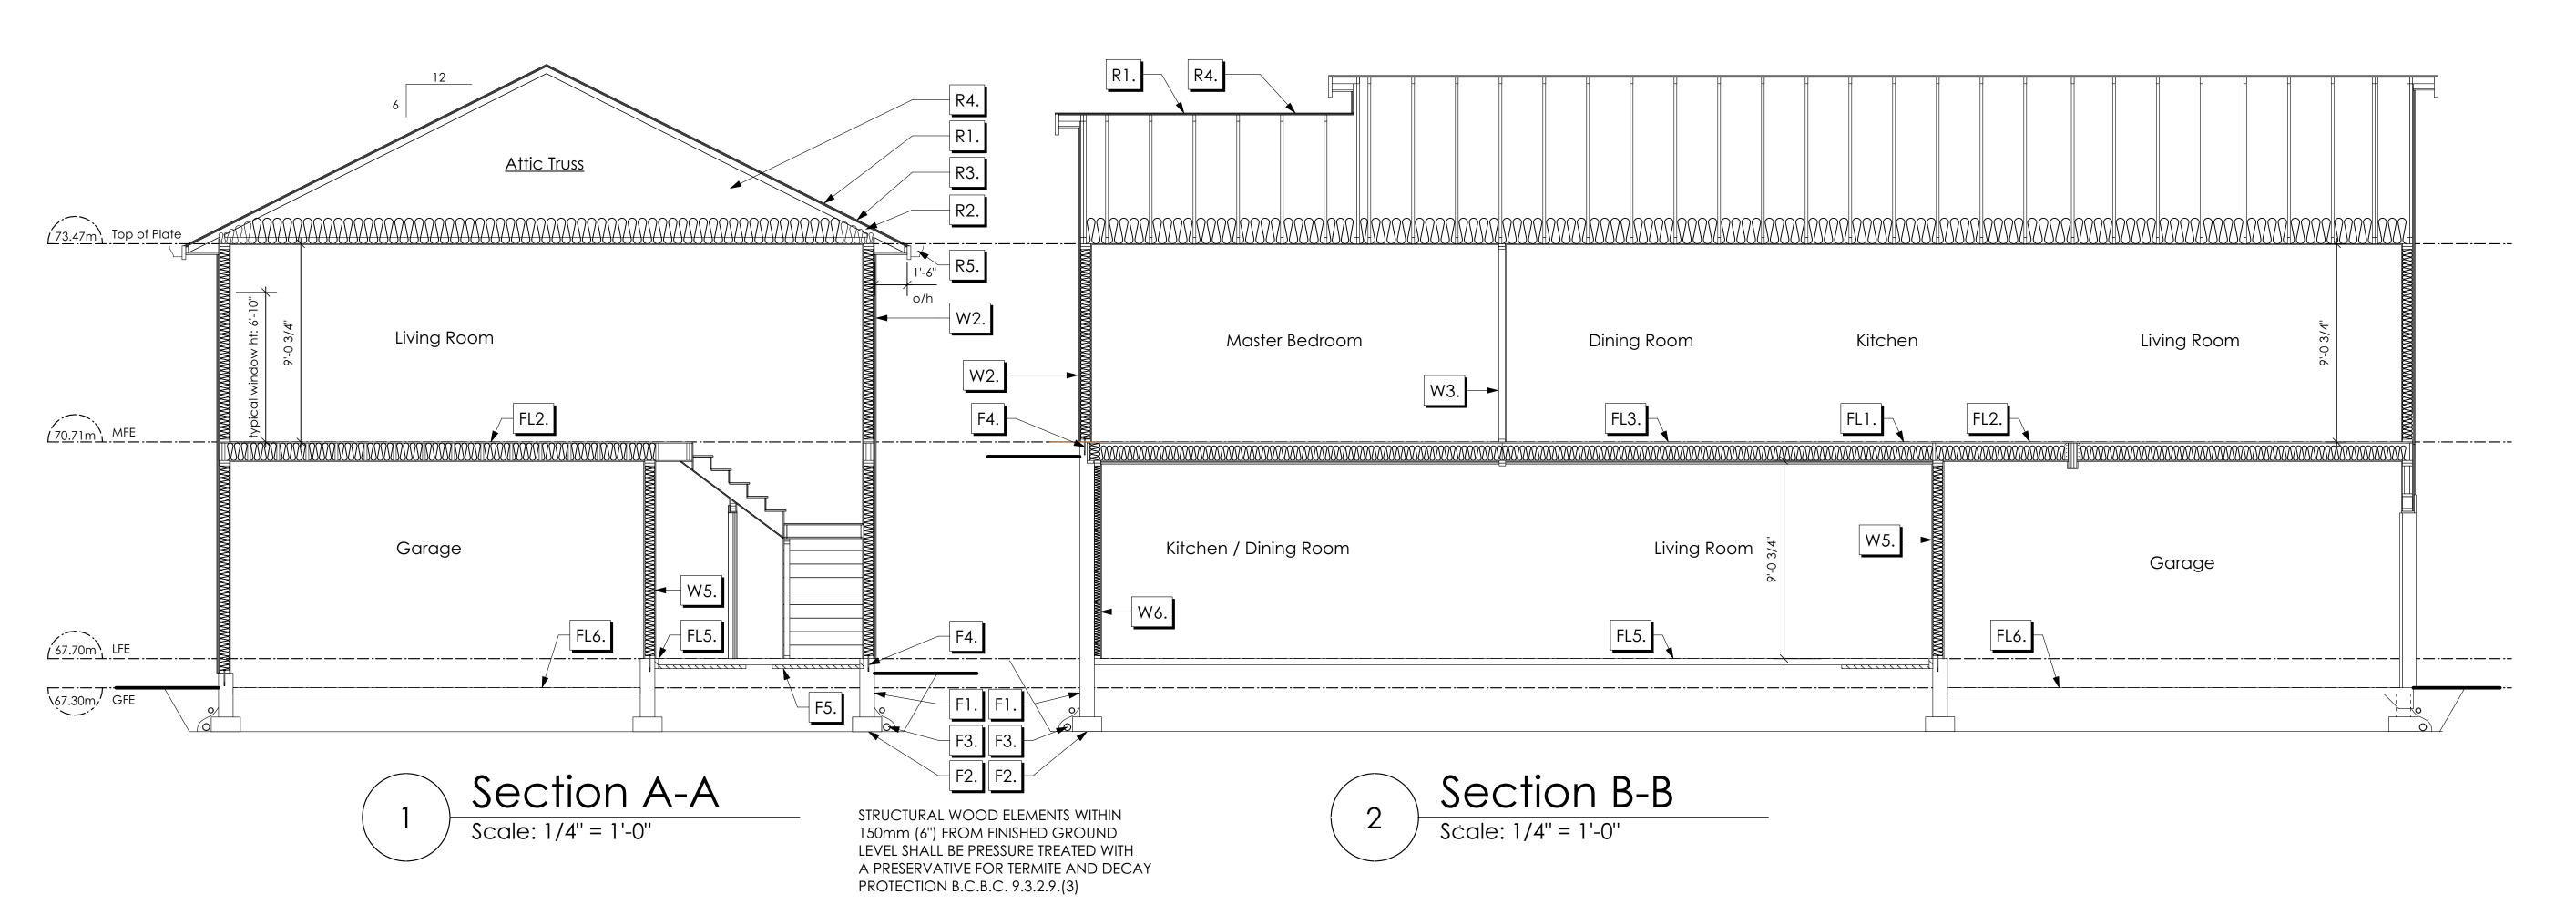
### **FLOORS**

- FL1. FINISHED FLOORING ON
  19/32" ORIENTED STRAND BOARD
  (NAILED & GLUED TO FLOOR STRUCT. BELOW) ON
  2×10 FLOOR JOISTS @ 16" OR 12" O/C
  C/W 2×2 X-BRIDGING @ 7.0' O/C (MAX)
  1/2" GYPSUM BOARD
- FL2. FINISHED FLOORING ON
  19/32" ORIENTED STRAND BOARD
  (NAILED & GLUED TO FLOOR STRUCT. BELOW) ON
  2×10 FLOOR JOISTS @ 16" OR 12" O/C
  C/W 2×2 X-BRIDGING @ 7.0' O/C (MAX)
  R-31 INSULATION
  5/8" X-TYPE GYPSUM BOARD
  (BETWEEN GARAGE AND LIVING SPACE)
- FL3. B.C. BUILDING CODE (TABLE-9.10.3.1.B)
  RATED FLOOR ASSEMBLY F8D
  FINISHED FLOORING ON
  19/32" ORIENTED STRAND BOARD
  (FASTENED & GLUED TO FLOOR STRUCT. BELOW) ON
  2×10 FLOOR JOISTS @ 16" OR 12" O/C
  C/W 2×2 X-BRIDGING @ 7.0' O/C (MAX)
  R-31 INSULATION
  RESILIENT METAL CHANNELS @ 24" O/C
  1 LAYERS 5/8" X-TYPE GYPSUM BOARD
  30 MINUTE F.R.R., 50 S.T.C.
- FL4. FINISHED FLOORING ON

  19/32" ORIENTED STRAND BOARD
  (NAILED & GLUED TO FLOOR STRUCT. BELOW) ON

  2×10 FLOOR JOISTS @ 16" OR 12" O/C

  C/W 2×2 X-BRIDGING @ 7.0' O/C (MAX)

  PROVIDE R-31 F/G BATT INSULATION IN

  JOIST CAVITY

  BUILDING WRAP

  VENTED SOFFIT (TO OWNERS SPEC'S)

  TO ALL SUSPENDED FLOOR AREAS
  (NOT SHOWN IN SECTION)

- FL5. FINISHED FLOORING ON
  3 1/2" CONCRETE SLAB
  6 MIL. POLY'N V.B.
  6" COMPACTED GRAVEL OR SAND
- FL6. 3 1/2" CONCRETE SLAB
  6 MIL. POLY'N V.B.
  6" COMPACTED GRAVEL OR SAND
  SLOPE TO DOORS 1"

(NOT SHOWN IN SECTION)

FL7. DECKING MEMBRANE

(TO COMPLY WITH CAN/CGSB 37.54) ON 19/32" ORIENTED STRAND BOARD C/W "H" CLIPS TAPERS TO PROVIDE MIN.1:50 SLOPE ON 2×4 WOOD STRAPPING @ 16" O/C 2×10 ROOF JOISTS @ 16" O/C C/W (PROVIDE ADEQUATE MEMBRANE "UPSTAND" @ EXT. WALL.) R-31 INSULATION RESILIENT METAL CHANNELS @ 24" O/C 1 LAYERS 5/8" X-TYPE GYPSUM BOARD 30 MINUTE F.R.R.

### **WALLS**

- W1. DOUBLE GLAZING ENERGY STAR LOW "E" RATING IN THERMAL BREAK FRAMES 2/2"X10" LINTEL OVER (@ BEARING WALLS ONLY) (TYPICAL, WI. 2 1/2" XPS INSULATION) FLASHING OVER @ EXTERIOR (GLAZING IN ALL EXTERIOR DOORS & WITHIN 3 FT. OF EXTERIOR DOORS TO BE SHATTERPROOF (SP)) WINDOW REQUIREMENTS DERIVED FROM BCBC TABLE C-5 AS PER BCBC 9.7.4.3. AND ARE TO BE USED TO SATISFY THE REQUIREMENTS OF AAMA/WDMA/CSA 101/I.S.2/A440, "NAFS": COLWOOD, CLASS R, DP 1440, PG 30, WATER RESIST, 220, A2, RATINGS MUST BE CLEARLY LABELED ON ALL WINDOW UNITS UPON INSTALLATION FOR INSPECTION. (NOT SHOWN IN SECTION)
- W2. CONC. FIBRE BOARD ON
  9.5MM (3/8") AIR SPACE / STRAPPING
  3/8"×2" BORATE TREATED PLYWOOD STRAPPING
  BUILDING WRAP on
  7/16" ORIENTED STRAND BOARD SHEATHING
  2×6 STUDS @ 16" O/C
  R-20 INSULATION
  6 MIL. POLYETHYLENE VAPOUR BARRIER
  1/2" GYPSUM BOARD
  (REFER TO DETAILS ON D1)
- W3. INTERIOR PARTITION

  1/2" GYPSUM BOARD ON EACH SIDE

  OF 2×4 STUDS @ 16" O/C OR

  2×6 STUDS @ 16" O/C (IF NOTED)
- W4. PRE-MANUFACTURED STONE VENEER
  (INSTALLED TO MANUF. SPEC)
  LIME BASED MORTAR SETTING BED ON
  LIME BASED MORTAR SCRATCH COAST ON
  METAL LATHE INSTALLED HORIZONTALLY
  OVERLAP HORIZONTAL AND VERTICAL SEAMS 1"
  SEMI-RIGID BACK BOARD
  (HAL-TEX RAINBOARD OR EQ.)
  9.5MM (3/8") AIR SPACE / STRAPPING
  3/8"×2" BORATE TREATED PLYWOOD STRAPPING
  HOUSE WRAP (A.B.) (TYVEK OR EQ.)
  7/16" ORIENTED STRAND BOARD SHEATHING
  2×6 STUDS @ 16" (AS REQUIRED)
  (NOT SHOWN IN SECTION)

# W5. 5/8" X-TYPE GYPSUM BOARD ON 2×6 STUDS @ 16" O/C C/W R-20 INSULATION 6 MIL. POLY'N V.B 1/2" GYPSUM BOARD (BETWEEN GARAGE & LIVING)

- W6. 1/2" GYPSUM BOARD ON
  6 MIL. POLY'N V.B.
  2×4 STUDS @ 24" O/C C/W
  R-12 BATT INSULATION
  2 PLY 30 MINUTE BUILDING PAPER OR
  12.7MM (1/2") AIR SPACE
  (PROVIDE REQUIRED FIRE STOPS IN WALL
  ASSEMBLIES TO COMPLY WITH
  B.C. BLDG. CODE 9.10.16.)
- W7. B.C. BUILDING CODE (TABLE 9.10.3.1.A)
  RATED WALL ASSEMBLY W3C
  1 LAYER 1/2" X-TYPE GYPSUM BOARD ON
  EACH SIDE OF 2×4 STUDS @ 16" O/C OR
  2×6 STUDS @ 16" O/C (IF NOTED)
  RESILIENT METAL CHANNELS ON ONE SIDE
  @ 400mm OR 600mm O.C. C/W
  3 1/2" FIBRE GLASS SOUND BATTS
  FRICTION FITTED AND SOLID FILLED
  45 MIN. F.R.R., 43 S.T.C.
  (BETWEEN PRIMARY LIVING & SECONDARY SUITE)

### **FOUNDATION WALLS**

- F1. DAMP PROOFING (WHERE REQUIRED) ON 8" THK. CONC. FOUNDATION WALL C/W 15 M BARS @ 24" O/C B/W
- F2. 16"X 8" CONC. FOOTINGS

  C/W 2 (TWO) 15M BARS CONT. 3 IN. FROM BOTT.

  ON UNDISTURBED SOIL (SOLID BEARING)
- 3. 4" PERIMETER DRAIN
  3" TIGHT PIPE FOR RWL
  DRAIN ROCK
- F4. ANCHOR BOLTS @ 4.0 FT. O/C MAX C/W SILL GASKETS
- F5. UNDER SLAB INSULATION
  2 1/2" (RSI 2.15) EXTRUDED POLYSTYRENE
  RIGID INSULATION 4'-0" (1.2M)
  CONT. AROUND PERIMETER UNDER
  SLAB INSTALLED HORIZONTALLY
  (VERIFY WITH MUNICIPALITY DEPTH OF FROST LINE)

Schooner Traditional

Date

Feb 2, 2023

**Project Address**3461 Trumpeter Street

Royal Bay - Sector 7 Colwood, B.C. **Prepared for** 

Verity Construction

Project #

8298

Scale

As Noted

Drawn By

MRB


### ALL FENCING, RETAINING AND LANDSCAPING MUST MEET THE **GUIDELINE REQUIREMENTS**

ALL RETAINING WALLS ARE TO BE STAND ALONE STRUCTURES (THEY MUST TERMINATE AT PROPERTY LINE) AND MUST NOT CONNECT TO RETAINING WALLS LOCATED ON ADJACENT PRIVATE PROPERTIES

PATIO

ESTIMATED LOCATION OF REAR


\*NOTE: In the interest of maintaining high standards, the developer reserves the right to modify plans. specifications and design without prior notice. Drawings contained within are artist renderings only. Sizes and dimensions are approximate and may vary with actual plan and survey. Exterior style may change pending municipal approval. Retaining wall location and types may vary and are subject to municipal, engineering or developer discretion. Subject to change without notice. Furniture as shown on plans are for layout purposes only and are not included in the sale.

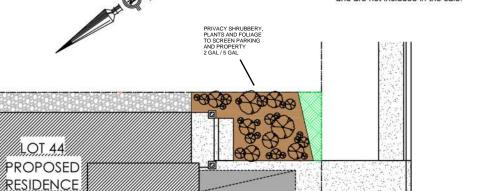


88 PAR 8PAR


PRIVACY SHRUBBERY PRIVACY SHRUBBERY, PLANTS AND FOLIAGE TO SCREEN PARKING AND PROPERTY 2 GAL / 5 GAL

000	ITEM	AREA (sf)	%
398	GARDEN BED	282	12%
ter.	GRAVEL	462	20%
	CONCRETE	907	40%
	SOD	631	28%
	TOTAL	2,282	100%

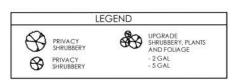



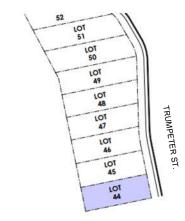

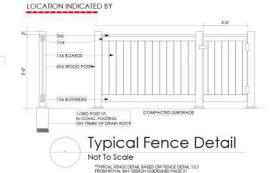



### ADDITIONAL NOTES:

PROPERTY TO BE IRRIGATED 6" PIPE FOR DRIVEWAY SLEEVES TO BE INSTALLED FOR CITY IRRIGATION LINES

LANDSCAPE PLAN
NOT TO SCALE

	MM/DD/YY	ISSUED/REVISED	DATE
01	09/21/22	FOR APPROVAL	PROJE
02	10/05/22	GC REVISION - FOR APPROVAL	
03	10/07/22	GARDEN BED PLANTING	
04	12/23/22	REVISION AS PER CITY OF COLWOOD	

SUITE PATIO:

**PROJECT** 

LANDSCAPING PLAN LOT 44, 3461 TRUMPETER ST. **ROYAL BAY, SECTOR 7** CITY OF COLWOOD




QUALITY CONSTRUCTION. TRUSTED SERVICE.

106 - 1039 Langford Parkway Victoria, B.C. V9B 0A6

P: 250.474.1039 www.verityconstruction.ca



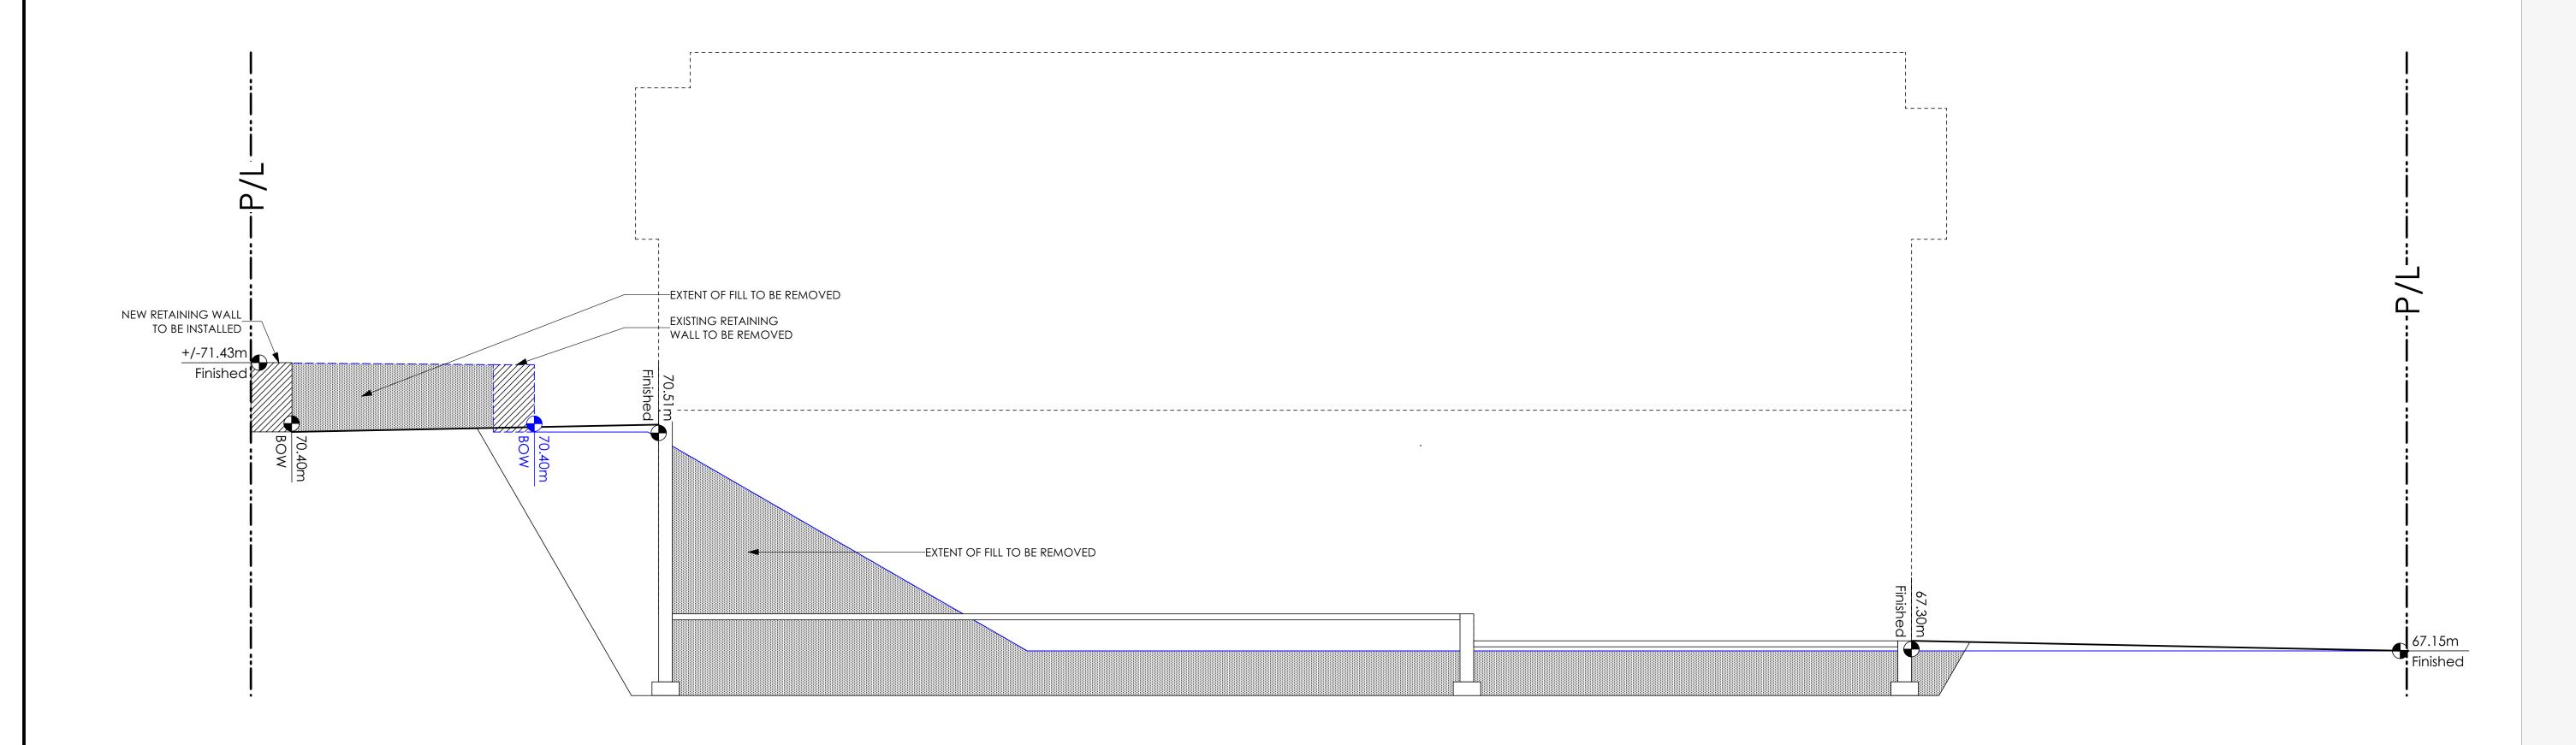

Lot 44 Site Section

Scale: 1/4" = 1'-0"

Schooner Traditional

Date

Feb 2, 2023

**Project Address** 

3461 Trumpeter Street Royal Bay - Sector 7 Colwood, B.C. **Prepared for** 

Verity Construction

Project #

8298

Scale

As Noted


Drawn By


MRB


# GABLECTART HOMES BUILDING GRADE SLIP


WSP	Project	No:	201-08151-00
	,		

BUILDING	JRADE SLIP  Issue Date:
MUNICIPAL ADDRESS 3/61 Trumpeter Street	P.I.D.
ADDRESS 3461 Trumpeter Street  LOT	PLAN
8UILDER	SUBDIVISION
VERITY HOMES  ADDRESS	ROYAL BAY SECTOR 7  DEVELOPER
	MEADOWS DEVELOPMENT LP  CONSULTANT
REPRESENTATIVE PH.	WSP CANADA INC
PROPOSED BUILDING GRADES  ALL ELEVATIONS ARE METRIC GEODETIC +  MAIN FLOOR ELEVATION	PLAN  LOT:  TRUMPETER ST.  67.15
ACTUAL TOP OF FOOTING	9 (EE 66.1 LFE 67.50 MSE 65.68 S 65.19 D 05.19 D 05.19 D 05.19
SERVICES FRONT REAR CENTER REFER SIZE TO PLAN (mm)	# # # # # # # # # # # # # # # # # # #
WATER	869.15) (B69.15)
SANITARY 100	77722
STORM	77.9 RETAINING
COMMENTS YES NO	WALL
DRAIN TO SUMP PUMP LIKELY REQUIRED  (FOR BASEMENT IF INSTALLED)	77
SEWER TO SUMP PUMP LIKELY REQUIRED	<u>LEGEND</u> STREET
(FOR BASEMENT IF INSTALLED)	AR AR AN I. A A STATE OF THE AREA A STATE OF T
SERVICES INSTALLED TO m INSIDE PROPERTY	oso ≥
CERTIFICATION REQUIRED	SROW (SHOWN ON ABOVE PLAN)  SROW (SHOWN ON ABOVE PLAN)
GEOTECHNICAL RESTRICTIONS APPLY (SEE GEOTECHNICAL REPORT)	D PROPOSED FRONT CORNER ELEVATIONS  PROPOSED FRONT SIDE YARD GRADES  L# 6  L# 6  L# 6  L# 6
ENVIRONMENTAL RESTRICTIONS APPLY (SEE ENVIRONMENTAL REPORT)	L# 6 L# 6 LEGAL LOT NUMBER
(SEE ENVINORMENTAL INCLOSE)	EG 49.90 S - EXISTING GROUND ELEVATION - LOWER/MAIN FLOOR ELEVATION
UTILITY EASEMENTS AFFECT THIS LOT	GFE 47.55 — GARAGE FLOOR ELEVATION
	MSE 52.20 - MINIMUM SANITARY SERVICABLE ELEVATION BY GRAVITY
	D 49.12 (P) — SAN SERVICE INV.  (P) DENOTES PUMP IS LIKELY REQUIRED FOR BASEMENT IF INSTALLED
	- STORM SERVICE INV. (P) DENOTES PUMP IS LIKELY REQUIRED
	FOR BASEMENT IF INSTALLED  PROPOSED REAR SIDE YARD GRADES
	[5] [8] L
NOTES	- LOT TYPE (L/LB/LBT) - PROPOSED REAR CORNER ELEVATIONS
1. IT IS THE RESPONSIBILITY OF THE BUILDER TO ENSURE THE FOOTINGS ARE PLACED ON A PROPER BASE THAT IS FREE FROM FROST, EXCESSIVE MOISTURE AND DELETERIOUS MATERIALS AND HAVE APPROPRIATE FROST PROTECTION WHEN COMPLETED.	LANE/LOT - PROPOSED REAR CORNER ELEVATIONS
2. THE INFORMATION CONTAINED HEREIN IS BASED ON THE APPROVED LOT GRADING PLAN FOR THIS SUBDIVISION. UN—AUTHORIZED DEVIATIONS WILL BE THE RESPONSIBILITY OF THE BUILDER TO ENSURE COMPLIANCE WITH ALL LOCAL BYLAWS.	I, THE BUILDER'S REPRESENTATIVE, CERTIFY THAT THE FINAL HOUSE PLANS PROVIDED IN THE BUILDING PERMIT
3. OTHER NOTES:	APPLICATION ARE THE SAME AS PROCESSED UNDER THIS GRADE SLIP AND THAT I UNDERSTAND THE INFORMATION AND THE REQUIREMENTS CONTAINED HEREIN AND WILL BUILD ACCORDINGLY.
	AUTHORIZED BUILDER'S REPRESENTATIVE DATE
	THE INFORMATION CONTAINED HEREIN IS BASED ON THE APPROVED

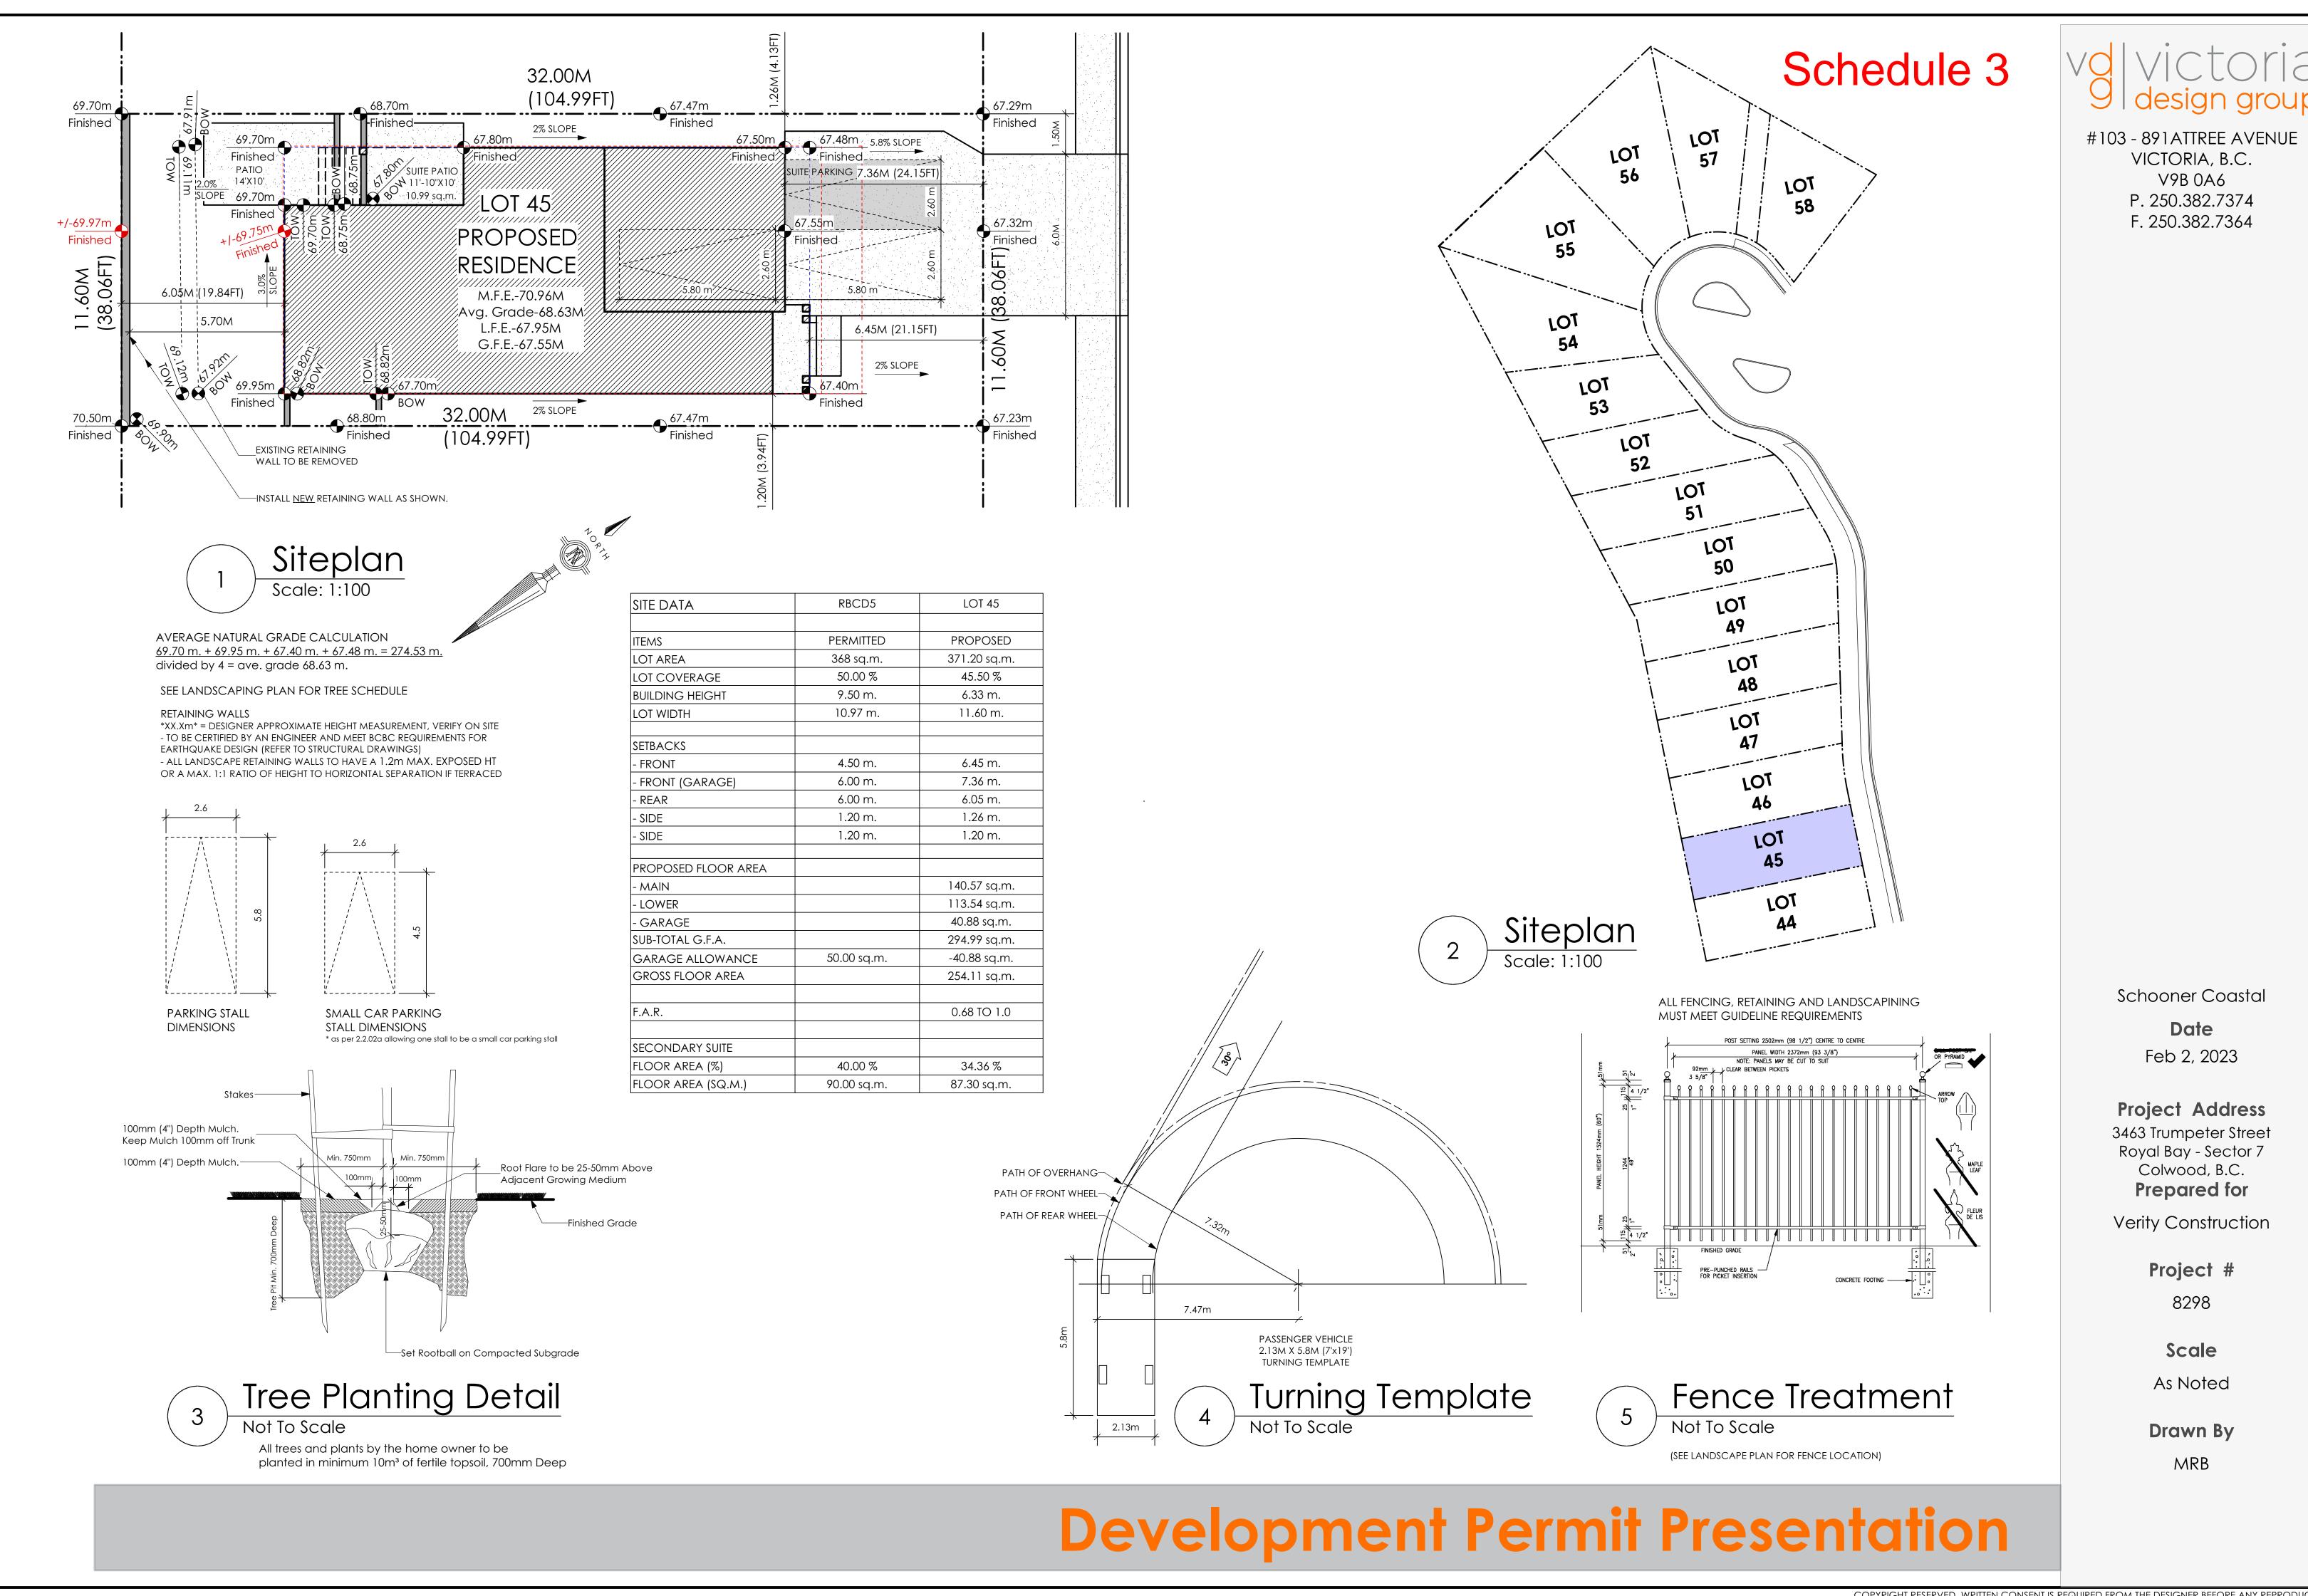

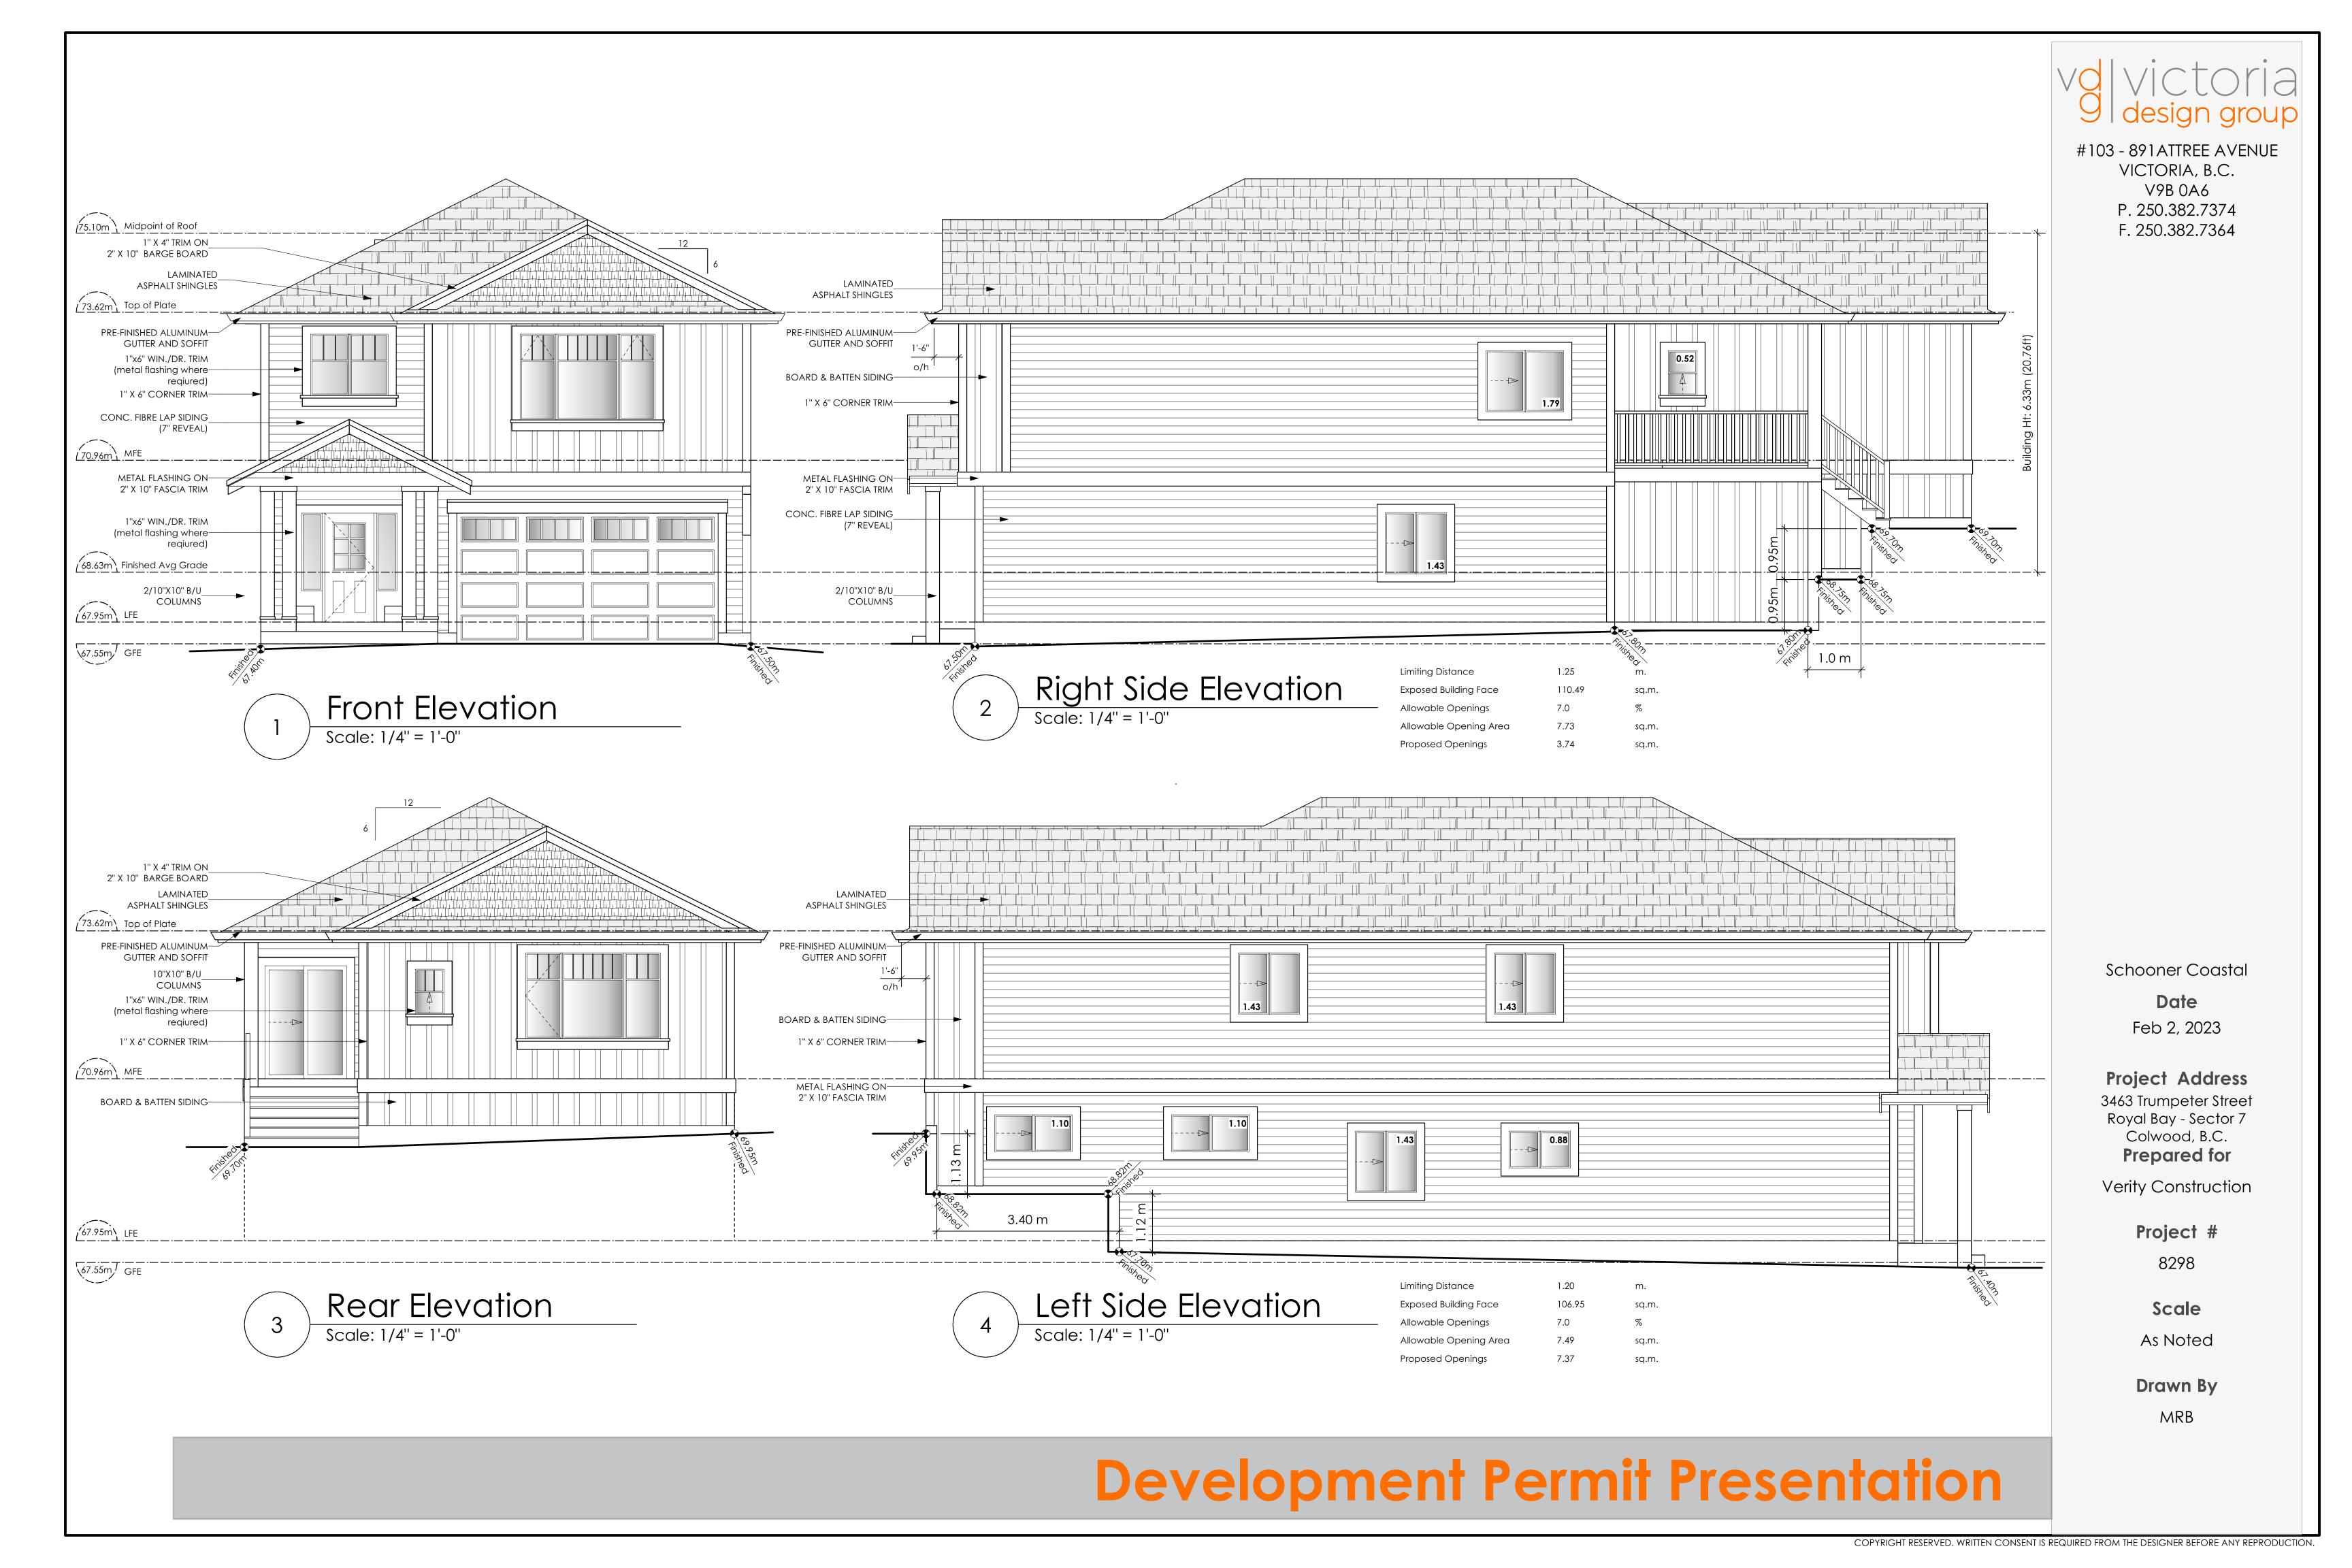

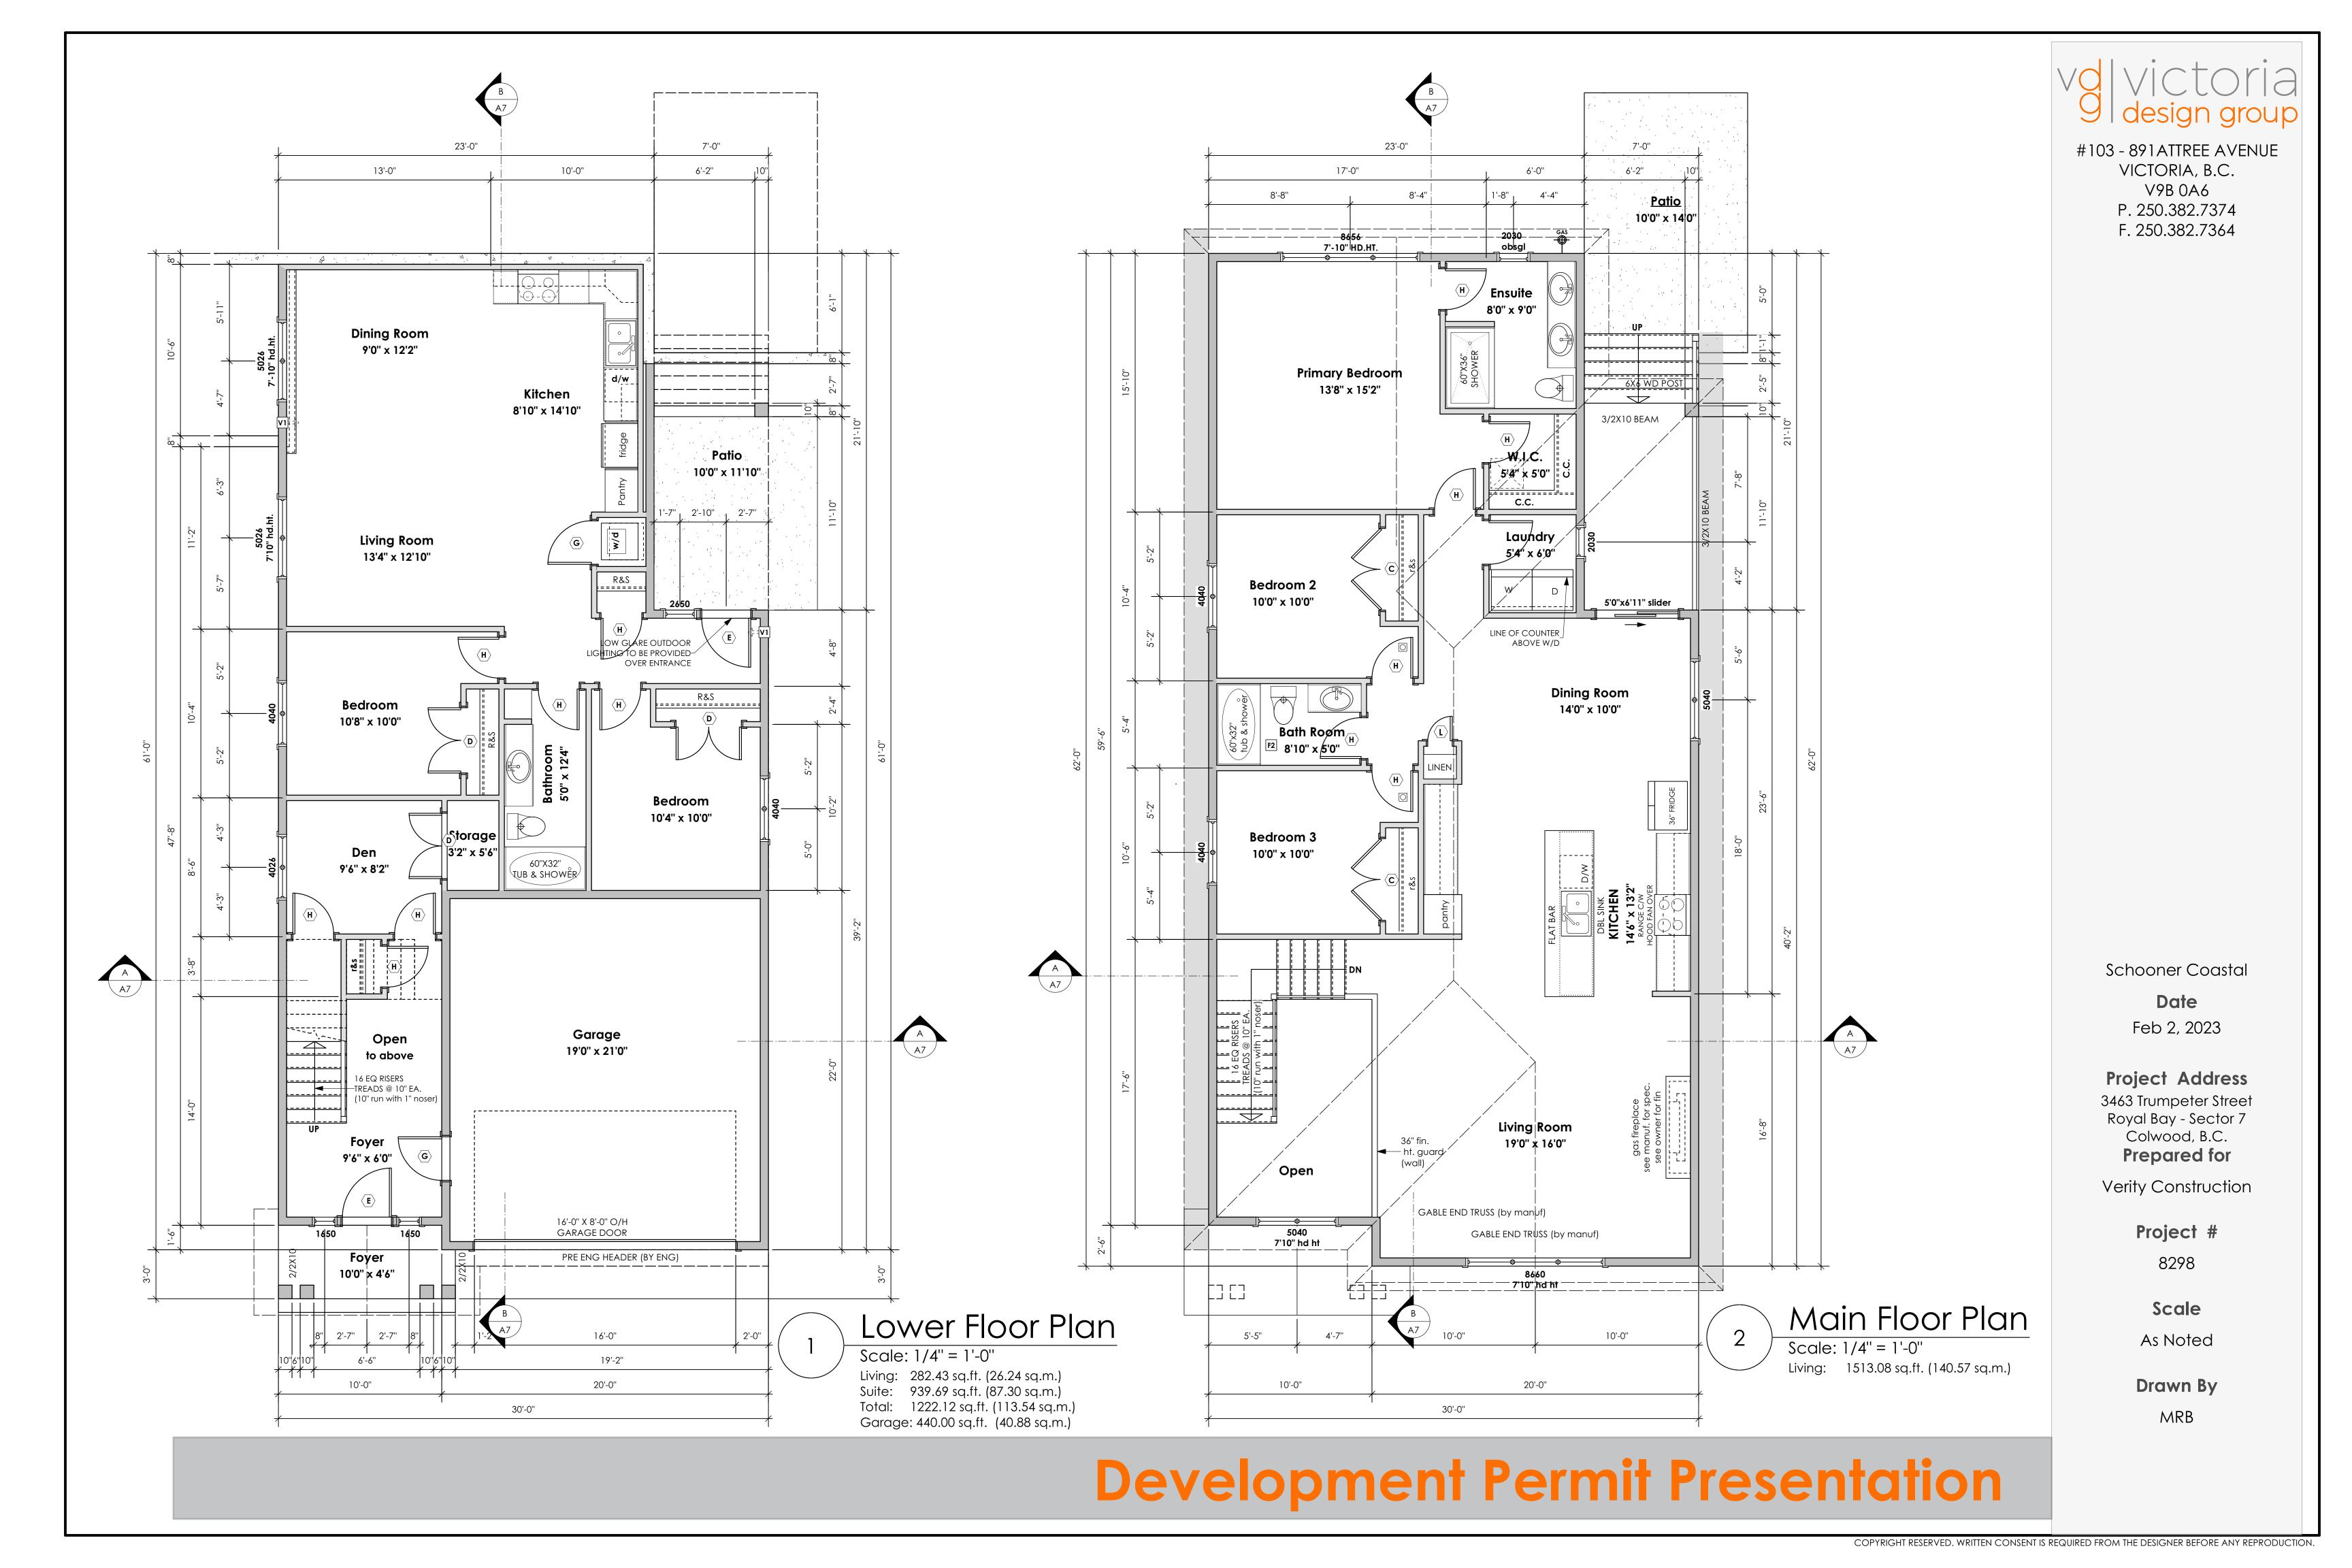

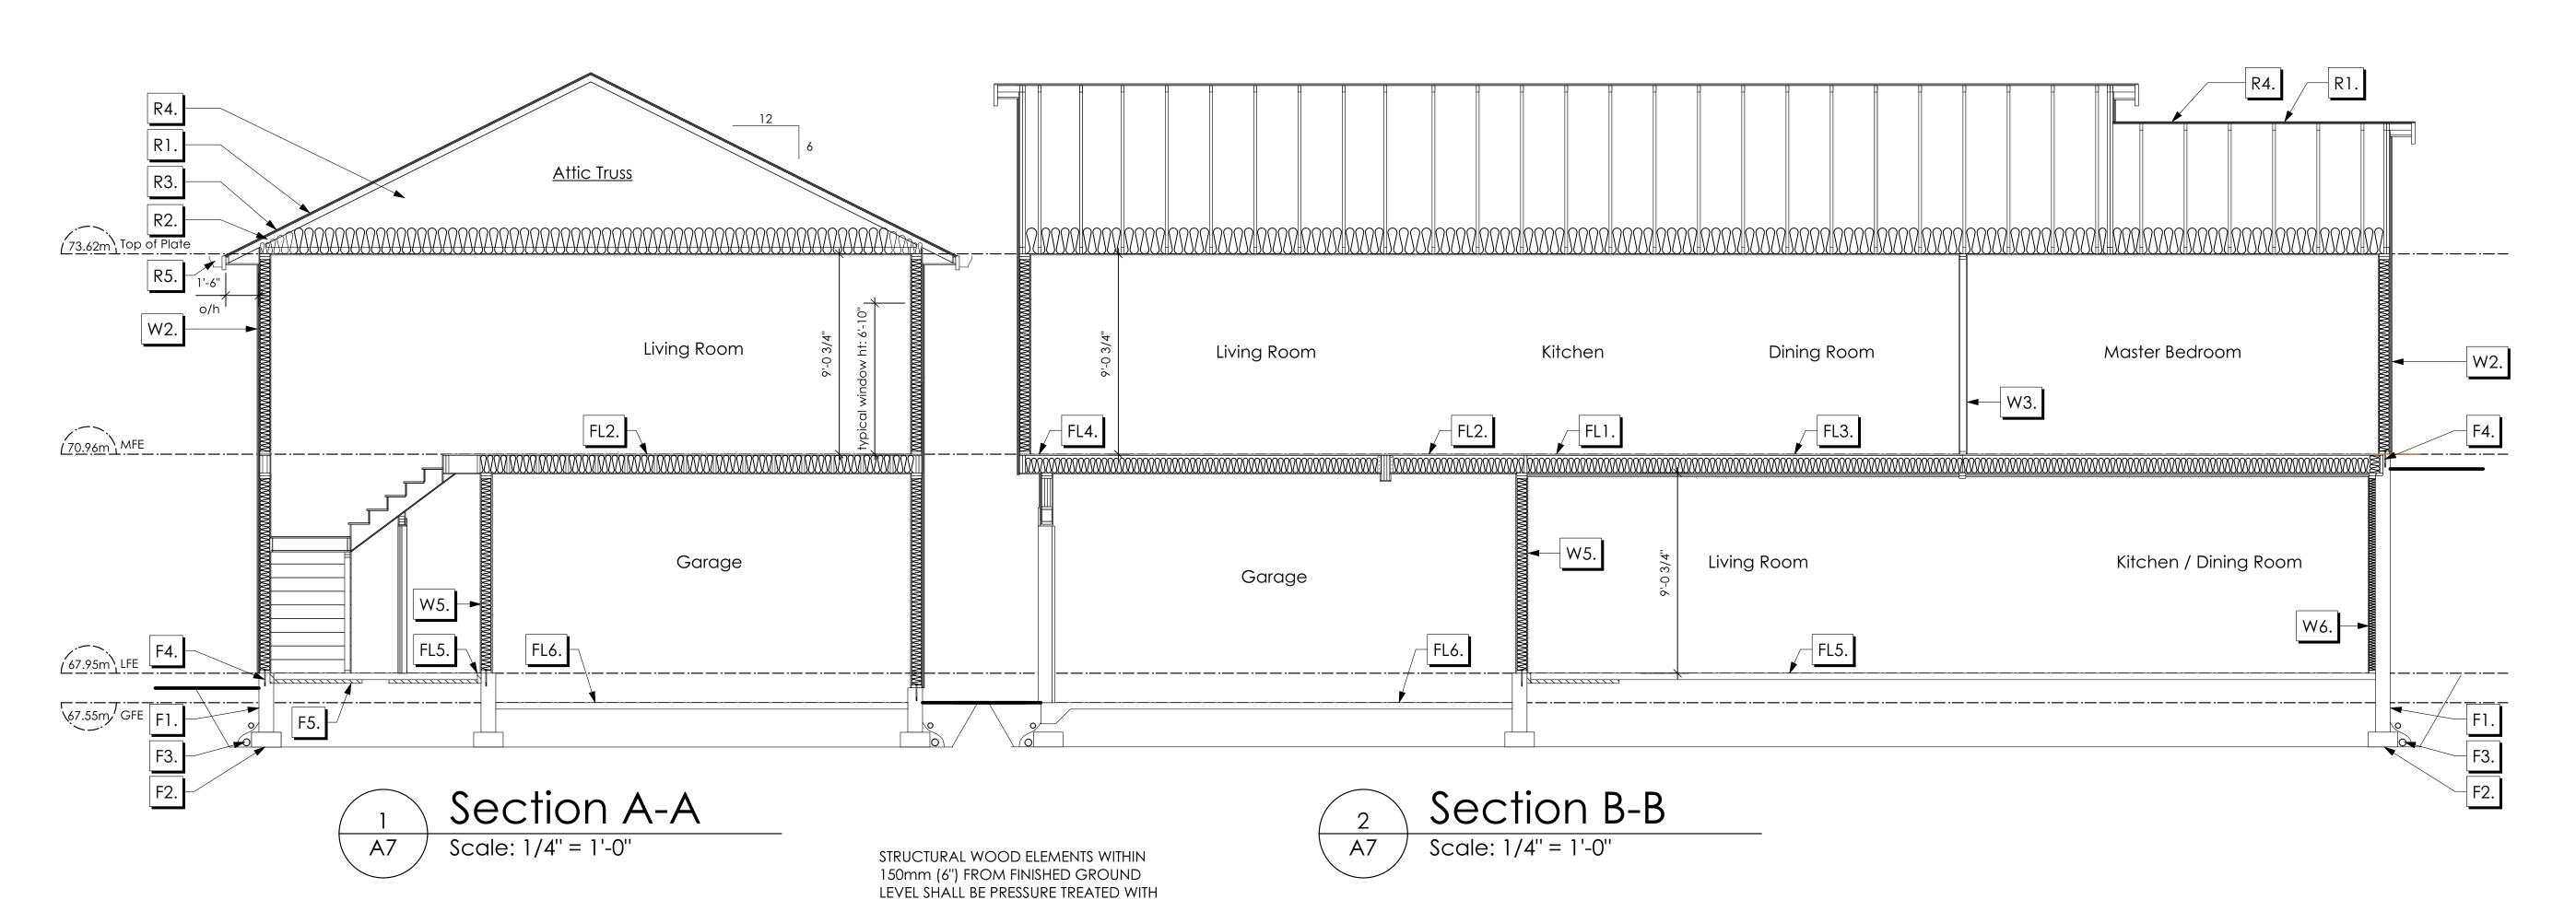

**ROOFS** 

7/16" ORIENTED STRAND BOARD WD TRUSSES (DESIGNED BY MANUF.) R-40 FIBRE GLAS BATT INSULATION OR 14 1/2" FIBRE GLASS LOOSE FILL INSULATION (ALLOW FOR SETTLING) 6 MIL POLY'N V.B.

R2. PROVIDE 2 1/2" (63MM) CLEAR BETWEEN R-20 INSULATION AND SHEATHING. (MIN. R-20 @ ROOF-WALL CONNECTION FOR 4'-0" (1.2M) AROUND PERIMETER OF BUILDING. AIR VENTILATION BAFFLES TO BE INSTALLED WHERE REQUIRED IN AS PER BCBC 9.19.)

R3. EAVE PROTECTION CONT. UP ROOF SLOPE FOR 12" PAST EXTERIOR WALL.

5/8" GYPSUM BOARD

- R4. PROVIDE 1 SQ.FT. ATTIC VENT PER 300 SQ.FT. OF INSULATED AREA MIN. 25% OF REQUIRED TO BE @ TOP AND BOTTOM (TO COMPLY WI. B.C. BLDG. CODE 9.19.1)
- R5. PRE-FIN. FASCIA GUTTER 2×8 FASCIA BD. 2×4 SUB. FASCIA BD. VENTED SOFFIT (SEE CONTRACTOR)

## **FLOORS**

19/32" ORIENTED STRAND BOARD (NAILED & GLUED TO FLOOR STRUCT. BELOW) ON 2×10 FLOOR JOISTS @ 16" OR 12" O/C C/W 2×2 X-BRIDGING @ 7.0' O/C (MAX) 1/2" GYPSUM BOARD

FL2. FINISHED FLOORING ON 19/32" ORIENTED STRAND BOARD (NAILED & GLUED TO FLOOR STRUCT. BELOW) ON 2×10 FLOOR JOISTS @ 16" OR 12" O/C C/W 2×2 X-BRIDGING @ 7.0' O/C (MAX) R-31 INSULATION 5/8" X-TYPE GYPSUM BOARD (BETWEEN GARAGE AND LIVING SPACE)

FL3. B.C. BUILDING CODE (TABLE-9.10.3.1.B) RATED FLOOR ASSEMBLY F8D FINISHED FLOORING ON 19/32" ORIENTED STRAND BOARD (FASTENED & GLUED TO FLOOR STRUCT. BELOW) ON 2×10 FLOOR JOISTS @ 16" OR 12" O/C C/W 2×2 X-BRIDGING @ 7.0' O/C (MAX) R-31 INSULATION RESILIENT METAL CHANNELS @ 24" O/C 1 LAYERS 5/8" X-TYPE GYPSUM BOARD 30 MINUTE F.R.R., 50 S.T.C.

FL4. FINISHED FLOORING ON 19/32" ORIENTED STRAND BOARD (NAILED & GLUED TO FLOOR STRUCT. BELOW) ON 2×10 FLOOR JOISTS @ 16" OR 12" O/C C/W 2×2 X-BRIDGING @ 7.0' O/C (MAX) PROVIDE R-31 F/G BATT INSULATION IN JOIST CAVITY BUILDING WRAP VENTED SOFFIT (TO OWNERS SPEC'S) TO ALL SUSPENDED FLOOR AREAS (NOT SHOWN IN SECTION)

3 1/2" CONCRETE SLAB 6 MIL. POLY'N V.B. 6" COMPACTED GRAVEL OR SAND

A PRESERVATIVE FOR TERMITE AND DECAY

PROTECTION B.C.B.C. 9.3.2.9.(3)

FL6. 3 1/2" CONCRETE SLAB 6 MIL. POLY'N V.B. 6" COMPACTED GRAVEL OR SAND SLOPE TO DOORS 1"

FL7. DECKING MEMBRANE (TO COMPLY WITH CAN/CGSB 37.54) ON 19/32" ORIENTED STRAND BOARD C/W "H" CLIPS TAPERS TO PROVIDE MIN.1:50 SLOPE ON 2×4 WOOD STRAPPING @ 16" O/C 2×10 ROOF JOISTS @ 16" O/C C/W (PROVIDE ADEQUATE MEMBRANE "UPSTAND" @ EXT. WALL.) R-31 INSULATION RESILIENT METAL CHANNELS @ 24" O/C 1 LAYERS 5/8" X-TYPE GYPSUM BOARD 30 MINUTE F.R.R. (NOT SHOWN IN SECTION)

ENERGY STAR LOW "E" RATING IN

**WALLS** 

THERMAL BREAK FRAMES 2/2"X10" LINTEL OVER (@ BEARING WALLS ONLY) (TYPICAL, WI. 2 1/2" XPS INSULATION) FLASHING OVER @ EXTERIOR (GLAZING IN ALL EXTERIOR DOORS & WITHIN 3 FT. OF EXTERIOR DOORS TO BE SHATTERPROOF (SP)) WINDOW REQUIREMENTS DERIVED FROM BCBC TABLE C-5 AS PER BCBC 9.7.4.3. AND ARE TO BE USED TO SATISFY THE REQUIREMENTS OF AAMA/WDMA/CSA 101/I.S.2/A440, "NAFS": COLWOOD, CLASS R, DP 1440, PG 30, WATER RESIST. 220, A2, RATINGS MUST BE CLEARLY LABELED ON ALL WINDOW UNITS UPON INSTALLATION FOR INSPECTION.

W2. CONC. FIBRE BOARD ON 9.5MM (3/8") AIR SPACE / STRAPPING 3/8"×2" BORATE TREATED PLYWOOD STRAPPING BUILDING WRAP on 7/16" ORIENTED STRAND BOARD SHEATHING 2×6 STUDS @ 16" O/C R-20 INSULATION 6 MIL. POLYETHYLENE VAPOUR BARRIER 1/2" GYPSUM BOARD (REFER TO DETAILS ON D1)

(NOT SHOWN IN SECTION)

W3. INTERIOR PARTITION 1/2" GYPSUM BOARD ON EACH SIDE OF 2×4 STUDS @ 16" O/C OR 2×6 STUDS @ 16" O/C (IF NOTED)

W4. PRE-MANUFACTURED STONE VENEER (INSTALLED TO MANUF. SPEC) LIME BASED MORTAR SETTING BED ON LIME BASED MORTAR SCRATCH COAST ON METAL LATHE INSTALLED HORIZONTALLY OVERLAP HORIZONTAL AND VERTICAL SEAMS 1" SEMI-RIGID BACK BOARD (HAL-TEX RAINBOARD OR EQ.) 9.5MM (3/8") AIR SPACE / STRAPPING 3/8"×2" BORATE TREATED PLYWOOD STRAPPING HOUSE WRAP (A.B.) (TYVEK OR EQ.) 7/16" ORIENTED STRAND BOARD SHEATHING 2×6 STUDS @ 16" (AS REQUIRED) (NOT SHOWN IN SECTION)

# 2×6 STUDS @ 16" O/C C/W R-20 INSULATION

6 MIL. POLY'N V.B

1/2" GYPSUM BOARD

W6. 1/2" GYPSUM BOARD ON

6 MIL. POLY'N V.B.

(BETWEEN GARAGE & LIVING)

2×4 STUDS @ 24" O/C C/W

12.7MM (1/2") AIR SPACE

ASSEMBLIES TO COMPLY WITH

W7. B.C. BUILDING CODE (TABLE 9.10.3.1.A)

2×6 STUDS @ 16" O/C (IF NOTED)

@ 400mm OR 600mm O.C. C/W

3 1/2" FIBRE GLASS SOUND BATTS

45 MIN. F.R.R., 43 S.T.C.

FRICTION FITTED AND SOLID FILLED

B.C. BLDG. CODE 9.10.16.)

RATED WALL ASSEMBLY W3c

2 PLY 30 MINUTE BUILDING PAPER OR

(PROVIDE REQUIRED FIRE STOPS IN WALL

1 LAYER 1/2" X-TYPE GYPSUM BOARD ON

RESILIENT METAL CHANNELS ON ONE SIDE

(BETWEEN PRIMARY LIVING & SECONDARY SUITE)

EACH SIDE OF 2×4 STUDS @ 16" O/C OR

R-12 BATT INSULATION

16"X 8" CONC. FOOTINGS ON UNDISTURBED SOIL (SOLID BEARING)

4" PERIMETER DRAIN

UNDER SLAB INSULATION 2 1/2" (RSI 2.15) EXTRUDED POLYSTYRENE RIGID INSULATION 4'-0" (1.2M) CONT. AROUND PERIMETER UNDER SLAB INSTALLED HORIZONTALLY (VERIFY WITH MUNICIPALITY DEPTH OF FROST LINE)

# **FOUNDATION WALLS**

8" THK. CONC. FOUNDATION WALL C/W 15 M BARS @ 24" O/C B/W

C/W 2 (TWO) 15M BARS CONT. 3 IN. FROM BOTT.

3" TIGHT PIPE FOR RWL DRAIN ROCK

ANCHOR BOLTS @ 4.0 FT. O/C MAX C/W SILL GASKETS

Feb 2, 2023

**Project Address** 3463 Trumpeter Street Royal Bay - Sector 7 Colwood, B.C. Prepared for

Schooner Coastal

Date

#103 - 891ATTREE AVENUE

VICTORIA, B.C.

V9B 0A6

P. 250.382.7374

F. 250.382.7364

Verity Construction

Project #

8298

Scale


As Noted

Drawn By MRB


### ALL FENCING, RETAINING AND LANDSCAPING MUST MEET THE **GUIDELINE REQUIREMENTS**

ALL RETAINING WALLS ARE TO BE STAND ALONE STRUCTURES (THEY MUST TERMINATE AT PROPERTY LINE) AND MUST NOT CONNECT TO RETAINING WALLS LOCATED ON ADJACENT PRIVATE PROPERTIES


\*NOTE: In the interest of maintaining high standards, the developer reserves the right to modify plans. specifications and design without prior notice. Drawings contained within are artist renderings only. Sizes and dimensions are approximate and may vary with actual plan and survey. Exterior style may change pending municipal approval. Retaining wall location and types may vary and are subject to municipal, engineering or developer discretion. Subject to change without notice. Furniture as shown on plans are for layout purposes only and are not included in the sale.

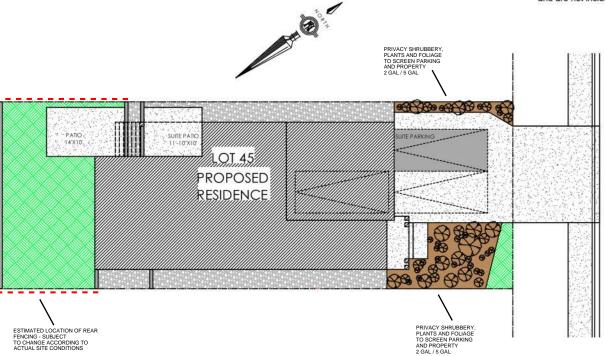


	ITEM	AREA (sf)	%	
88	GARDEN BED	280	12%	
	GRAVEL	432	19%	
	CONCRETE	884	39%	
	SOD	678	30%	
	TOTAL	2,274	100%	

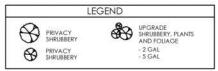



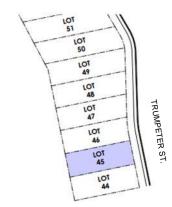

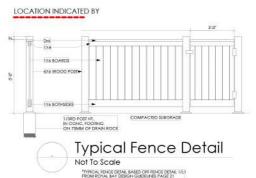

# All trees and plants by the home owner to be

Tree Planting Detail

### ADDITIONAL NOTES:

PROPERTY TO BE IRRIGATED 6" PIPE FOR DRIVEWAY SLEEVES TO BE INSTALLED FOR CITY IRRIGATION LINES

LANDSCAPE PLAN
NOT TO SCALE

DATE	ISSUED/REVISED	MM/DD/YY	
PROJE	FOR APPROVAL	09/21/22	01
	GARDEN BED PLANTING	10/07/22	02
	REVISION AS PER CITY OF COLWOOD	12/23/22	03

**PROJECT** 

LANDSCAPING PLAN LOT 45, 3463 TRUMPETER ST. **ROYAL BAY, SECTOR 7** CITY OF COLWOOD




QUALITY CONSTRUCTION. TRUSTED SERVICE.

106 - 1039 Langford Parkway Victoria, B.C. V9B 0A6

P: 250.474.1039 www.verityconstruction.ca

Roof Flare to be 25-50mm Above Adjacent Growing Medium



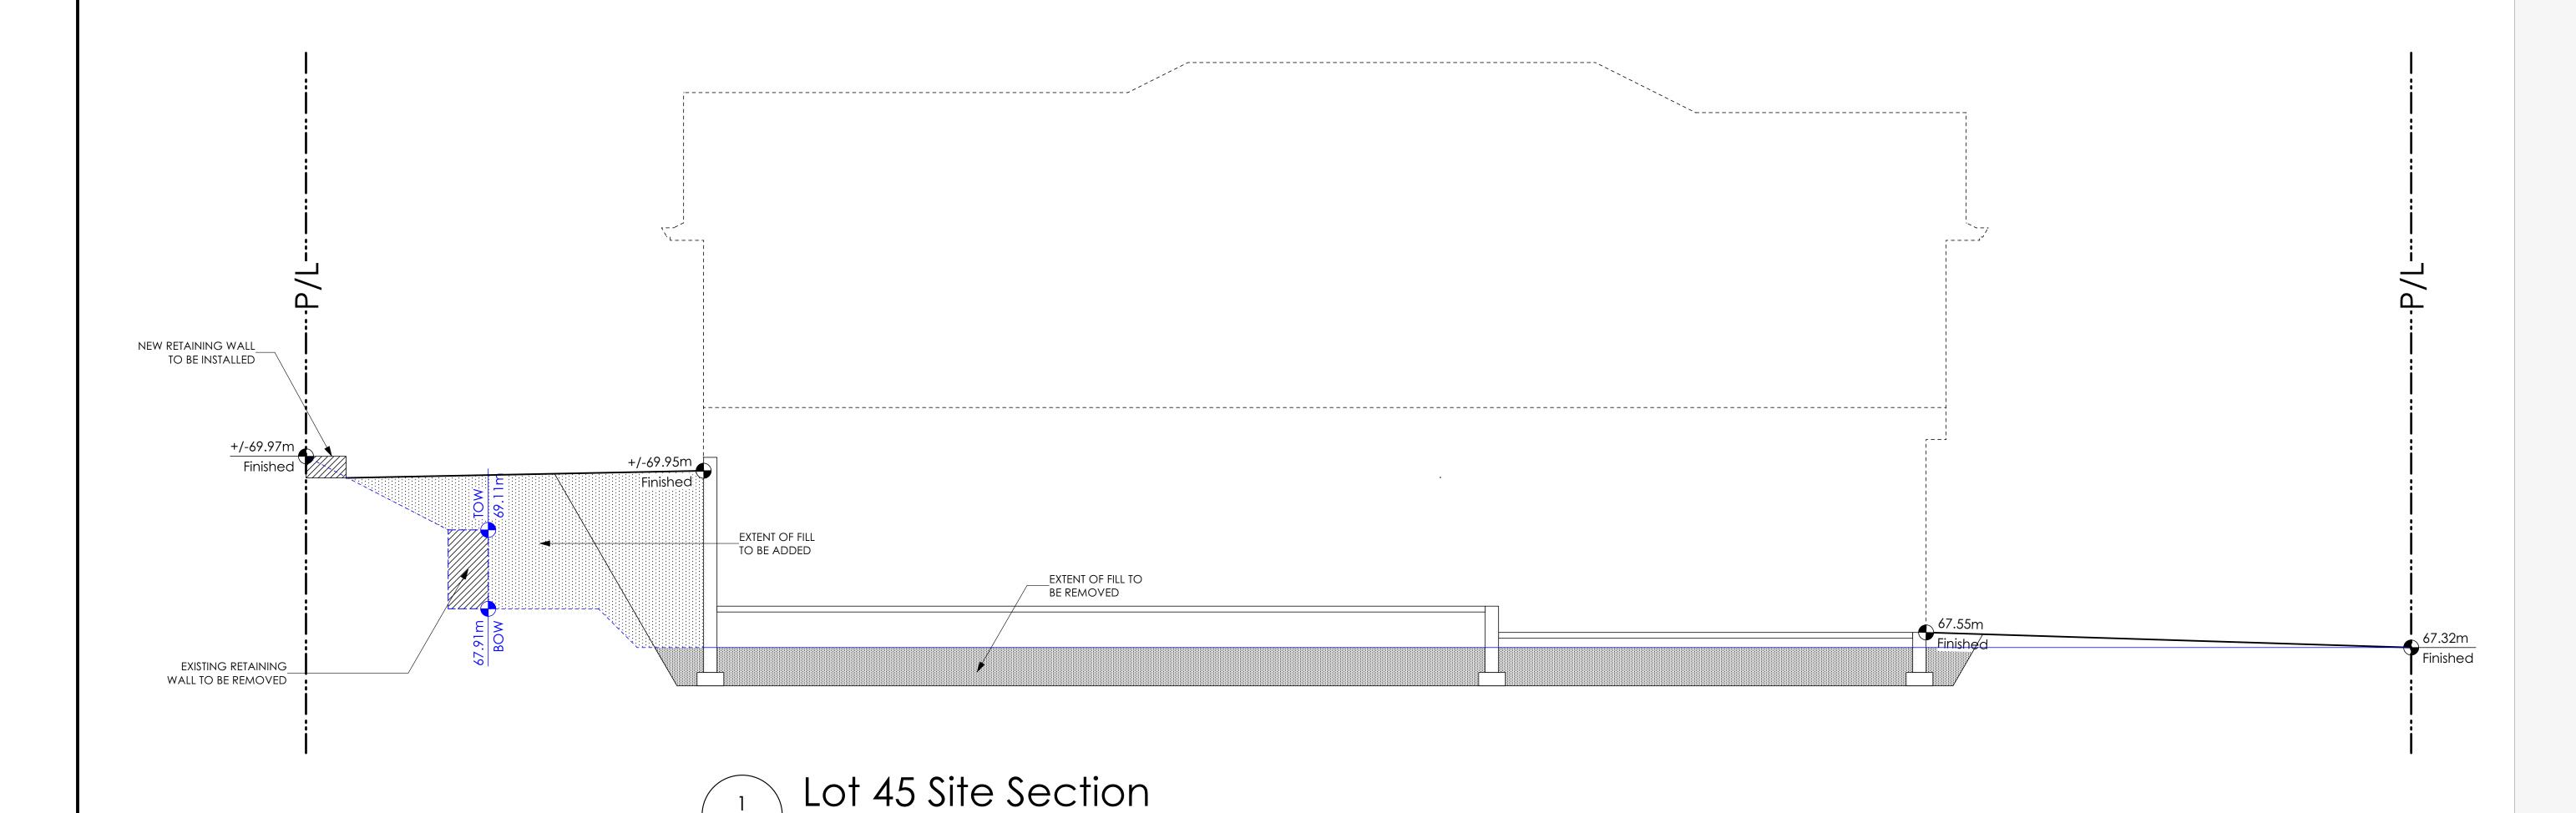

Scale: 1/4" = 1'-0"

Schooner Coastal

Date

Feb 2, 2023

**Project Address** 

3463 Trumpeter Street Royal Bay - Sector 7 Colwood, B.C. **Prepared for** 

Verity Construction

Project #

8298

Scale

As Noted

Drawn By


MRB

WSP	Project	No:	201-08151-00
	,		

C. Hume - October 5/22

DATE

GABLECTAST HOMES BILLIDING	WSP Project No: 201-08151-00
DOILDING	- Issue Date.
MUNICIPAL ADDRESS 3463 Trumpeter Street	P.I.D.
LOT 45	PLAN
VERITY HOMES	SUBDIVISION ROYAL BAY SECTOR 7
ADDRESS	DEVELOPER  MEADOWS DEVELOPMENT LP
REPRESENTATIVE PH.	CONSULTANT  WSP CANADA INC
PROPOSED BUILDING GRADES  ALL ELEVATIONS ARE METRIC GEODETIC +  MAIN FLOOR ELEVATION	67.32 45 67.32 45 67.66.6 MFE 67.75 MSE 64.25 S 63.76 D 63.85 BF
WATER	(B67.84) (B67.84) (C9.12) (C9.
COMMENTS YES NO	RETAINING WALLS
DRAIN TO SUMP PUMP LIKELY REQUIRED (FOR BASEMENT IF INSTALLED)	LEGEND
SEWER TO SUMP PUMP LIKELY REQUIRED  (FOR BASEMENT IF INSTALLED)	STREET
FOUNDATION SOIL BEARING INVESTIGATION CERTIFICATION REQUIRED	SROW SROW SROW SROW SROW SROW SROW SROW
(SEE ENVIRONMENTAL REPORT)	EG 49.90  LFE/MFE 47.70  GFE 47.55  MSE 52.20 S 49.12 (P) D 49.12 (P)  CO
NOTES  1. IT IS THE RESPONSIBILITY OF THE BUILDER TO ENSURE THE FOOTINGS ARE PLACED ON A PROPER BASE THAT IS FREE FROM FROST, EXCESSIVE MOISTURE AND DELETERIOUS MATERIALS AND HAVE APPROPRIATE FROST PROTECTION WHEN COMPLETED.	- LOT TYPE (L/LB/LBT) - PROPOSED REAR CORNER ELEVATIONS LANE/LOT
2. THE INFORMATION CONTAINED HEREIN IS BASED ON THE APPROVED LOT GRADING PLAN FOR THIS SUBDIVISION. UN—AUTHORIZED DEVIATIONS WILL BE THE RESPONSIBILITY OF THE BUILDER TO ENSURE COMPLIANCE WITH ALL LOCAL BYLAWS.  3. OTHER NOTES:	I, THE BUILDER'S REPRESENTATIVE,  CERTIFY THAT THE FINAL HOUSE PLANS PROVIDED IN THE BUILDING PERMIT APPLICATION ARE THE SAME AS PROCESSED UNDER THIS GRADE SLIP AND THAT I UNDERSTAND THE INFORMATION AND THE REQUIREMENTS CONTAINED HEREIN AND WILL BUILD ACCORDINGLY.
	AUTHORIZED BUILDER'S REPRESENTATIVE DATE  THE INFORMATION CONTAINED HEREIN IS BASED ON THE APPROVED LOT GRADING PLAN FOR THIS SUBDIVISION, DATED

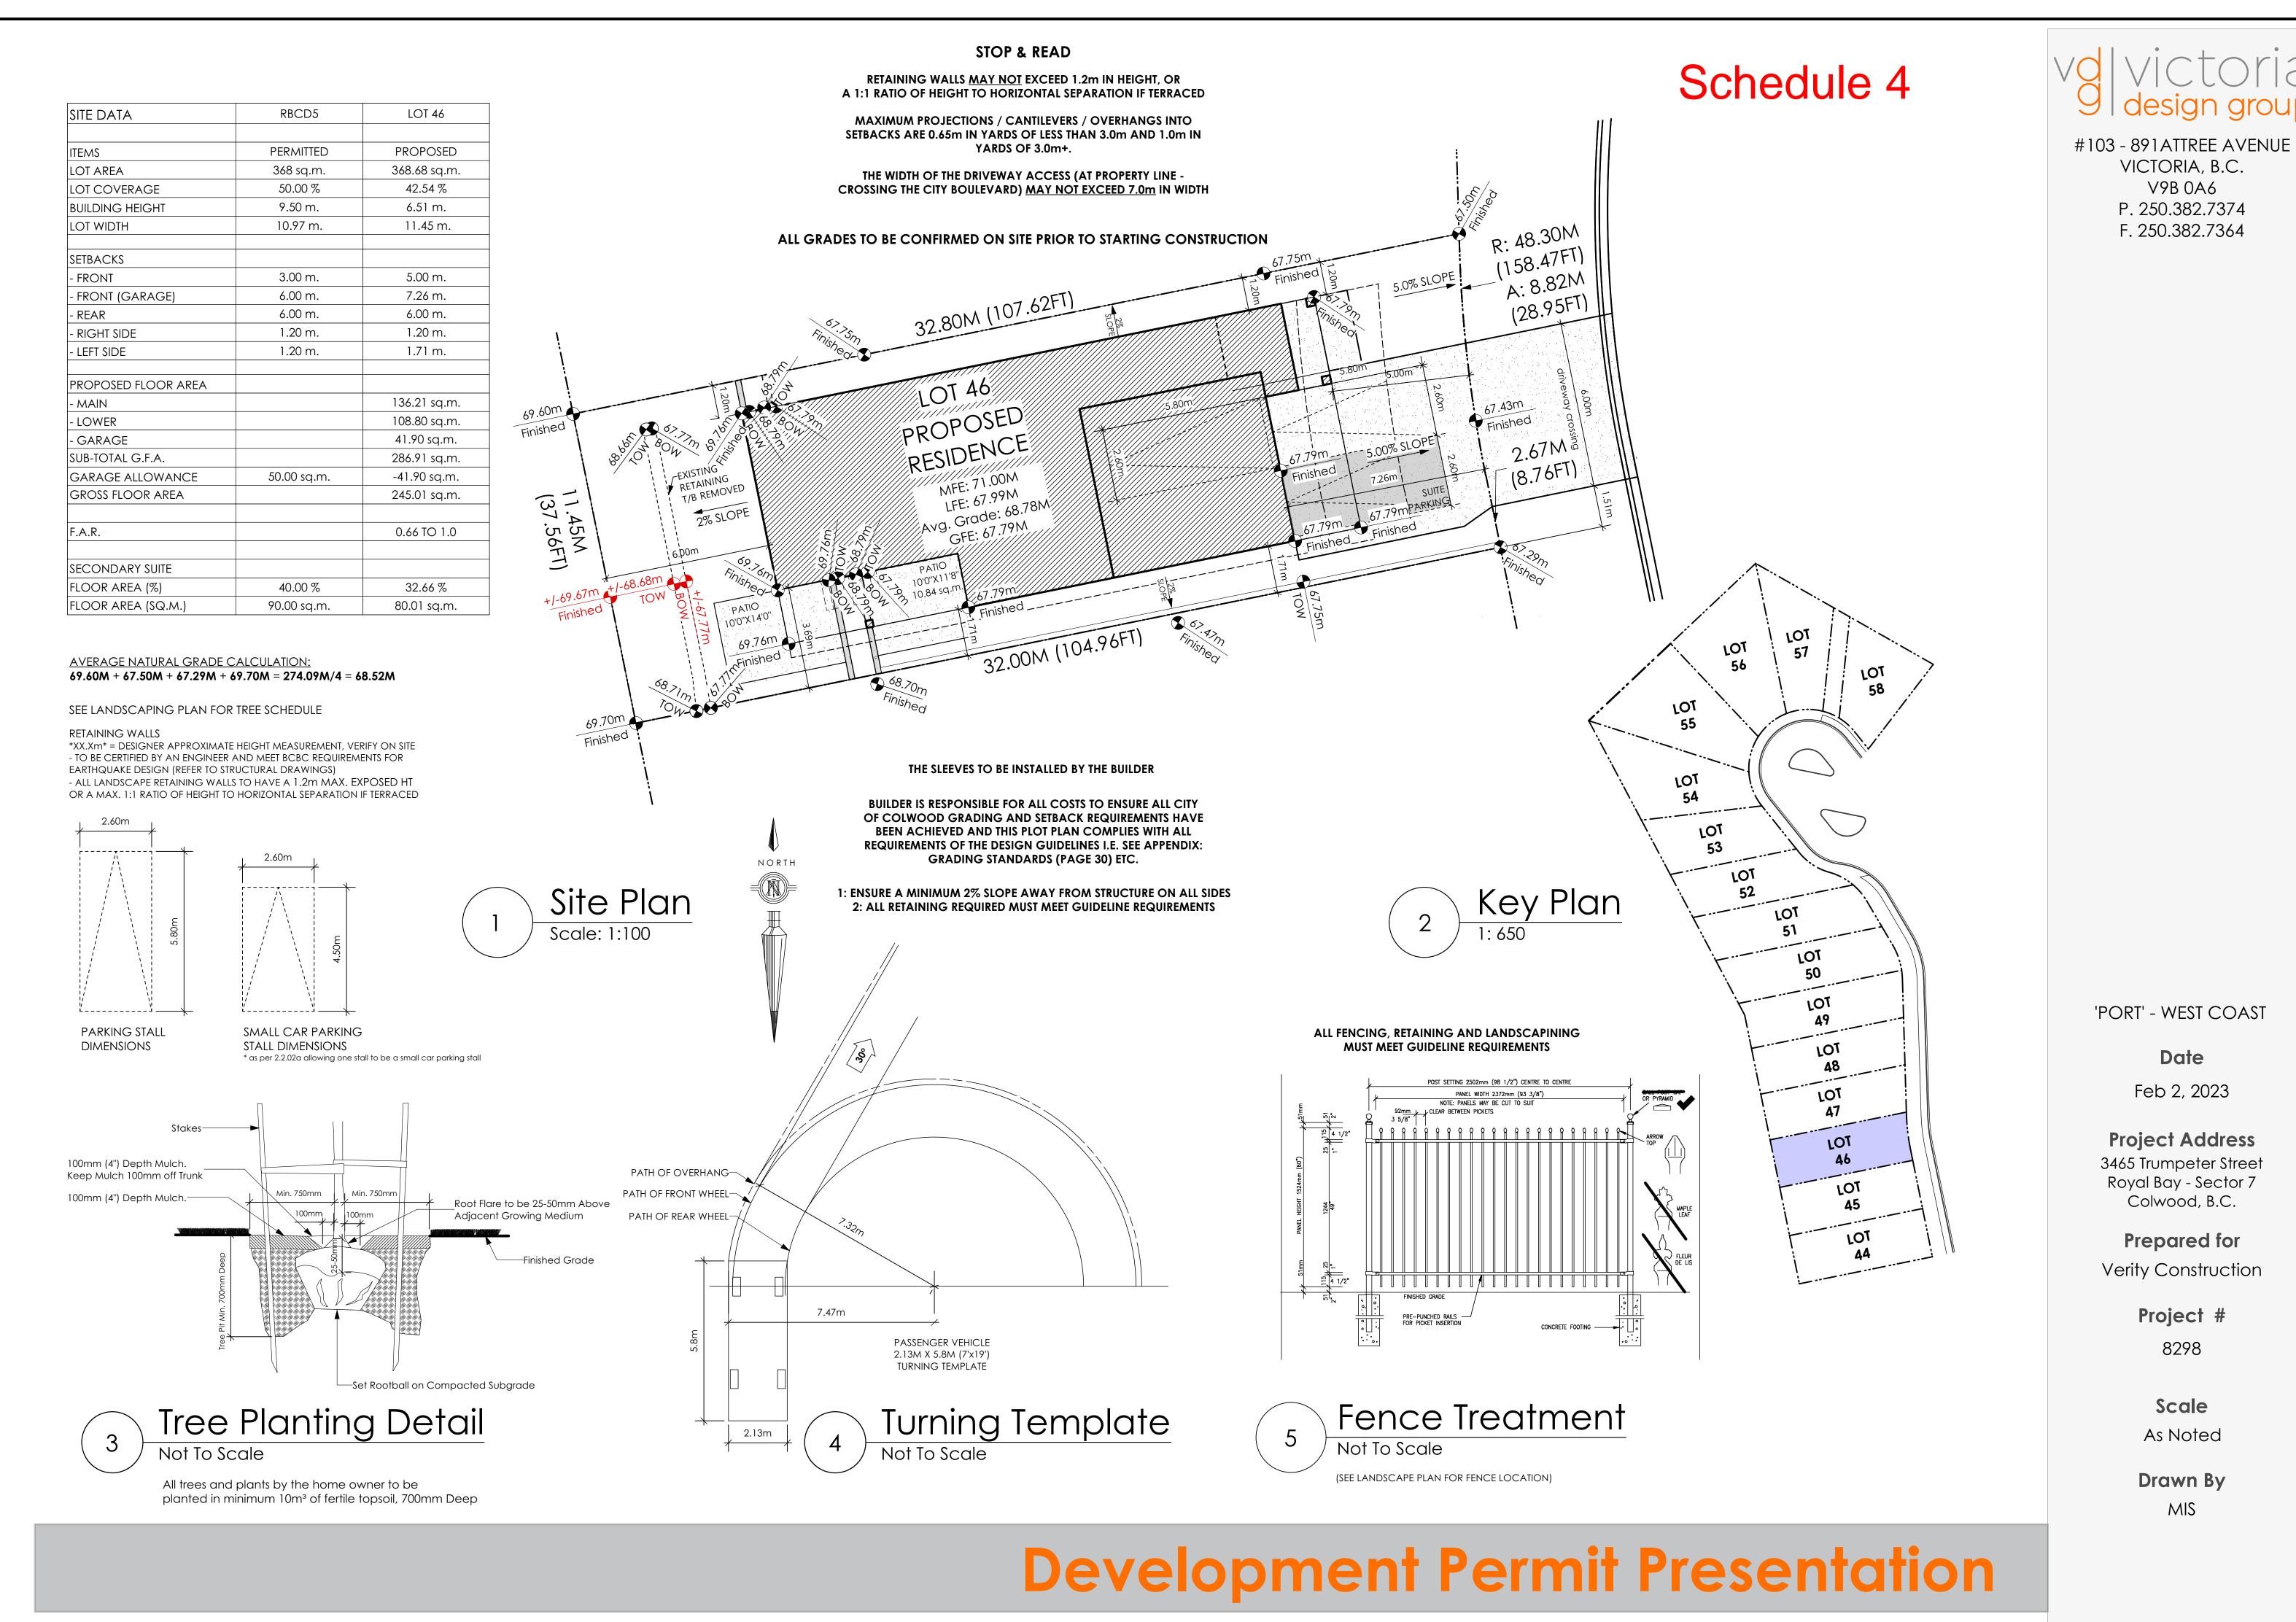

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V9B 0A6

Date


8298

Scale

As Noted

MIS



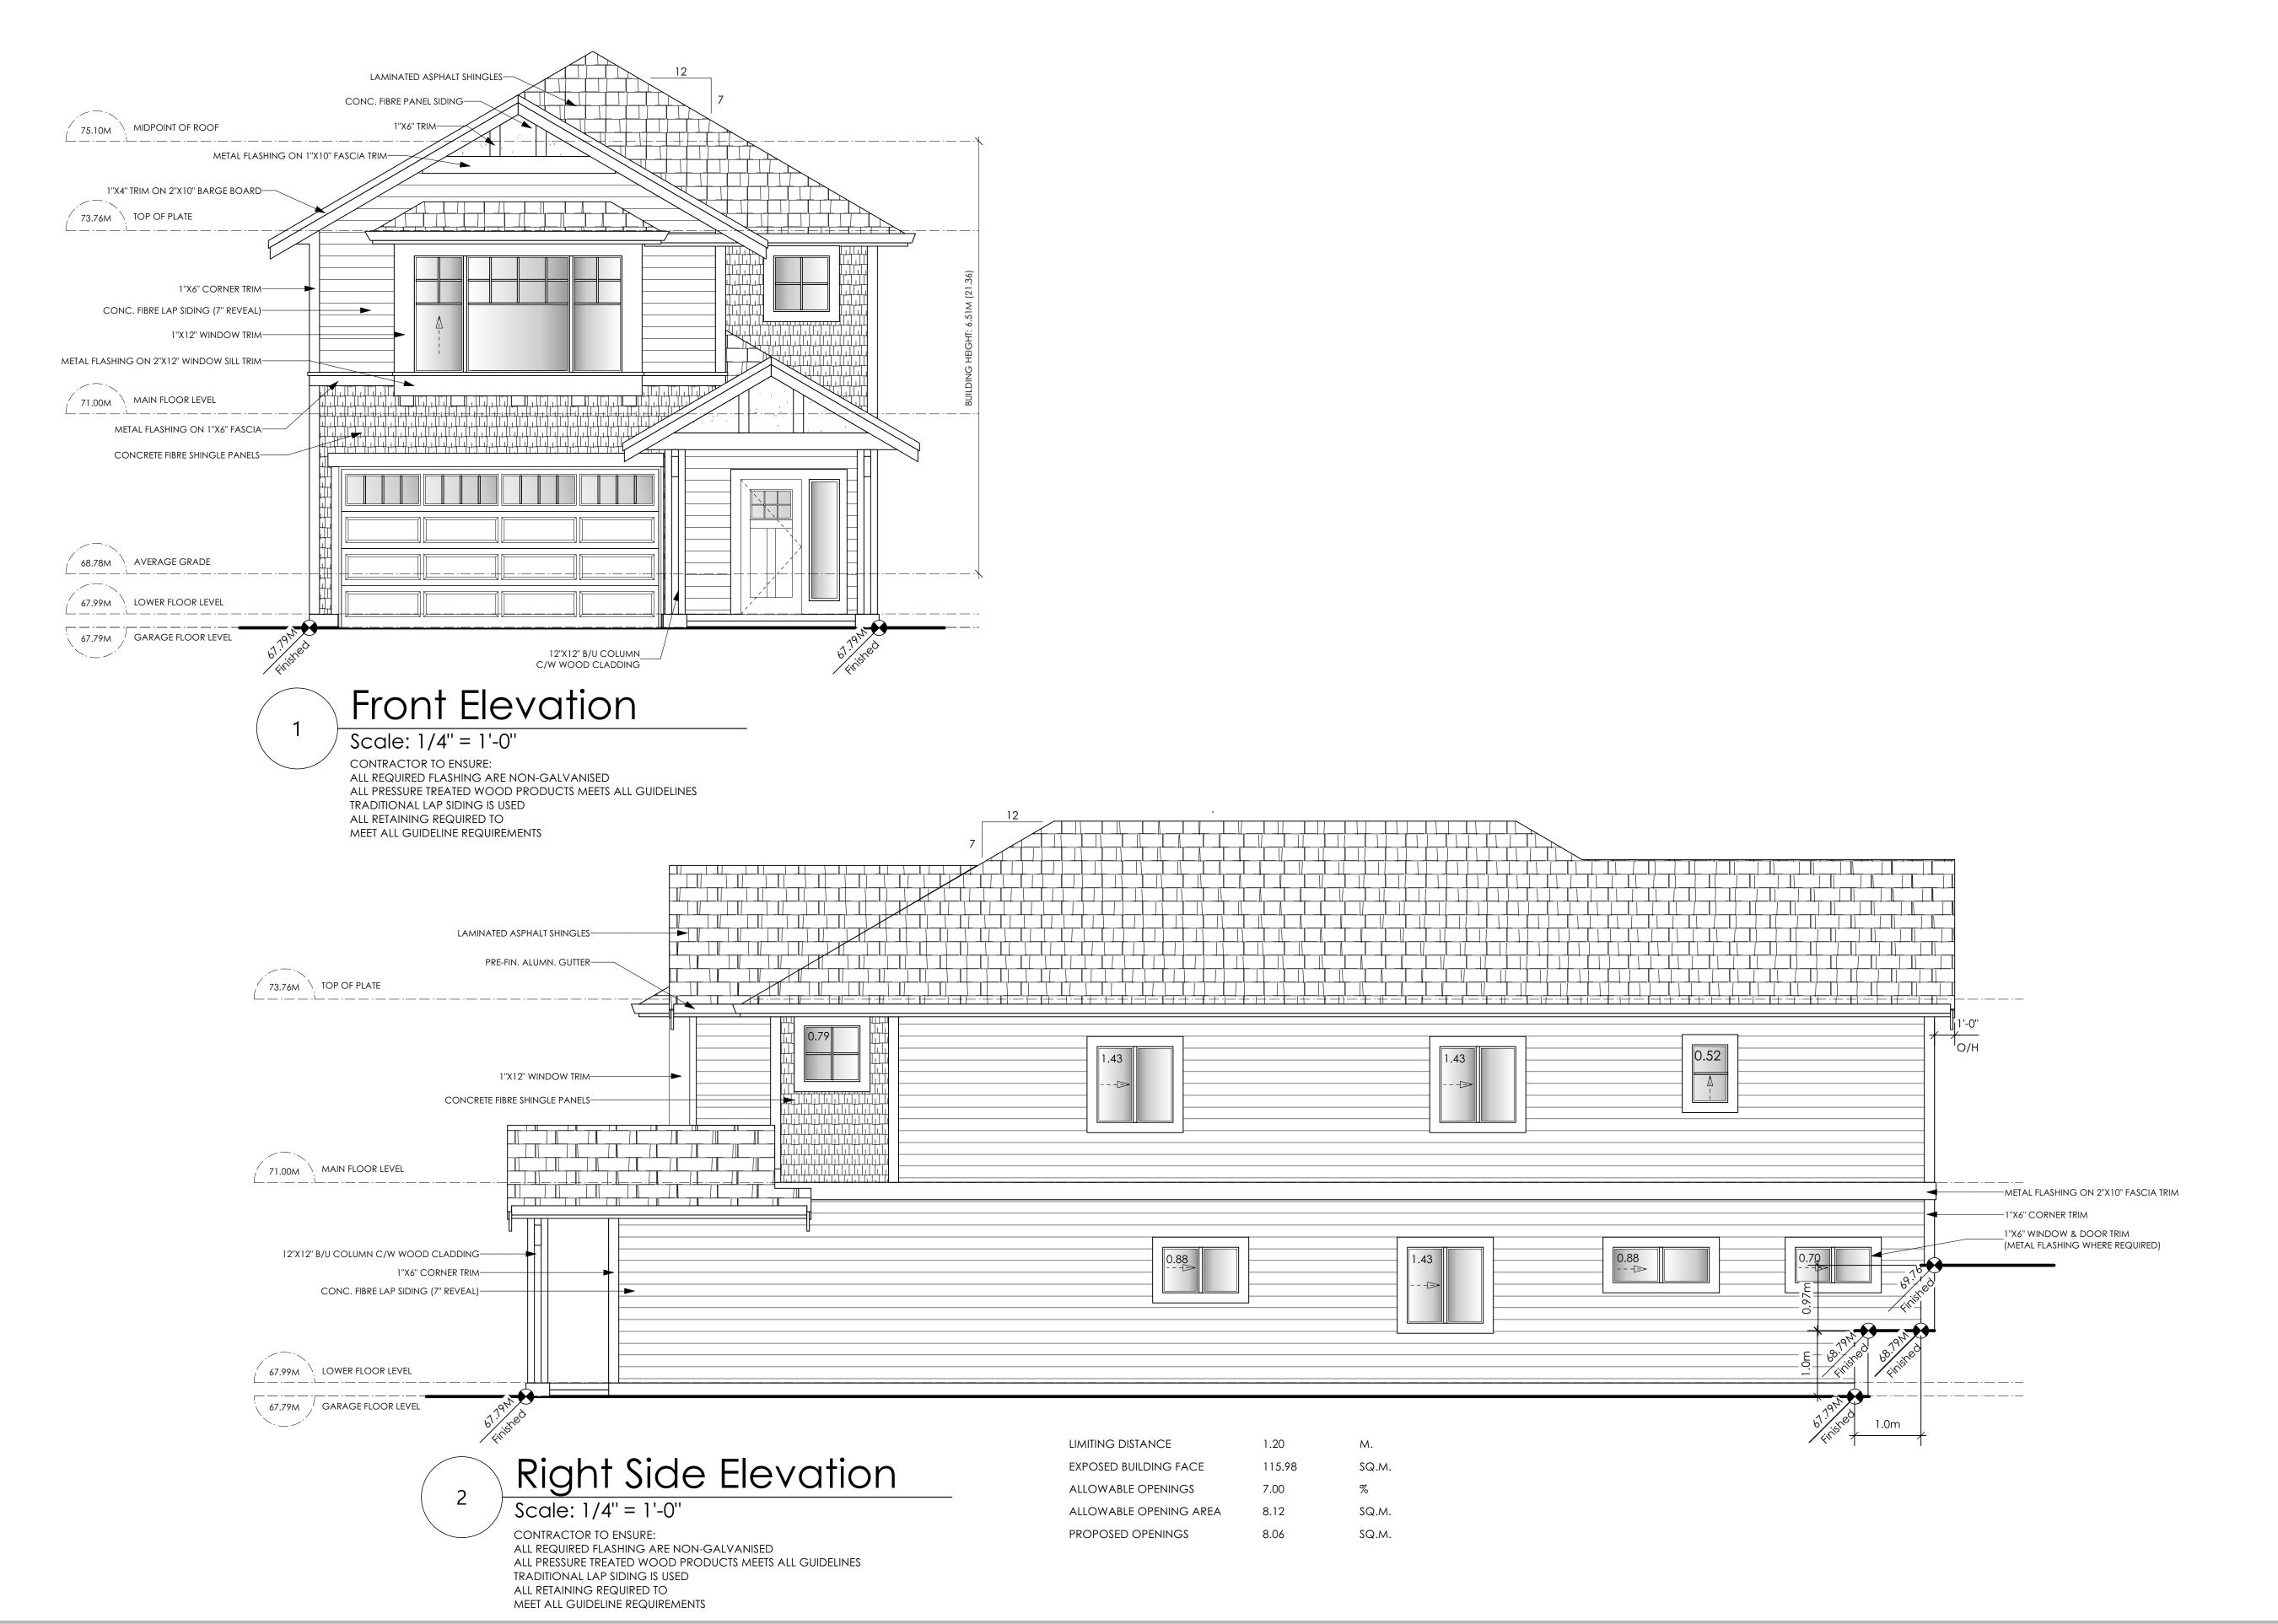

'PORT' - WEST COAST

Date

Feb 2, 2023

Project Address
3465 Trumpeter Street
Royal Bay - Sector 7
Colwood, B.C.


Prepared for Verity Construction

**Project #** 8298

**Scale**As Noted


Drawn By
MIS




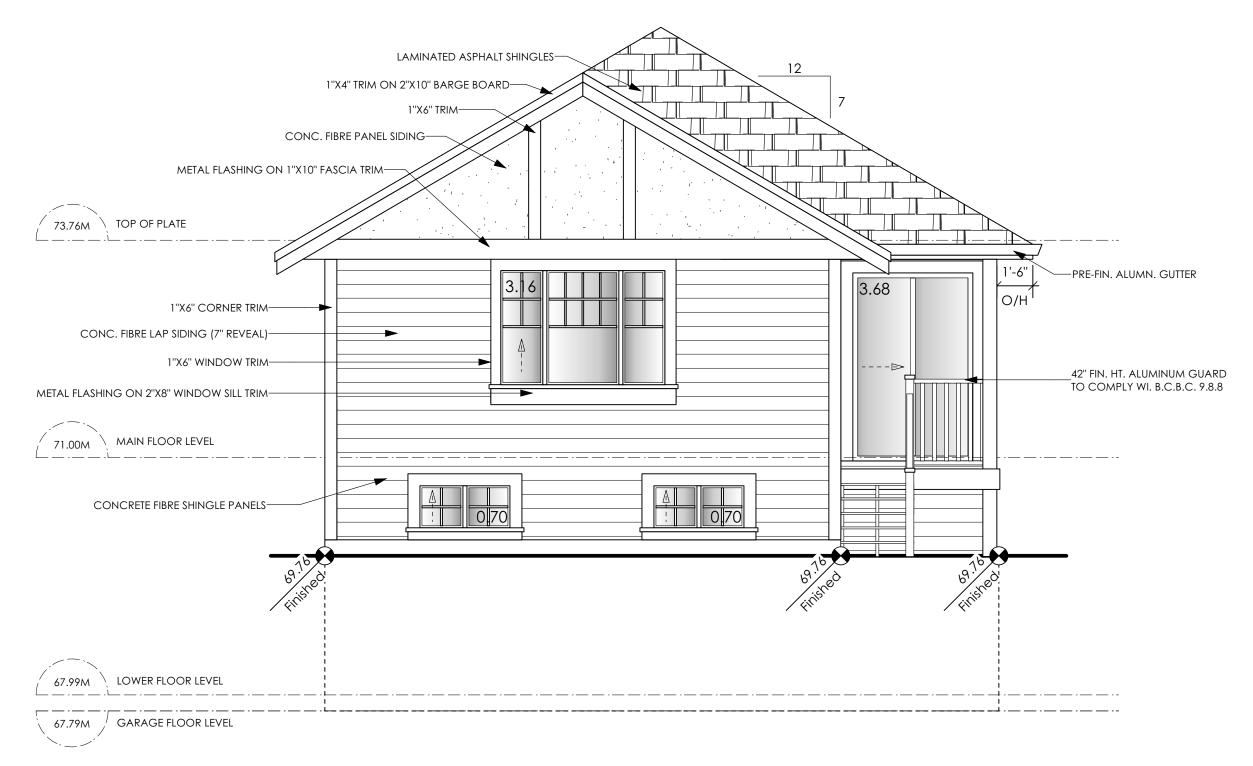

ALL RETAINING REQUIRED TO

MEET ALL GUIDELINE REQUIREMENTS

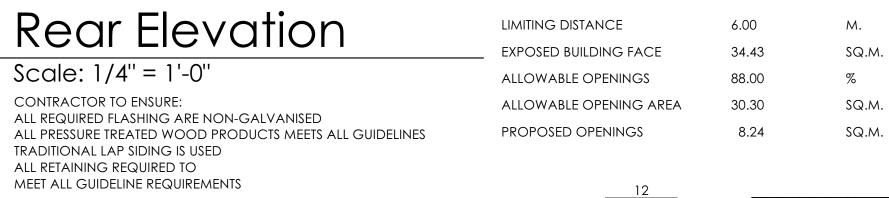

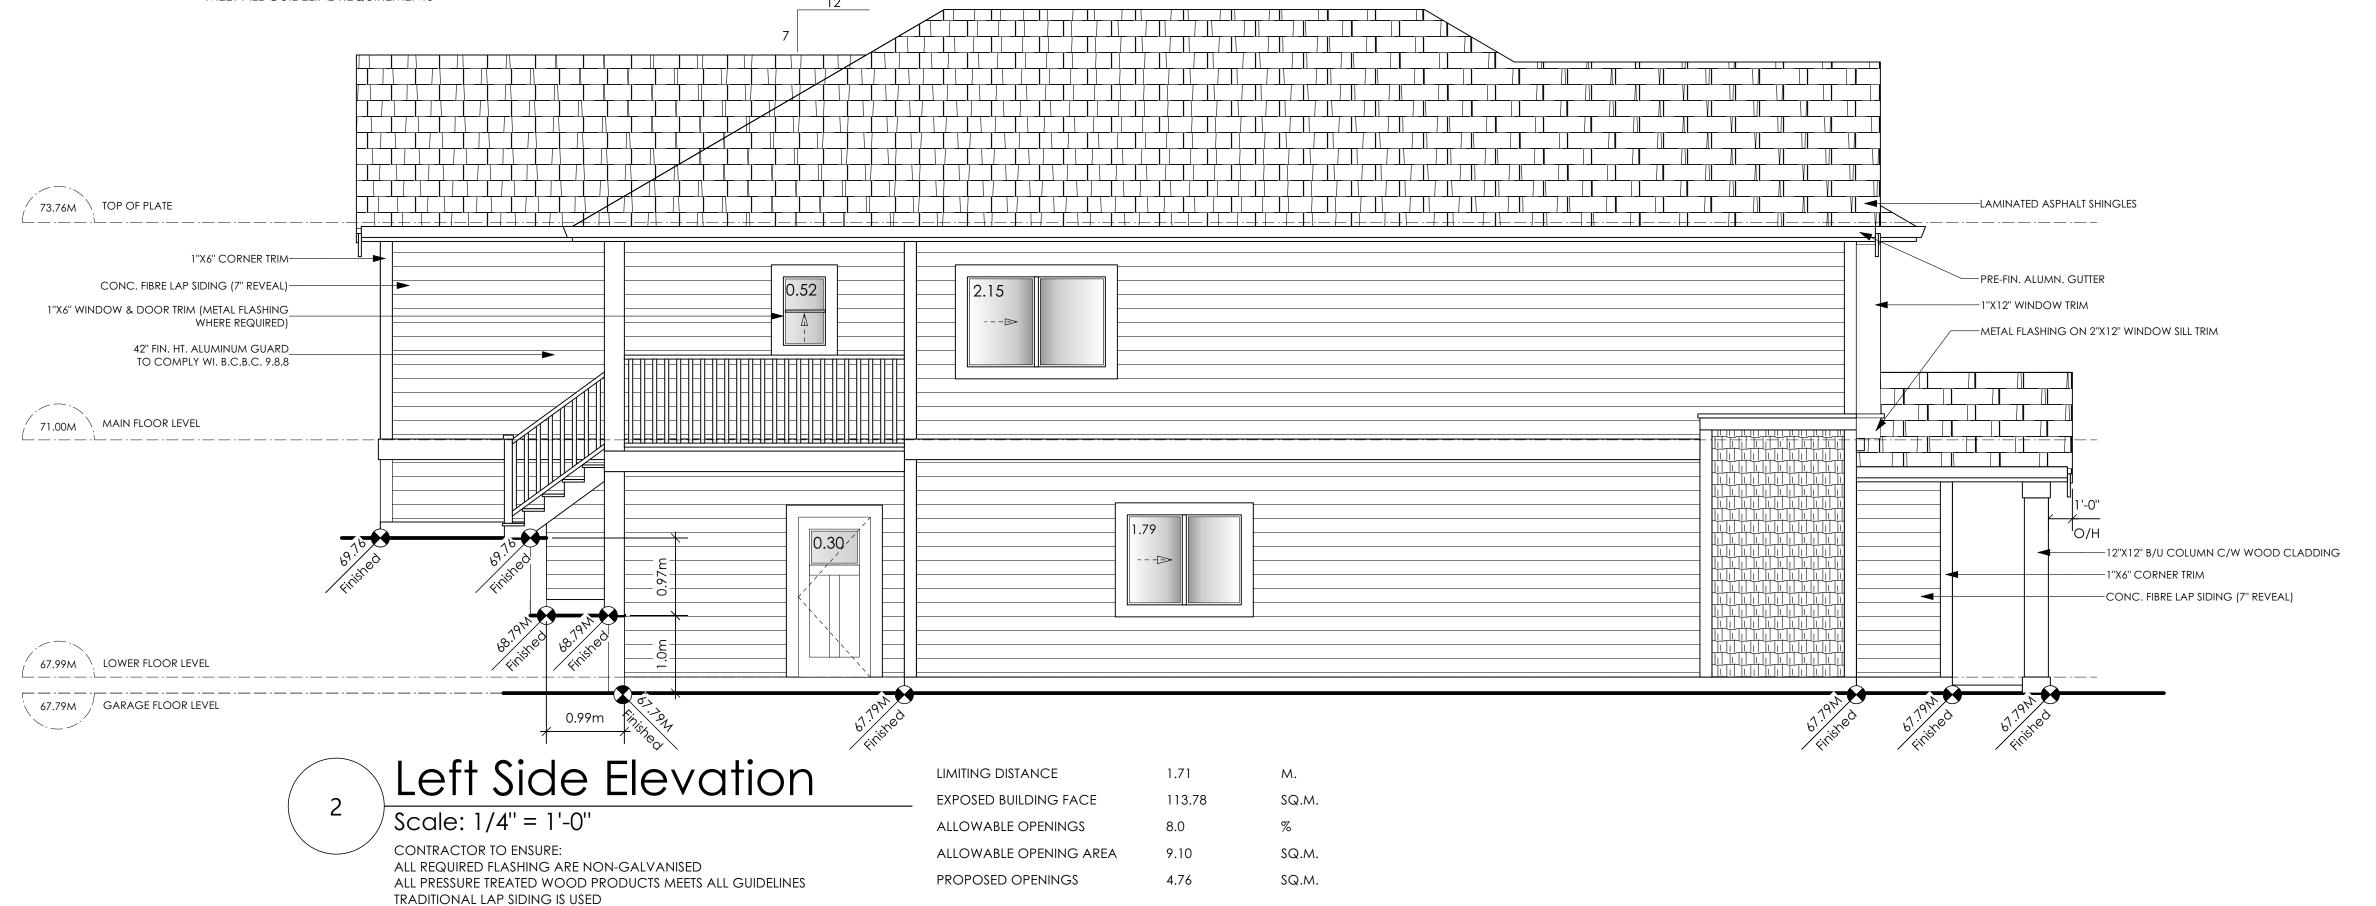

'PORT' - WEST COAST

Date

Feb 2, 2023


Project Address
3465 Trumpeter Street
Royal Bay - Sector 7
Colwood, B.C.

Prepared for Verity Construction

**Project #** 8298

**Scale**As Noted

Drawn By
MIS

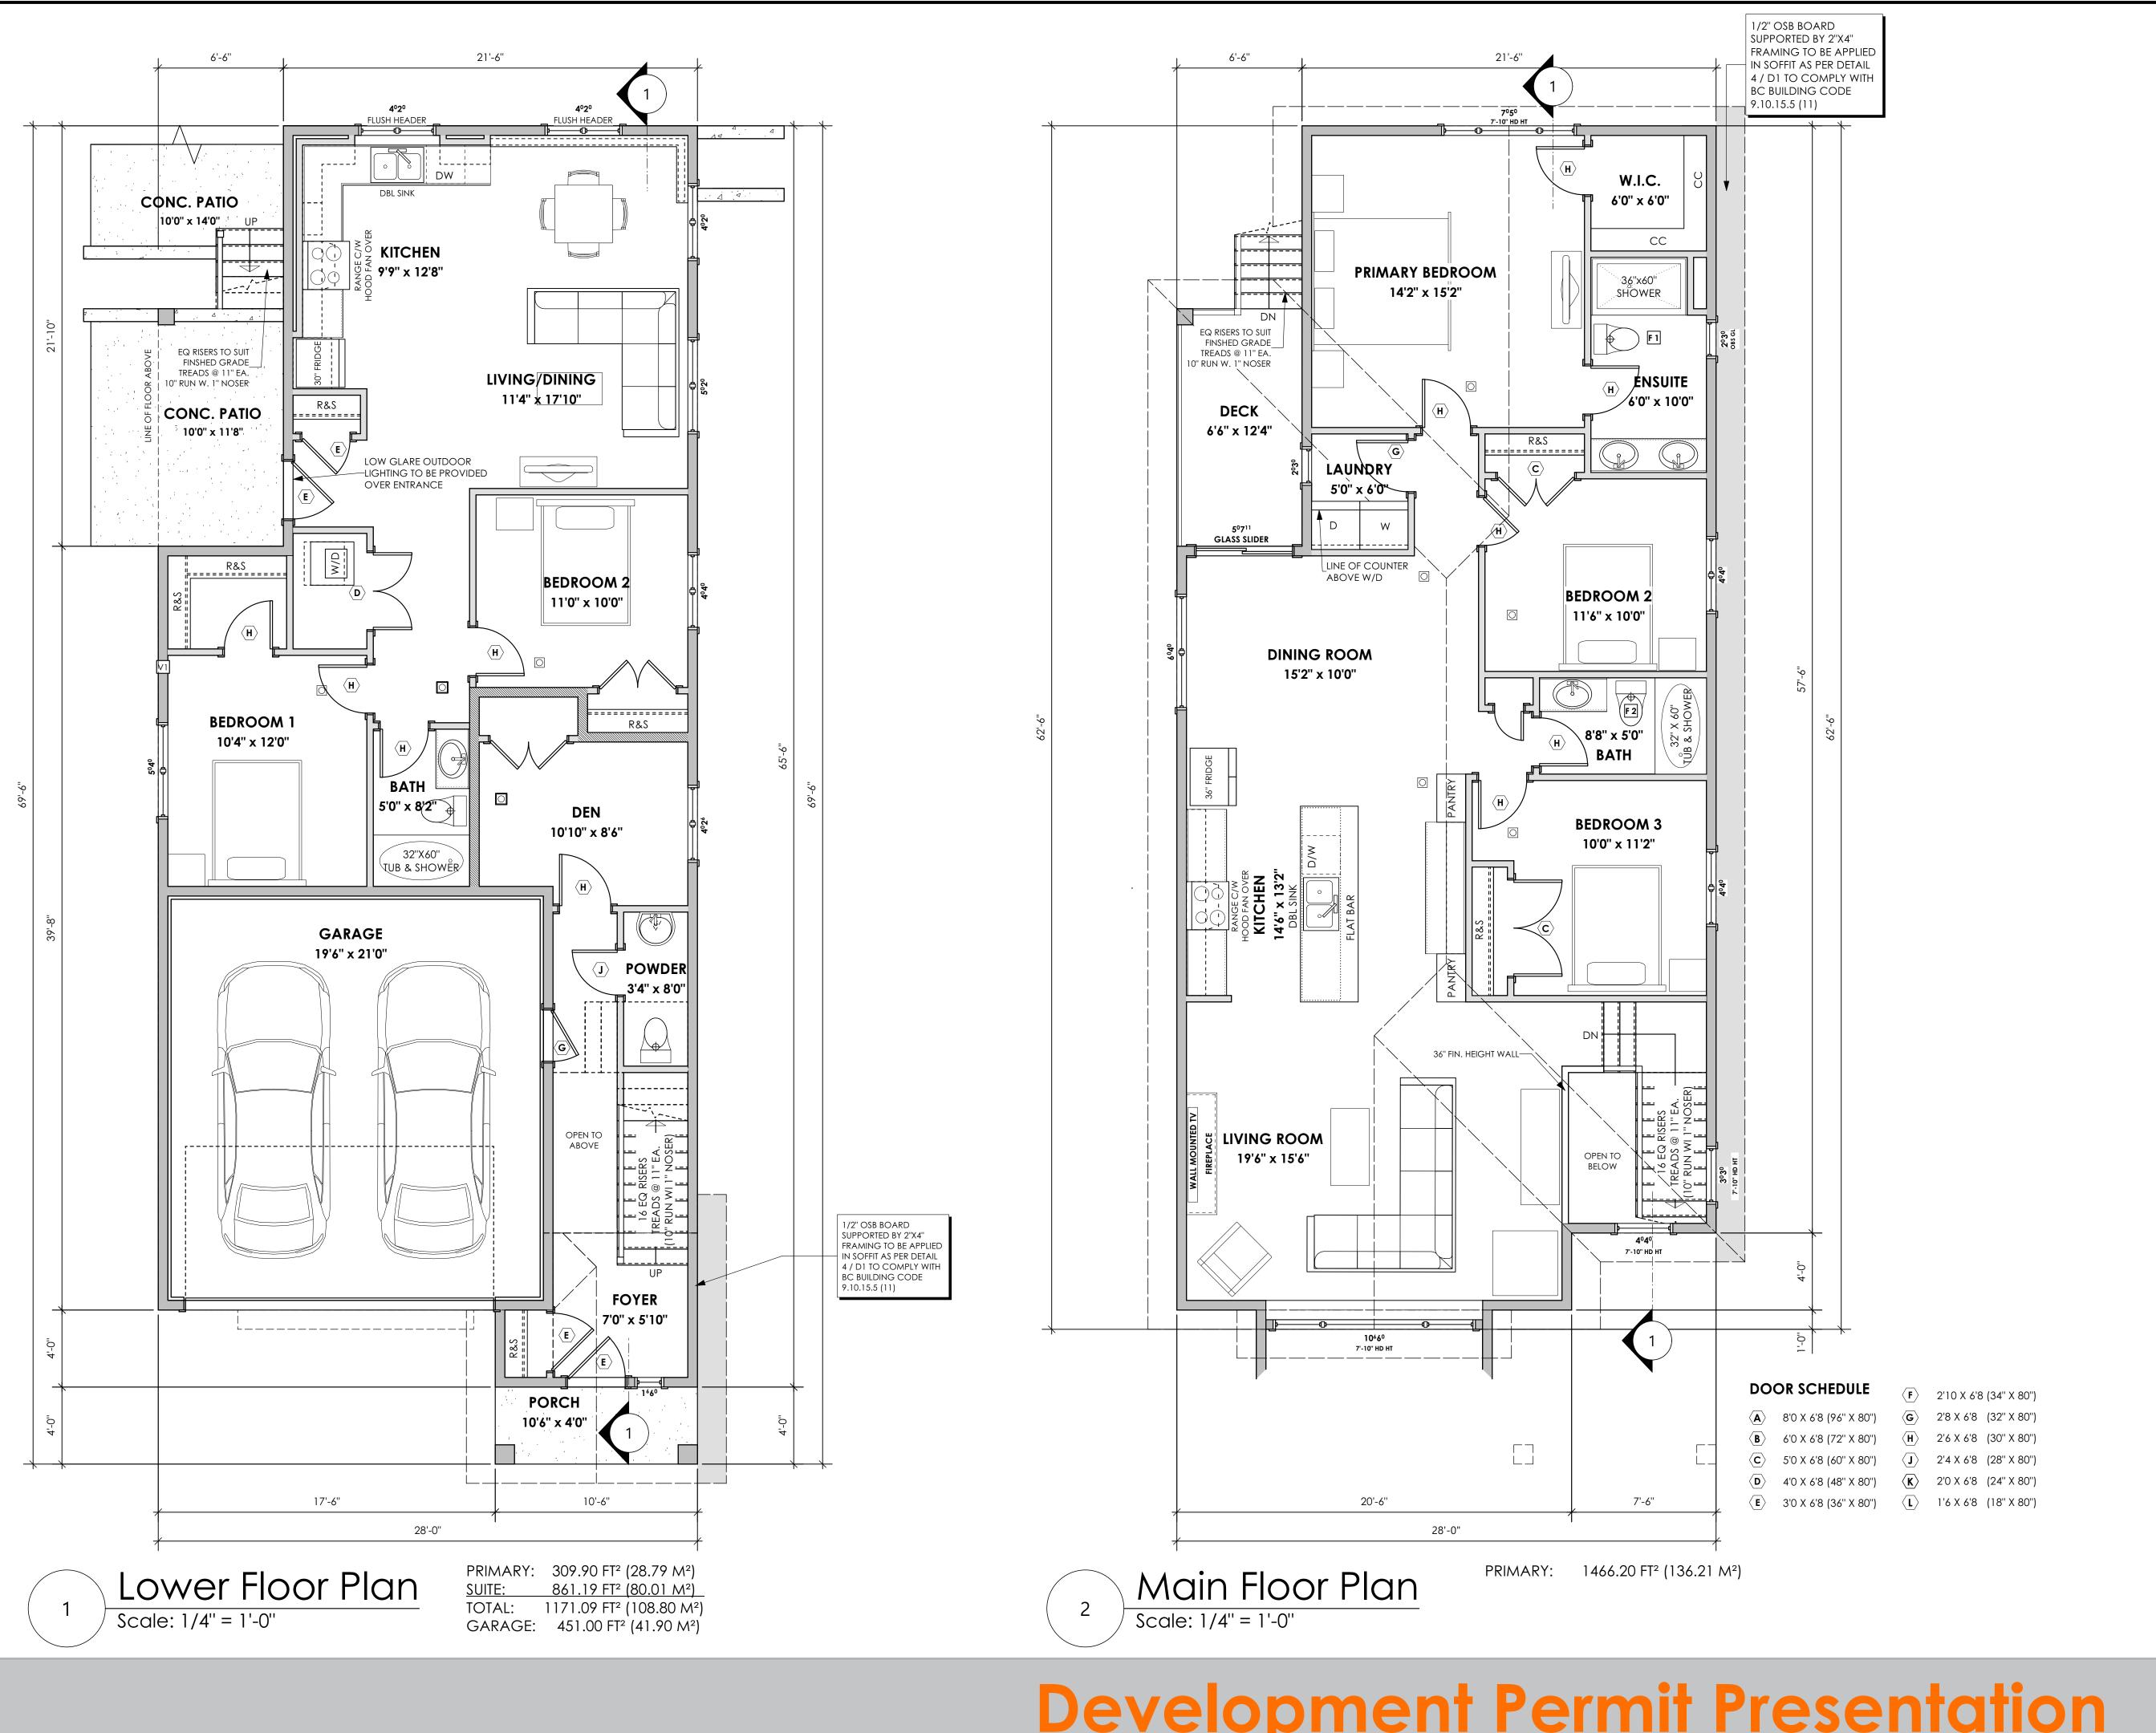

'PORT' - WEST COAST

Date

Feb 2, 2023

**Project Address** 

3465 Trumpeter Street Royal Bay - Sector 7 Colwood, B.C.

Prepared for Verity Construction

Project #


8298

Scale As Noted

Drawn By

MIS



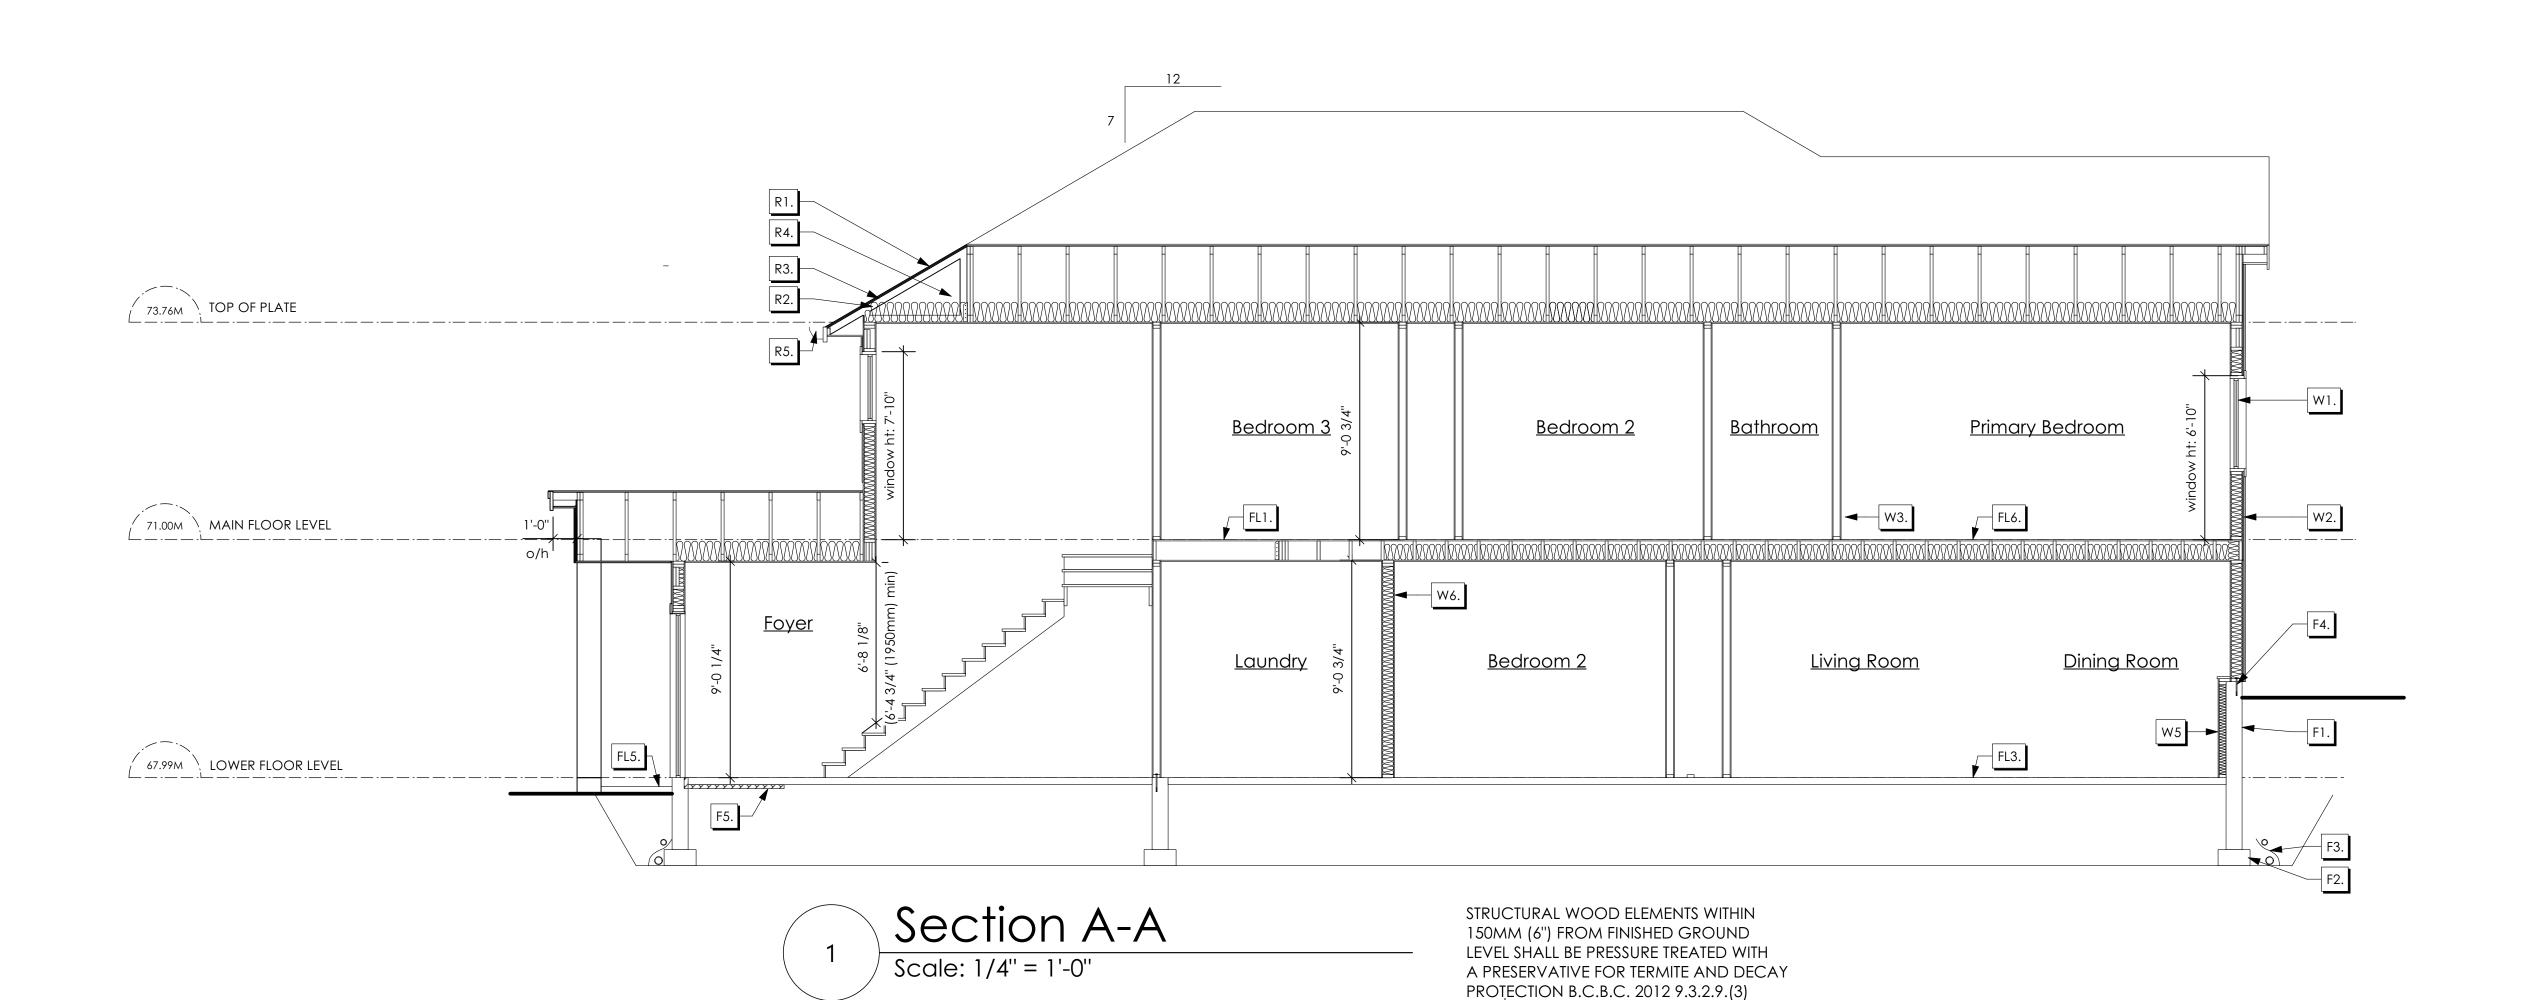

### Roofs

- R1. LAMINATED ASPHALT SHINGLES ON
  7/16" ORIENTED STRAND BOARD C/W "H" CLIPS
  WD TRUSSES (DESIGNED BY MANUF.)
  14 1/2" FIBRE GLASS LOOSE FILL INSULATION
  (ALLOW FOR SETTLING)
  OR R-40 FIBRE GLASS BATT INSULATION
  6 MIL POLY'N V.B.
  5/8" GYPSUM BOARD
- R2. PROVIDE 2 1/2" (63mm) CLEAR BETWEEN R-20 INSULATION AND SHEATHING. (min. R-20 @ roof-wall connection for 4'-0" (1.2m) around perimeter of building. air ventelation baffles to be installed where required in as per BCBC 9.19.)
- R3. EAVE PROTECTION

  CONT. UP ROOF SLOPE FOR 12"

  PAST EXTERIOR WALL.
- R4. PROVIDE 1 SQ.FT. ATTIC VENT PER
  300 SQ.FT. OF INSULATED AREA MIN.
  25% OF REQUIREDTO BE @ TOP AND BOTTOM
  (to comply wi. B.C. bldg. code 9.19.1)
- R5. PRE-FN. FASCIA GUTTER
  2×8 FASCIA BD.
  2×4 SUB. FASCIA BD.
  VENTED SOFFIT
  (see contractor)

- PRE MANUF SOFFIT

  1/2" OSB BOARD

  SUPPORTED BY 2"X4" FRAMING

  REFER TO DETAIL 4 / D1

  (to be applied in any soffit that has less then 1.20m clearance to any proverty line.

  To comply with BC BUILDING CODE

  9.10.15.5 (11) )

  (AS REQUIRED, VERIFY ON SITE)

  (NOT SHOWN IN SECTION)
- R1. 2 PLY S.B.S.MODIFIED BITUMEN FULLY
  ADHERED MEMBRANE
  (TO COMPLY WI. CGSB 37-GP-56M
  AND CGSB-37-6P-9MA)
  1/2" PLYWOOD SHEATHING
  SLOPED TAPERS TO PROVIDE MIN. 1:50 SLOPE ON
  2×4 WOOD STRAPPING @16" O/C
  2×10 DECK JOISTS @ 16" O.C.
  C/W R-28 F.G. BATT. INSULATION
  1/2" EXTRUDED POLYSTYRENE INSULATION
  6 MIL POLY'N V.B.
  1/2" GYPSUM BOARD
  (PROVIDE ADEQUATE MEMBRANE
  "UPSTAND" @ EXT. WALL.)
  (not in section)

# **Floors**

FL1. FINISHED FLOORING ON
19/32" ORIENTED STRAND BOARD OR EQUAL
(NAILED & GLUED TO FLOOR STRUCT. BELOW) ON
2×10 FLOOR JOISTS @ 16" OR 12" O/C
C/W 2×2 X-BRIDGING @ 7.0' O/C (MAX)
1/2" GYPSUM BOARD

SECTION NOTES

- FL2. FINISHED FLOORING ON
  19/32" ORIENTED STRAND BOARD OR EQUAL
  (NAILED & GLUED TO FLOOR STRUCT. BELOW) ON
  2×10 FLOOR JOISTS @ 16" OR 12" O/C
  C/W 2×2 X-BRIDGING @ 7.0' O/C (MAX)
  R-31 FIBRE GLASS BATT INSULATION
  5/8" X-TYPE GYPSUM BOARD
  (BETWEEN GARAGE AND LIVING SPACE)
  (NOT SHOWN IN SECTION)
- FL3. 3 1/2" CONCRETE SLAB 6 MIL. POLY'N V.B. 6" COMPACTED GRAVEL OR SAND
- FL4. 3 1/2" CONCRETE SLAB
  6 MIL. POLY'N V.B.
  6" COMPACTED GRAVEL OR SAND
  SLOPE TO DOORS 1"
  (NOT SHOWN IN SECTION)
- FL5. 3 1/2" CONCRETE SLAB
  (CONTRACTOR TO VERIFY EXTENT OF
  EXTERIOR SLABS AND FINISHES)
  (SLOPE AWAY FROM BUILDING @ 2% MIN.)
  6" COMPACTED GRAVEL OR SAND
- FL6. F8d RATED CEILING ASSEMBLY
  (BC BUILDING CODE TABLE 9.10.3.1.B)
  FINISHED FLOORING ON
  19/32" ORIENTED STRAND BOARD OR EQ.
  (FASTENED & GLUED TO FLOOR STRUCT. BELOW) ON
  2×10 FLOOR JOISTS @ 16" OR 12" O/C
  C/W 2×2 X-BRIDGING @ 7.0' O/C (MAX)
  R-31 INSULATION
  RESILIENT METAL CHANNELS @ 24" O/C
  1 LAYERS 5/8" X-TYPE GYPSUM BOARD
  30 MINUTE F.R.R., 50 S.T.C.

## Walls

- W1. DOUBLE GLAZING
  ENERGY STAR LOW "E" RATING IN
  THERMAL BREAK FRAMES
  2/2"X10" LINTEL OVER (@ BEARING WALLS ONLY)
  (TYPICAL, WI. 2 1/2" XPS INSULATION)
  FLASHING OVER @ EXTERIOR
  (GLAZING IN ALL EXTERIOR DOORS & WITHIN 3 FT.
  OF EXTERIOR DOORS TO BE SHATTERPROOF (SP))
  WINDOW REQUIREMENTS DERIVED FROM BCBC
  TABLE C-5 AS PER BCBC 9.7.4.3. AND ARE TO BE
  USED TO SATISFY THE REQUIREMENTS OF
  AAMA/WDMA/CSA 101/I.S.2/A440, "NAFS":
  COLWOOD, CLASS R, DP 1440, PG 30, WATER RESIST. 220, A2,
  RATINGS MUST BE CLEARLY LABELED ON ALL
  WINDOW UNITS UPON INSTALLATION FOR INSPECTION.
- W2. CONC. FIBRE BOARD ON
  9.5MM (3/8") AIR SPACE / STRAPPING
  3/8"×2" BORATE TREATED PLYWOOD STRAPPING
  HOUSE WRAP (A.B.) (TYVEK OR EQ.)
  7/16" ORIENTED STRAND BOARD SHEATHING
  2×6 STUDS (SEE APCING BELOW)
  R-20 INSULATION
  6 MIL. POLYETHYLENE VAPOUR BARRIER
  1/2" GYPSUM BOARD
  (REFER TO DETAILS ON D1)
- W3. INTERIOR PARTITION
  1/2" GYPSUM BOARD ON EACH SIDE
  OF 2×4 STUDS (SEE SPACING BELOW) OR
  2×6 STUDS (SEE SPACING BELOW) (IF NOTED)

# W4. 5/8" X-TYPE GYPSUM BOARD ON 2×6 STUDS (SEE SPACING BELOW) R-20 INSULATION 6 MIL. POLY'N V.B

- 6 MIL. POLY'N V.B
  1/2" GYPSUM BOARD
  (BETWEEN GARAGE & LIVING)
  (NOT SHOWN IN SECTION)

  W5. 1/2" GYPSUM BOARD ON
- 6 MIL. POLY'N V.B.

  2×4 STUDS (SEE SPACING BELOW)

  OR 2x6 STUDS (SEE SPACING BELOW) (IF NOTED)

  R-12 BATT INSULATION

  HOUSE WRAP (A.B.) (TYVEK OR EQ.) OR

  12.7MM (1/2") AIR SPACE

  (PROVIDE REQUIRED FIRE STOPS IN WALL

  ASSEMBLIES TO COMPLY WITH

  B.C. BLDG. CODE 9.10.16.)

W6. B.C. BUILDING CODE (TABLE 9.10.3.1.A)

- RATED WALL ASSEMBLY W3C

  1 LAYER 1/2" X-TYPE GYPSUM BOARD
  RESILIENT METAL CHANNELS @ 24" O/C
  2×4 STUDS @ 16" O/C OR
  2×6 STUDS @ 16" O/C (IF NOTED) C/W
  3 1/2" FIBRE GLASS SOUND BATTS
  1 LAYER 1/2" X-TYPE GYPSUM BOARD
  45 MIN. F.R.R 43 S.T.C
  (BETWEEM PRIMARY LIVING & SECONDARY SUITE)
- W7. STUD SPACING

   UPPER FLOOR: 2"X6" @ 24" O/C

   MAIN FLOOR: 2"X6" @ 24" O/C

   LOWER FLOOR: 2"X6" @ 16" O/C

  (if applicable)

   INTERIOR PARTITION: 2"X4"" @ 24" O/C

   LOAD BEARING: 2"X4"" @ 16" O/C

   PARTY WALL 2"X4"" @ 24" O/C

(if applicable)

# **Foundation Walls**

- F1. DAMPROOFING (where required) ON 8" THK. CONC. FOUNDATION WALL C/W 15 M BARS @ 24" o/c B/W
- F2. 16"X 8" CONC. FOOTINGS

  C/W 2 (TWO) 15m BARS CONT. 3 IN. FROM BOTT.

  ON UNDISTURBED SOIL (SOLID BEARING)
  - 3. 4" PERIMETER DRAIN
    3" TIGHT PIPE FOR RWL
    DRAIN ROCK
- F4. ANCHOR BOLTS @ 4.0 FT. o/c MAX c/w SILL GASKETS
- F5. UNDER SLAB INSULATION
  2 1/2" (RSI 2.15) EXTRUDED POLYSTYRENE
  RIGID INSULATION 4'-0" (1.2M)
  CONT. AROUND PERIMETER UNDER
  SLAB INSTALLED HORIZONTALLY
  (VERIFY WITH MUNICIPALITY DEPTH OF FROST LINE)

'PORT' - WEST COAST

Date

Feb 2, 2023

Project Address
3465 Trumpeter Street
Royal Bay - Sector 7

Colwood, B.C.

Prepared for Verity Construction

Project #

027

**Scale**As Noted


Drawn By
MIS

### ALL FENCING, RETAINING AND LANDSCAPING MUST MEET THE **GUIDELINE REQUIREMENTS**

ALL RETAINING WALLS ARE TO BE STAND ALONE STRUCTURES (THEY MUST TERMINATE AT PROPERTY LINE) AND MUST NOT CONNECT TO RETAINING WALLS LOCATED ON ADJACENT PRIVATE PROPERTIES

NORTH


\*NOTE: In the interest of maintaining high standards, the developer reserves the right to modify plans. specifications and design without prior notice. Drawings contained within are artist renderings only. Sizes and dimensions are approximate and may vary with actual plan and survey. Exterior style may change pending municipal approval. Retaining wall location and types may vary and are subject to municipal, engineering or developer discretion. Subject to change without notice. Furniture as shown on plans are for layout purposes only and are not included in the sale.

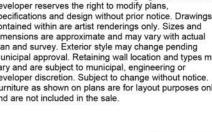


	ITEM	AREA (sf)	%
88	GARDEN BED	228	10%
100	GRAVEL	497	22%
	CONCRETE	830	36%
	SOD	718	32%
	TOTAL	2,273	100%




### **KEY PLAN** NOT TO SCALE

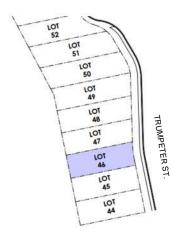

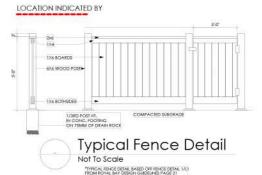

ADDITIONAL NOTES: PROPERTY TO BE IRRIGATED 6" PIPE FOR DRIVEWAY SLEEVES TO BE INSTALLED FOR CITY IRRIGATION LINES

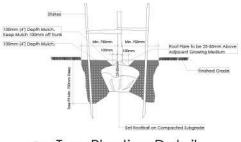

Tree Planting Detail All trees and plants by the home owner to be

### LANDSCAPE PLAN NOT TO SCALE

	MM/DD/YY	ISSUED/REVISED
01	09/30/22	FOR APPROVAL
02	10/07/22	GARDEN BED PLANTING
03	12/23/22	REVISION AS PER CITY OF COLWOOD

ESTIMATED LOCATION OF REAR FENCING - SUBJECT
TO CHANGE ACCORDING TO
ACTUAL SITE CONDITIONS

LOT 46

PROPOSED RESIDENCE

**PROJECT** 

DATE

PRIVACY SHRUBBERY PLANTS AND FOLIAGE

TO SCREEN PARKING AND PROPERTY

2 GAL / 5 GAL

LANDSCAPING PLAN LOT 46, 3465 TRUMPETER ST. **ROYAL BAY, SECTOR 7** CITY OF COLWOOD

•80 60 €0 €0 €0

PRIVACY SHRUBBERY

PLANTS AND FOLIAGE TO SCREEN PARKING




QUALITY CONSTRUCTION. TRUSTED SERVICE.

106 - 1039 Langford Parkway Victoria, B.C. V9B 0A6

P: 250.474.1039 www.verityconstruction.ca



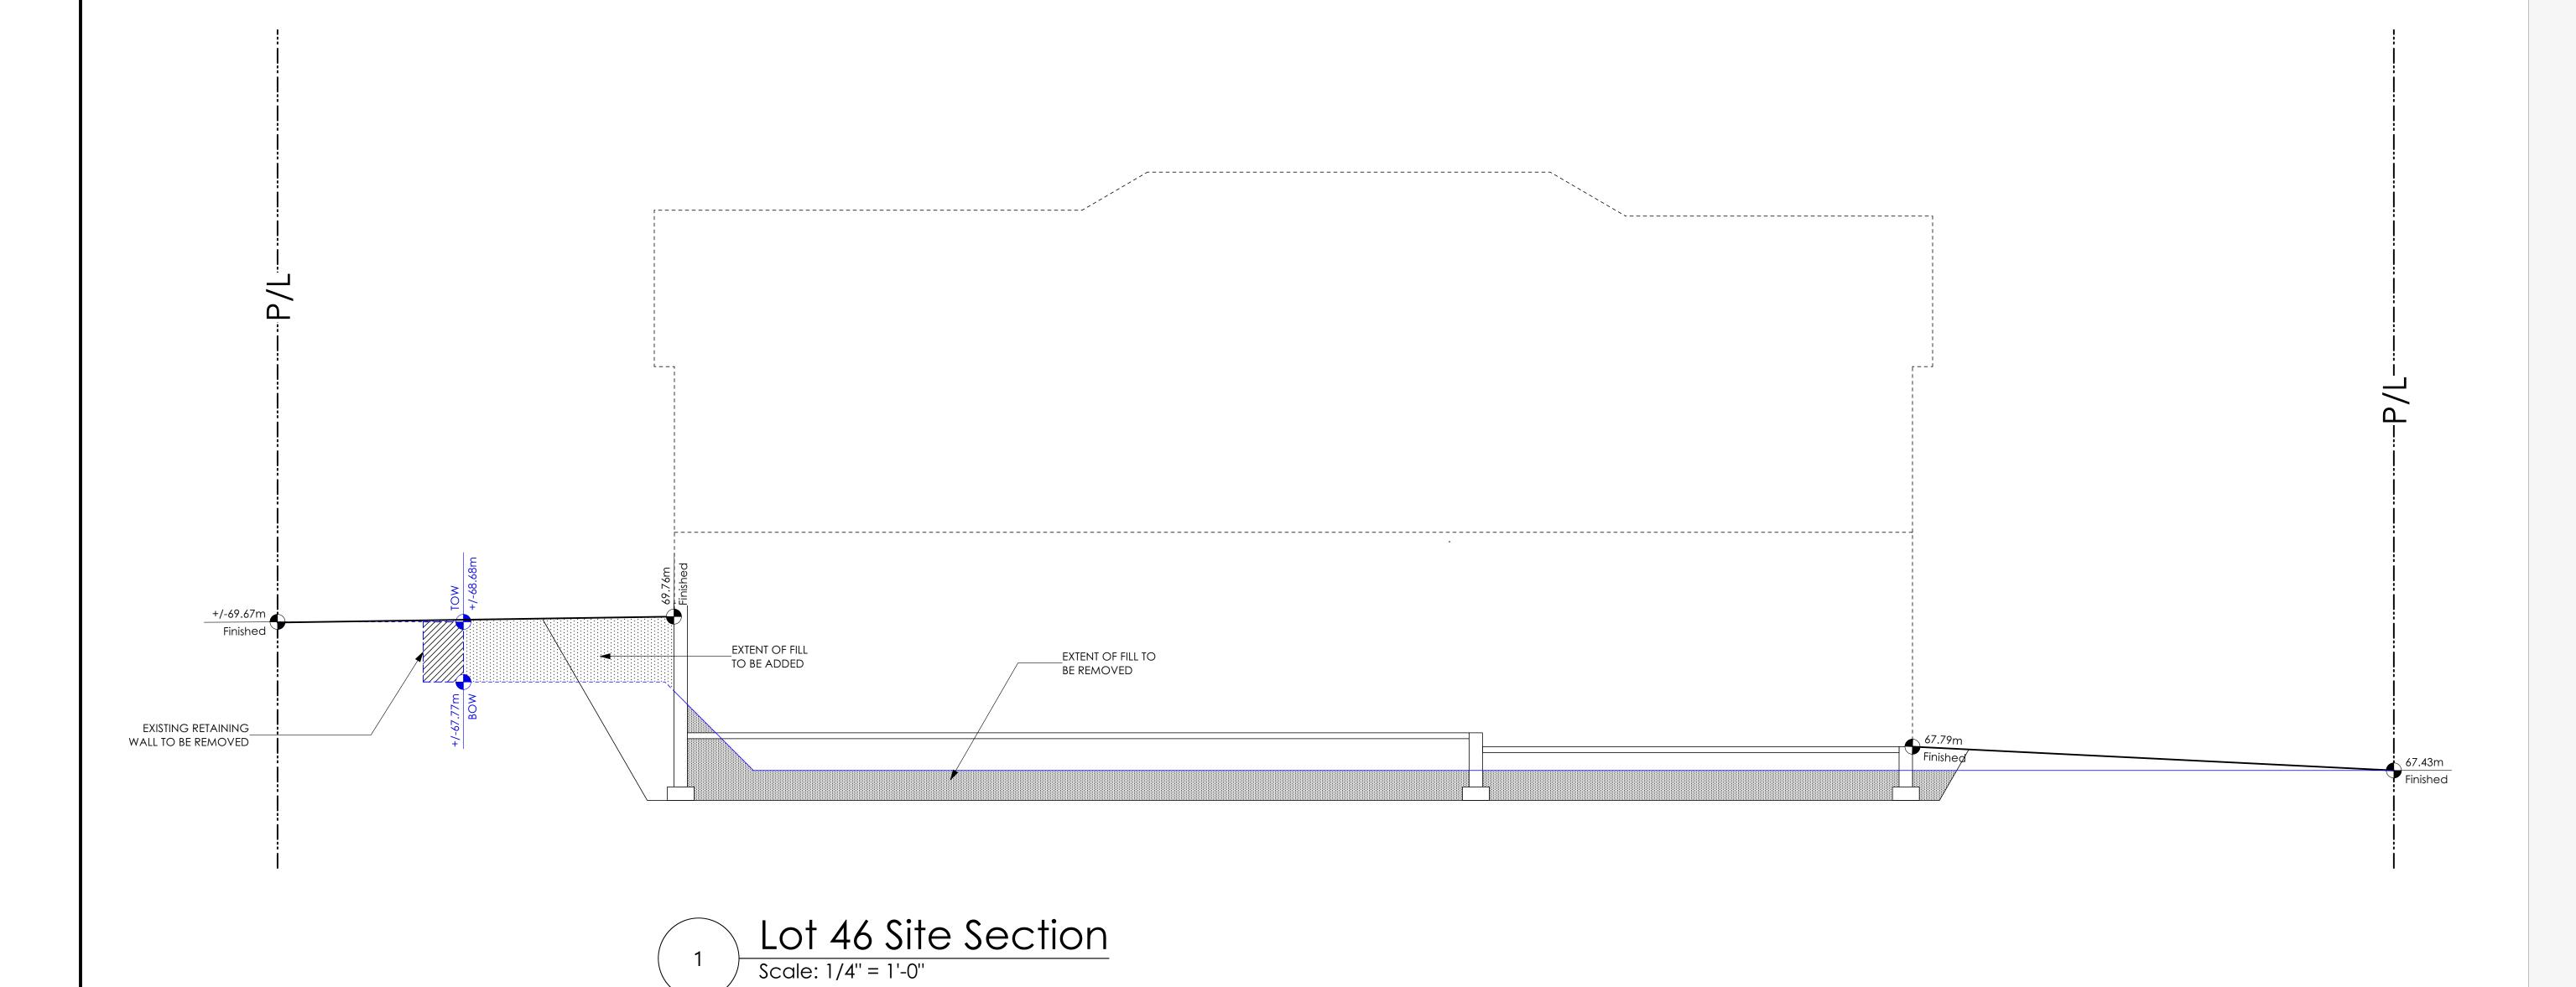

'PORT' - WEST COAST

Date

Feb 2, 2023

**Project Address** 

3465 Trumpeter Street Royal Bay - Sector 7 Colwood, B.C.

Prepared for Verity Construction

Project #

8298


**Scale**As Noted

Drawn By
MIS

## GABLECTART HOMES BUILDING GRADE SLIP

WSP	Project	No:	201-08151-00
	,		

	Issue Date:
MUNICIPAL ADDRESS 3465 Trumpeter Street	P.I.D.
LOT 46	PLAN
BUILDER VERITY HOMES	SUBDIVISION
ADDRESS	ROYAL BAY SECTOR 7  DEVELOPER
REPRESENTATIVE PH.	MEADOWS DEVELOPMENT LP  CONSULTANT
PROPOSED BUILDING GRADES	WSP CANADA INC PLAN
ALL ELEVATIONS ARE METRIC GEODETIC +	LOT:46 PLAN:
MAIN FLOOR ELEVATION 71.00 (TOP OF JOISTS)	TRUMPETER ST.
FRONT ELEV. 67.79 REAR ELEV. 69.76	
(FINISHED GRADE) (FINISHED GRADE)  FINISHED GRADE AT GARAGE 67.79	
	(67.43) (8) (8) (8) (8) (8) (8) (8) (8) (8) (8
HEADROOM	
	66.9 LG 66.9 LT 179.
ACTUAL TOP OF FOOTING	MFE   68.04   GFE   67.84
LOWEST PERMITTED TOP OF not provided FLOOR SLAB FOOTING ELEVATION (LTF) (BOTTOM OF BASEMENT SLAB	MSE 64.67 S 64.17 D 64.26 BF
FROST WALLS ARE REQUIRED.)	(S) (O)
SERVICES FRONT REAR CENTER REFER SIZE TO PLAN (mm)	* ************************************
WATER	(B67.77) (B67.84)
SANITARY 🔲 🔲 <u>100</u>	77 (768.66)
STORM	69.6
COMMENTS	RETAINING WALL
COMMENTS YES NO DRAIN TO SUMP PUMP LIKELY REQUIRED	
(FOR BASEMENT IF INSTALLED)	LEGEND
SEWER TO SUMP PUMP LIKELY REQUIRED (FOR BASEMENT IF INSTALLED)	STREET
SERVICES INSTALLED TO m INSIDE PROPERTY	
FOUNDATION SOIL BEARING INVESTIGATION CERTIFICATION REQUIRED	SROW (SHOWN ON ABOVE PLAN)
GEOTECHNICAL RESTRICTIONS APPLY (SEE GEOTECHNICAL REPORT)	PROPOSED FRONT CORNER ELEVATIONS  PROPOSED FRONT SIDE YARD GRADES  L# 6  L# 6  L# 6  L# 6
ENVIRONMENTAL RESTRICTIONS APPLY	L# 6 L# 6 LEGAL LOT NUMBER
(SEE ENVIRONMENTAL REPORT)	$\begin{bmatrix} \frac{1}{2} \\ \frac{1}{2} \end{bmatrix}$ EG 49.90 $\begin{bmatrix} \frac{1}{2} \\ \frac{1}{2} \end{bmatrix}$ — EXISTING GROUND ELEVATION
UTILITY EASEMENTS AFFECT THIS LOT	LFE/MFE 47.70 - LOWER/MAIN FLOOR ELEVATION GFE 47.55 - GARAGE FLOOR ELEVATION
	MSE 52.20 - MINIMUM SANITARY SERVICABLE ELEVATION BY GRAVITY
	S 49.12 (P) D 49.12 (P) SAN SERVICE INV. (P) DENOTES PUMP IS LIKELY REQUIRED
	FOR BASEMENT IF INSTALLED  FOR BASEMENT IF INSTALLED  STORM SERVICE INV.
	(P) DENOTES PUMP IS LIKELY REQUIRED FOR BASEMENT IF INSTALLED  PROPOSED REAR SIDE YARD GRADES
	[3] L
NOTES	- LOT TYPE (L/LB/LBT)
1. IT IS THE RESPONSIBILITY OF THE BUILDER TO ENSURE THE FOOTINGS ARE PLACED ON A PROPER BASE THAT IS FREE FROM FROST, EXCESSIVE MOISTURE AND DELETERIOUS MATERIALS AND HAVE APPROPRIATE FROST PROTECTION WHEN COMPLETED.	LANE/LOT
2. THE INFORMATION CONTAINED HEREIN IS BASED ON THE APPROVED LOT GRADING PLAN FOR THIS SUBDIVISION. UN—AUTHORIZED DEVIATIONS WILL BE THE RESPONSIBILITY OF THE BUILDER TO ENSURE COMPLIANCE WITH ALL LOCAL BYLAWS.	I, THE BUILDER'S REPRESENTATIVE, CERTIFY THAT THE FINAL HOUSE PLANS PROVIDED IN THE BUILDING PERMIT
3. OTHER NOTES:	APPLICATION ARE THE SAME AS PROCESSED UNDER THIS GRADE SLIP AND THAT I UNDERSTAND THE INFORMATION AND THE REQUIREMENTS CONTAINED HEREIN AND WILL BUILD ACCORDINGLY.
	AUTHORIZED BUILDER'S REPRESENTATIVE DATE
	THE INFORMATION CONTAINED HEREIN IS BASED ON THE APPROVED

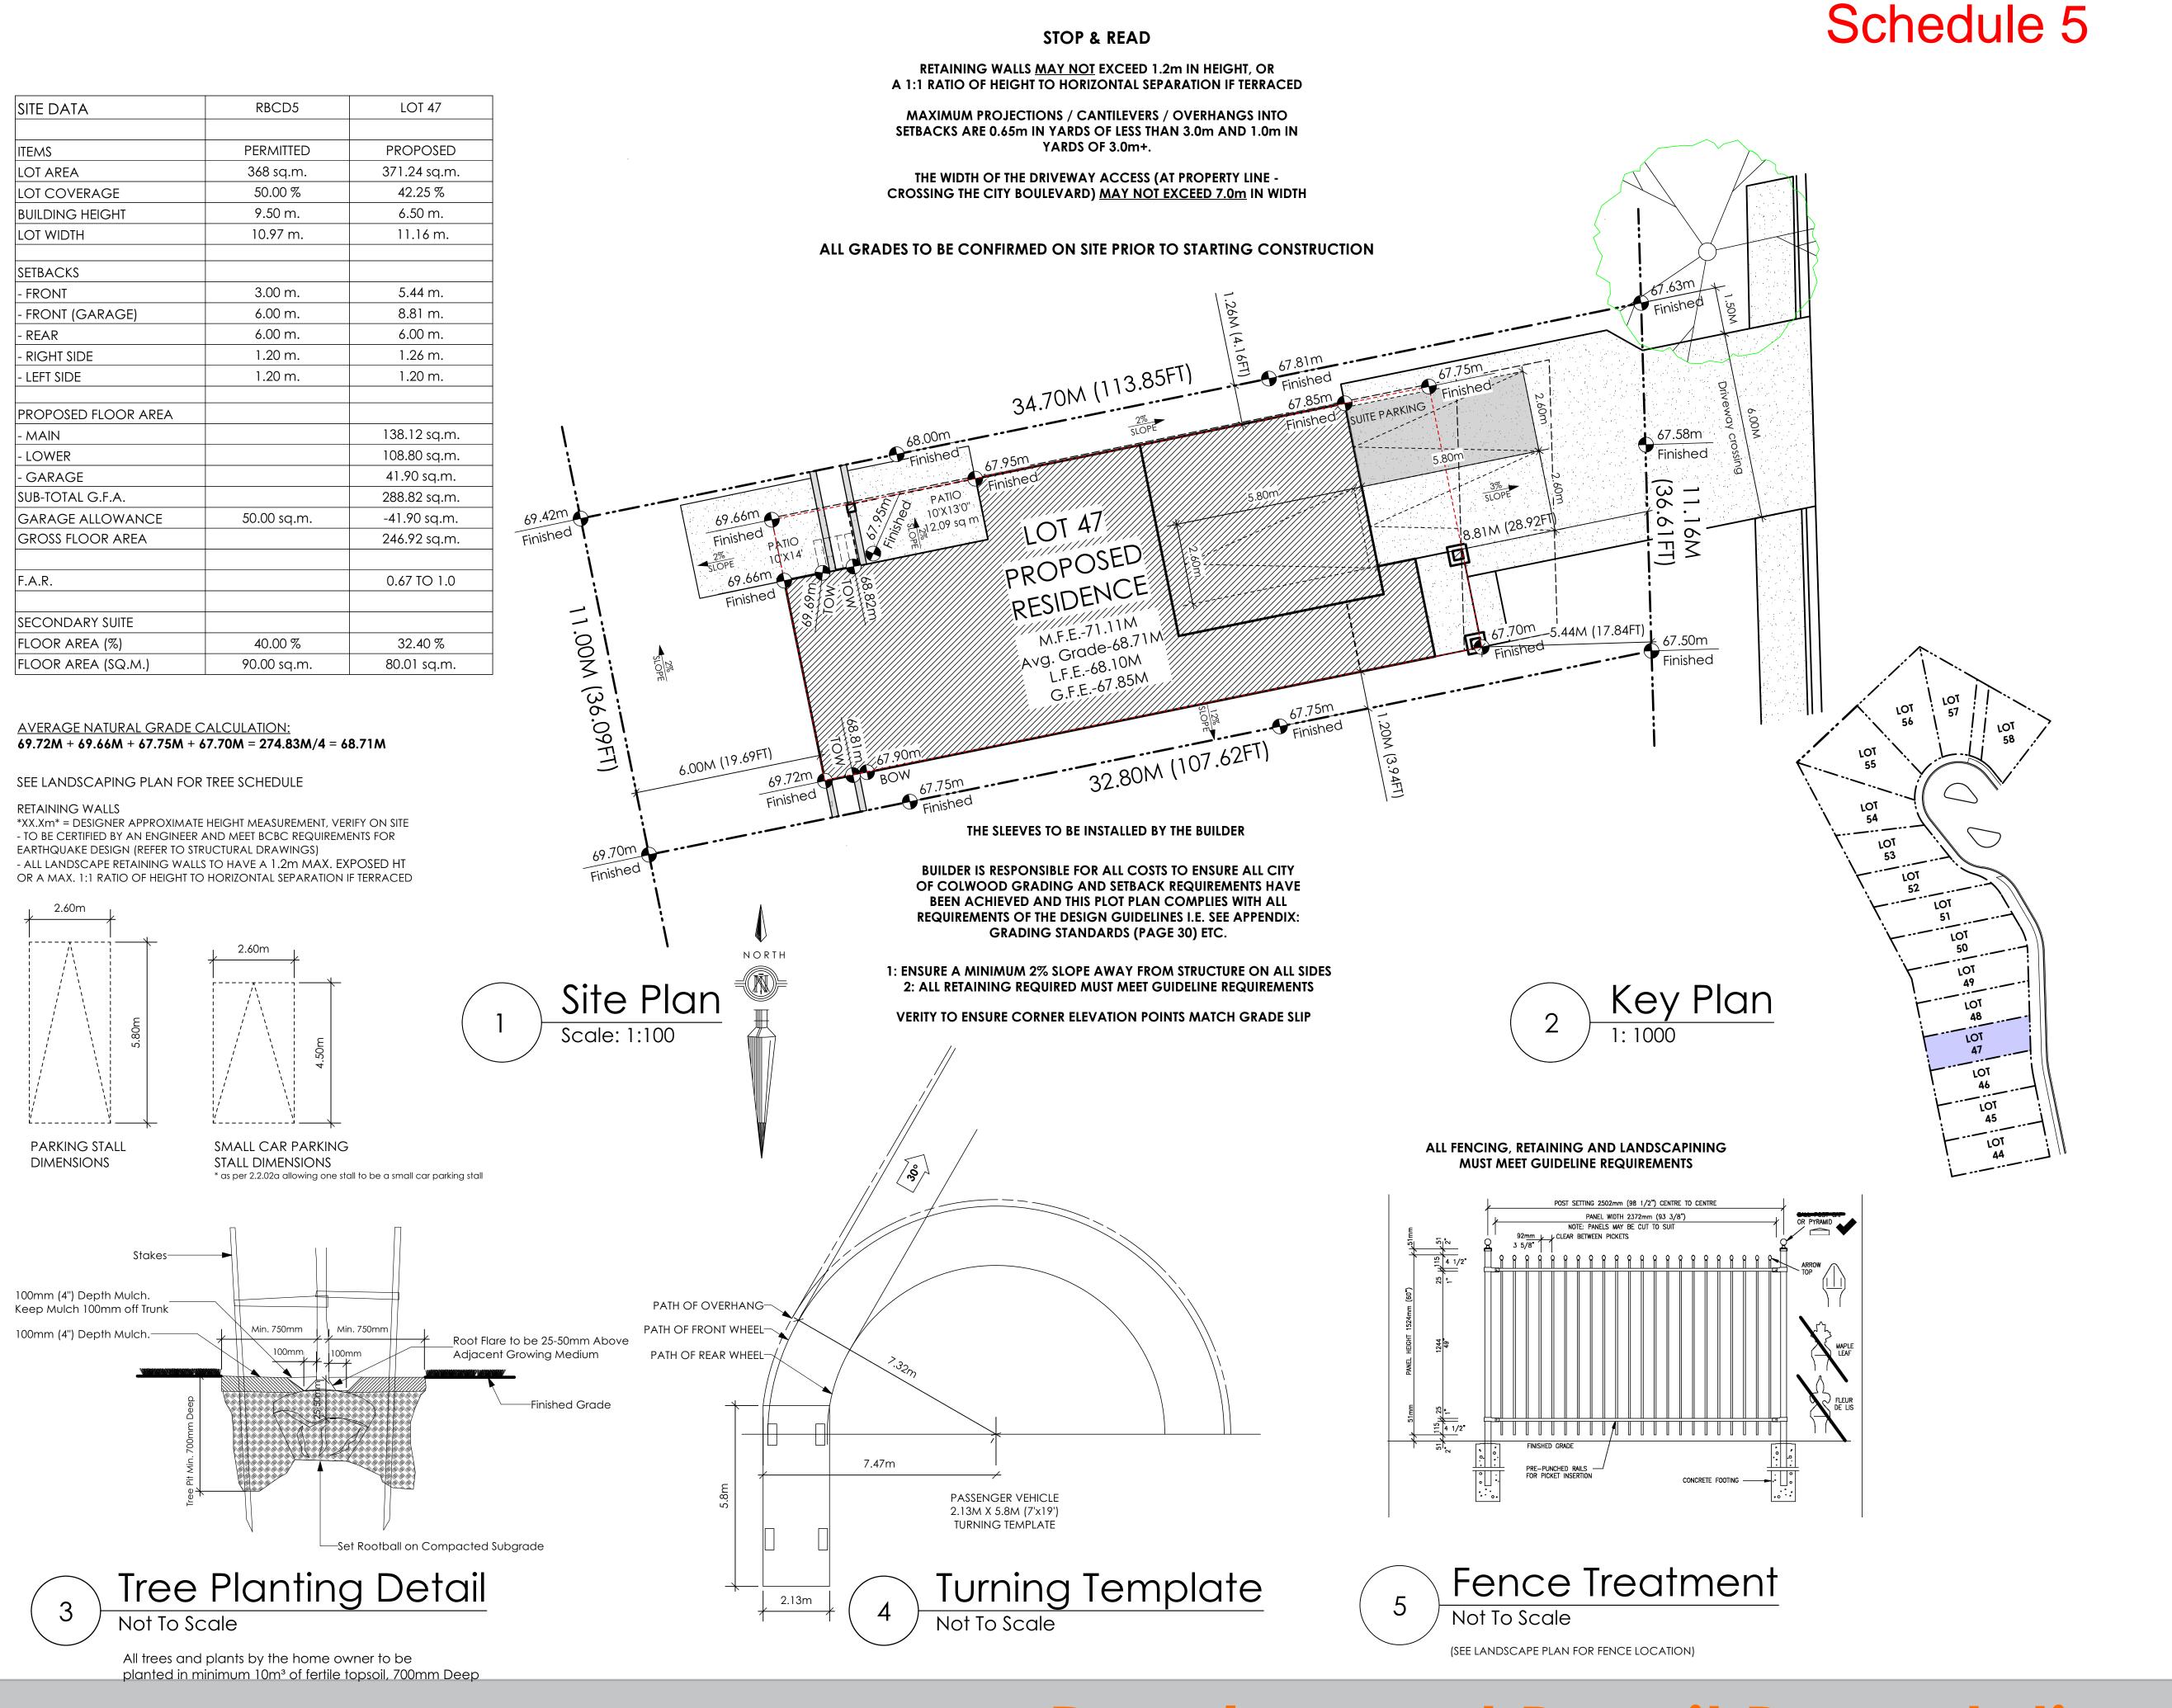

Vol Victoria design group

#103 - 891 ATTREE AVENUE VICTORIA, B.C. V9B 0A6 P. 250.382.7374 F. 250.382.7364

'PORT' - TRADITIONAL

Date

Dec 19 2022

#### **Project Address**

3467 Trumpeter Street Royal Bay - Sector 7 Colwood, B.C.

# Prepared for


Verity Construction


Project #

8298

**Scale**As Noted


Drawn By
MRB

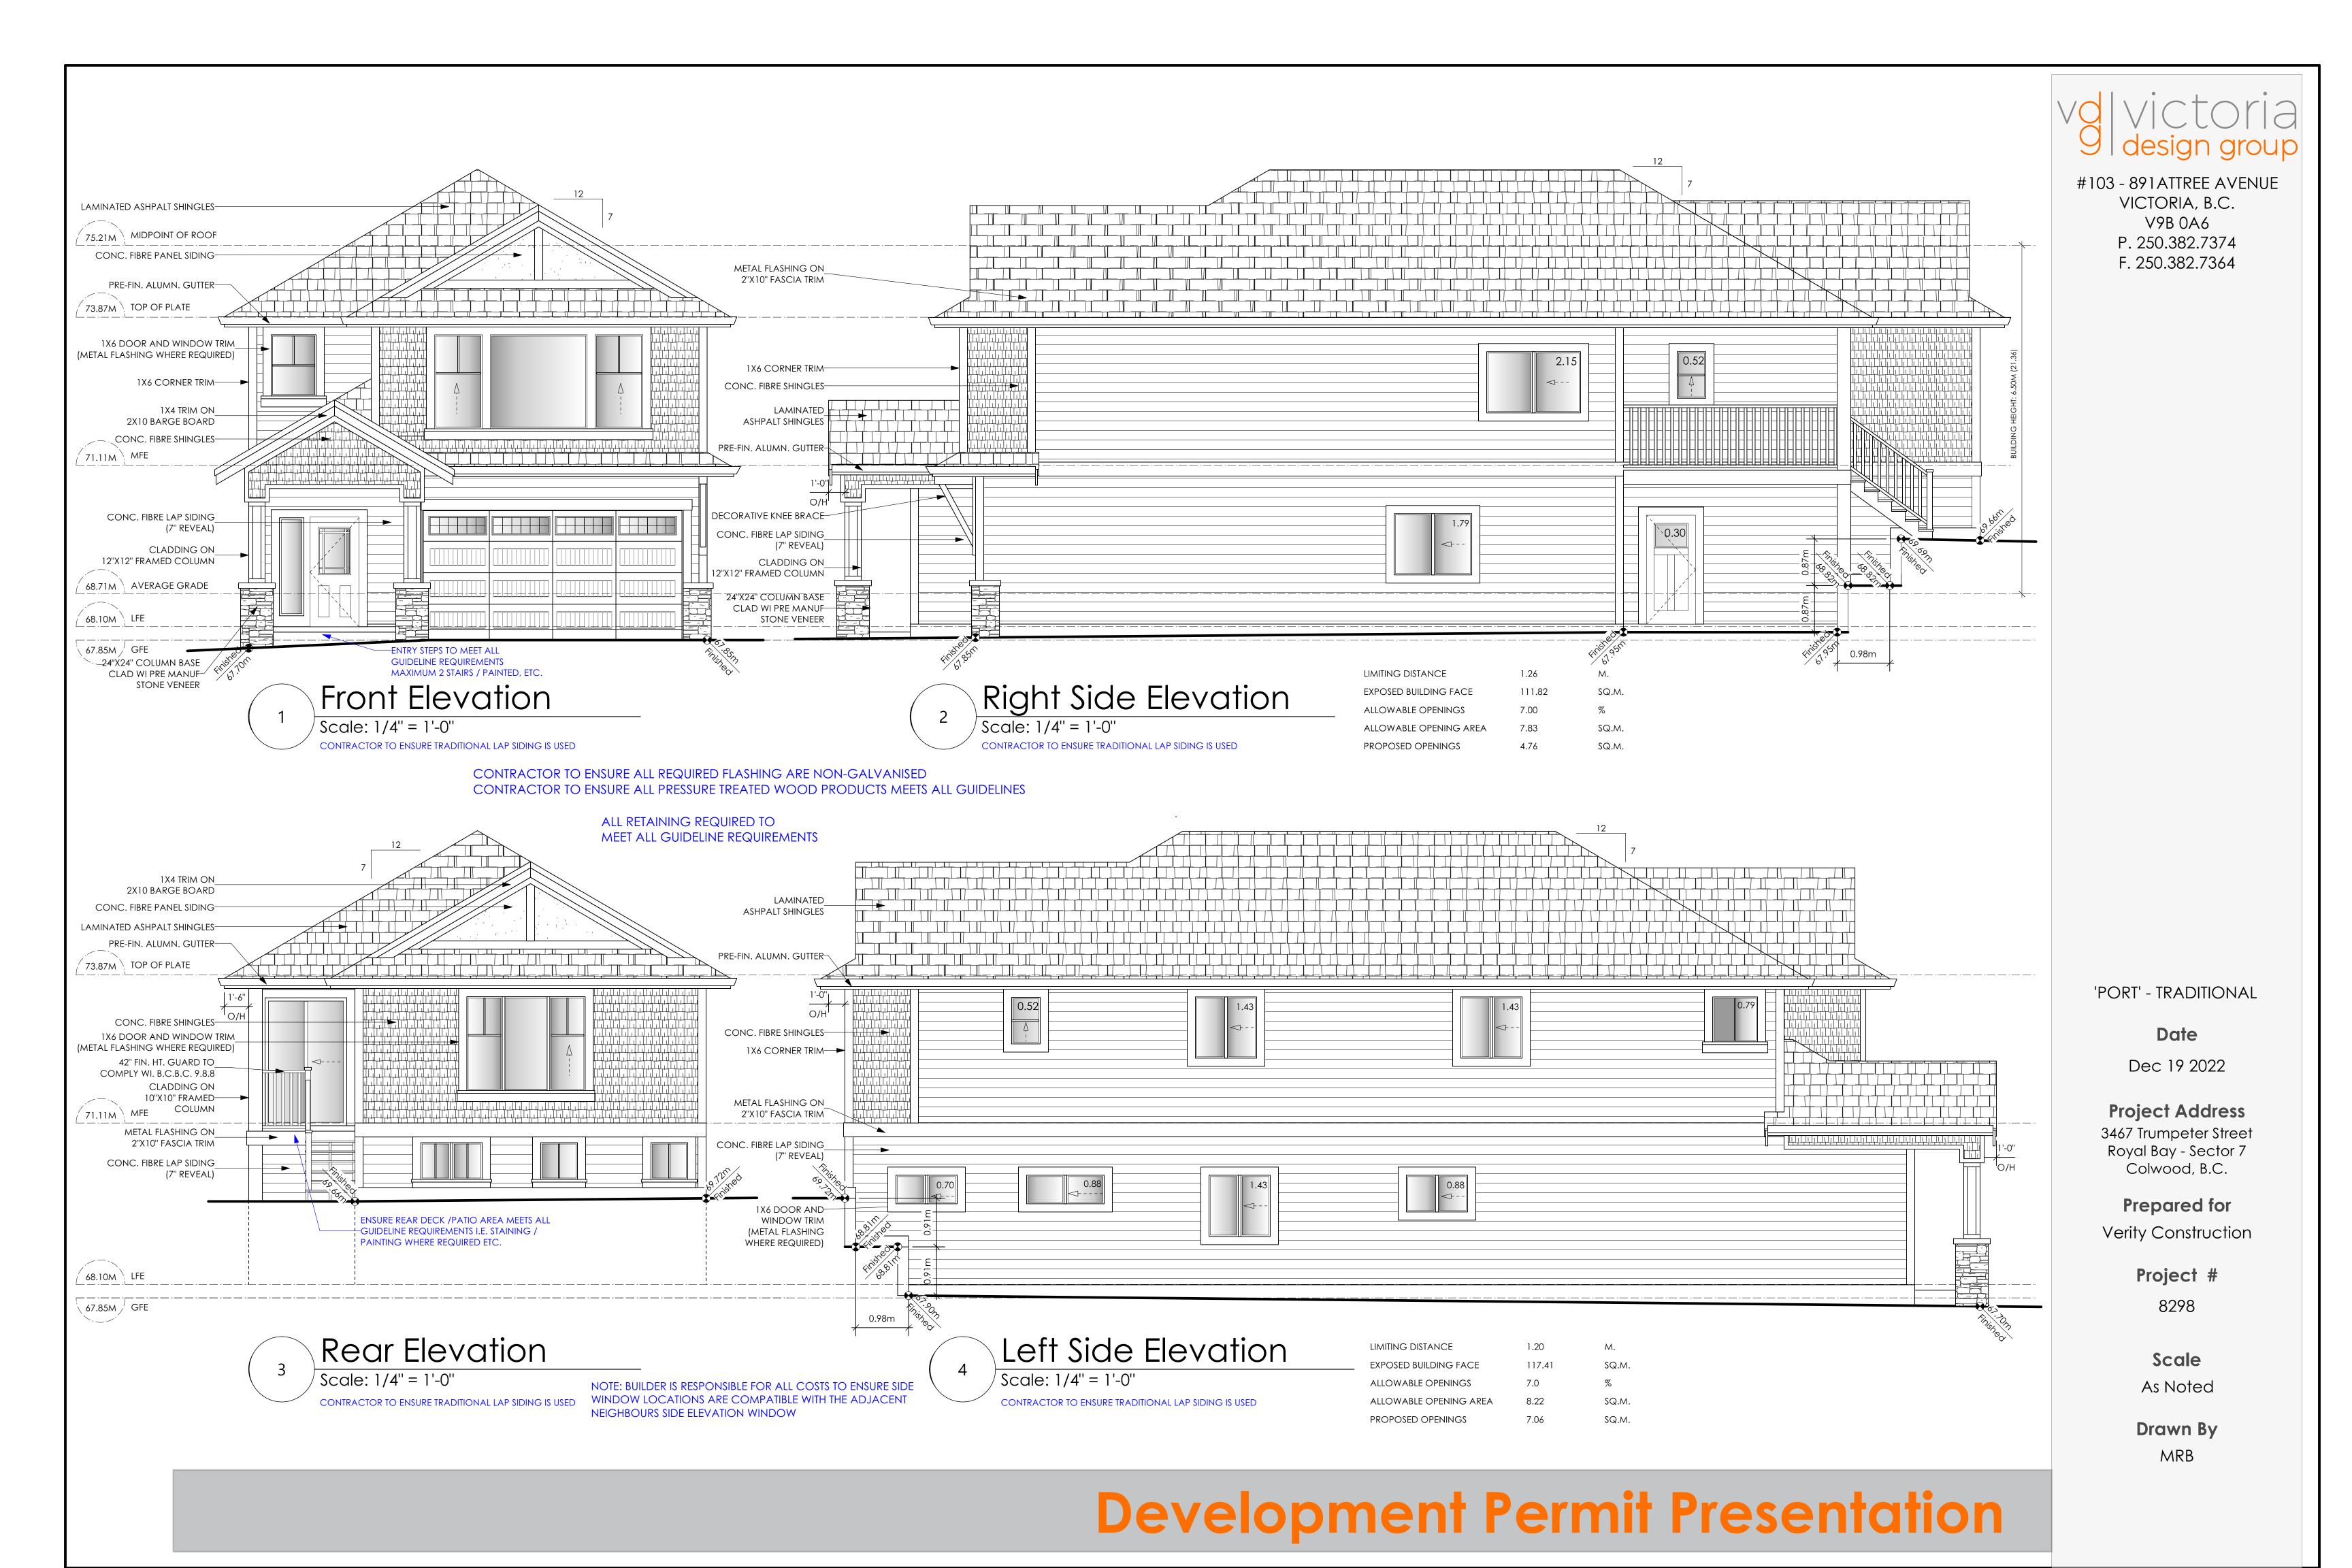

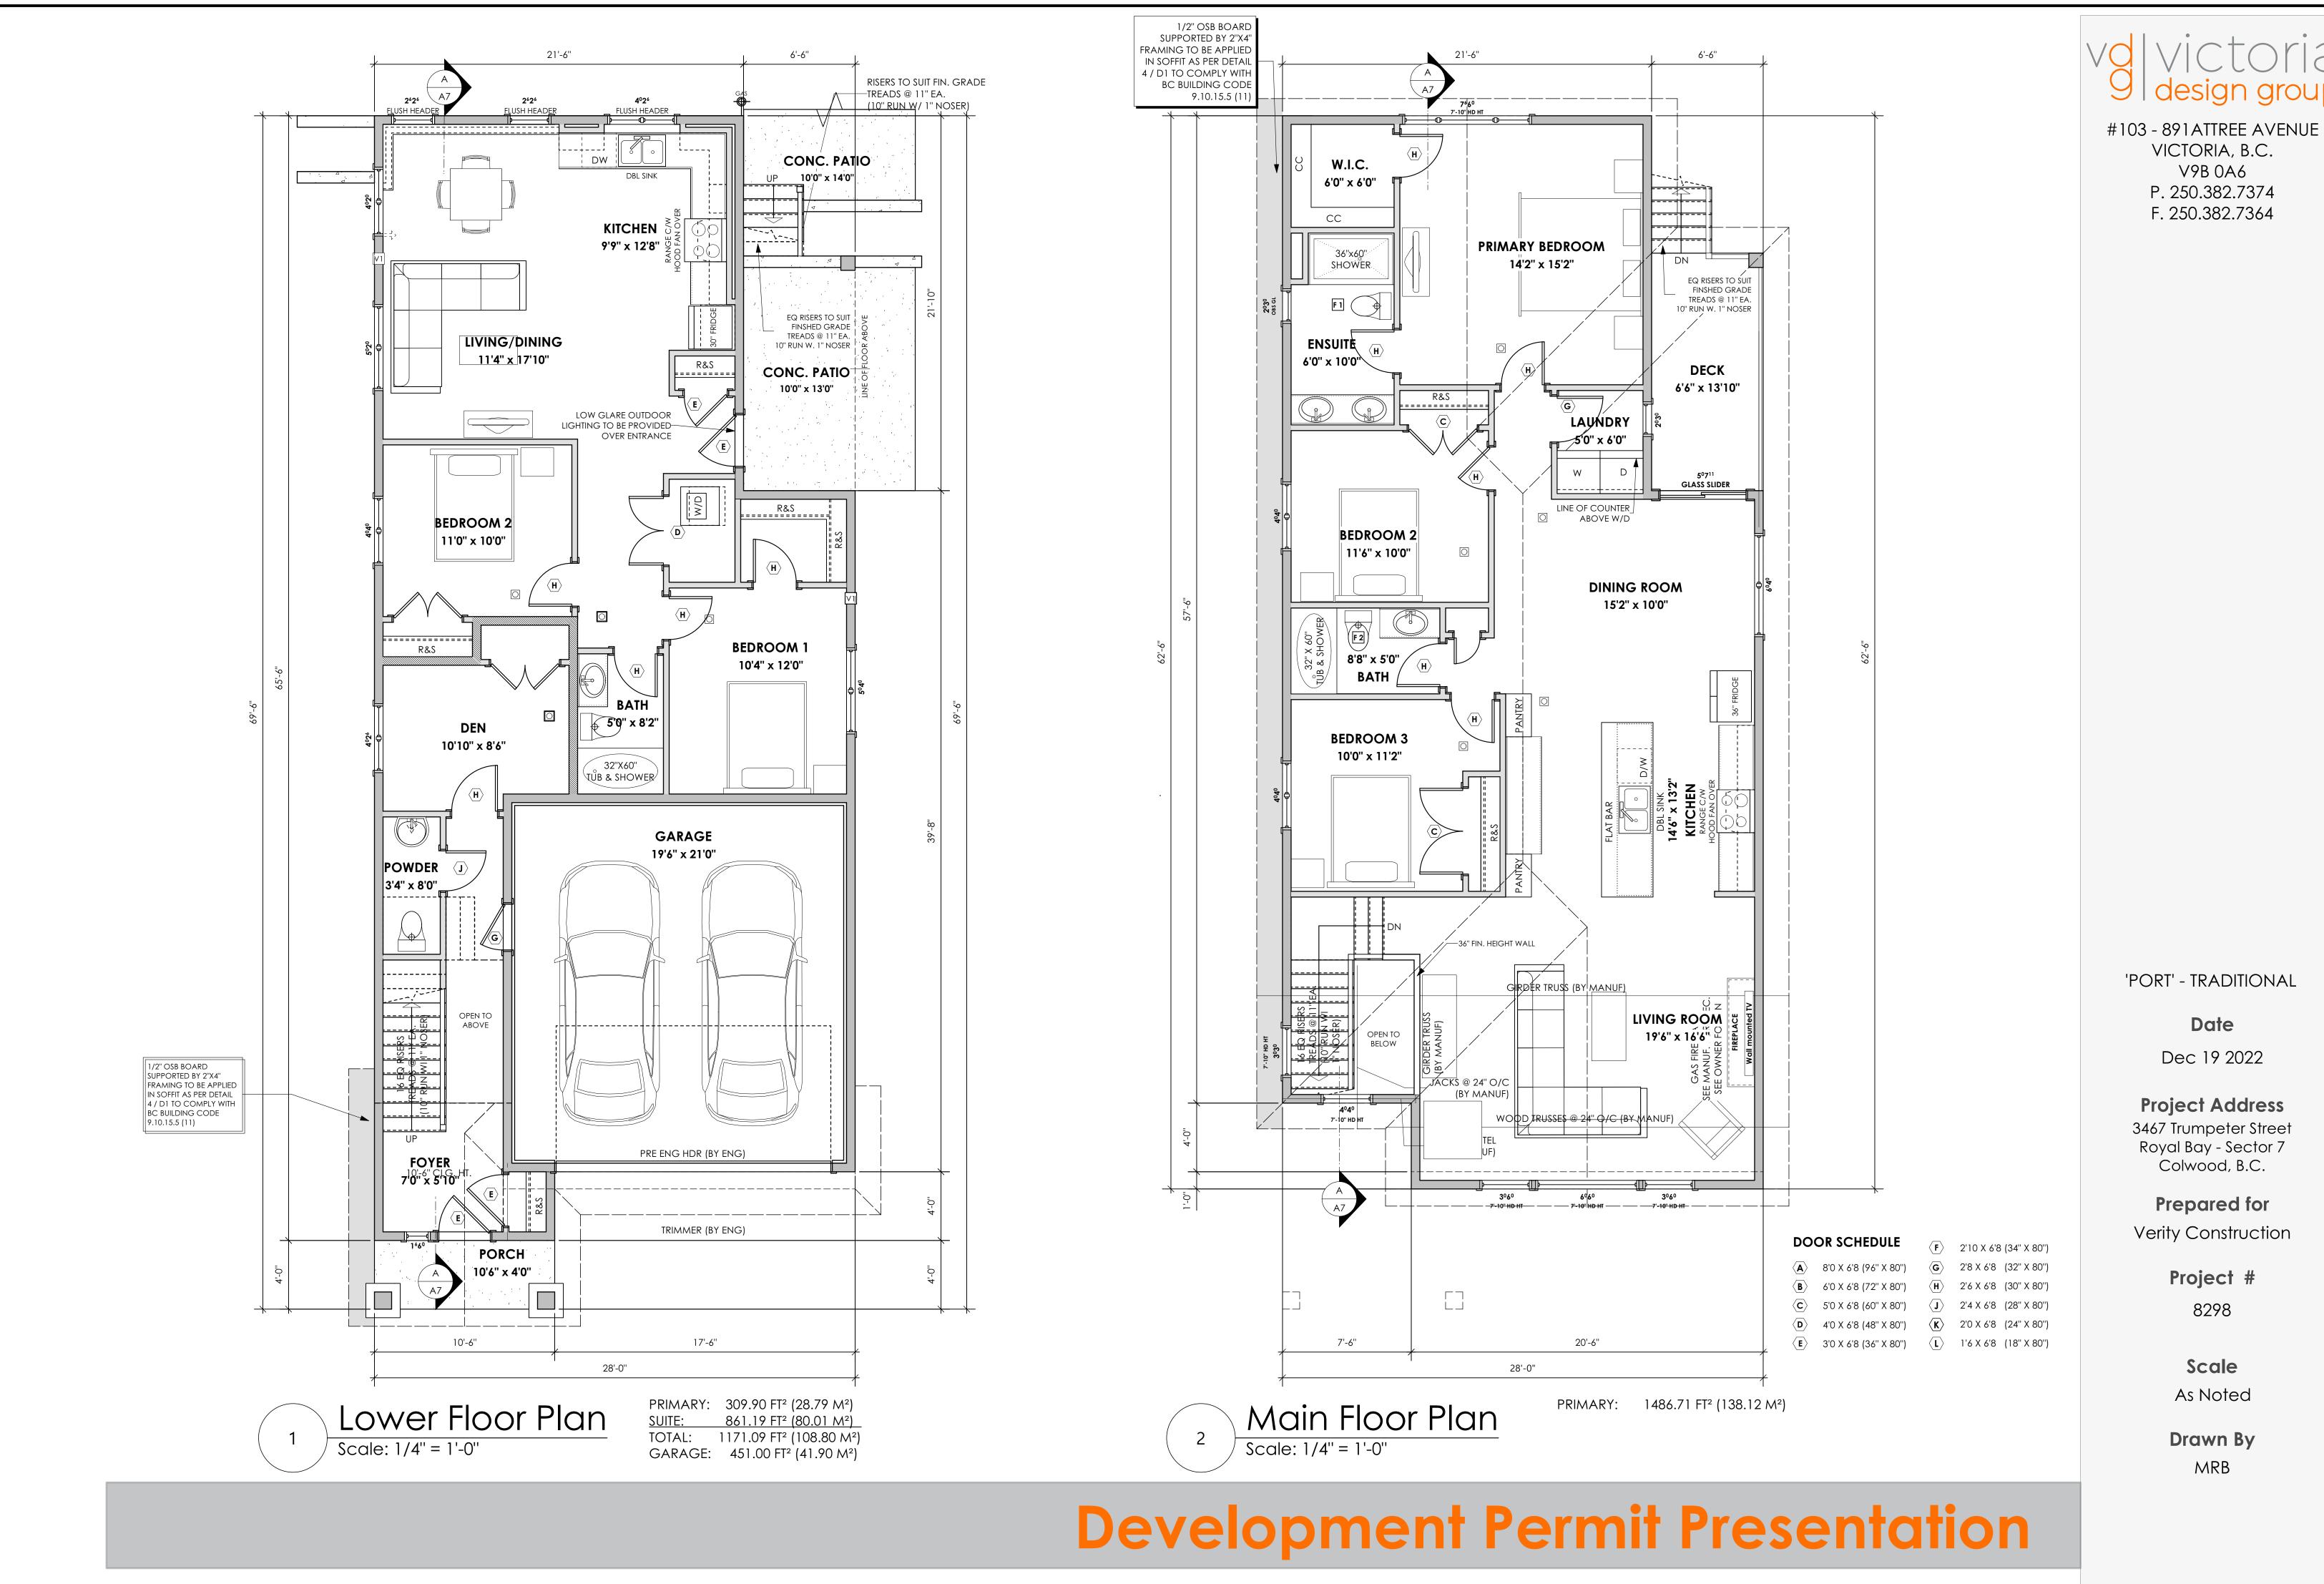



#103 - 891 ATTREE AVENUE VICTORIA, B.C. V9B 0A6 P. 250.382.7374 F. 250.382.7364

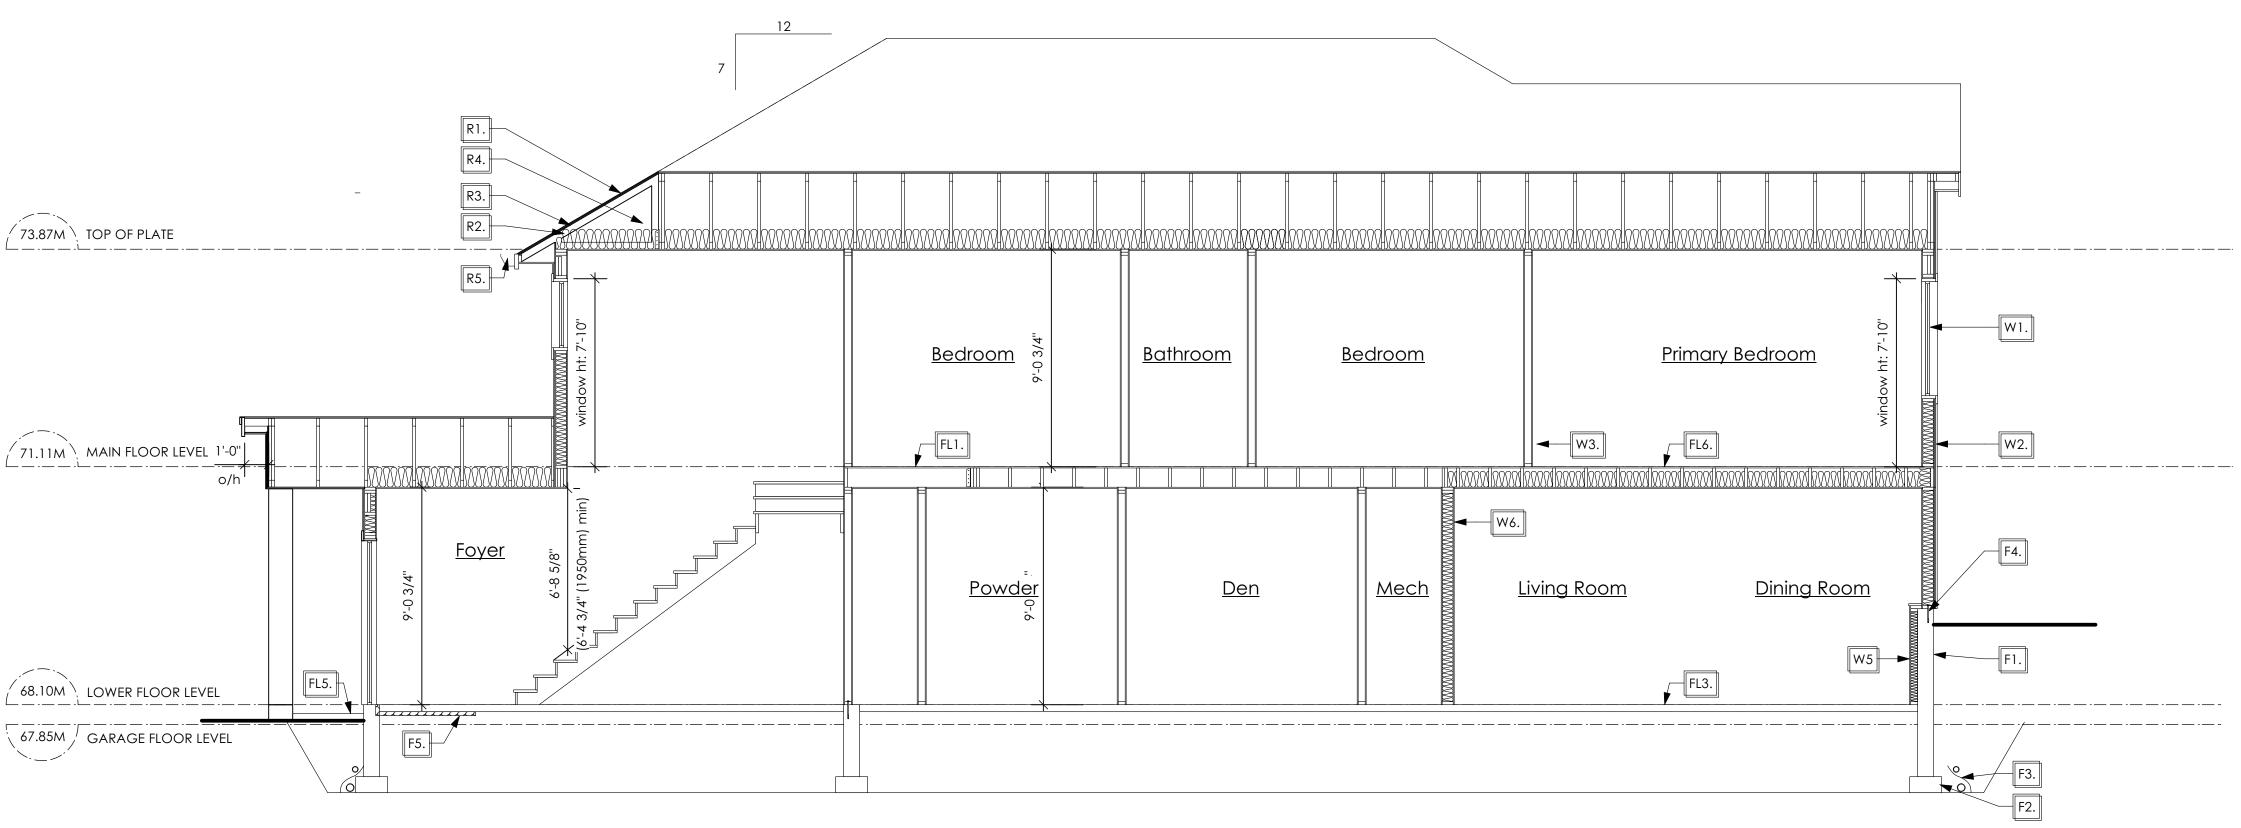



STRUCTURAL WOOD ELEMENTS WITHIN 150MM (6") FROM FINISHED GROUND LEVEL SHALL BE PRESSURE TREATED WITH A PRESERVATIVE FOR TERMITE AND DECAY PROTECTION B.C.B.C. 2012 9.3.2.9.(3)

# SECTION NOTES

#### Roofs

- R1. LAMINATED ASPHALT SHINGLES ON
  7/16" ORIENTED STRAND BOARD C/W "H" CLIPS
  WD TRUSSES (DESIGNED BY MANUF.)
  14 1/2" FIBRE GLASS LOOSE FILL INSULATION
  (ALLOW FOR SETTLING)
  OR R-40 FIBRE GLASS BATT INSULATION
  6 MIL POLY'N V.B.
  5/8" GYPSUM BOARD
- R2. PROVIDE 2 1/2" (63mm) CLEAR BETWEEN R-20 INSULATION AND SHEATHING. (min. R-20 @ roof-wall connection for 4'-0" (1.2m) around perimeter of building. air ventelation baffles to be installed where required in as per BCBC 9.19.)
- R3. EAVE PROTECTION

  CONT. UP ROOF SLOPE FOR 12"

  PAST EXTERIOR WALL.
- R4. PROVIDE 1 SQ.FT. ATTIC VENT PER
  300 SQ.FT. OF INSULATED AREA MIN.
  25% OF REQUIREDTO BE @ TOP AND BOTTOM
  (to comply wi. B.C. bldg. code 9.19.1)
- R5. PRE-FN. FASCIA GUTTER
  2×8 FASCIA BD.
  2×4 SUB. FASCIA BD.
  VENTED SOFFIT
  (see contractor)

R6. PRE MANUF SOFFIT

1/2" OSB BOARD

SUPPORTED BY 2"X4" FRAMING

REFER TO DETAIL 4 / D1

(to be applied in any soffit that has less then
1.20m clearance to any proverty line.

To comply with BC BUILDING CODE
9.10.15.5 (11) )

(AS REQUIRED, VERIFY ON SITE)

(NOT SHOWN IN SECTION)

### **Floors**

- FL1. FINISHED FLOORING ON
  19/32" ORIENTED STRAND BOARD OR EQUAL
  (NAILED & GLUED TO FLOOR STRUCT. BELOW) ON
  2×10 FLOOR JOISTS @ 16" OR 12" O/C
  C/W 2×2 X-BRIDGING @ 7.0' O/C (MAX)
  1/2" GYPSUM BOARD
- FL2. FINISHED FLOORING ON

  19/32" ORIENTED STRAND BOARD OR EQUAL
  (NAILED & GLUED TO FLOOR STRUCT. BELOW) ON

  2×10 FLOOR JOISTS @ 16" OR 12" O/C
  C/W 2×2 X-BRIDGING @ 7.0' O/C (MAX)

  R-31 FIBRE GLASS BATT INSULATION

  5/8" X-TYPE GYPSUM BOARD
  (BETWEEN GARAGE AND LIVING SPACE)
  (NOT SHOWN IN SECTION)
- FL3. 3 1/2" CONCRETE SLAB
  6 MIL. POLY'N V.B.
  6" COMPACTED GRAVEL OR SAND
- FL4. 3 1/2" CONCRETE SLAB
  6 MIL. POLY'N V.B.
  6" COMPACTED GRAVEL OR SAND
  SLOPE TO DOORS 1"
  (NOT SHOWN IN SECTION)
- FL5. 3 1/2" CONCRETE SLAB
  (CONTRACTOR TO VERIFY EXTENT OF
  EXTERIOR SLABS AND FINISHES)
  (SLOPE AWAY FROM BUILDING @ 2% MIN.)
  6" COMPACTED GRAVEL OR SAND
- FL6. F8d RATED CEILING ASSEMBLY
  (BC BUILDING CODE TABLE 9.10.3.1.B)
  FINISHED FLOORING ON
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  R-31 INSULATION
  RESILIENT METAL CHANNELS @ 24" O/C
  1 LAYERS 5/8" X-TYPE GYPSUM BOARD
  30 MINUTE F.R.R., 50 S.T.C.

#### Walls

- W1. DOUBLE GLAZING
  ENERGY STAR LOW "E" RATING IN
  THERMAL BREAK FRAMES
  2/2"X10" LINTEL OVER (@ BEARING WALLS ONLY)
  (TYPICAL, WI. 2 1/2" XPS INSULATION)
  FLASHING OVER @ EXTERIOR
  (GLAZING IN ALL EXTERIOR DOORS & WITHIN 3 FT.
  OF EXTERIOR DOORS TO BE SHATTERPROOF (SP))
  WINDOW REQUIREMENTS DERIVED FROM BCBC
  TABLE C-5 AS PER BCBC 9.7.4.3. AND ARE TO BE
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  AAMA/WDMA/CSA 101/I.S.2/A440, "NAFS":
  COLWOOD, CLASS R, DP 1440, PG 30, WATER RESIST. 220, A2,
  RATINGS MUST BE CLEARLY LABELED ON ALL
  WINDOW UNITS UPON INSTALLATION FOR INSPECTION.
- W2. CONC. FIBRE BOARD ON
  9.5MM (3/8") AIR SPACE / STRAPPING
  3/8"×2" BORATE TREATED PLYWOOD STRAPPING
  HOUSE WRAP (A.B.) (TYVEK OR EQ.)
  7/16" ORIENTED STRAND BOARD SHEATHING
  2×6 STUDS (SEE APCING BELOW)
  R-20 INSULATION
  6 MIL. POLYETHYLENE VAPOUR BARRIER
  1/2" GYPSUM BOARD
  (REFER TO DETAILS ON D1)
- W3. INTERIOR PARTITION
  1/2" GYPSUM BOARD ON EACH SIDE
  OF 2×4 STUDS (SEE SPACING BELOW) OR
  2×6 STUDS (SEE SPACING BELOW) (IF NOTED)

# W4. 5/8" X-TYPE GYPSUM BOARD ON 2×6 STUDS (SEE SPACING BELOW) R-20 INSULATION 6 MIL. POLY'N V.B 1/2" GYPSUM BOARD

(NOT SHOWN IN SECTION)

(BETWEEN GARAGE & LIVING)

- W5. 1/2" GYPSUM BOARD ON
  6 MIL. POLY'N V.B.
  2×4 STUDS (SEE SPACING BELOW)
  OR 2×6 STUDS (SEE SPACING BELOW) (IF NOTED)
  R-12 BATT INSULATION
  HOUSE WRAP (A.B.) (TYVEK OR EQ.) OR
  12.7MM (1/2") AIR SPACE
  (PROVIDE REQUIRED FIRE STOPS IN WALL
  ASSEMBLIES TO COMPLY WITH
  B.C. BLDG. CODE 9.10.16.)
- W6. B.C. BUILDING CODE (TABLE 9.10.3.1.A)
  RATED WALL ASSEMBLY W3C
  1 LAYER 1/2" X-TYPE GYPSUM BOARD
  RESILIENT METAL CHANNELS @ 24" O/C
  2×4 STUDS @ 16" O/C OR
  2×6 STUDS @ 16" O/C (IF NOTED) C/W
  3 1/2" FIBRE GLASS SOUND BATTS
  1 LAYER 1/2" X-TYPE GYPSUM BOARD
  45 MIN. F.R.R 43 S.T.C
  (BETWEEM PRIMARY LIVING & SECONDARY SUITE)
- W7. STUD SPACING
   UPPER FLOOR: 2"X6" @ 24" O/C
   MAIN FLOOR: 2"X6" @ 24" O/C
   LOWER FLOOR: 2"X6" @ 16" O/C
  (if applicable)
   INTERIOR PARTITION: 2"X4"" @ 24" O/C
   LOAD BEARING: 2"X4"" @ 16" O/C
   PARTY WALL
  (if applicable)

## **Foundation Walls**

- F1. DAMPROOFING (where required) ON 8" THK. CONC. FOUNDATION WALL C/W 15 M BARS @ 24" o/c B/W
- F2. 16"X 8" CONC. FOOTINGS

  C/W 2 (TWO) 15m BARS CONT. 3 IN. FROM BOTT.

  ON UNDISTURBED SOIL (SOLID BEARING)
- F3. 4" PERIMETER DRAIN 3" TIGHT PIPE FOR RWL DRAIN ROCK
- F4. ANCHOR BOLTS @ 4.0 FT. o/c MAX c/w SILL GASKETS
- F5. UNDER SLAB INSULATION
  2 1/2" (RSI 2.15) EXTRUDED POLYSTYRENE
  RIGID INSULATION 4'-0" (1.2M)
  CONT. AROUND PERIMETER UNDER
  SLAB INSTALLED HORIZONTALLY
  (VERIFY WITH MUNICIPALITY DEPTH OF FROST LINE)

'PORT' - TRADITIONAL

Date

Dec 19 2022

Project Address
3467 Trumpeter Street
Royal Bay - Sector 7

Prepared for

Colwood, B.C.

Verity Construction

Project #

8298

**Scale**As Noted


Drawn By

MRB


# Development Permit Presentation


## ALL FENCING, RETAINING AND LANDSCAPING MUST MEET THE GUIDELINE REQUIREMENTS

ALL RETAINING WALLS ARE TO BE STAND ALONE STRUCTURES (THEY MUST TERMINATE AT PROPERTY LINE) AND MUST NOT CONNECT TO RETAINING WALLS LOCATED ON ADJACENT PRIVATE PROPERTIES \*NOTE: In the interest of maintaining high standards, the developer reserves the right to modify plans, specifications and design without prior notice. Drawings contained within are artist renderings only. Sizes and dimensions are approximate and may vary with actual plan and survey. Exterior style may change pending municipal approval. Retaining wall location and types may vary and are subject to municipal, engineering or developer discretion. Subject to change without notice. Furniture as shown on plans are for layout purposes only and are not included in the sale.

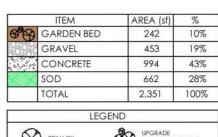



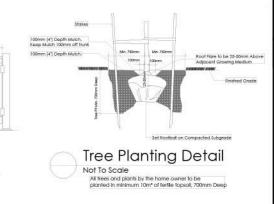

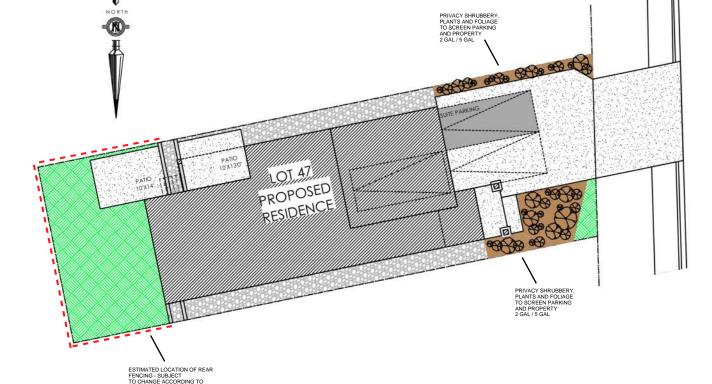

DATE

**PROJECT** 

LANDSCAPE PLAN
NOT TO SCALE

ADDITIONAL NOTES:

LOCATION INDICATED BY

6X6 WOOD POST

PROPERTY TO BE IRRIGATED
6" PIPE FOR DRIVEWAY SLEEVES TO
BE INSTALLED FOR CITY IRRIGATION
LINES

Not To Scale

COMPACTED SUBGRADE

Typical Fence Detail

"TYPICAL FENCE DETAIL BASED OFF FENCE DETAIL 1/L1 FROM ROYAL BAY DESIGN GUIDELINES PAGE 21

	MM/DD/YY	ISSUED/REVISED
01	09/30/22	FOR APPROVAL
02	10/12/22	GARDEN BED PLANTING
03	01/03/23	REVISION AS PER CITY OF COLWOOD

ACTUAL SITE CONDITIONS

LANDSCAPING PLAN LOT 47, 3467 TRUMPETER ST. ROYAL BAY, SECTOR 7 CITY OF COLWOOD



**KEY PLAN** 

NOT TO SCALE

QUALITY CONSTRUCTION. TRUSTED SERVICE.

106 - 1039 Langford Parkway Victoria, B.C. V9B 0A6 P: 250.474.1039 www.verityconstruction.ca


### **GABLECTAST HOMES**

#### **BUILDING GRADE SLIP**

WSP	Project	No:	201-08151-00
	,		

DATE

	Issue Date:
MUNICIPAL ADDRESS 3467 Trumpeter Street	P.I.D.
LOT 47	PLAN
BUIL DER	SUBDIVISION
VERITY HOMES  ADDRESS	ROYAL BAY SECTOR 7 DEVELOPER
REPRESENTATIVE PH.	MEADOWS DEVELOPMENT LP CONSULTANT
	WSP CANADA INC
PROPOSED BUILDING GRADES  ALL ELEVATIONS ARE METRIC GEODETIC +	<u>PLAN</u>
74.44	LOT:47 PLAN: TRUMPETER ST.
(TOP OF JOISTS) JOIST	+-41
FRONT ELEV. 67.70 (FINISHED GRADE) (FINISHED GRADE)	
FINISHED GRADE AT GARAGE 67.85	
WOO	67.58
HEADROOM	
ACTUAL TOP OF FOOTING	₩ 47
LOWEST PERMITTED TOP OF not provided FLOOR SLAB FOOTING ELEVATION (LTF) (BOTTOM OF BASEMENT SLAB	00 MFE 68.24 X 00 GFE 68.04 90
FROST WALLS ARE REQUIRED.)	D 64.47
SERVICES FRONT REAR CENTER REFER SIZE TO PLAN (mm)	OD LB
WATER	900
SANITARY           100	
STORM	79.4 69.7 69.7
000000000000000000000000000000000000000	19.4 69.7
COMMENTS YES NO DRAIN TO SUMP PUMP LIKELY REQUIRED	~~~
(FOR BASEMENT IF INSTALLED)	LEGEND
SEWER TO SUMP PUMP LIKELY REQUIRED (FOR BASEMENT IF INSTALLED)	STREET
SERVICES INSTALLED TO m INSIDE PROPERTY	
FOUNDATION SOIL BEARING INVESTIGATION CERTIFICATION REQUIRED	- SERVICE LOCATION (SHOWN ON ABOVE PLAN)
GEOTECHNICAL RESTRICTIONS APPLY	
(SEE GEOTECHNICAL REPORT)	PROPOSED FRONT CORNER ELEVATIONS  PROPOSED FRONT SIDE YARD GRADES  L# 6  L# 6  L# 6
ENVIRONMENTAL RESTRICTIONS APPLY (SEE ENVIRONMENTAL REPORT)	(5) EG 49.90 (7) — EXISTING GROUND ELEVATION
UTILITY EASEMENTS AFFECT THIS LOT	LFE/MFE 47.70 - LOWER/MAIN FLOOR ELEVATION GFE 47.55 - GARAGE FLOOR ELEVATION
	MSE 52.20 — MINIMUM SANITARY SERVICABLE
	S 49.12 (P)  S A9.12 (P)  SAN SERVICE INV.
	D 49.12 (P) (P) DENOTES PUMP IS LIKELY REQUIRED FOR BASEMENT IF INSTALLED
	7 - STORM SERVICE INV. (P) DENOTES PUMP IS LIKELY REQUIRED FOR BASEMENT IF INSTALLED
	PROPOSED REAR SIDE YARD GRADES
NOTES	LOT TYPE (L/LB/LBT)
NOTES  1. IT IS THE RESPONSIBILITY OF THE BUILDER TO ENSURE THE FOOTINGS	- PROPOSED REAR CORNER ELEVATIONS
ARE PLACED ON A PROPER BASE THAT IS FREE FROM FROST, EXCESSIVE MOISTURE AND DELETERIOUS MATERIALS AND HAVE	
APPROPRIATE FROST PROTECTION WHEN COMPLETED.	
2. THE INFORMATION CONTAINED HEREIN IS BASED ON THE APPROVED LOT GRADING PLAN FOR THIS SUBDIVISION. UN-AUTHORIZED DEVIATIONS WILL BE THE RESPONSIBILITY OF THE BUILDER TO	
ENSURE COMPLIANCE WITH ALL LOCAL BYLAWS.	I, THE BUILDER'S REPRESENTATIVE, , CERTIFY THAT THE FINAL HOUSE PLANS PROVIDED IN THE BUILDING PERMIT APPLICATION ARE THE SAME AS PROCESSED UNDER THIS GRADE SLIP AND
3. OTHER NOTES:	THAT I UNDERSTAND THE INFORMATION AND THE REQUIREMENTS CONTAINED HEREIN AND WILL BUILD ACCORDINGLY.
	AUTHORIZED BUILDER'S REPRESENTATIVE DATE  THE INFORMATION CONTAINED HEREIN IS BASED ON THE APPROVED
	LOT GRADING PLAN FOR THIS SUBDIVISION, DATED
	C. Hume - Oct. 12/22

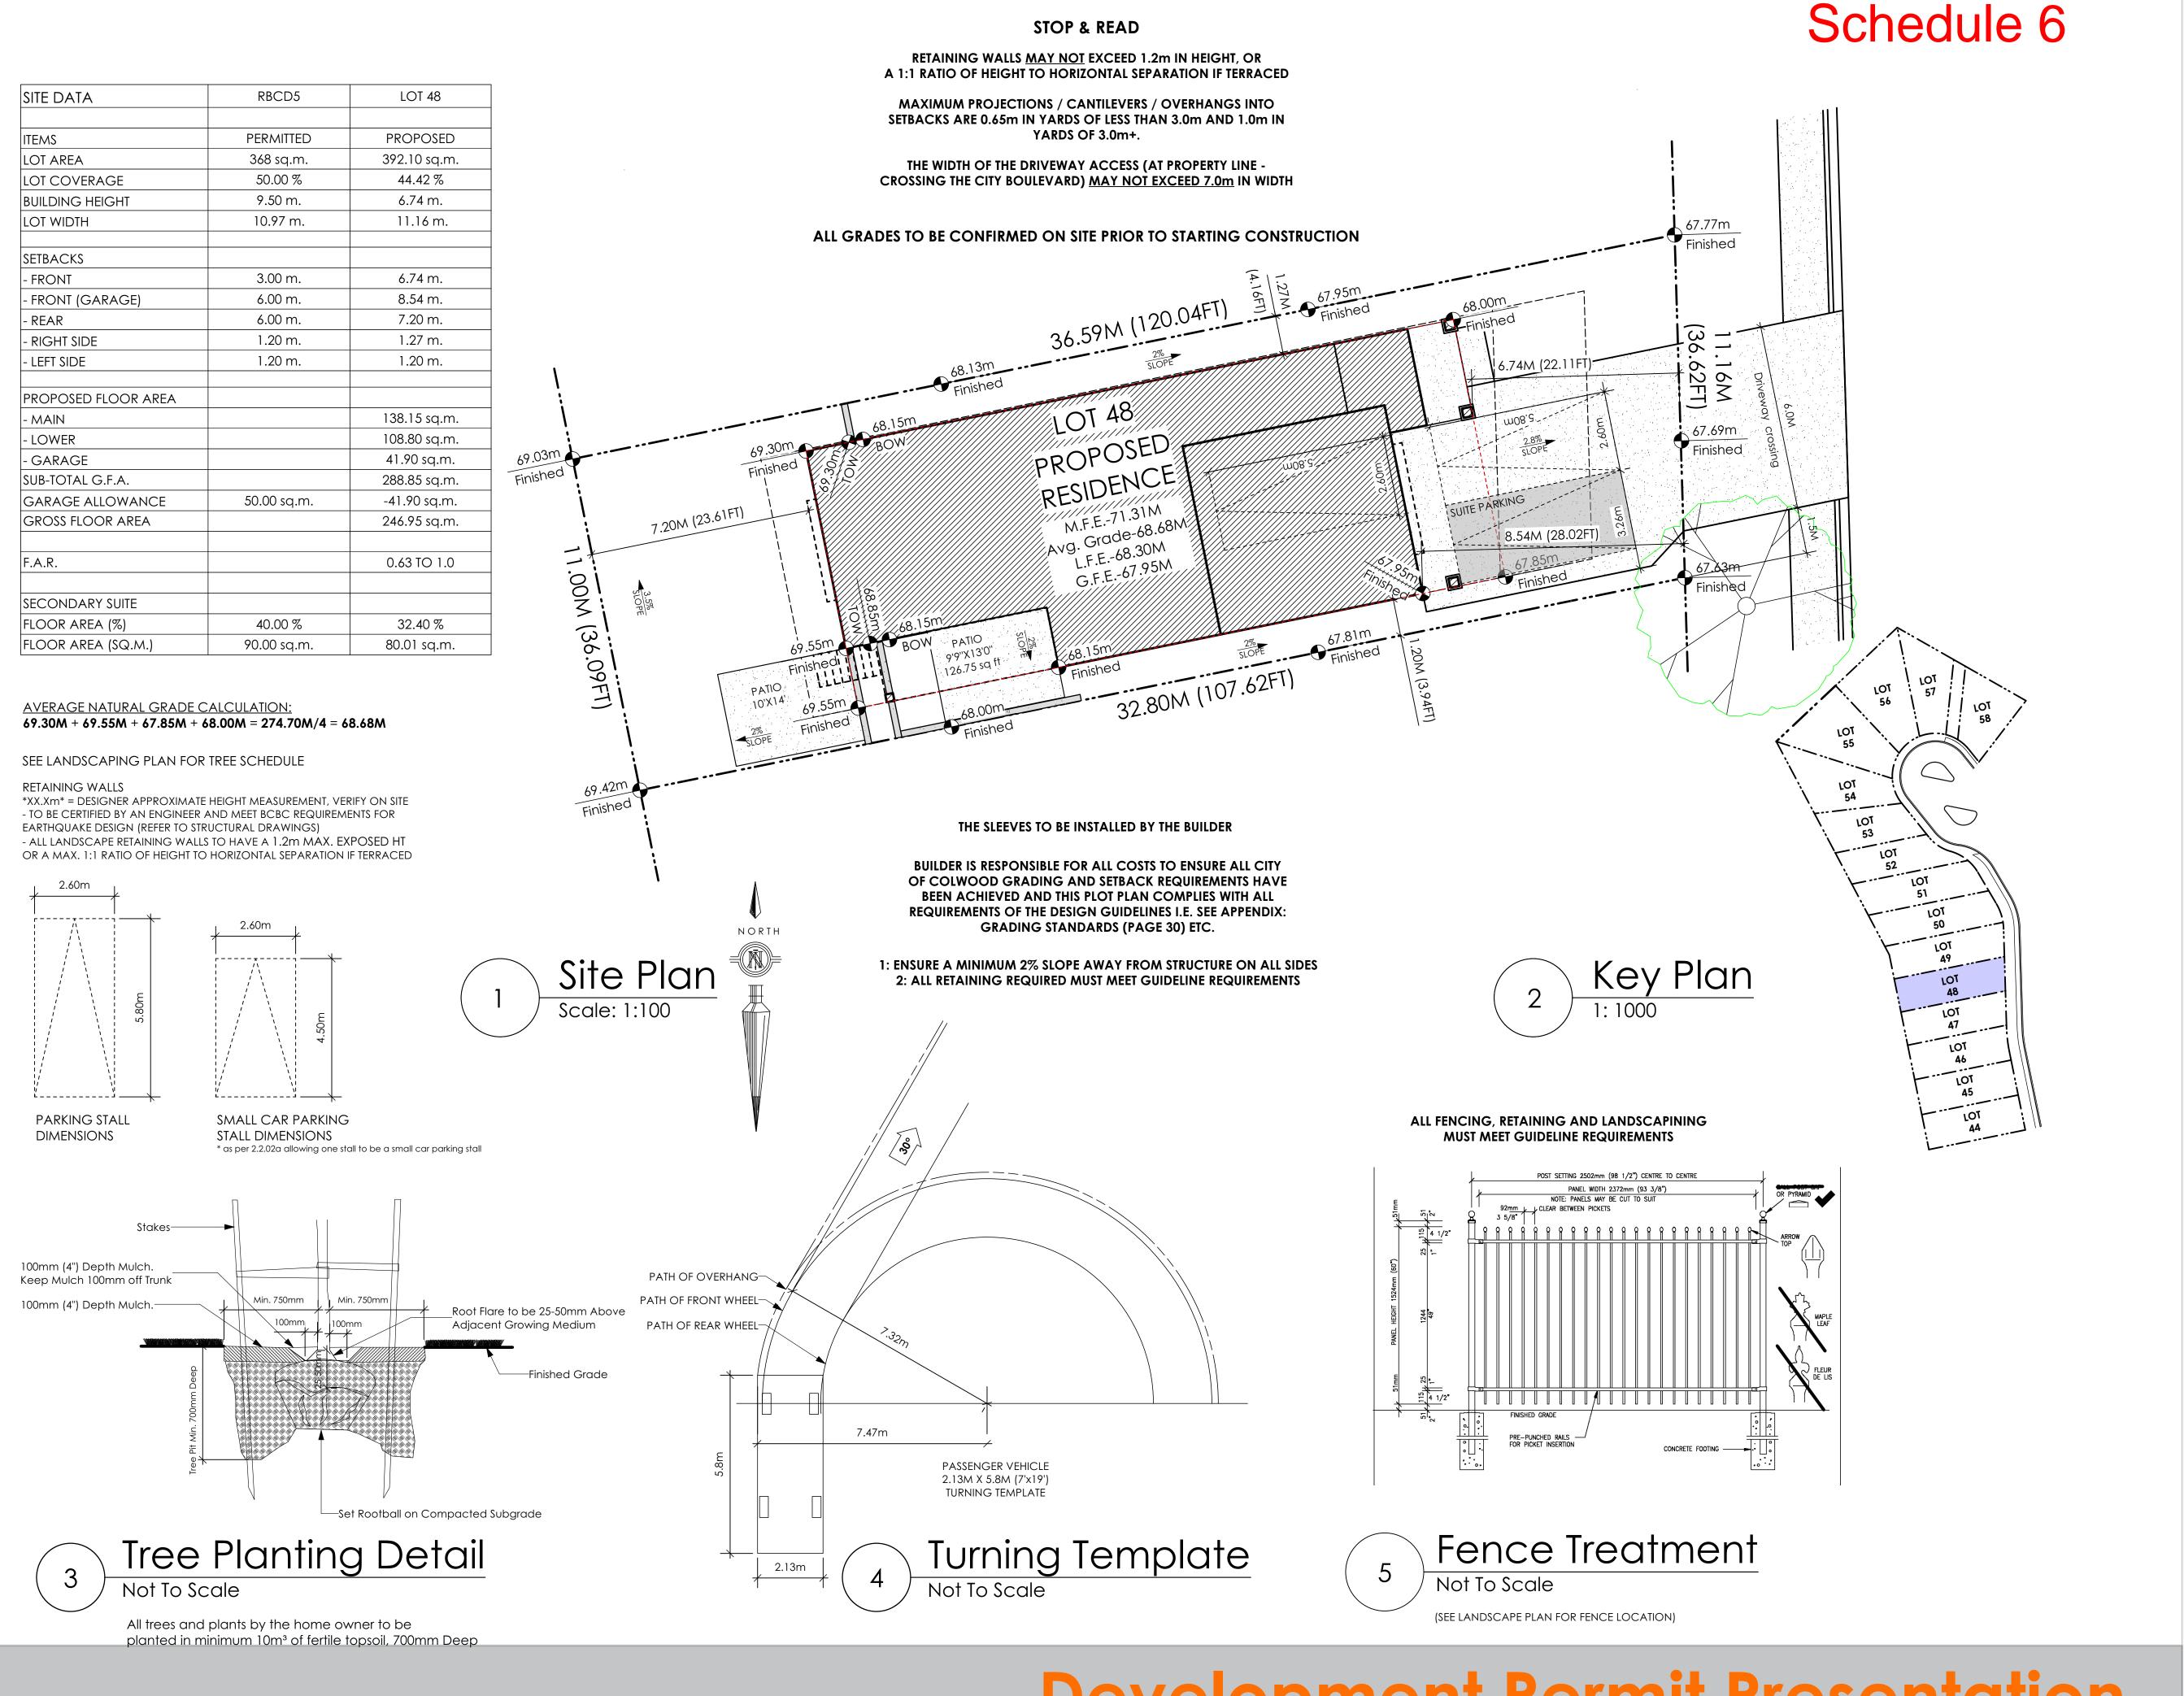

volvictoria 9 design group

#103 - 891 ATTREE AVENUE VICTORIA, B.C. V9B 0A6 P. 250.382.7374 F. 250.382.7364

'PORT' - COASTAL

Date

Dec 22 2022

#### **Project Address**

3469 Trumpeter Street Royal Bay - Sector 7 Colwood, B.C.

### Prepared for

Verity Construction

Project #


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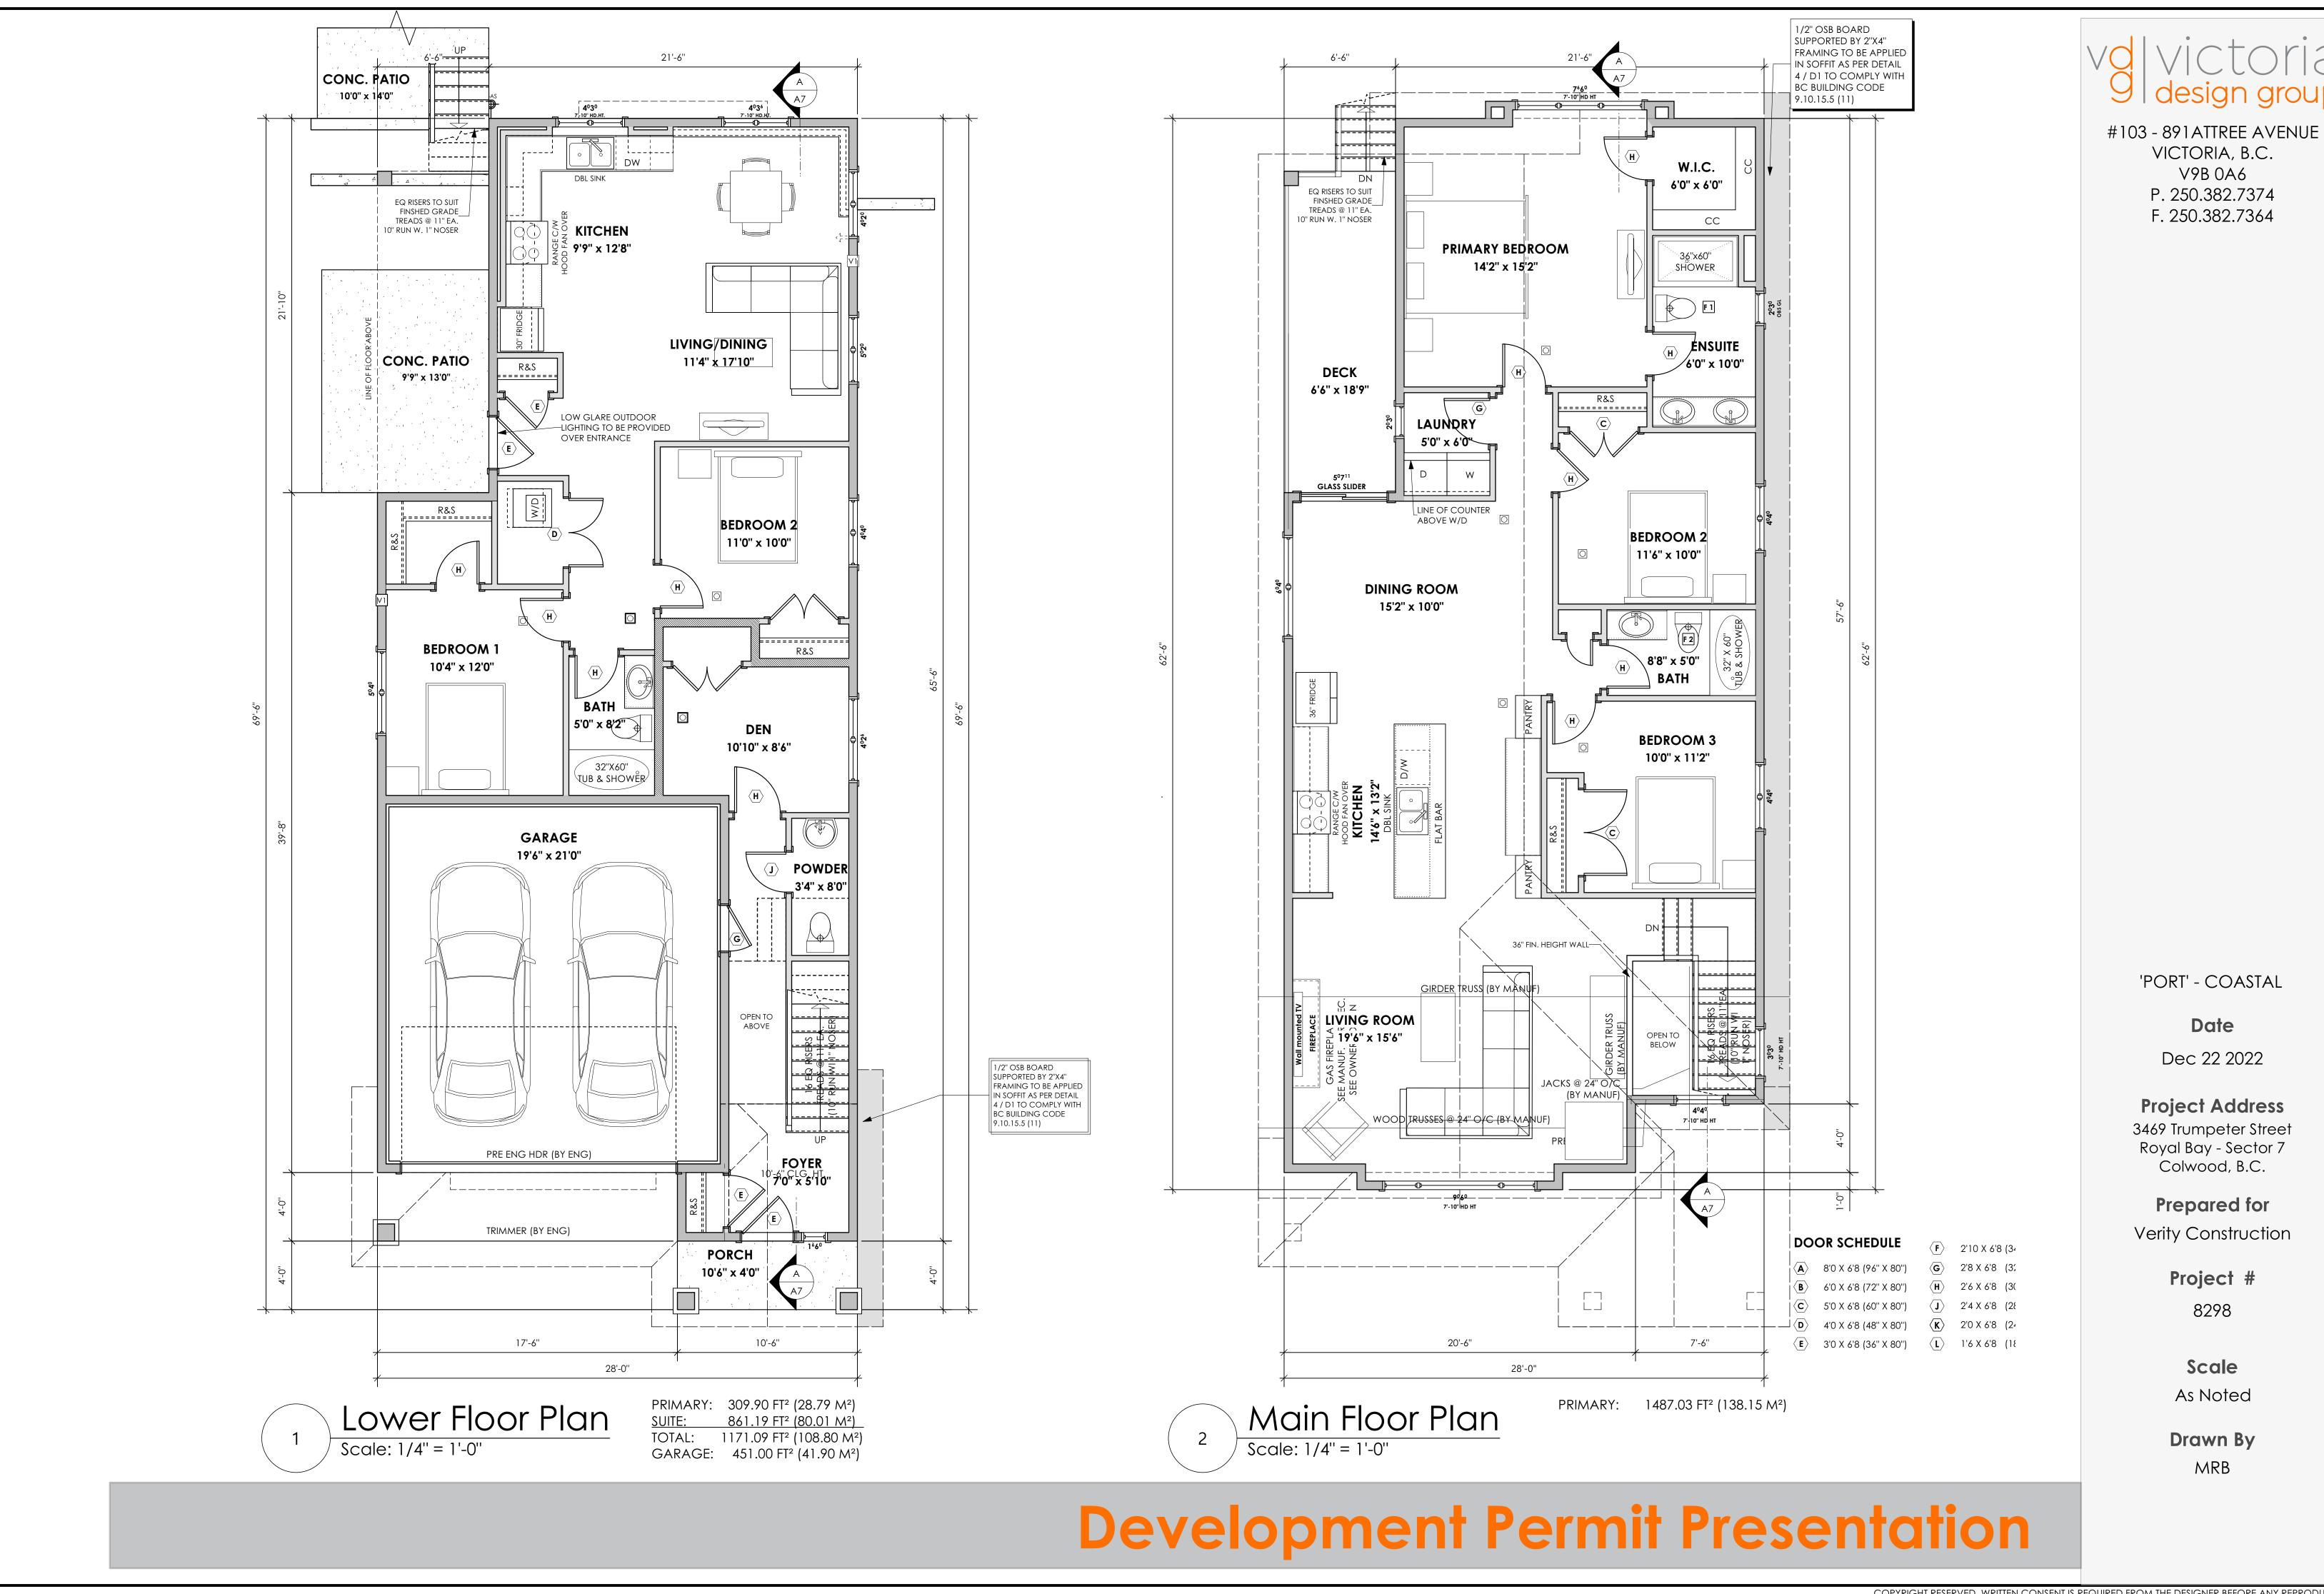
Scale

As Noted

**Drawn By**MRB


Development Permit Presentation



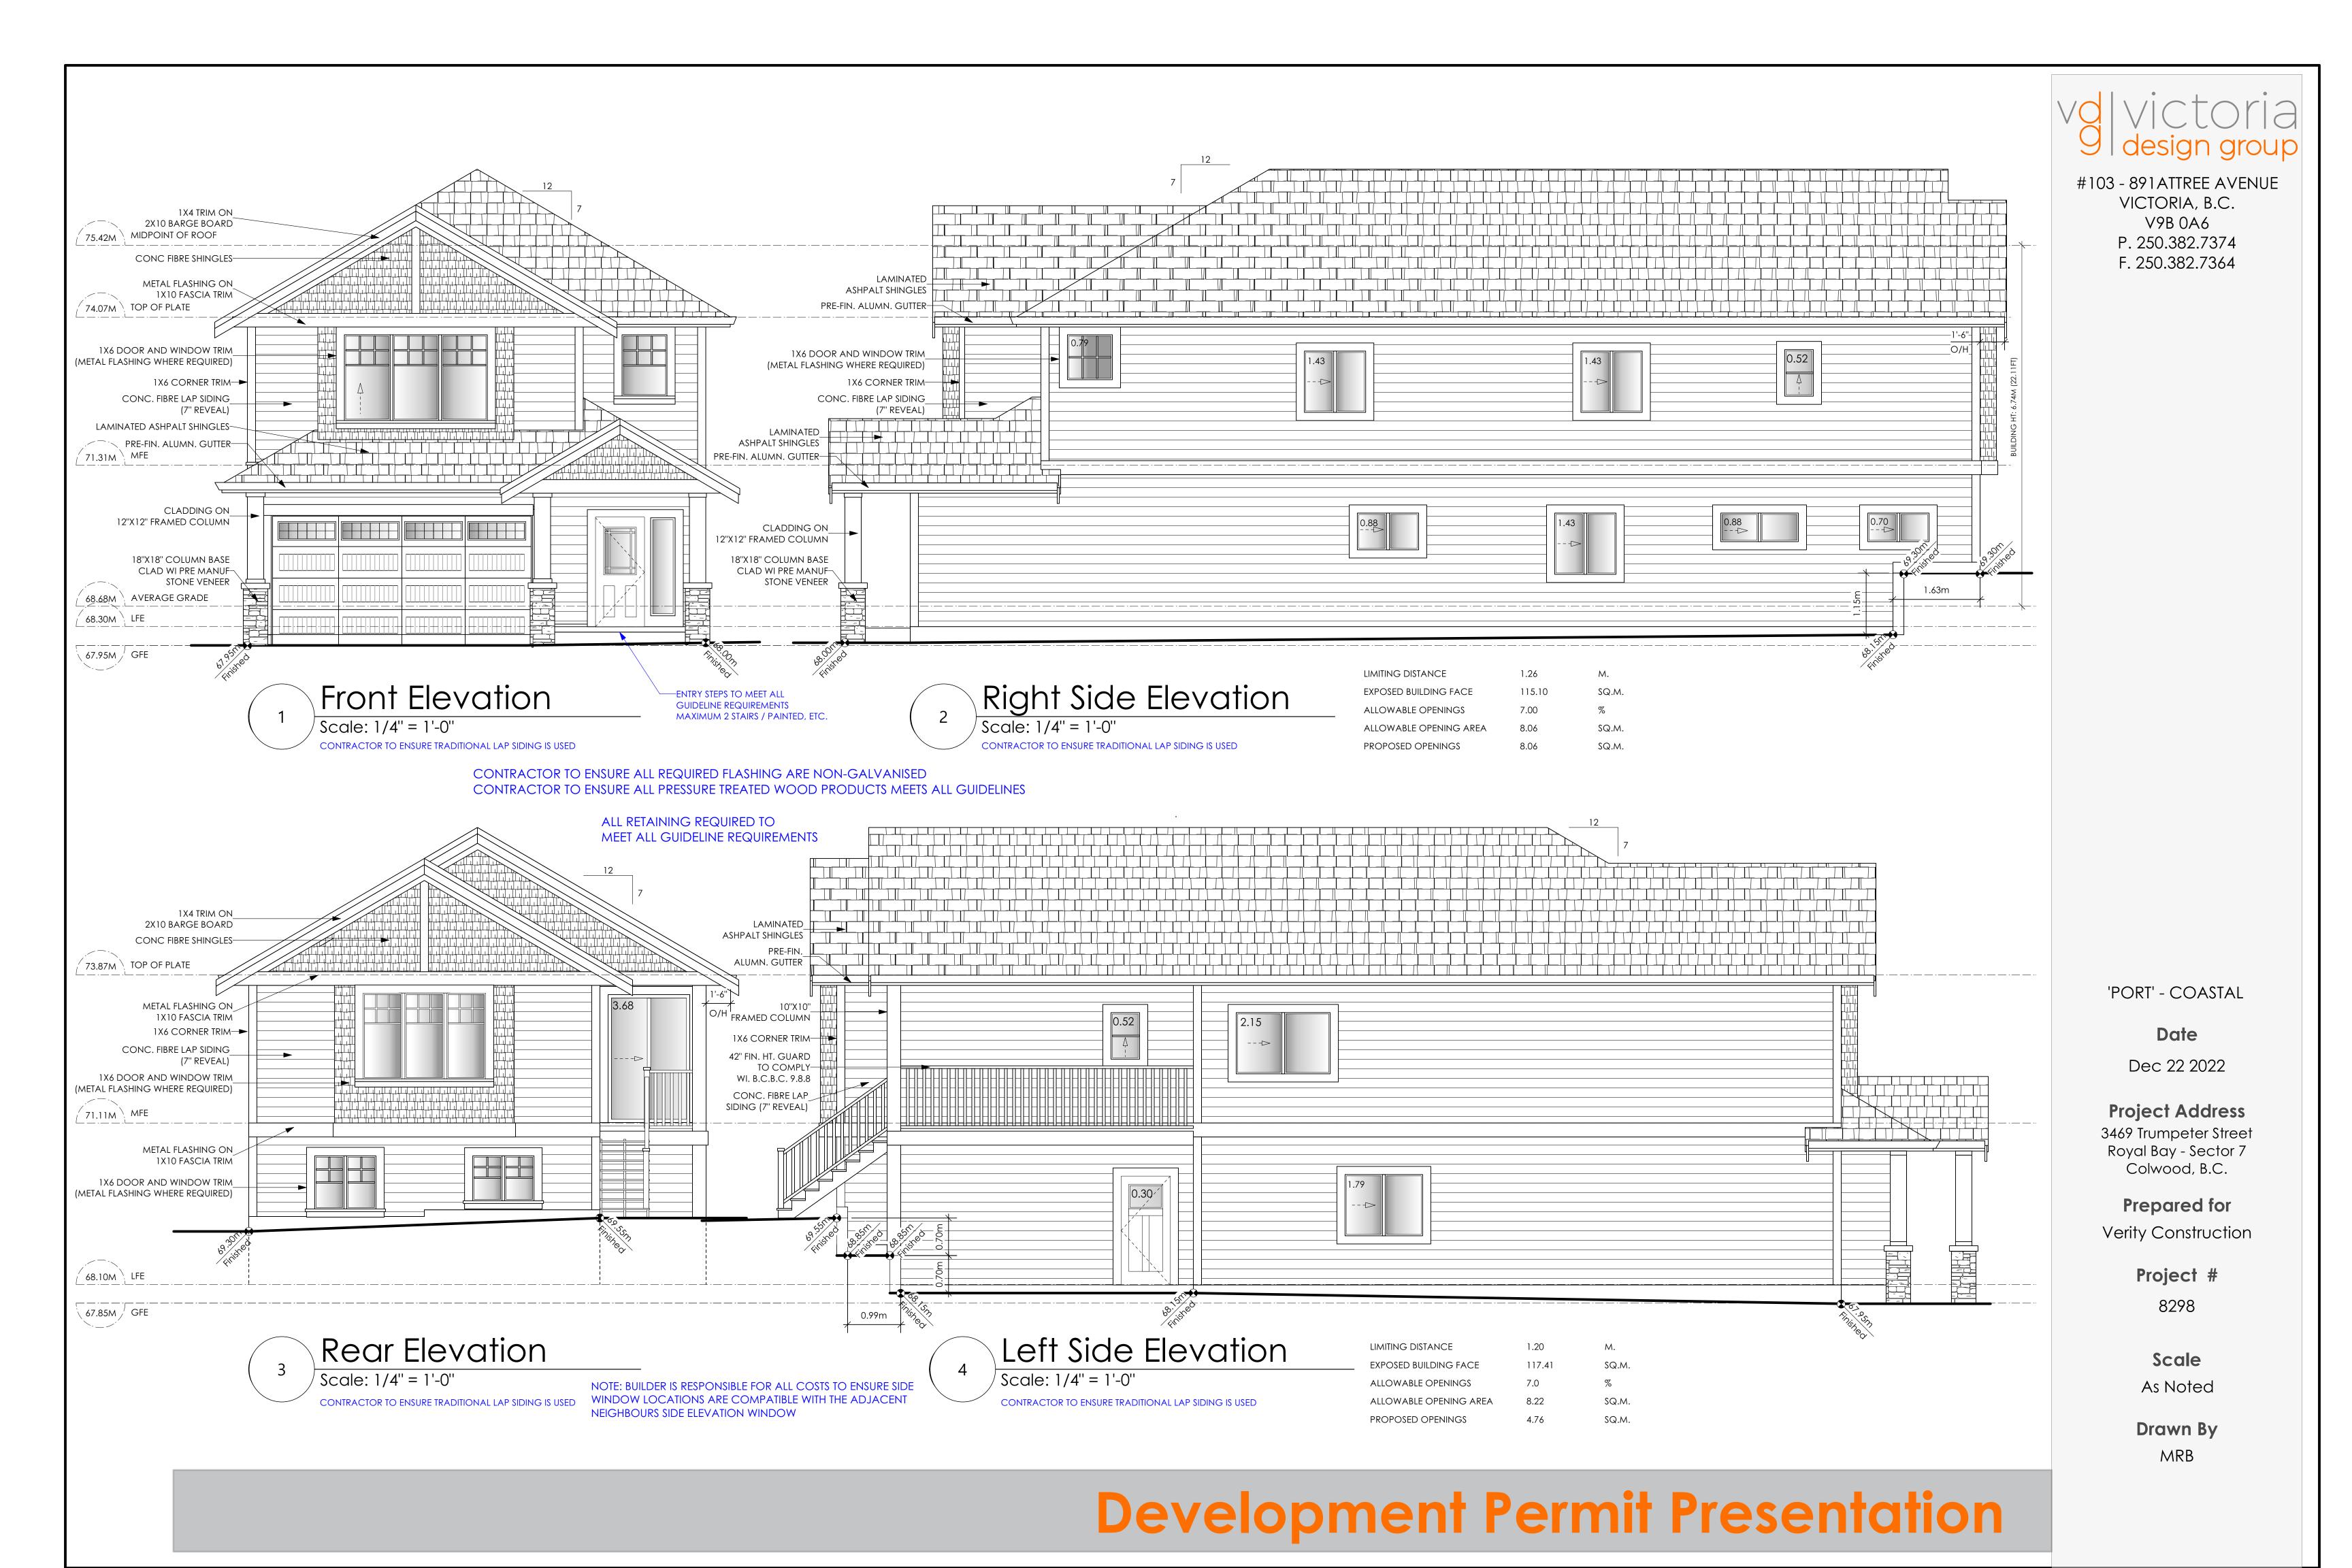



#103 - 891 ATTREE AVENUE VICTORIA, B.C. V9B 0A6 P. 250.382.7374 F. 250.382.7364

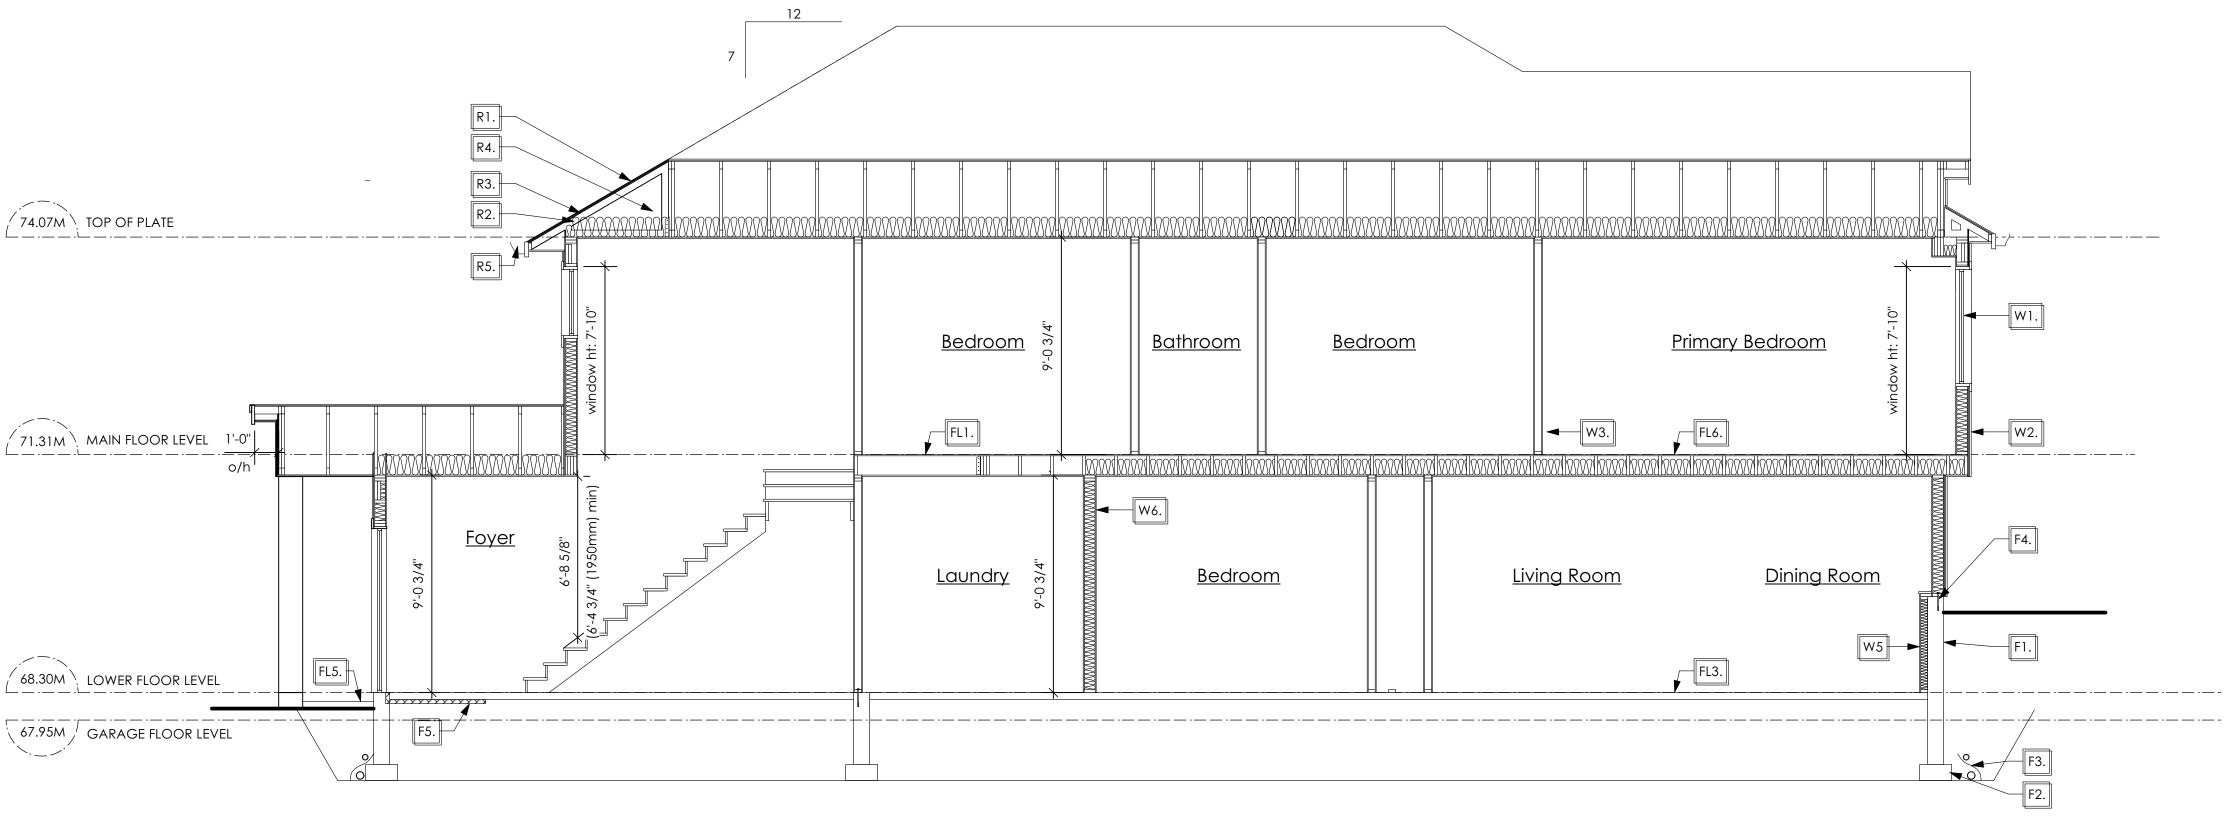

Section A-A

Scale: 1/4" = 1'-0"

STRUCTURAL WOOD ELEMENTS WITHIN 150MM (6") FROM FINISHED GROUND LEVEL SHALL BE PRESSURE TREATED WITH A PRESERVATIVE FOR TERMITE AND DECAY PROTECTION B.C.B.C. 2012 9.3.2.9.(3)

# SECTION NOTES

#### Roofs

- R1. LAMINATED ASPHALT SHINGLES ON
  7/16" ORIENTED STRAND BOARD C/W "H" CLIPS
  WD TRUSSES (DESIGNED BY MANUF.)
  14 1/2" FIBRE GLASS LOOSE FILL INSULATION
  (ALLOW FOR SETTLING)
  OR R-40 FIBRE GLASS BATT INSULATION
  6 MIL POLY'N V.B.
  5/8" GYPSUM BOARD
- R2. PROVIDE 2 1/2" (63mm) CLEAR BETWEEN R-20 INSULATION AND SHEATHING. (min. R-20 @ roof-wall connection for 4'-0" (1.2m) around perimeter of building. air ventelation baffles to be installed where required in as per BCBC 9.19.)
- R3. EAVE PROTECTION

  CONT. UP ROOF SLOPE FOR 12"

  PAST EXTERIOR WALL.
- R4. PROVIDE 1 SQ.FT. ATTIC VENT PER
  300 SQ.FT. OF INSULATED AREA MIN.
  25% OF REQUIREDTO BE @ TOP AND BOTTOM
  (to comply wi. B.C. bldg. code 9.19.1)
- R5. PRE-FN. FASCIA GUTTER
  2×8 FASCIA BD.
  2×4 SUB. FASCIA BD.
  VENTED SOFFIT
  (see contractor)

PRE MANUF SOFFIT
1/2" OSB BOARD
SUPPORTED BY 2"X4" FRAMING
REFER TO DETAIL 4 / D1
(to be applied in any soffit that has less then
1.20m clearance to any proverty line.
To comply with BC BUILDING CODE
9.10.15.5 (11) )
(AS REQUIRED, VERIFY ON SITE)
(NOT SHOWN IN SECTION)

#### **Floors**

- FL1. FINISHED FLOORING ON
  19/32" ORIENTED STRAND BOARD OR EQUAL
  (NAILED & GLUED TO FLOOR STRUCT. BELOW) ON
  2×10 FLOOR JOISTS @ 16" OR 12" O/C
  C/W 2×2 X-BRIDGING @ 7.0' O/C (MAX)
  1/2" GYPSUM BOARD
- FL2. FINISHED FLOORING ON
  19/32" ORIENTED STRAND BOARD OR EQUAL
  (NAILED & GLUED TO FLOOR STRUCT. BELOW) ON
  2×10 FLOOR JOISTS @ 16" OR 12" O/C
  C/W 2×2 X-BRIDGING @ 7.0' O/C (MAX)
  R-31 FIBRE GLASS BATT INSULATION
  5/8" X-TYPE GYPSUM BOARD
  (BETWEEN GARAGE AND LIVING SPACE)
  (NOT SHOWN IN SECTION)
- FL3. 3 1/2" CONCRETE SLAB 6 MIL. POLY'N V.B. 6" COMPACTED GRAVEL OR SAND
- FL4. 3 1/2" CONCRETE SLAB
  6 MIL. POLY'N V.B.
  6" COMPACTED GRAVEL OR SAND
  SLOPE TO DOORS 1"
  (NOT SHOWN IN SECTION)
- FL5. 3 1/2" CONCRETE SLAB

  (CONTRACTOR TO VERIFY EXTENT OF
  EXTERIOR SLABS AND FINISHES)

  (SLOPE AWAY FROM BUILDING @ 2% MIN.)
  6" COMPACTED GRAVEL OR SAND
- FL6. F8d RATED CEILING ASSEMBLY
  (BC BUILDING CODE TABLE 9.10.3.1.B)
  FINISHED FLOORING ON
  19/32" ORIENTED STRAND BOARD OR EQ.
  (FASTENED & GLUED TO FLOOR STRUCT. BELOW) ON
  2×10 FLOOR JOISTS @ 16" OR 12" O/C
  C/W 2×2 X-BRIDGING @ 7.0' O/C (MAX)
  R-31 INSULATION
  RESILIENT METAL CHANNELS @ 24" O/C
  1 LAYERS 5/8" X-TYPE GYPSUM BOARD
  30 MINUTE F.R.R., 50 S.T.C.

#### Walls

- W1. DOUBLE GLAZING
  ENERGY STAR LOW "E" RATING IN
  THERMAL BREAK FRAMES
  2/2"X10" LINTEL OVER (@ BEARING WALLS ONLY)
  (TYPICAL, WI. 2 1/2" XPS INSULATION)
  FLASHING OVER @ EXTERIOR
  (GLAZING IN ALL EXTERIOR DOORS & WITHIN 3 FT.
  OF EXTERIOR DOORS TO BE SHATTERPROOF (SP))
  WINDOW REQUIREMENTS DERIVED FROM BCBC
  TABLE C-5 AS PER BCBC 9.7.4.3. AND ARE TO BE
  USED TO SATISFY THE REQUIREMENTS OF
  AAMA/WDMA/CSA 101/I.S.2/A440, "NAFS":
  COLWOOD, CLASS R, DP 1440, PG 30, WATER RESIST. 220, A2,
  RATINGS MUST BE CLEARLY LABELED ON ALL
  WINDOW UNITS UPON INSTALLATION FOR INSPECTION.
- W2. CONC. FIBRE BOARD ON
  9.5MM (3/8") AIR SPACE / STRAPPING
  3/8"×2" BORATE TREATED PLYWOOD STRAPPING
  HOUSE WRAP (A.B.) (TYVEK OR EQ.)
  7/16" ORIENTED STRAND BOARD SHEATHING
  2×6 STUDS (SEE APCING BELOW)
  R-20 INSULATION
  6 MIL. POLYETHYLENE VAPOUR BARRIER
  1/2" GYPSUM BOARD
  (REFER TO DETAILS ON D1)
- W3. INTERIOR PARTITION
  1/2" GYPSUM BOARD ON EACH SIDE
  OF 2×4 STUDS (SEE SPACING BELOW) OR
  2×6 STUDS (SEE SPACING BELOW) (IF NOTED)

# W4. 5/8" X-TYPE GYPSUM BOARD ON 2×6 STUDS (SEE SPACING BELOW) R-20 INSULATION 6 MIL. POLY'N V.B 1/2" GYPSUM BOARD (BETWEEN GARAGE & LIVING)

- (NOT SHOWN IN SECTION)

  W5. 1/2" GYPSUM BOARD ON
  6 MIL. POLY'N V.B.
  2×4 STUDS (SEE SPACING BELOW)
  OR 2×6 STUDS (SEE SPACING BELOW) (IF NOTED)
  R-12 BATT INSULATION
  HOUSE WRAP (A.B.) (TYVEK OR EQ.) OR
  12.7MM (1/2") AIR SPACE
  (PROVIDE REQUIRED FIRE STOPS IN WALL
  ASSEMBLIES TO COMPLY WITH
  B.C. BLDG. CODE 9.10.16.)
- W6. B.C. BUILDING CODE (TABLE 9.10.3.1.A)
  RATED WALL ASSEMBLY W3c
  1 LAYER 1/2" X-TYPE GYPSUM BOARD
  RESILIENT METAL CHANNELS @ 24" O/C
  2×4 STUDS @ 16" O/C OR
  2×6 STUDS @ 16" O/C (IF NOTED) C/W
  3 1/2" FIBRE GLASS SOUND BATTS
  1 LAYER 1/2" X-TYPE GYPSUM BOARD
  45 MIN. F.R.R 43 S.T.C
  (BETWEEM PRIMARY LIVING & SECONDARY SUITE)
- W7. STUD SPACING
   UPPER FLOOR:
   MAIN FLOOR:
   LOWER FLOOR:
  (if applicable)
   INTERIOR PARTITION:

- LOAD BEARING:

- PARTY WALL

(if applicable)

#### 2"X6" @ 24" O/C 2"X6" @ 24" O/C 2"X6" @ 16" O/C : 2"X4"" @ 24" O/C 2"X4"" @ 16" O/C 2"X4"" @ 24" O/C

### **Foundation Walls**

- F1. DAMPROOFING (where required) ON 8" THK. CONC. FOUNDATION WALL C/W 15 M BARS @ 24" o/c B/W
- F2. 16"X 8" CONC. FOOTINGS

  C/W 2 (TWO) 15m BARS CONT. 3 IN. FROM BOTT.

  ON UNDISTURBED SOIL (SOLID BEARING)
- F3. 4" PERIMETER DRAIN 3" TIGHT PIPE FOR RWL DRAIN ROCK
- F4. ANCHOR BOLTS @ 4.0 FT. o/c MAX c/w SILL GASKETS
- 5. UNDER SLAB INSULATION
  2 1/2" (RSI 2.15) EXTRUDED POLYSTYRENE
  RIGID INSULATION 4'-0" (1.2M)
  CONT. AROUND PERIMETER UNDER
  SLAB INSTALLED HORIZONTALLY
  (VERIFY WITH MUNICIPALITY DEPTH OF FROST LINE)

'PORT' - COASTAL

Date

Dec 22 2022

Project Address
3469 Trumpeter Street
Royal Bay - Sector 7

Prepared for

Verity Construction

Colwood, B.C.

Project #

8298

**Scale**As Noted


Drawn By
MRB

# Development Permit Presentation


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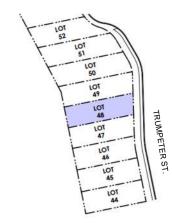
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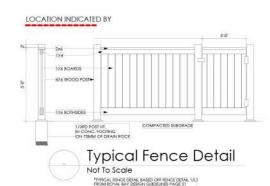


	ITEM	AREA (sf)	%
68	GARDEN BED	277	11%
	GRAVEL	480	19%
	CONCRETE	979	38%
	SOD	825	32%
	TOTAL	2,561	100%

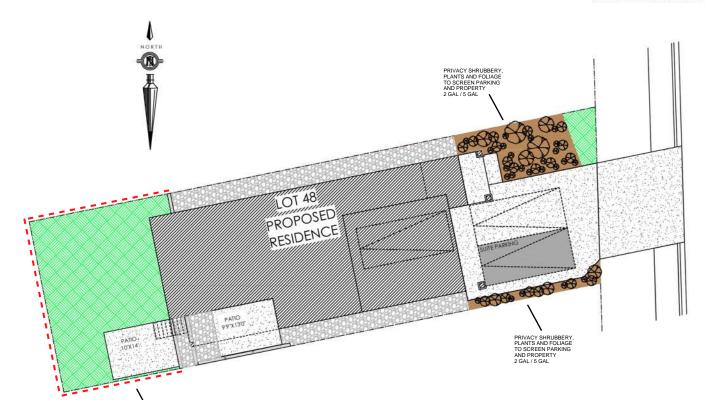

#### **KEY PLAN** NOT TO SCALE



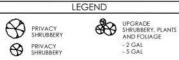

# ADDITIONAL NOTES:

PROPERTY TO BE IRRIGATED 6" PIPE FOR DRIVEWAY SLEEVES TO BE INSTALLED FOR CITY IRRIGATION LINES

Stakes	-1 1	1 1	
100mm (4") Depth Mulch. Keep Mulch 100mm aff Trunk	+	1	
100mm (4") Depth Mulch.	Min. 750mm	Win 750mm	Roof Flore to be 25-50mm Above Adjacent Growing Medium
Tree FEIch. "Offern Deep.			Finished Grade
		Set Roofball on	Compacted Subgrade
Tre	e Plar	nting	Detail
All tree	Scale es and plants by ed in minimum 10		er to be soil, 700mm Deep

	MM/DD/YY	ISSUED/REVISED
01	09/30/22	FOR APPROVAL
02	10/12/22	GARDEN BED PLANTING
03	01/03/23	REVISION AS PER CITY OF COLWOOD

ESTIMATED LOCATION OF REAR FENCING - SUBJECT TO CHANGE ACCORDING TO

ACTUAL SITE CONDITIONS

**PROJECT** 

DATE

LANDSCAPING PLAN LOT 48, 3469 TRUMPETER ST. **ROYAL BAY, SECTOR 7** CITY OF COLWOOD

LANDSCAPE PLAN

NOT TO SCALE



QUALITY CONSTRUCTION. TRUSTED SERVICE.

106 - 1039 Langford Parkway Victoria, B.C. V9B 0A6

P: 250.474.1039 www.verityconstruction.ca

# GABLECTART HOMES BUILDING GRADE SLIP

WSP	Project	No:	201-08151-00
	,		

C. Hume - October 13/22

Issue Date: \_

MUNICIPAL ADDRESS 3469 Trumpeter Street	P.I.D.
LOT 48	PLAN
VERITY HOMES	SUBDIVISION
ADDRESS	ROYAL BAY SECTOR 7  DEVELOPER
REPRESENTATIVE PH.	MEADOWS DEVELOPMENT LP CONSULTANT
DDODOCED DIWINIO ODADEC	WSP CANADA INC
PROPOSED BUILDING GRADES  ALL ELEVATIONS ARE METRIC GEODETIC +	PLAN LOT: 48 PLAN:
MAIN FLOOR ELEVATION 71.31	TRUMPETER ST.
(TOP OF JOISTS)  FRONT ELEV 68.00 REAR ELEV 69.55/96.30  JOIST DEPTH	
(FINISHED GRADE) (FINISHED GRADE)	
FINISHED GRADE AT GARAGE 67.95	67.69
HEADROOM	[9]
HEAL	<u>87.95</u>
ACTUAL TOP OF FOOTING	98 49 18 19 19 19 19 19 19 19 19 19 19 19 19 19
ELEVATION (ATF)  LOWEST PERMITTED TOP OF not provided FLOOR SLAB	EG 67.9 (18)
FOOTING ELEVATION (LTF) (BOTTOM OF BASEMENT SLAB FROST WALLS ARE REQUIRED.)	MFE 68.36 GFE 68.16 MSE 64.99
CERVICES FRONT READ CENTER REFER SIZE	S 64.49 D 64.58 LB·
SERVICES FRONT REAR CENTER REFER SIZE TO PLAN (mm)	*(E)
WATER 19	
SANITARY	7 27
STORM   100	<u></u>
COMMENTS YES NO	
DRAIN TO SUMP PUMP LIKELY REQUIRED  (FOR BASEMENT IF INSTALLED)	
SEWER TO SUMP PUMP LIKELY REQUIRED	LEGEND
(FOR BASEMENT IF INSTALLED)	STREET
SERVICES INSTALLED TO m INSIDE PROPERTY	が ≱             - SERVICE LOCATION
FOUNDATION SOIL BEARING INVESTIGATION CERTIFICATION REQUIRED	SROW (SHOWN ON ABOVE PLAN)
GEOTECHNICAL RESTRICTIONS APPLY (SEE GEOTECHNICAL REPORT)	PROPOSED FRONT CORNER ELEVATIONS  PROPOSED FRONT SIDE YARD GRADES  L# 6  L# 6  L# 6
ENVIRONMENTAL RESTRICTIONS APPLY	L# 6 L# 6 LEGAL LOT NUMBER
(SEE ENVIRONMENTAL REPORT)	EG 49.90 EG 49.90 EG 49.90
UTILITY EASEMENTS AFFECT THIS LOT	GFE 47.55 - LOWER/MAIN FLOOR ELEVATION  GFE 47.55 - GARAGE FLOOR ELEVATION
	MSE 52.20 - MINIMUM SANITARY SERVICABLE ELEVATION BY GRAVITY
	S 49.12 (P) D 49.12 (P) S 49.12 (P) D ENOTES PUMP IS LIKELY REQUIRED
	FOR BASEMENT IF INSTALLED  STORM SERVICE INV.
	(P) DENOTES PUMP IS LIKELY REQUIRED FOR BASEMENT IF INSTALLED  PROPOSED REAR SIDE YARD GRADES
	[2] L (28) - FROPOSED REAR SIDE TARD GRADES
NOTES	- LOT TYPE (L/LB/LBT) - PROPOSED REAR CORNER ELEVATIONS
IT IS THE RESPONSIBILITY OF THE BUILDER TO ENSURE THE FOOTINGS     ARE PLACED ON A PROPER BASE THAT IS FREE FROM FROST,	LANE/LOT
EXCESSIVE MOISTURE AND DELETERIOUS MATERIALS AND HAVE APPROPRIATE FROST PROTECTION WHEN COMPLETED.	
2. THE INFORMATION CONTAINED HEREIN IS BASED ON THE APPROVED	
LOT GRADING PLAN FOR THIS SUBDIVISION. UN-AUTHORIZED DEVIATIONS WILL BE THE RESPONSIBILITY OF THE BUILDER TO ENSURE COMPLIANCE WITH ALL LOCAL BYLAWS.	I, THE BUILDER'S REPRESENTATIVE,  CERTIFY THAT THE FINAL HOUSE PLANS PROVIDED IN THE BUILDING PERMIT
3. OTHER NOTES:	APPLICATION ARE THE SAME AS PROCESSED UNDER THIS GRADE SLIP AND THAT I UNDERSTAND THE INFORMATION AND THE REQUIREMENTS CONTAINED HEREIN AND WILL BUILD ACCORDINGLY.
	THE WILL HAVE THE BOILD ROUGHDINGET.
	AUTHORIZED BUILDER'S REPRESENTATIVE DATE
	THE INFORMATION CONTAINED HEREIN IS BASED ON THE APPROVED LOT GRADING PLAN FOR THIS SUBDIVISION, DATED