


# CITY OF COLWOOD

## PROJECT NAME: ALLANDALE PIT PUMPING SYSTEM

### INDICATIVE DESIGN

Sheet List Table	
Allandale Pit Pumping System	
Sheet Number	Sheet Title
0	Cover Page
1	Overall Site Plan – Ortho
2	Overall Site Plan
3	General Arrangement Plan – Ortho
4	General Arrangement Plan
5	Details – Manhole Views
6	Proposed Tube Feeding – Plan and Profile – Guidance Only
7	Steel Storage Container – General Arrangement
8	Proposed Site – Lift Station
9	Site – Piping and Instrumentation Diagram

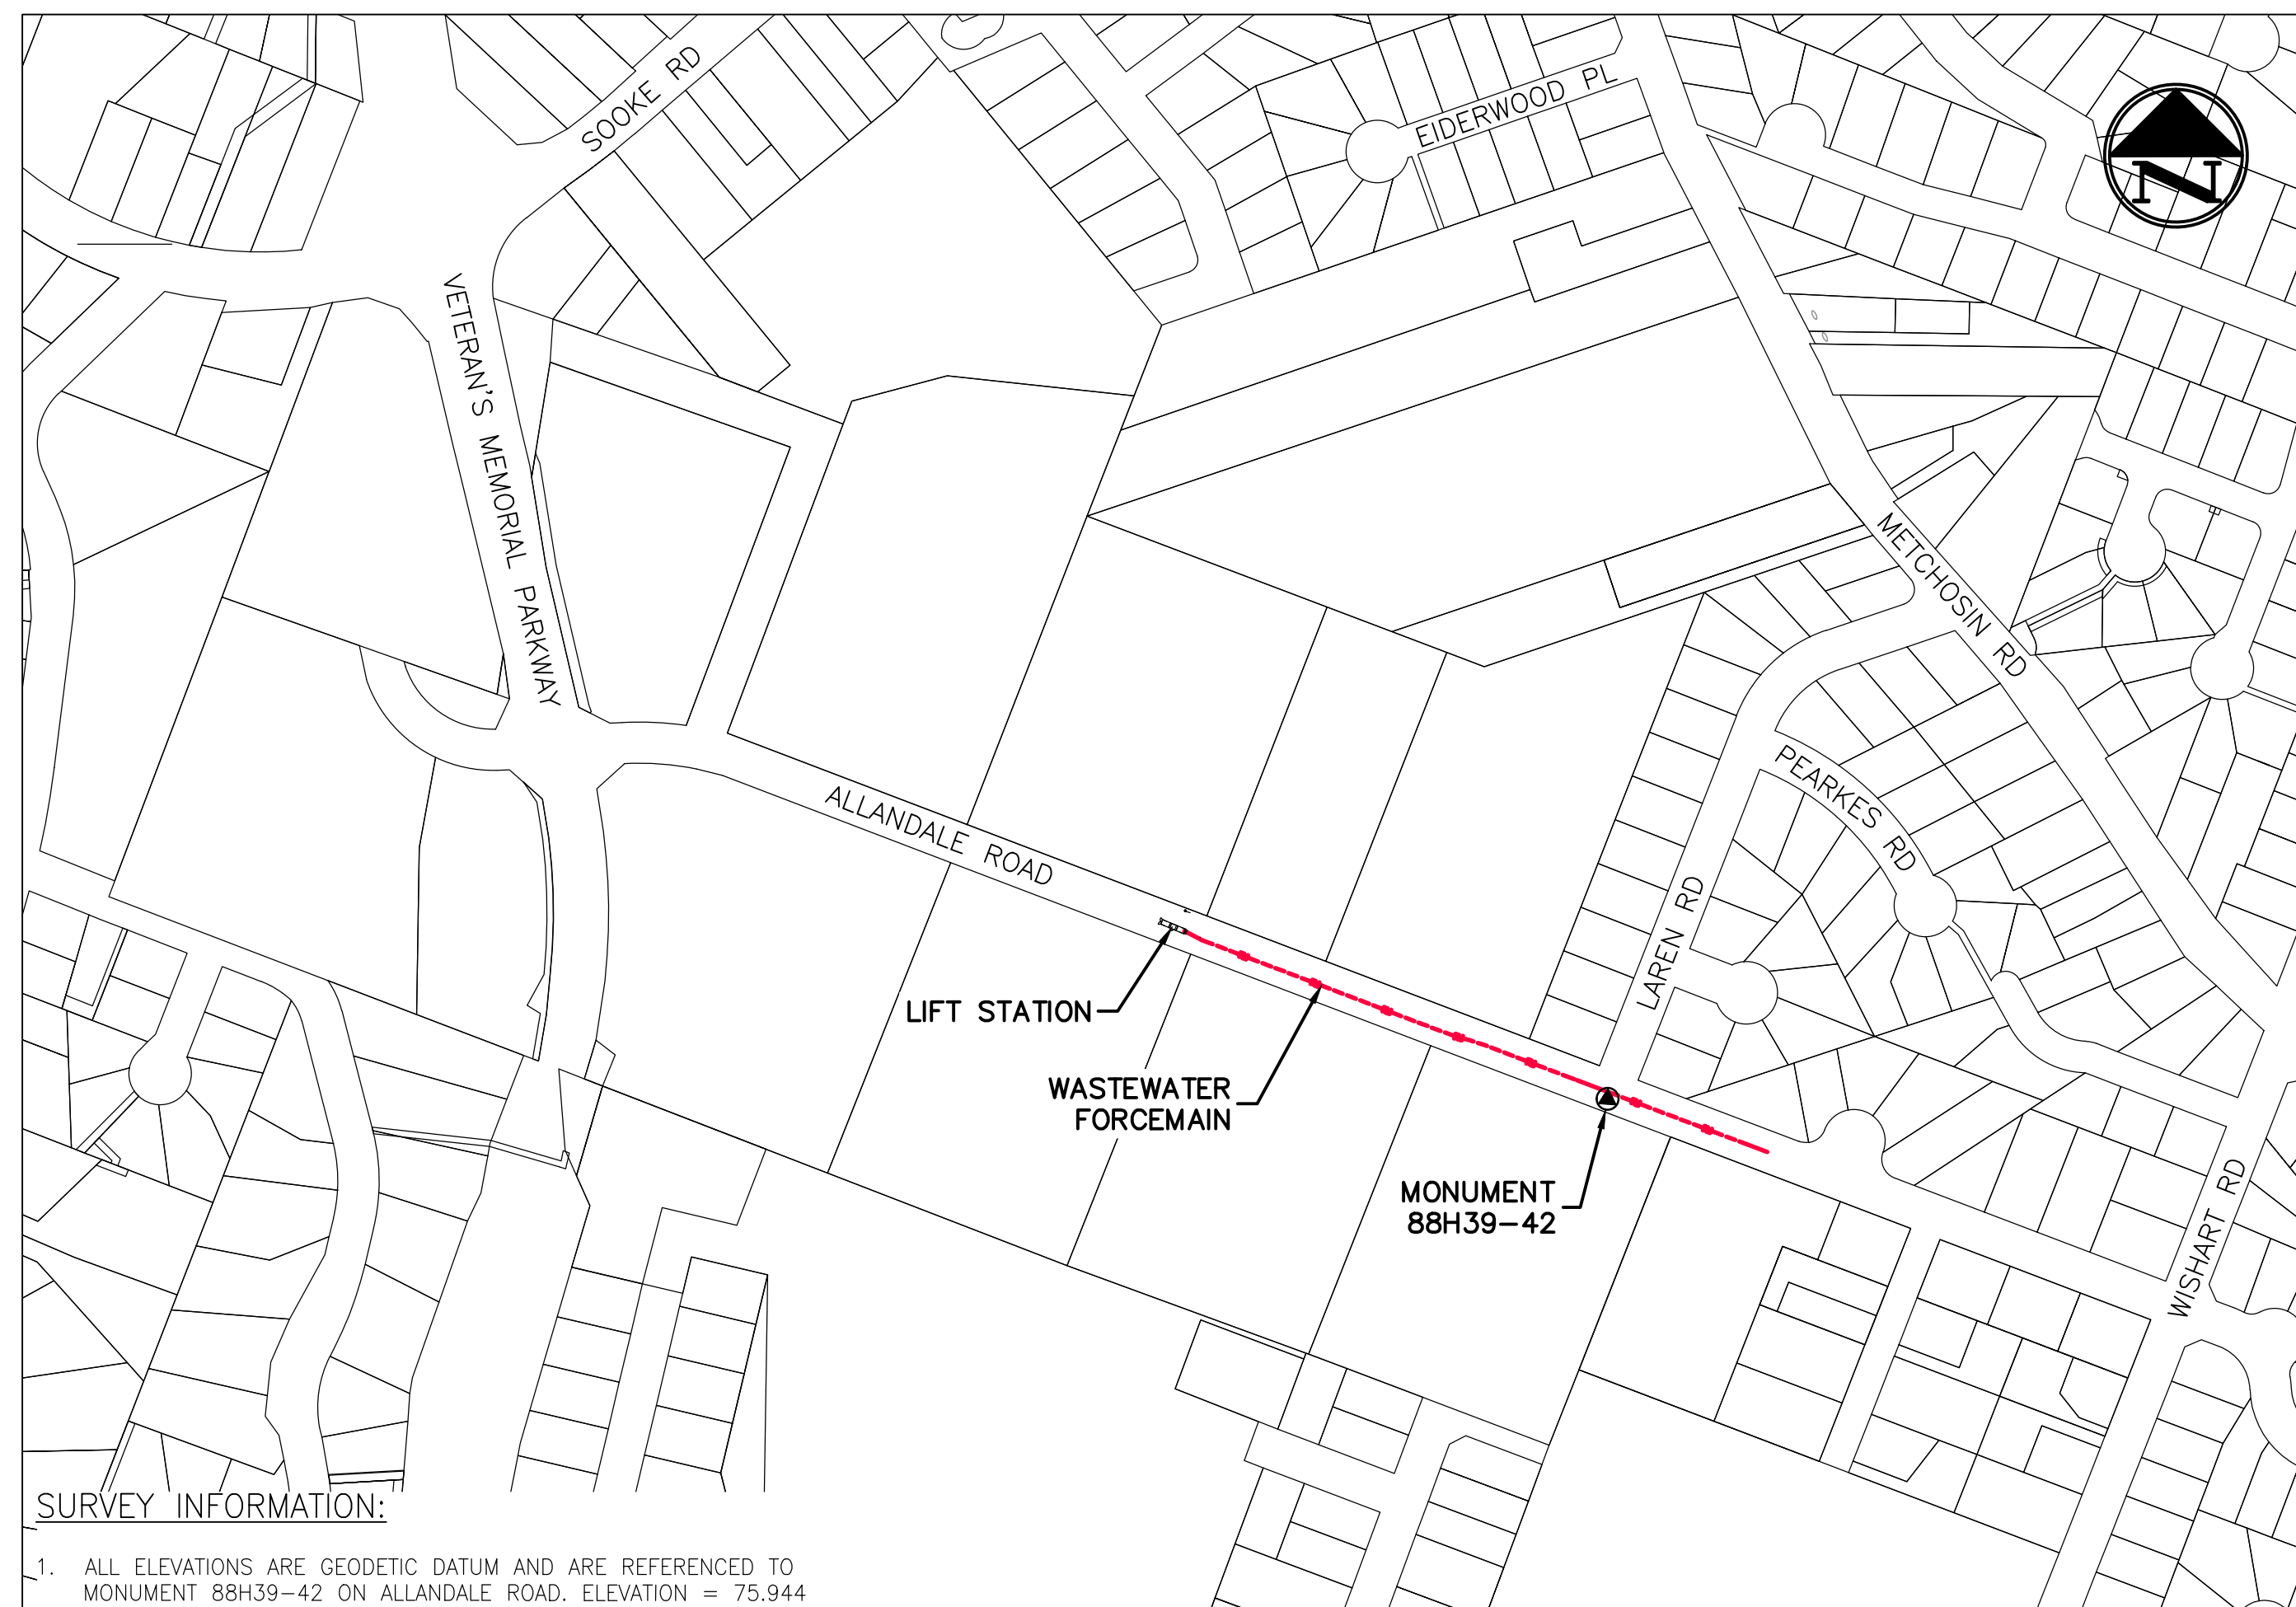

LOCATION PLAN  
SCALE: 1:3,000m

SURVEY INFORMATION:  
1. ALL ELEVATIONS ARE GEODETIC DATUM AND ARE REFERENCED TO MONUMENT 88H39-42 ON ALLANDALE ROAD. ELEVATION = 75.944

#### CONSTRUCTION NOTES:

##### 1.0 GENERAL CONSTRUCTION NOTES:

- ALL CONSTRUCTION AND MATERIALS SHALL CONFORM TO CONTRACT DOCUMENT, MASTER MUNICIPAL CONSTRUCTION DOCUMENTS (MMCD), MMCD SUPPLEMENTS.
- REPAIR AND/OR REPLACE ALL INFRASTRUCTURE/PRIVATE PROPERTY DAMAGED OR REMOVED DURING CONSTRUCTION, TO BETTER THAN, OR EQUAL TO PRE-CONSTRUCTION CONDITION AND TO THE SATISFACTION OF THE CITY ENGINEER.
- RESTRICT ALL WORK TO CITY OF COLWOOD RIGHT-OF-WAY. NO ENCROACHMENT ONTO PRIVATE PROPERTY IS PERMITTED.
- CONTACT BC1CALL AT 1-800-474-6886 FOR EXTERNAL UTILITY LOCATIONS AT LEAST 72 HOURS PRIOR TO THE START OF CONSTRUCTION. CONTACT ALL OTHER RELEVANT SERVICE PROVIDERS FOR UTILITY LOCATIONS AT LEAST 72 HOURS PRIOR TO START OF CONSTRUCTION. NOT ALL UTILITIES MAY BE SHOWN. IT IS THE CONTRACTORS RESPONSIBILITY TO LOCATE ALL UTILITIES PRIOR TO CONSTRUCTION AT NO EXTRA COST TO THE CONTRACT. EXISTING GAS AND WATER MAINS ARE UNDER PRESSURE AND THE CONTRACTOR IS TO TAKE ALL PRECAUTIONS TO PROTECT AND MAINTAIN ALL EXISTING ACTIVE UTILITIES DURING CONSTRUCTION.
- BC HYDRO, TELUS, SHAW CABLE AND FORTISBC FACILITIES ARE SHOWN SCHEMATICALLY ON THESE DRAWING. ACTUAL LOCATION MAY DIFFER. REFER TO UTILITY COMPANY DRAWINGS (BC1 CALL) FOR CONSTRUCTION DETAILS.
- EXCAVATE AND CONFIRM LOCATION AND ELEVATION OF EXISTING SEWER, DRAIN AND WATER MAINS AND UTILITIES AT ALL CROSSINGS AND CONNECTION POINTS A MINIMUM OF 72 HOURS PRIOR TO CONSTRUCTION. WHERE INFORMATION DOES NOT MEET REQUIREMENTS OF CONTRACT, CONTACT CONTRACT ADMINISTRATOR. ENSURE THAT NEW UTILITIES CAN BE TIED INTO EXISTING UTILITIES FOR STRAIGHT TIE-IN AT EXISTING ELEVATION.
- ENSURE ALL EXISTING SERVICES STAY IN OPERATIONAL CONDITION DURING CONSTRUCTION. PROVIDE BYPASS PUMPING AS REQUIRED TO CONSTRUCT WORKS.
- BACKFILL SEWER, DRAIN AND WATER MAINS AND UTILITY TRENCH AS PER MMCD STD. DWG. G4 IN ACCORDANCE WITH MMCD SECTION 31 23 01. BED ALL PIPE USING CLASS 'B' BEDDING. IN ROAD, PIPES TO HAVE CLASS B BEDDING WITH FULL DEPTH GRAVEL BACKFILL.
- WHERE A TRENCH IS UNDER OR WITHIN 1.00m OF THE EDGE OF A ROAD OR DRIVEWAY, USE IMPORTED GRANULAR BACKFILL FROM THE TOP OF THE PIPE BEDDING TO THE TOP OF THE ROAD, PARKING OR DRIVEWAY SUBGRADE.
- ALL UNUSED EXCAVATED TRENCH AND SUB-EXCAVATION MATERIALS MAY BE DISPOSED IN THE RIGHT-OF-WAY.
- ALL SURVEY LAYOUT SHALL BE PROVIDED BY THE CONTRACTOR AT THE CONTRACTORS EXPENSE.
- BE RESPONSIBLE FOR AND PAY FOR ALL TRENCH DE-WATERING.
- REMOVE AND REPLACE MONUMENTS AS NECESSARY FOR CONSTRUCTION OF WORK AT NO COST TO THE OWNER. REPLACEMENT MONUMENTS SHALL BE SURVEYED BY A LICENSED BCLS.
- ACQUIRE CITY OF COLWOOD PERMIT TO ALTER OR CONSTRUCT ON CITY RIGHT-OF-WAY AS PER CONTRACT DOCUMENTS.
- MAINTAIN VEHICULAR, CYCLIST AND PEDESTRIAN ACCESS THROUGH THE SITE DURING CONSTRUCTION.
- PROVIDE SECURITY FENCING AND BARRICADES DURING CONSTRUCTION TO DELINEATE PROJECT SITE AS REQUIRED TO PROTECT PEDESTRIAN TRAFFIC.

##### 2.0 SEWER NOTES:

- SEWER PVC PIPE SHALL BE HDPE AS NOTED ON THE DRAWINGS AND CALLED FOR IN THE CONTRACT DOCUMENTS.
- INSTALL SECONDARY PUMP STATION 75mm FORCE MAIN AS CALLED FOR ON THE DRAWINGS OR ALTERNATIVELY CONNECT THE 75 mm FORCEMAIN TO THE PUMP STATION WET WELL. PROVIDE ALTERNATIVE AND COST IMPLICATIONS IN TO REQUEST FOR PROPOSAL. INSTALL SEWER PIPING IN ACCORDANCE WITH MMCD SECTION 33 30 01 UNLESS OTHERWISE SPECIFIED.
- EXCAVATION, TRENCHING AND BACKFILL TO BE IN ACCORDANCE WITH MMCD SECTION 33 23 01.

- DO NOT START ANY BACKFILL OPERATION UNTIL THE WORKS HAVE BEEN INSPECTED BY THE CONTRACT ADMINISTRATOR.
- THE INTENT IS TO INSTALL THE 150mm FORCE MAIN IN THE EXISTING INACTIVE 300mm DIAMETER SEWER FORCE MAIN IN ACCORDANCE WITH MMCD SECTION 33 05 23, EXCEPT THAT WE ARE NOT BURSTING THE EXISTING PIPE, MERELY USING IT AS A CASING.
- SEWER MAINS MUST BE PRESSURE TESTED TO 1.5 TIMES THE WORKING PRESSURE AND VIDEO INSPECTED IN ACCORDANCE WITH MMCD SECTION 33 01 30.1. SUBMIT TEST REPORTS TO CITY OF COLWOOD UPON COMPLETION.
- ISOLATION OF SEWAGE ENTERING MANHOLE AS REQUIRED TO MAINTAIN OPERATION DURING CONSTRUCTION. LOCATION OF PUMP OUT AND DISPOSAL LOCATION OF SEWAGE IS TO BE REVIEWED WITH THE CITY OF COLWOOD.
- PROVIDE AND PAY FOR ALL WATER FOR TESTING. OBTAIN AND PAY FOR CITY OF COLWOOD PERMIT TO CONNECT TO CITY FIRE HYDRANT.
- TENDERERS ARE ENCOURAGED TO REVIEW THE DRAWINGS AND SPECIFICATIONS AND PROVIDE AN ALTERNATIVE TENDER IN ACCORDANCE WITH MMCD INSTRUCTIONS TO TENDERERS – PART II. TENDERERS MAY REQUEST APPROVED EQUALS DURING THE RFP PHASE IN ACCORDANCE WITH MMCD INSTRUCTIONS TO TENDERERS – PART II.

##### 3.0 ENVIRONMENTAL NOTES:

- USE BEST MANAGEMENT PRACTICES AND MMCD SECTION 01 57 01 DURING CONSTRUCTION. ADJUST WORK ACTIVITIES DURING PERIODS OF HEAVY RAIN TO MINIMIZE SEDIMENTS ENTERING THE STORM DRAINAGE SYSTEM. SOME BMP'S TO CONSIDER:
- CHECK ALL EQUIPMENT FOR FLUID LEAKS PRIOR TO ENTERING THE WORK AREA.
  - NO EQUIPMENT RE-FUELING TO OCCUR IN THE WORK AREA UNLESS SPILL PROTECTION MEASURES ARE IN PLACE.
  - A SPILL KIT IS TO BE MAINTAINED ON SITE THROUGHOUT THE CONSTRUCTION PERIOD.
  - COVER EXPOSED SOILS AND GRAVELS IN INCLEMENT WEATHER ie TARP, HYDRO SEED OR ORGANIC LEAF MULCH.
  - STOCKPILE SOILS AND GRAVELS AND ENSURE THEY ARE COVERED IF LEFT FOR MORE THAN 48 HOURS.
  - SURROUND PROTECTED TREES WITH SNOW FENCING AT DRIP LINE OR CRITICAL ROOT ZONE OF TREE DURING CONSTRUCTION.
  - OWNER WILL ENGAGE INDEPENDENT CONSULTANT TO PROVIDE GUIDANCE TO CONTRACTOR IN EXCAVATING, SEGREGATION AND CHARACTERIZATION OF SUSPECT CONTAMINATED SOIL ENCOUNTERED DURING TRENCH EXCAVATION.



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No.	DATE	REVISION	ENGR	EXISTING	PROPOSED	EXISTING	PROPOSED	EXISTING	PROPOSED	EXISTING	PROPOSED
A	3/2017	INDICATIVE DESIGN	LS	<ul style="list-style-type: none"> <li>MANHOLE</li> <li>CLEANOUT</li> <li>LIFT STATION</li> <li>INSPECTION CHAMBER</li> <li>CATCH BASIN</li> <li>SILT TRAP</li> <li>SEEPAGE PIT</li> <li>CULVERT</li> <li>DITCH</li> <li>HYDRANT</li> <li>WATER VALVE</li> <li>FLUSH VALVE</li> </ul>	<ul style="list-style-type: none"> <li>AIR VALVE</li> <li>WATER METER</li> <li>IRRIGATION VALVE</li> <li>UTILITY MANHOLE *</li> <li>SERVICE BOX *</li> <li>LPT</li> <li>UTILITY POLE *</li> <li>POLE-MOUNT LS</li> <li>ORNAMENTAL LUMINAIRE</li> <li>TRAFFIC SIGNAL</li> </ul>	<ul style="list-style-type: none"> <li>SANITARY</li> <li>SANITARY FORCEMAIN</li> <li>STORM DRAIN</li> <li>WATER</li> <li>GAS</li> <li>ELECTRICAL</li> <li>ROAD CURB</li> <li>EDGE OF PAVEMENT</li> <li>DRIVEWAY</li> <li>SIDEWALK</li> <li>PROPERTY LINE</li> <li>EASEMENT</li> </ul>	<ul style="list-style-type: none"> <li>FENCE</li> <li>SLOPE - TOP</li> <li>SLOPE - BOTTOM</li> <li>CONTOUR - MAJOR</li> <li>CONTOUR - MINOR</li> <li>BOUNDARY</li> <li>BUILDING ENVELOPE</li> <li>VEGETATION LINE</li> </ul>	<ul style="list-style-type: none"> <li>N/A</li> </ul>	<ul style="list-style-type: none"> <li>BENCHMARK:</li> <li>ELEVATION:</li> </ul>		






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DESIGN	LS	SEAL
DRAWN	MT	
CHECKED	DM	
ENGINEER	LS	

PROJECT:	<b>ALLANDALE PIT</b>	COLWOOD FILE NO.	RFP-2017-01
TITLE:	<b>PUMPING SYSTEM OVERALL SITE PLAN - ORTHO</b>	COLWOOD CONTRACT NO.	RFP-2017-01
DATE:	2017-03-21	SCALE:	AS NOTED
DRAWING NO.	DWG-J0001	SHEET:	1 of 9
		REV:	INP



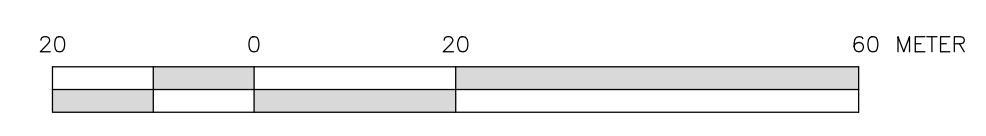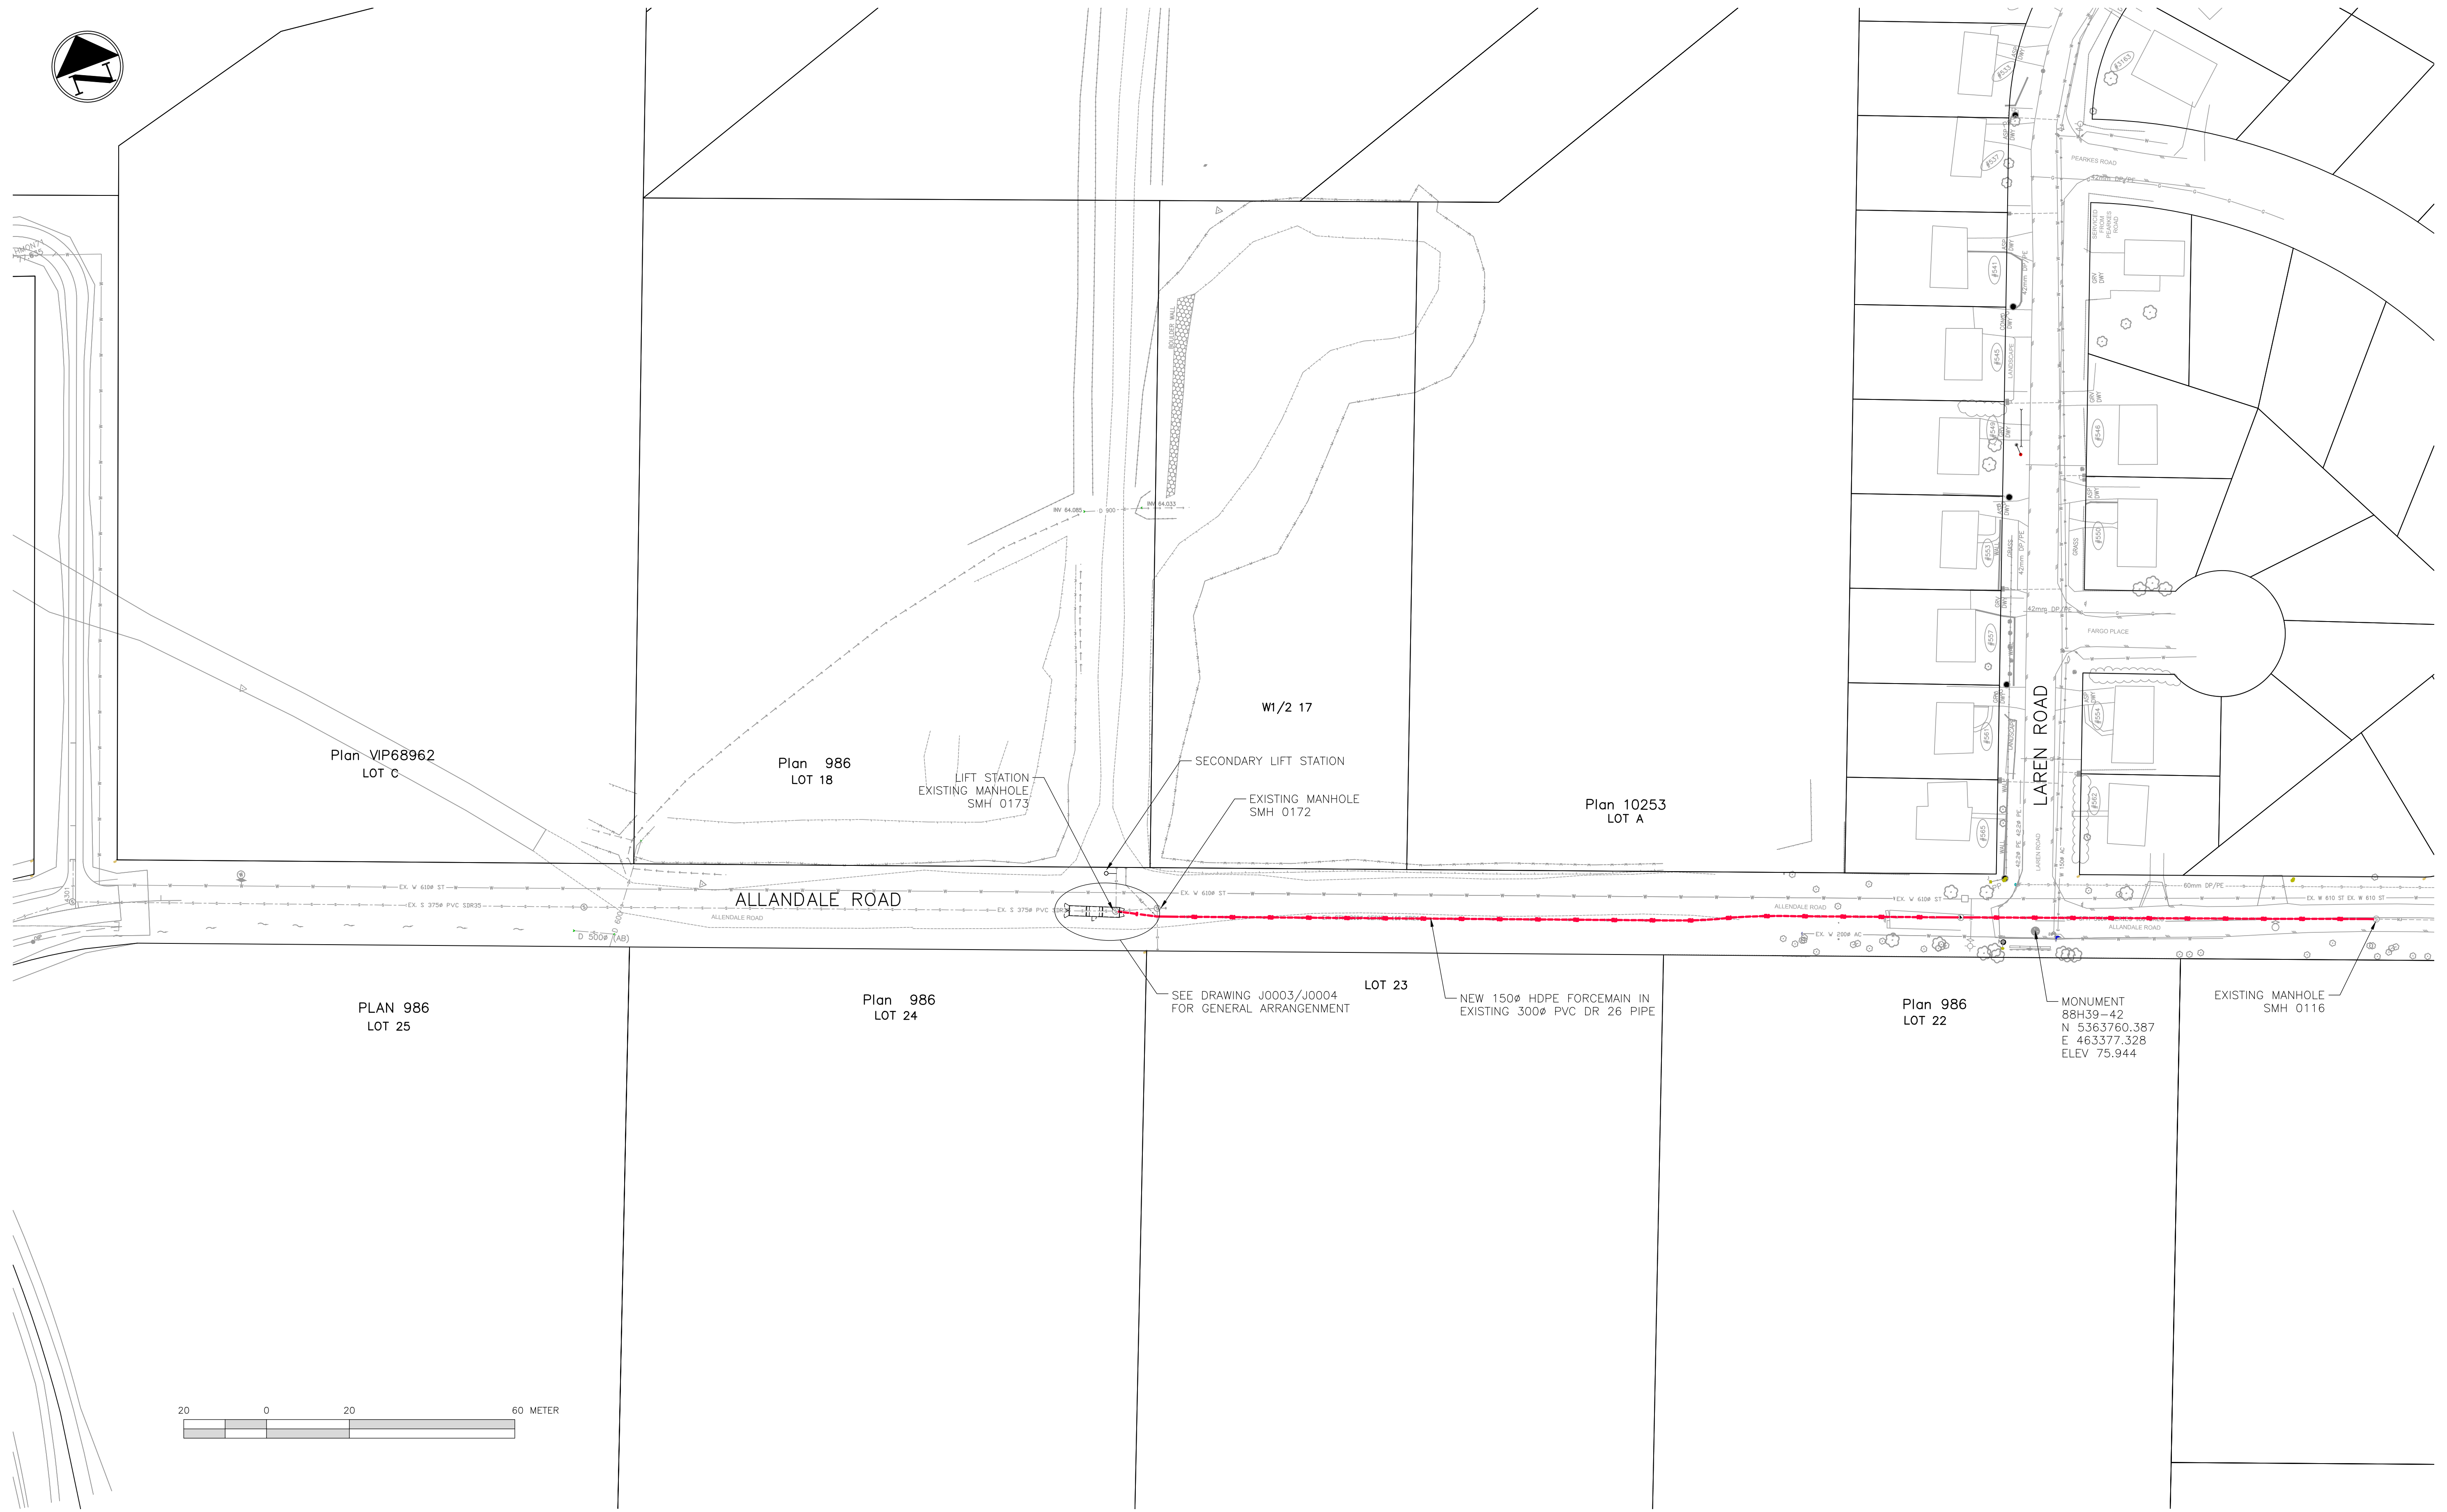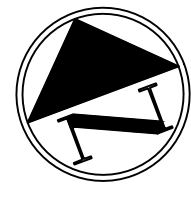

No.	DATE	REVISION	ENGR	EXISTING	PROPOSED	EXISTING	PROPOSED	EXISTING	PROPOSED	EXISTING	PROPOSED
A	3/2017	INDICATIVE DESIGN	LS	<ul style="list-style-type: none"> <li>MANHOLE</li> <li>CLEANOUT</li> <li>LIFT STATION</li> <li>INSPECTION CHAMBER</li> <li>CATCH BASIN</li> <li>SILT TRAP</li> <li>SEEPAGE PIT</li> <li>CULVERT</li> <li>DITCH</li> <li>HYDRANT</li> <li>WATER VALVE</li> <li>FLUSH VALVE</li> </ul>	<ul style="list-style-type: none"> <li>AIR VALVE</li> <li>WATER METER</li> <li>IRRIGATION VALVE</li> <li>UTILITY MANHOLE *</li> <li>SERVICE BOX *</li> <li>LPT</li> <li>UTILITY POLE *</li> <li>POLE-MOUNT LS</li> <li>ORNAMENTAL LUMINAIRE</li> <li>TRAFFIC SIGNAL</li> </ul>	<ul style="list-style-type: none"> <li>SANITARY</li> <li>SANITARY FORCEMAIN</li> <li>STORM DRAIN</li> <li>WATER</li> <li>GAS</li> <li>ELECTRICAL</li> <li>ROAD CURB</li> <li>EDGE OF PAVEMENT</li> <li>DRIVEWAY</li> <li>SIDEWALK</li> <li>PROPERTY LINE</li> <li>EASEMENT</li> </ul>	<ul style="list-style-type: none"> <li>FENCE</li> <li>SLOPE - TOP</li> <li>SLOPE - BOTTOM</li> <li>CONTOUR - MAJOR</li> <li>CONTOUR - MINOR</li> <li>BOUNDARY</li> <li>BUILDING ENVELOPE</li> <li>VEGETATION LINE</li> </ul>	<ul style="list-style-type: none"> <li>N/A</li> </ul>	<ul style="list-style-type: none"> <li>BENCHMARK:</li> <li>ELEVATION:</li> </ul>		
				*SUBSTITUTE L,C,T AS REQUIRED							



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ENGINEER	LS	

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DATE:	2017-03-21	SCALE:	AS NOTED
DRAWING NO.	DWG-J0002	SHEET:	2 of 9
		REV:	INP





- NOTES FOR INSTALLATION:**
- CUT AND REMOVE AS REQUIRED EXISTING 300Ø 160 DR26 TO INSTALL WORK. INSTALL FLANGE (CLASS 150) AND BOLT BLIND FLANGE. REMOVE AND DISPOSE OF PIPE OFFSITE.
  - DISCONNECT/CUT EXISTING 300Ø AND OPEN EXISTING SFM 300Ø 160 DR26 LINE. CONTRACTOR TO FEED 150Ø DR17 HDPE LINE THROUGH EXISTING SANITARY FORCE MAIN TERMINATING AT SMH 0116 LOCATED AT (NW74.053, SE73.889). PROVIDE END SEAL CLOSURES BETWEEN NEW FORCEMAIN AND EXISTING PIPE.
  - LOCATE ENCLOSURE OVER EXISTING MANHOLE. GRADE AND GRUB EXISTING AREA UNDER THE ENCLOSURE AND PLACE LEVELING COURSE OF 19mm CRUSHED BASE MATERIAL. COMPACT SUBGRADE AND SET ENCLOSURE ON LEVEL SUBGRADE.
  - PROVIDE A 900Ø DIAMETER SECONDARY LIFT STATION DRILLED TO 12m. WELL TO BE CASED WITH 900mm THICK CONCRETE PLUG AND AS CALLED FOR ON THE DRAWINGS AND CONTRACT DOCUMENTS.
  - TRENCH AND INSTALL 75mmØ FORCE MAIN TO CONNECT NEW SECONDARY LIFT STATION TO EXISTING 375mmØ LIND\_02. OR ALTERNATIVELY TO THE NEW PUMP STATION OR 200Ø PVC SDR35. THE PROPOSED PIPING INTERCONNECTION IS AN INDICATIVE DESIGN AND ASSUMES FLEXIBLE SPOOL SECTION WITH FLANGED END CONNECTIONS. SUBMERSIBLE GUIDE RAIL IS ACCEPTABLE IF CONTRACTOR CAN FIT IN PROPOSED WET WELL. ALTERNATIVES THAT CROSS THE WATERMAIN MUST BE IN ACCORDANCE WITH CRD WATER SERVICES ENGINEERING MANUAL.
  - SEE DIAGRAM PID-P0001 FOR LINE IDENTIFICATIONS.
  - A MINIMUM 3.0m HORIZONTAL CLEAR SEPARATION AND 450mm CLEAR VERTICAL SEPARATION SHALL BE MAINTAINED BETWEEN WATERMANS AND ALL SANITARY/SERVICES EXCEPT WHERE NOTED AND APPROVED BY THE CITY OF COLWOOD AND CRD.



No.	DATE	REVISION	ENGR	EXISTING	PROPOSED	EXISTING	PROPOSED	EXISTING	PROPOSED	EXISTING	PROPOSED
A	3/2017	INDICATIVE DESIGN	LS	○ MANHOLE ○ CLEANOUT ○ LIFT STATION ○ INSPECTION CHAMBER ○ CATCH BASIN ○ SILT TRAP ○ SEEPAGE PIT ○ CULVERT ○ DITCH ○ HYDRANT ○ WATER VALVE ○ FLUSH VALVE	● AIR VALVE ● WATER METER ● IRRIGATION VALVE ● UTILITY MANHOLE * ● SERVICE BOX * ● LPT ● UTILITY POLE * ● POLE-MOUNT LS ● ORNAMENTAL LUMINAIRE ● TRAFFIC SIGNAL *SUBSTITUTE L,C,T AS REQUIRED	— SANITARY — SANITARY FORCEMAIN — STORM DRAIN — WATER — GAS — ELECTRICAL — ROAD CURB — EDGE OF PAVEMENT — DRIVEWAY — SIDEWALK — PROPERTY LINE — EASEMENT	— SANITARY — SANITARY FORCEMAIN — STORM DRAIN — WATER — GAS — ELECTRICAL — ROAD CURB — EDGE OF PAVEMENT — DRIVEWAY — SIDEWALK — PROPERTY LINE — EASEMENT	— FENCE — SLOPE - TOP — SLOPE - BOTTOM — CONTOUR - MAJOR — CONTOUR - MINOR — BOUNDARY — BUILDING ENVELOPE — VEGETATION LINE BENCHMARK: ELEVATION:	— FENCE — SLOPE - TOP — SLOPE - BOTTOM — CONTOUR - MAJOR — CONTOUR - MINOR — BOUNDARY — BUILDING ENVELOPE — VEGETATION LINE BENCHMARK: ELEVATION:		




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DESIGN LS  
 DRAW MT  
 CHECKED DM  
 ENGINEER LS


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TITLE: <b>PUMPING SYSTEM GENERAL ARRANGEMENT PLAN - ORTHO</b>	COLWOOD CONTRACT NO. RFP-2017-01
DATE: 2017-03-21	SCALE: AS NOTED
DRAWING NO. DWG-J0003	SHEET: 3 of 9
	REV: INP





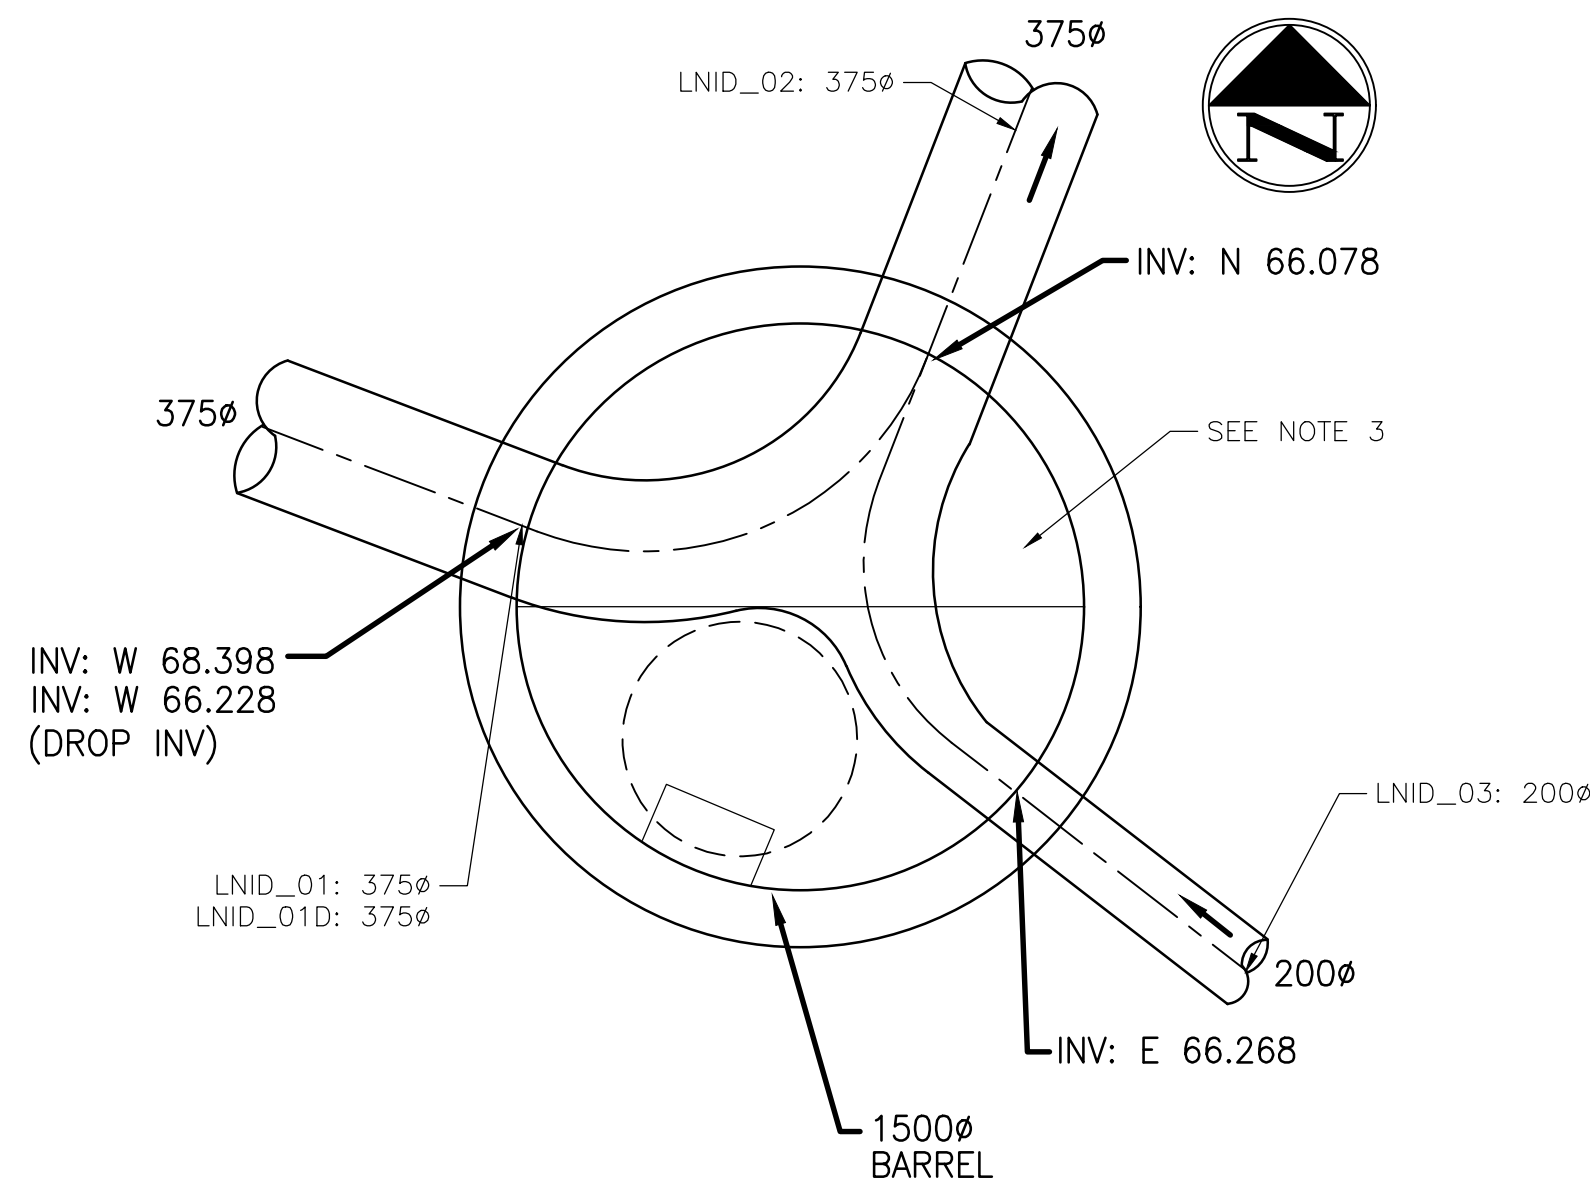


PLAN VIEW – SMH ALL 05 (SMH 0173)  
FIRST LIFT STATION

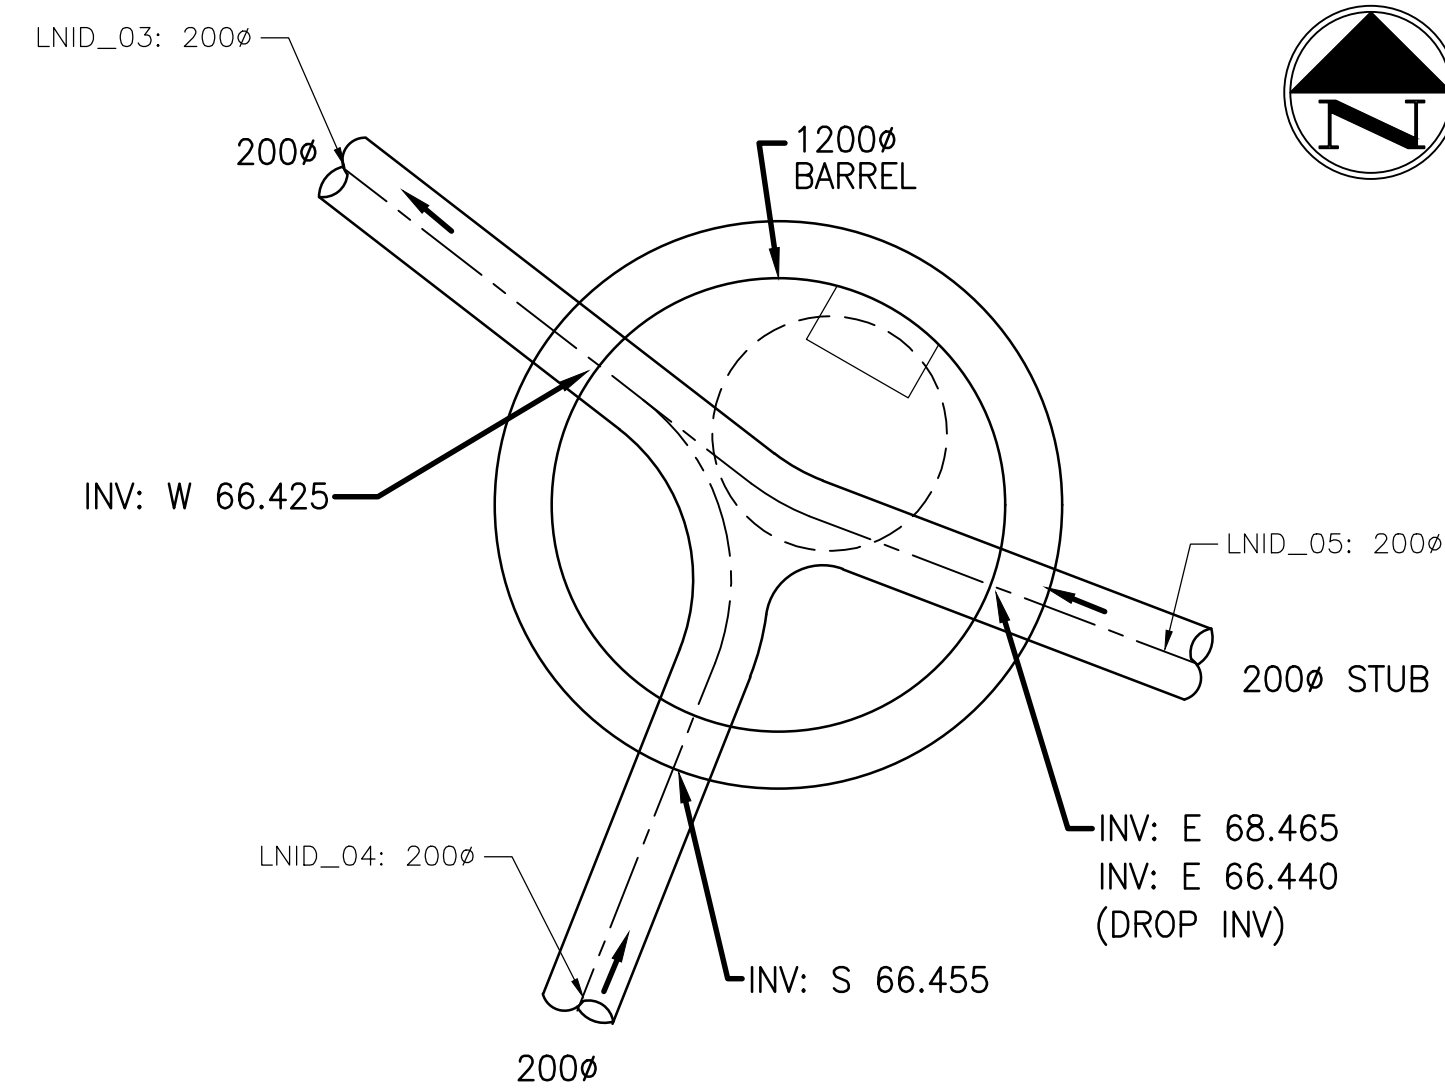

PLAN VIEW – SMH ALL 06  
(SMH 0172)


NOTES:

1. MANHOLE VIEWS ARE SHOWN USING BEST AVAILABLE INFORMATION. CONTRACTOR TO VERIFY EXACT SIZING, ELEVATION AND LOCATION PRIOR TO START OF CONSTRUCTION.
2. PROVIDE A 900mm DIAMETER SECONDARY LIFT STATION DRILLED TO 12m. WELL TO BE CASED WITH 900mm CONCRETE PLUG.
3. REMOVE CONCRETE BENCHING TO INVERT OF PIPES. DRILL 4 STAINLESS STEEL QUICK BOLTS FOR PUMP BASE C/W LEVELING NUTS. GROUT PUMP BASE WITH NON SHRINK GROUT. PUMP SUCTION MUST HAVE A MINIMUM 300mm CLEARANCE FOR FULL DIAMETER OF INTAKE.
4. REMOVE EXISTING MANHOLE FRAME, COVER AND TOP CONCRETE LID. PROVIDE WATERTIGHT CLOSURE BETWEEN FLOOR OF EQUIPMENT ENCLOSURE AND MANHOLE. PROVIDE DETAILS FOR REVIEW BY CA.
5. PROVIDE QUICK RELEASE CONNECTION ON INSIDE OF CLOSING TO CONNECT TO PUMP DISCHARGE. FLEXIBLE CONNECTION TO INTERIOR OF CASING. PROVIDE ROBAR STYLE TRANSITION COUPLING BETWEEN PUMP DISCHARGE PIPE AND 75mm HDPE.
6. CONTRACTOR TO DRILL WELL AND PROVIDE CASING TO ALLOW INSTALLATION OF 5 l/sec PUMP IN LIFT STATION. CONTRACTOR TO PROPOSE PIPING INTERCONNECTION. INDICATIVE DESIGN ASSUMED FLEXIBLE SPOOL SECTION WITH FLANGED END CONNECTIONS. SUBMERSIBLE GUIDE RAIL IS ACCEPTABLE IF CONTRACTOR CAN FIT IN PROPOSED WET WELL.
7. PROVIDE SECURE SUPPORTS AT TOP OF CASING NOT MORE THAN 300mm BELOW GRADE FOR PUMP LIFTING CHAIN, FLOAT(S) AND CONTROL WIRING. PROVIDE LOCKABLE SOLID GALVANIZED STEEL PLATE COVER OVER CASING, SET COVER 50mm ABOVE GRADE.

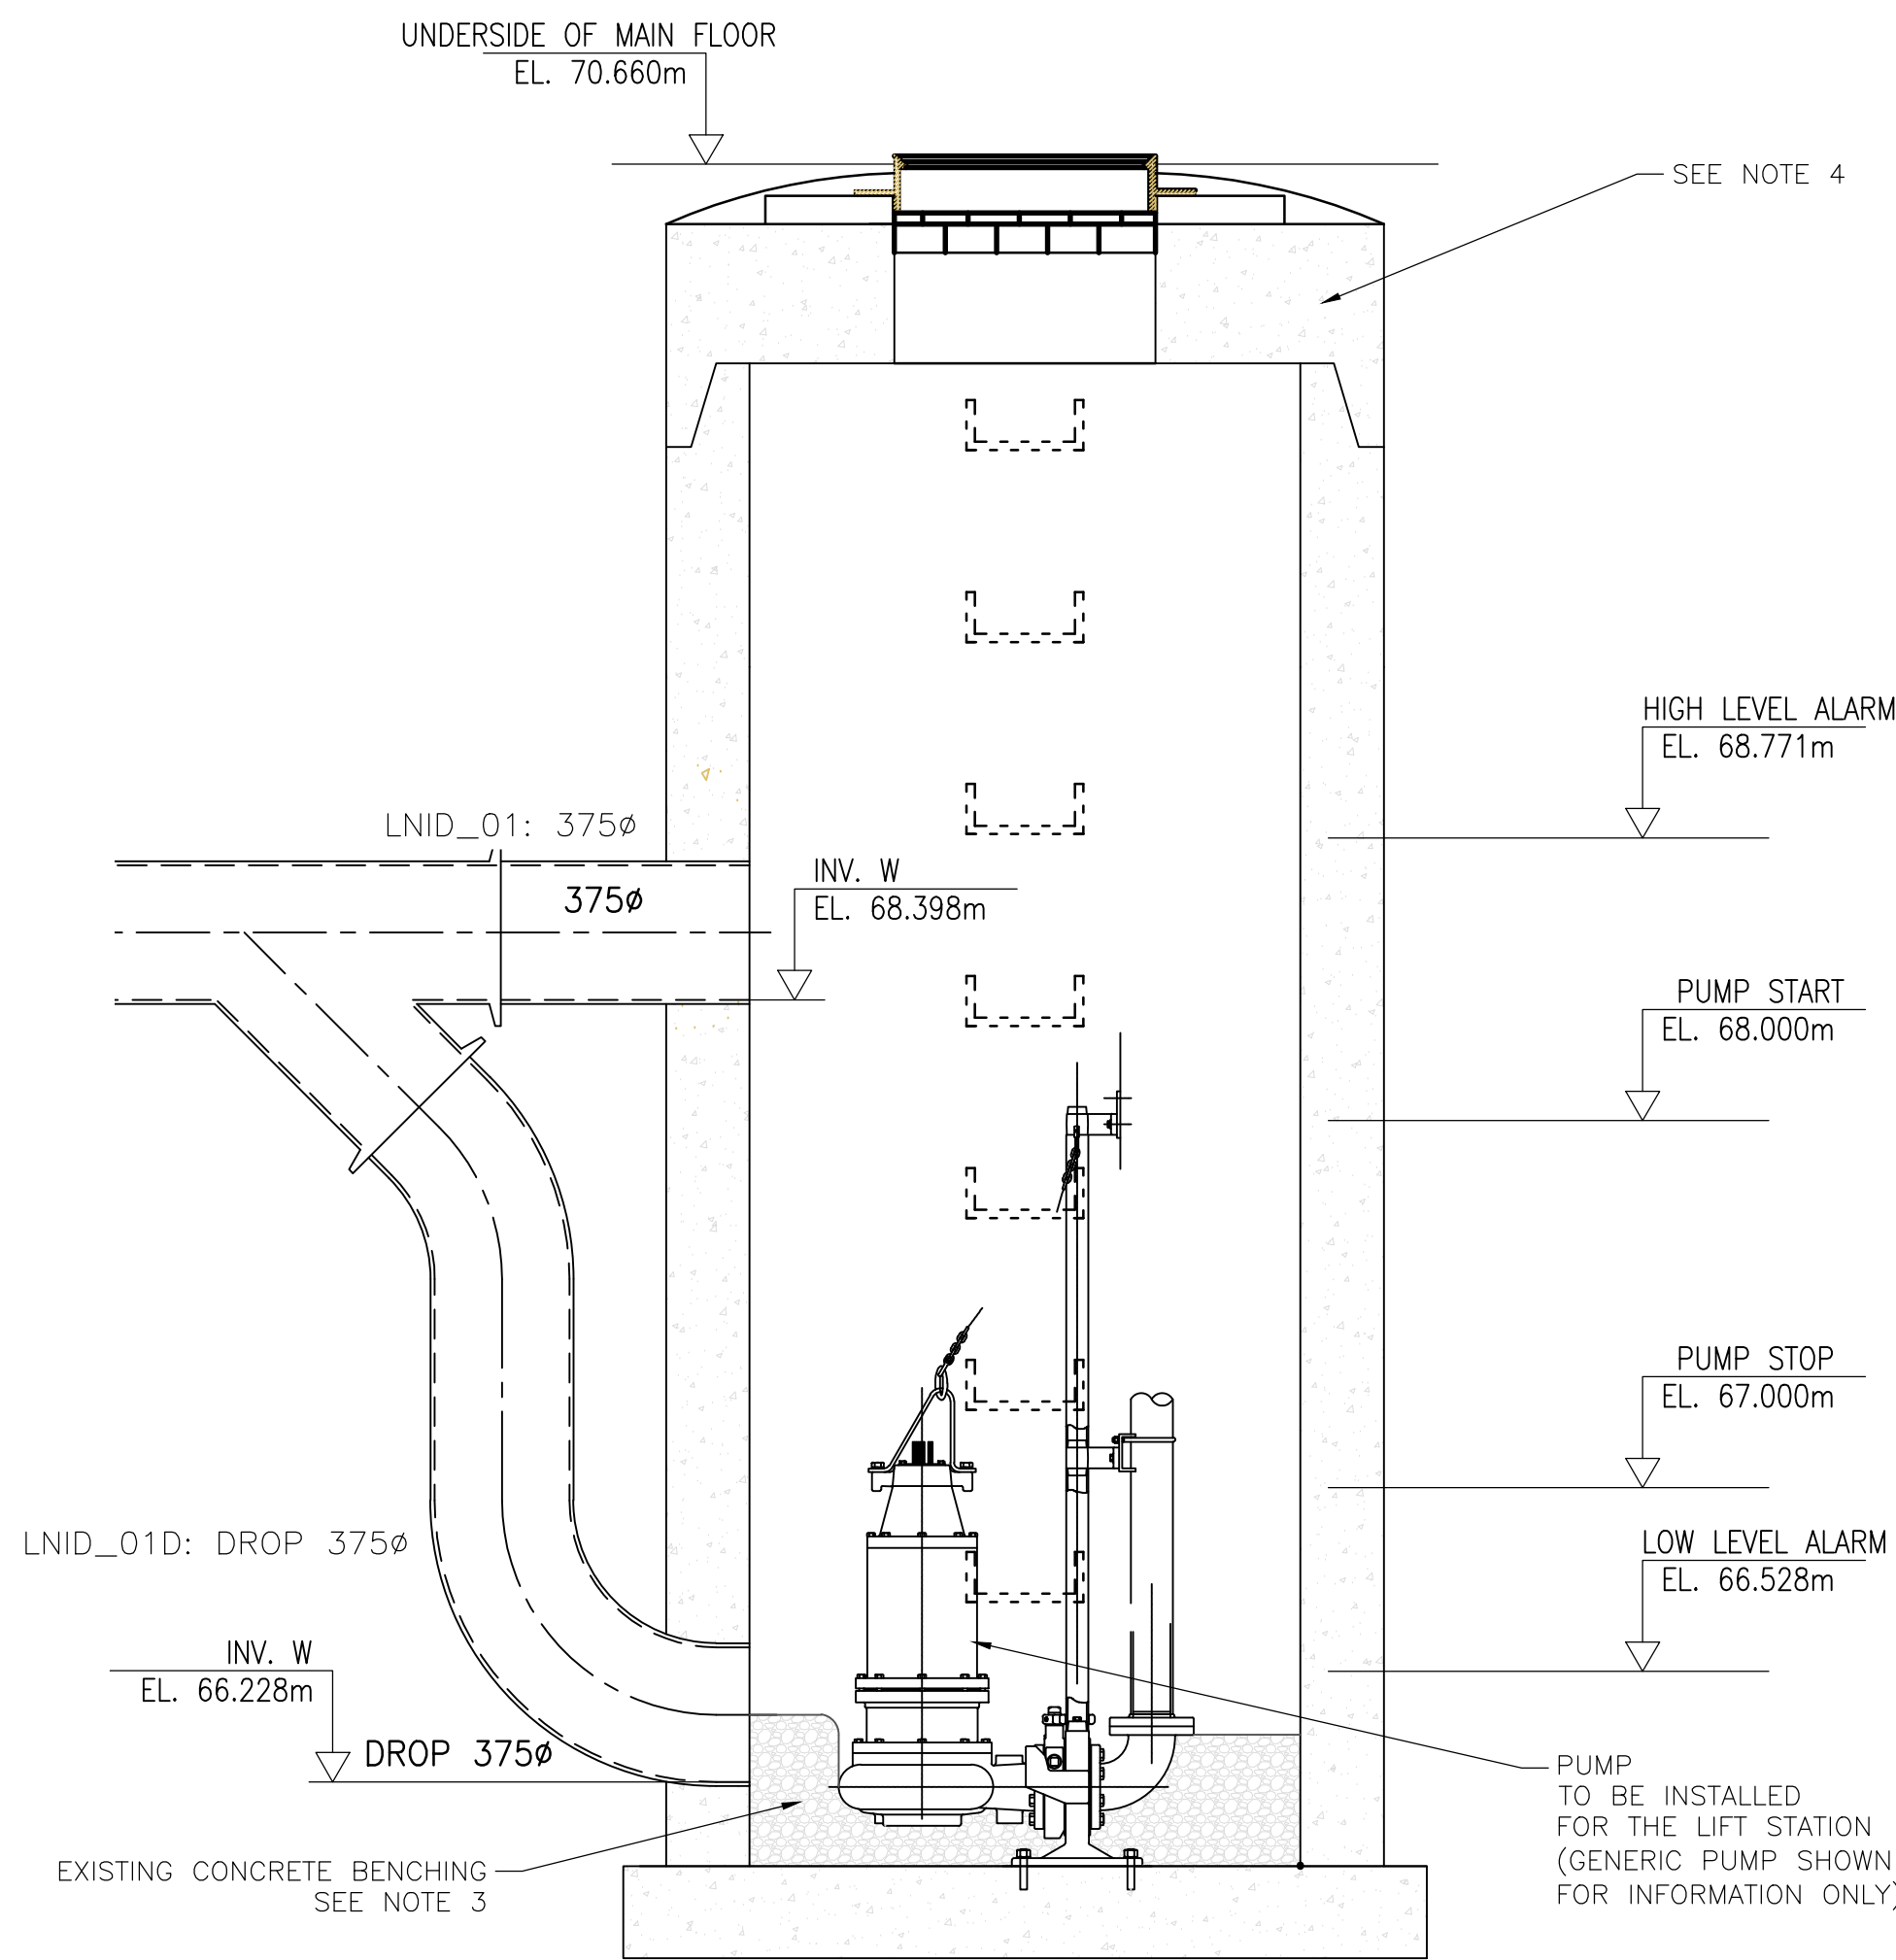


ELEVATION VIEW – SMH ALL 05 (SMH 0173)  
FIRST LIFT STATION

SEE NOTE 4

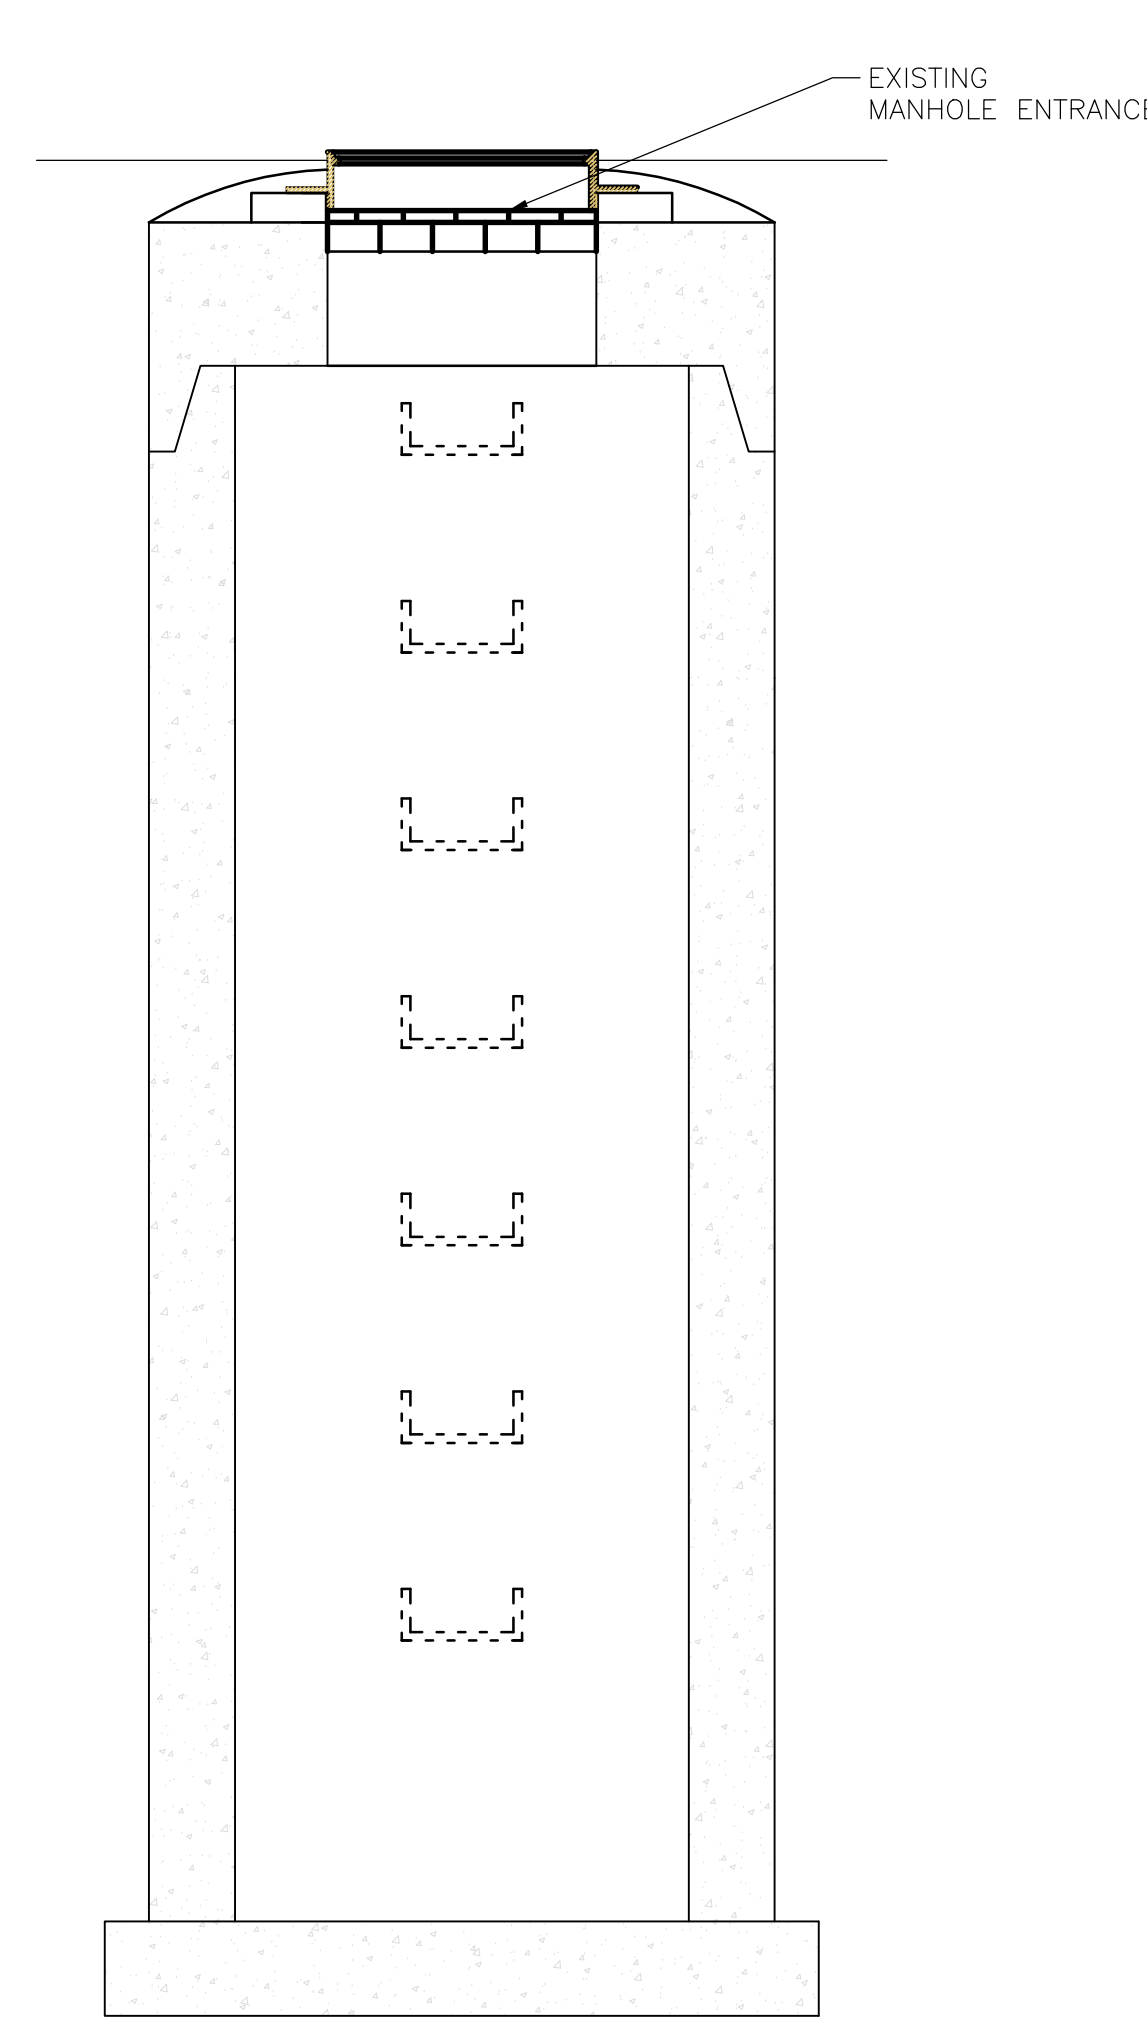

ELEVATION VIEW – SMH ALL 06  
(SMH 0172)

SEE NOTE 4

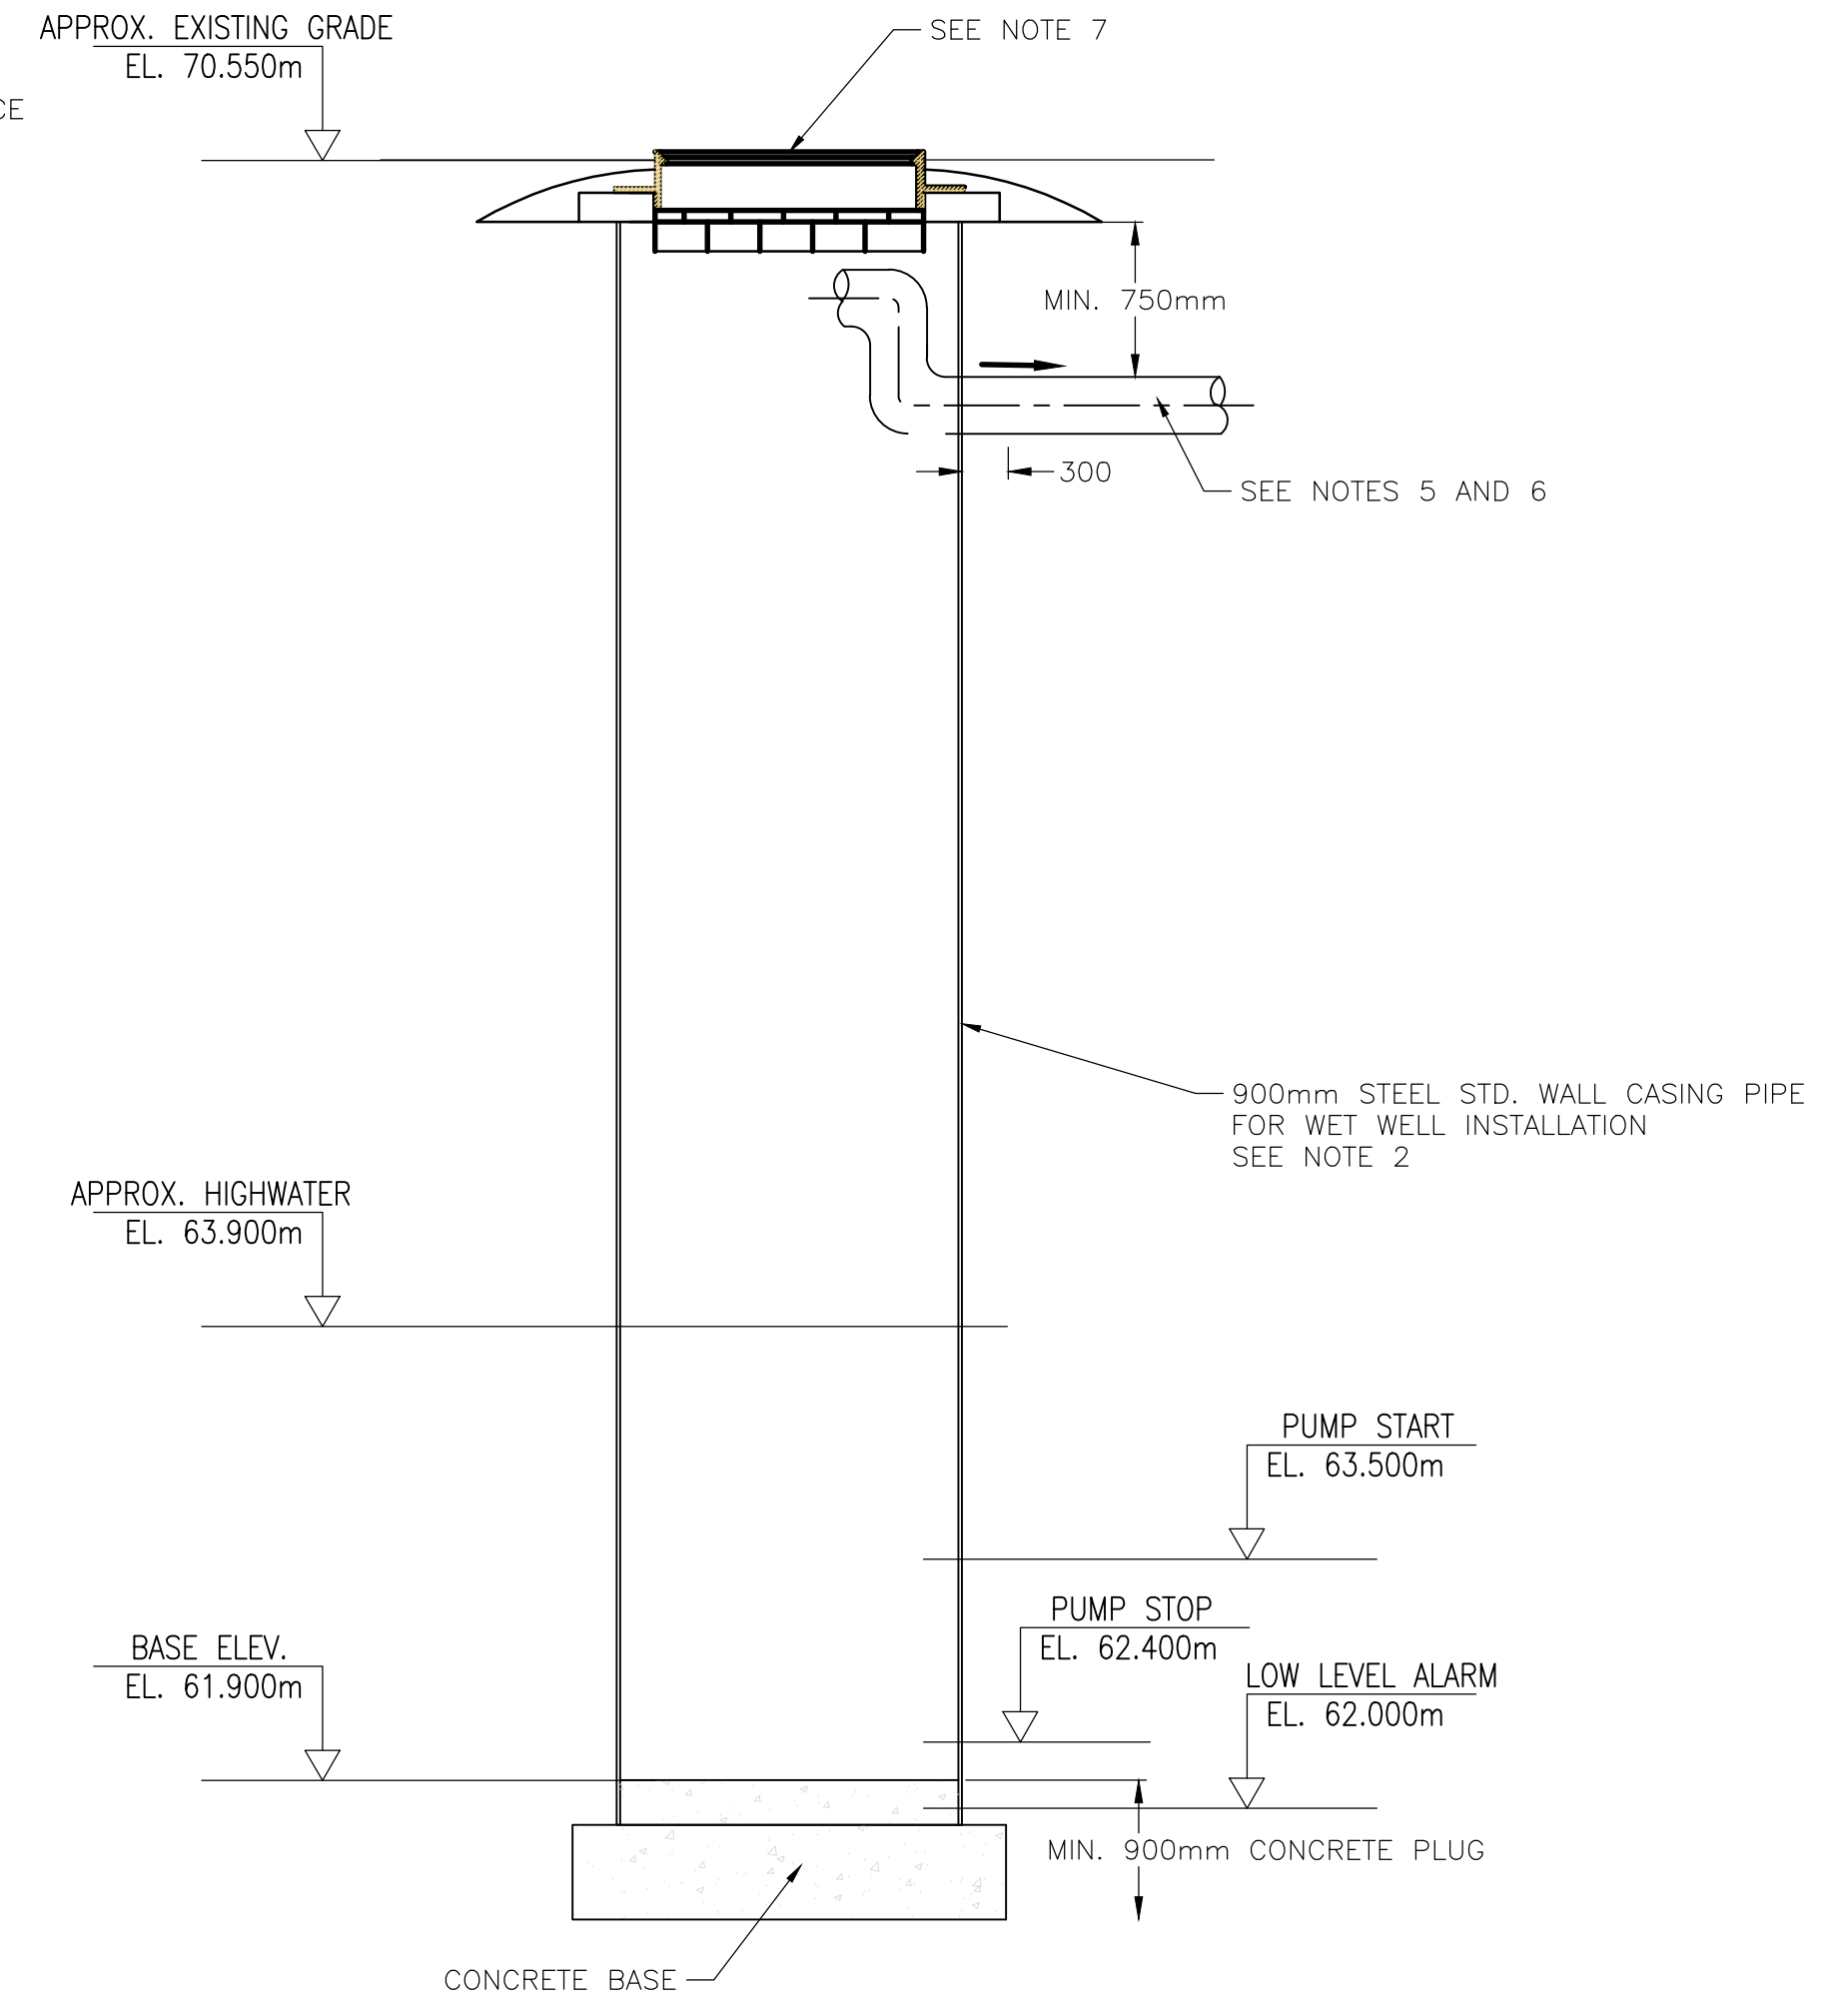

WET WELL – NEW  
SECONDARY LIFT STATION

SEE NOTE 6

No.	DATE	REVISION	ENGR	EXISTING	PROPOSED	EXISTING	PROPOSED	EXISTING	PROPOSED	EXISTING	PROPOSED	EXISTING	PROPOSED
A	3/2017	INDICATIVE DESIGN	LS	MANHOLE CLEANOUT LIFT STATION INSPECTION CHAMBER CATCH BASIN SILT TRAP SEEPAGE PIT CULVERT DITCH HYDRANT WATER VALVE FLUSH VALVE	MANHOLE CLEANOUT LIFT STATION INSPECTION CHAMBER CATCH BASIN SILT TRAP SEEPAGE PIT CULVERT DITCH HYDRANT WATER VALVE FLUSH VALVE	AIR VALVE WATER METER IRRIGATION VALVE UTILITY MANHOLE SERVICE BOX LPT UTILITY POLE POLE-MOUNT LS ORNAMENTAL LUMINAIRE TRAFFIC SIGNAL	AIR VALVE WATER METER IRRIGATION VALVE UTILITY MANHOLE SERVICE BOX LPT UTILITY POLE POLE-MOUNT LS ORNAMENTAL LUMINAIRE TRAFFIC SIGNAL	SANITARY SANITARY FORCEMAIN STORM DRAIN WATER GAS ELECTRICAL ROAD CURB EDGE OF PAVEMENT DRIVEWAY SIDEWALK PROPERTY LINE EASEMENT	SANITARY SANITARY FORCEMAIN STORM DRAIN WATER GAS ELECTRICAL ROAD CURB EDGE OF PAVEMENT DRIVEWAY SIDEWALK PROPERTY LINE EASEMENT	FENCE SLOPE – TOP SLOPE – BOTTOM CONTOUR – MAJOR CONTOUR – MINOR BOUNDARY BUILDING ENVELOPE VEGETATION LINE	FENCE SLOPE – TOP SLOPE – BOTTOM CONTOUR – MAJOR CONTOUR – MINOR BOUNDARY BUILDING ENVELOPE VEGETATION LINE	BENCHMARK: ELEVATION:	BENCHMARK: ELEVATION:




**TETRA TECH**  
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DESIGN LS  
DRAWN MT  
CHECKED DM  
ENGINEER LS


PROJECT:	<b>ALLANDALE PIT</b>	COLWOOD FILE NO.	RFP-2017-01
TITLE:	<b>PUMPING SYSTEM DETAILS MANHOLE VIEWS</b>	COLWOOD CONTRACT NO.	RFP-2017-01
DATE:	2017-03-21	SCALE:	AS NOTED
DRAWING NO.	DWG-J0005	SHEET:	5 of 9
		REV:	INP



- NOTES :**
- THIS DRAWING FOR GUIDANCE ONLY. CONTENTS BEING TAKEN FROM CITY OF COLWOOD FILE NO:10.7.20; DRAWING NO. 026-24-05 REVISION J.
  - EXCAVATE, CUT AND REMOVE EXISTING 300Ø AT MANHOLE AND CONNECT NEW 150Ø TO EXISTING. INSTALL TEMPORARY PLUG IN EXISTING 300Ø FOR AIR TESTING. AIR TEST COMPLETE LINE FROM MANHOLE ALLO2 TO ALLO5 (SMH 0173).

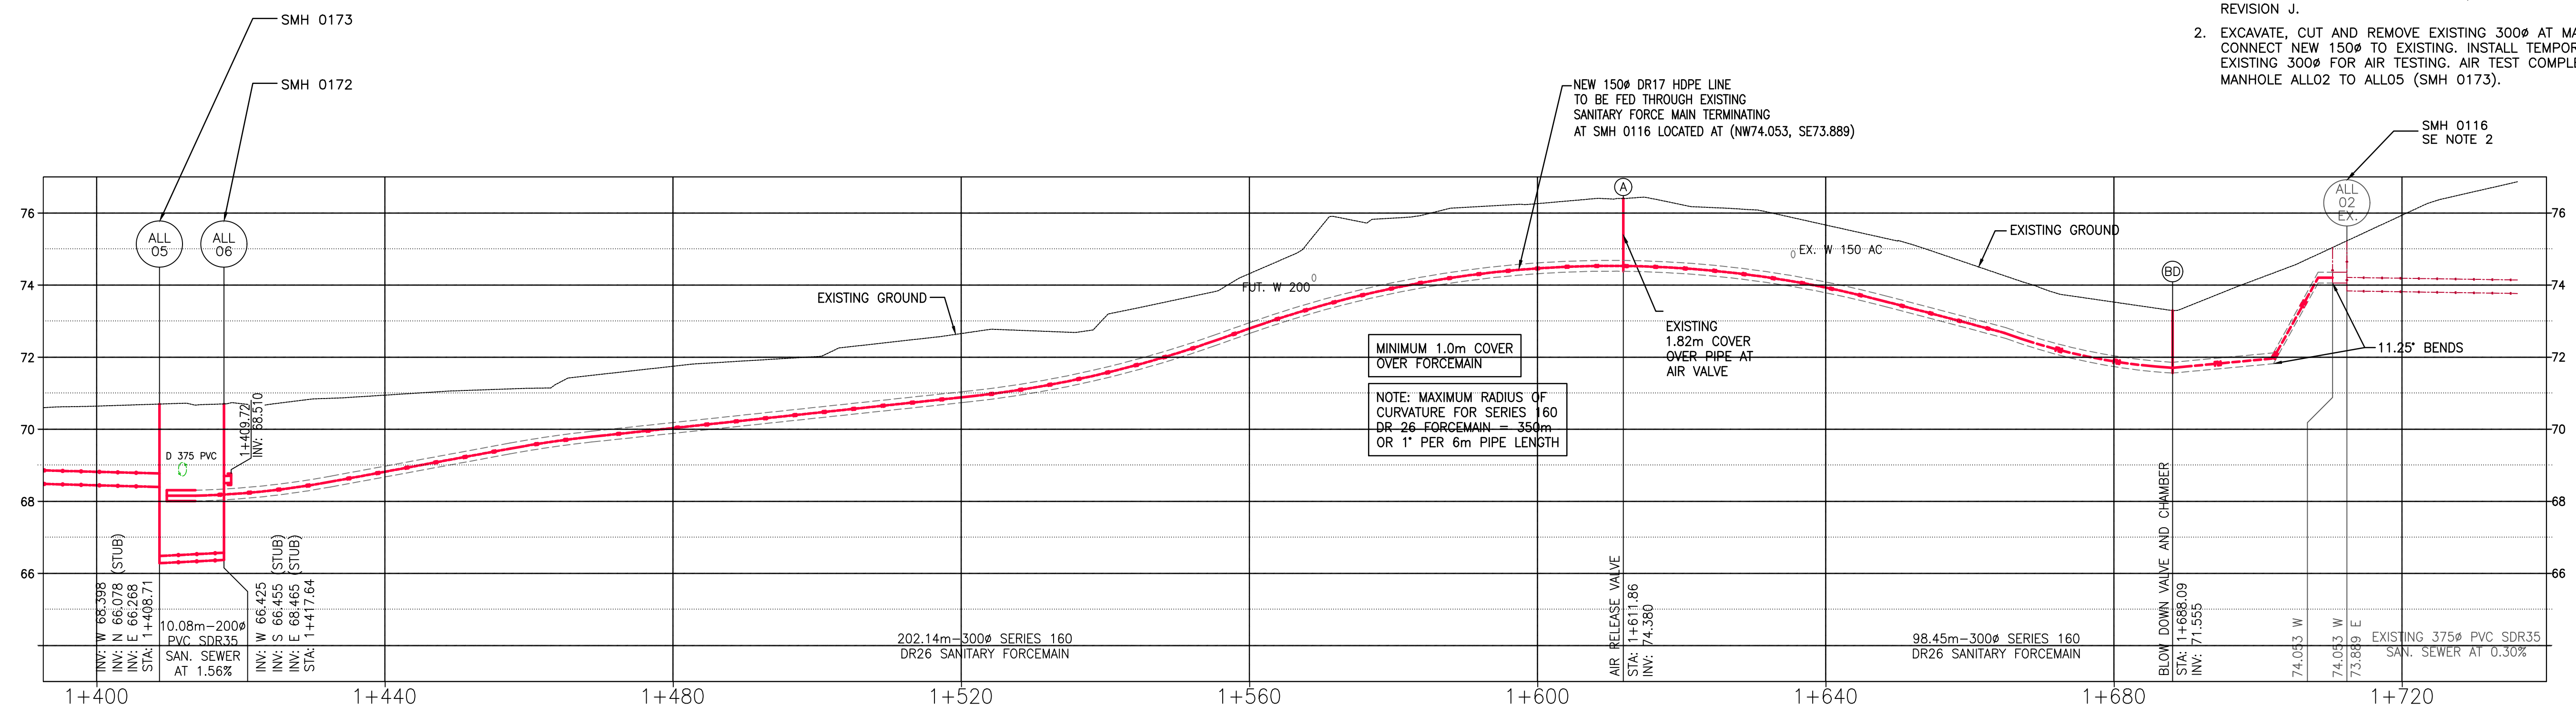

PROFILE VIEW - COLWOOD SEWERS  
ALLANDALE ROAD

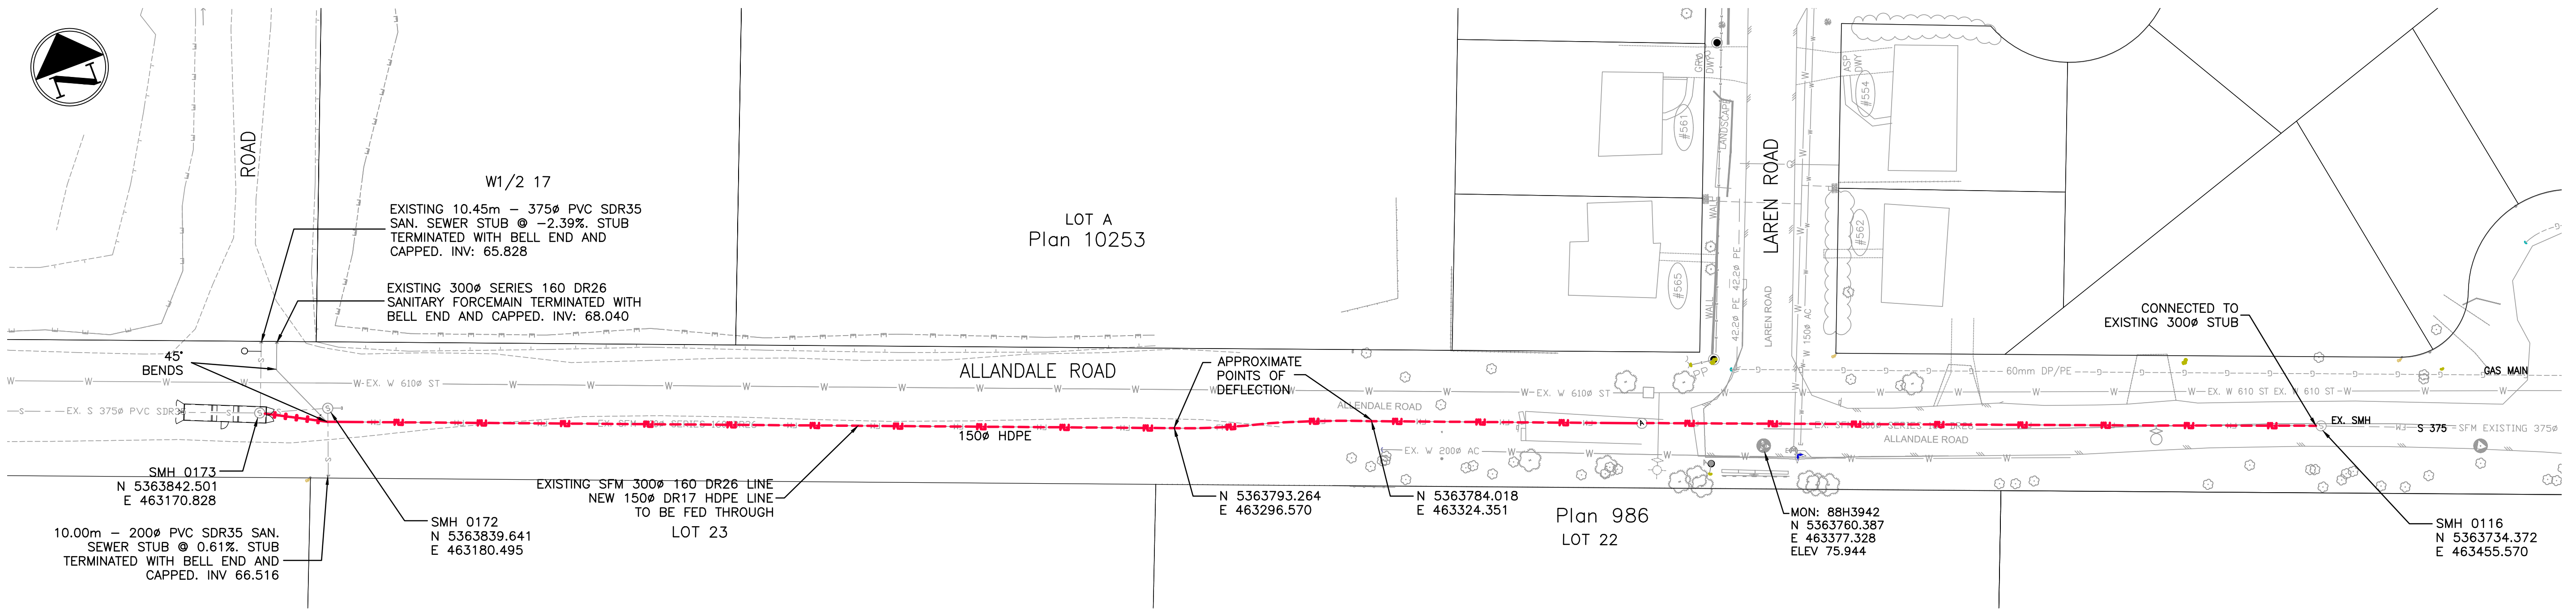

PLAN VIEW  
ALLANDALE ROAD

No.	DATE	REVISION	ENGR	EXISTING	PROPOSED	EXISTING	PROPOSED	EXISTING	PROPOSED	EXISTING	PROPOSED
A	3/2017	INDICATIVE DESIGN	LS	<ul style="list-style-type: none"> <li>MANHOLE</li> <li>CLEANOUT</li> <li>LIFT STATION</li> <li>INSPECTION CHAMBER</li> <li>CATCH BASIN</li> <li>SILT TRAP</li> <li>SEEPAGE PIT</li> <li>CULVERT</li> <li>DITCH</li> <li>HYDRANT</li> <li>WATER VALVE</li> <li>FLUSH VALVE</li> </ul>	<ul style="list-style-type: none"> <li>AIR VALVE</li> <li>WATER METER</li> <li>IRRIGATION VALVE</li> <li>UTILITY MANHOLE *</li> <li>SERVICE BOX *</li> <li>LPT</li> <li>UTILITY POLE *</li> <li>POLE-MOUNT LS</li> <li>ORNAMENTAL LUMINAIRE</li> <li>TRAFFIC SIGNAL</li> </ul>	<ul style="list-style-type: none"> <li>SANITARY</li> <li>SANITARY FORCEMAIN</li> <li>STORM DRAIN</li> <li>WATER</li> <li>GAS</li> <li>ELECTRICAL</li> <li>ROAD CURB</li> <li>EDGE OF PAVEMENT</li> <li>DRIVEWAY</li> <li>SIDEWALK</li> <li>PROPERTY LINE</li> <li>EASEMENT</li> </ul>	<ul style="list-style-type: none"> <li>FENCE</li> <li>SLOPE - TOP</li> <li>SLOPE - BOTTOM</li> <li>CONTOUR - MAJOR</li> <li>CONTOUR - MINOR</li> <li>BOUNDARY</li> <li>BUILDING ENVELOPE</li> <li>VEGETATION LINE</li> </ul>	<ul style="list-style-type: none"> <li>BENCHMARK:</li> <li>ELEVATION:</li> </ul>			




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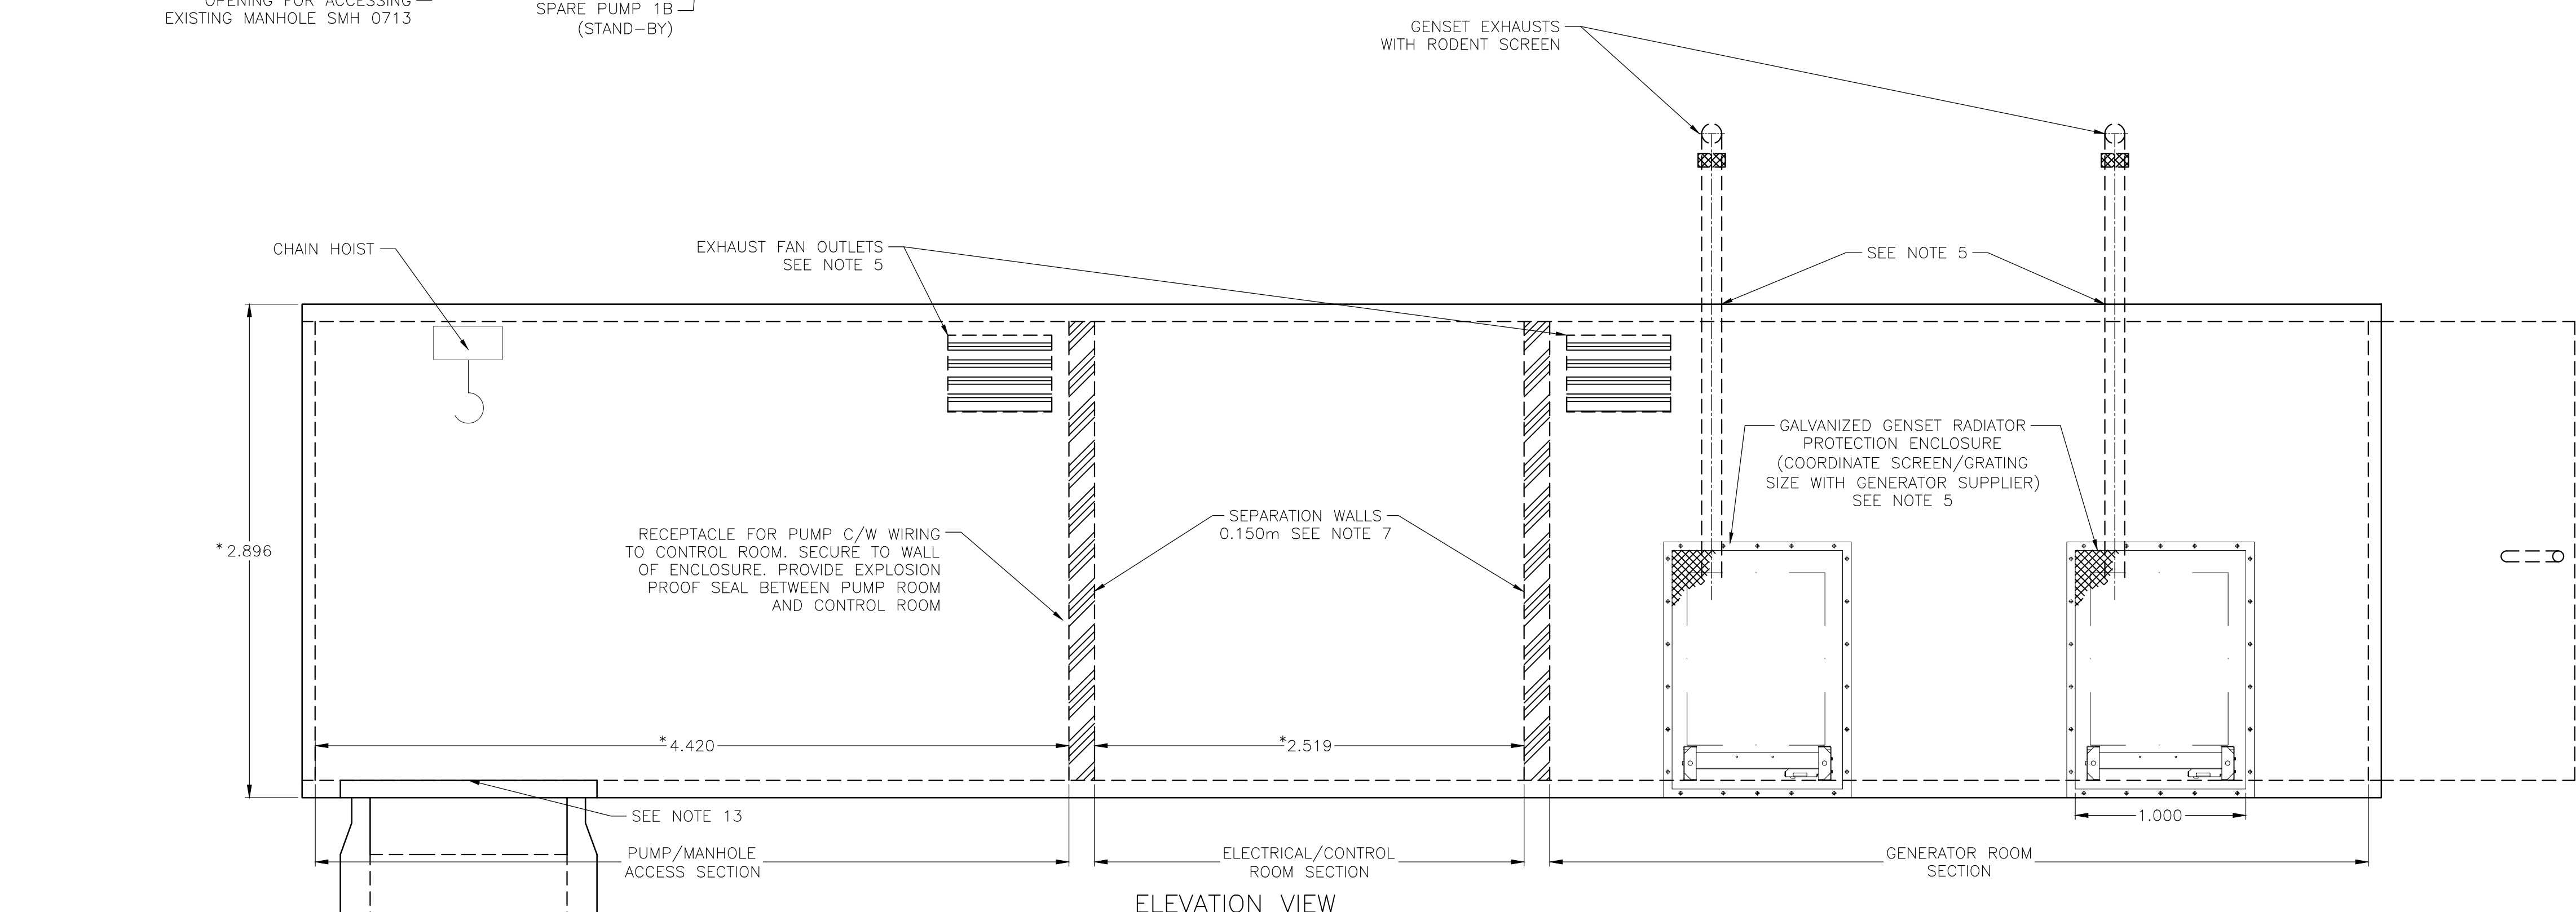
DESIGN LS SEAL  
DRAW MT  
CHECKED DM  
ENGINEER LS

PROJECT:	<b>ALLANDALE PIT</b>	COLWOOD FILE NO.	RFP-2017-01
TITLE:	<b>PUMPING SYSTEM PROPOSED TUBE FEEDING PLAN AND PROFILE, GUIDANCE ONLY</b>	COLWOOD CONTRACT NO.	RFP-2017-01
DATE:	2017-03-21	SCALE:	AS NOTED
DRAWING NO.	DWG-J0006	SHEET:	6 of 9
		REV:	INP




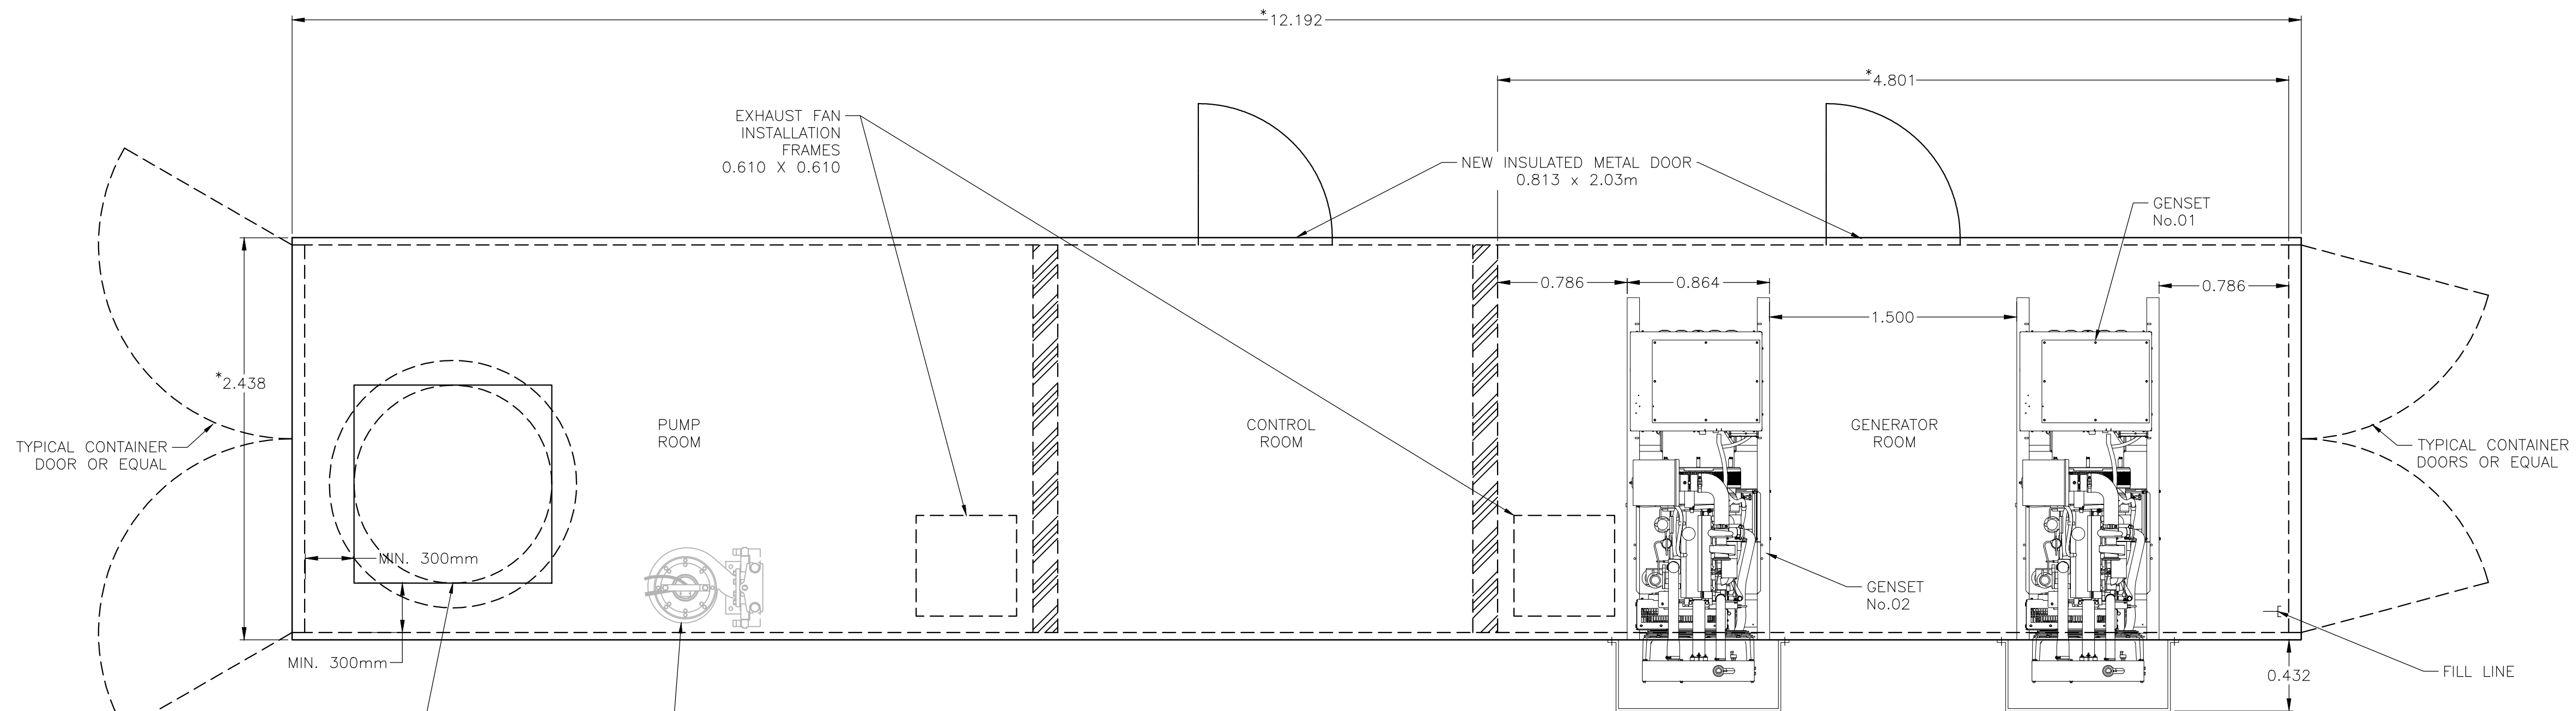

PLAN VIEW



ELEVATION VIEW

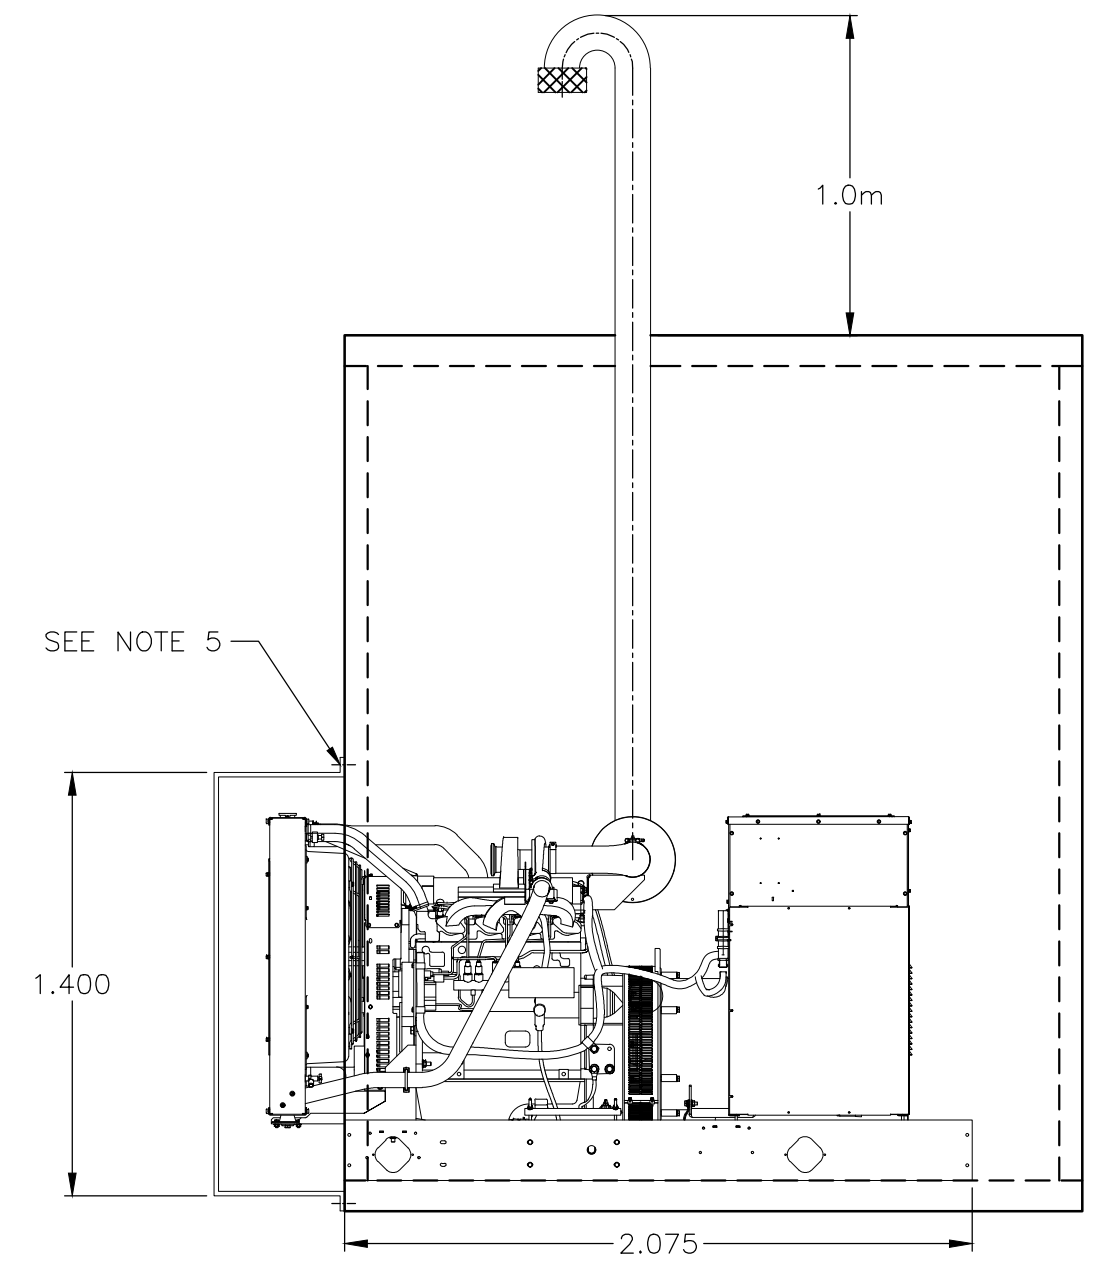

ELEVATION SIDE VIEW

\* DIMENSIONS BASED ON STEEL STORAGE CONTAINER

- NOTES:**
- CONTROL ROOM AREA IS CLASS 1 DIV 2 ELECTRICAL RATING. WALLS MUST INCLUDE SEALED BARRIER TO PREVENT GAS TRANSFER.
  - REFER TO DRAWING J0004 FOR LOCATING CONTAINER ON SITE.
  - FOR GENERATOR CONNECTION DETAILS REFER TO MANUFACTURER DRAWINGS. PROVIDE PRODUCT DATA SHEETS AND SHOP DRAWING TO CA FOR REVIEW. PROVIDE O/M MANUAL PRIOR TO SUBSTANTIAL PERFORMANCE.
  - FILL LINE FOR GENERATOR FUEL TO BE FIELD LOCATED BASED ON GENERATOR SELECTION. CONTRACTOR TO PLACE NEAR CONTAINER OR GENERATOR ACCESS DOOR. SECURE ALL PIPING TO WALLS. PROVIDE SPILL CONTAINMENT AROUND FILL AREA.
  - CONTRACTOR TO PROVIDE SEAL FOR ELECTRICAL ROOM TO PREVENT GAS OR ODORS FROM ENTERING ELECTRICAL ROOM. PROVIDE WEATHER TIGHT CLOSURES FOR ALL OPENINGS IN CONTAINER FOR GENERATOR EXHAUST, FANS, GENERATOR RADIATORS AND DOORS.
  - SECURE GENSET TO FLOOR OF ENCLOSURE. COORDINATE REQUIREMENTS WITH GENERATOR SUPPLIER.
  - WALLS MUST INCLUDE SEALED BARRIER TO PREVENT GAS TRANSFER.
  - PROVIDE SEAL FOR ELECTRICAL ROOM TO PREVENT GAS OR ODORS FROM ENTERING ELECTRICAL ROOM. METAL OR STEEL STUDS MAY BE USED WITH R12 INSULATION IN THE WALLS AND R20 ON THE ROOF. SECURE ROOF INSULATION TO ENCLOSURE ROOF. INTERIOR WALLS TO HAVE BATTEN/PLYWOOD ON ONE SIDE AND GYPROC ON THE OPPOSITE SIDE.
  - REFER TO DRAWING J0004 FOR LOCATING CONTAINER ON SITE.
  - FOR GENERATOR CONNECTION DETAILS REFER TO MANUFACTURER DRAWINGS.
  - CONTRACTOR TO INSTALL CHAIN HOIST DIRECTLY OVER SUBMERSIBLE PUMP. CONTRACTOR TO INCLUDE HOOK IN WALL TO SECURE CHAIN WHEN NOT IN USE. PUMP LIFTING CHAIN TO CONNECT TO MANUAL HOIST CONNECTED TO ENCLOSURE ROOF. PROVIDE SUFFICIENT LENGTH OF CHAIN TO CONNECT TO HOIST. PROVIDE HOIST WITH CAPACITY OF MINIMUM 1.5 TIMES WEIGHT OF PUMP AND ASSOCIATED PIPING.
  - CONTRACTOR TO PROVIDE SHELVING FOR STORAGE OF SPARE PARTS AS RECOMMENDED BY EQUIPMENT SUPPLIER AND DEFINED IN SPECIFICATIONS.
  - REMOVE MANHOLE FRAME, LID AND TOP CONCRETE RING OF EXISTING MANHOLE SMH 0173 TO PROVIDE ACCESS FOR PUMP OPERATION. PROVIDE WATER TIGHT SEAL BETWEEN THE MANHOLE AND THE ENCLOSURE FLOOR. PROVIDE DETAILS FOR REVIEW BY CA.
  - PROVIDE ACCESS THROUGH FLOOR OF ENCLOSURE TO PROVIDE FULL ACCESS TO EXISTING MANHOLE. INSTALL HINGED, LOCKABLE ARMETEC GALVANIZED GRATING OR NON-METALLIC GRATING OVER MANHOLE, FLUSH WITH TOP OF THE ENCLOSURE FLOOR. SEAL AND MAKE WATERTIGHT ANNULAR SPACE BETWEEN THE FLOOR AND THE MANHOLE. GRATING TO BE RATED FOR 40 LBS PER SQUARE FOOT. PROVIDE DETAIL FOR REVIEW BY CA.
  - SECOND PUMP WILL BE LOCATED IN STEEL STORAGE CONTAINER COMPLETELY WIRED FOR IMMEDIATE SERVICE. ELECTRICAL TO INCLUDE LOCK ON SWITCH TO PREVENT ACCIDENTAL START OF PUMP.

No.	DATE	REVISION	ENGR	EXISTING	PROPOSED	EXISTING	PROPOSED	EXISTING	PROPOSED	EXISTING	PROPOSED
A	3/2017	INDICATIVE DESIGN	LS	MANHOLE CLEANOUT LIFT STATION INSPECTION CHAMBER CATCH BASIN SILT TRAP SEEPAGE PIT CULVERT DITCH HYDRANT WATER VALVE FLUSH VALVE	AIR VALVE WATER METER IRRIGATION VALVE UTILITY MANHOLE * SERVICE BOX * LPT UTILITY POLE * POLE-MOUNT LS ORNAMENTAL LUMINAIRE TRAFFIC SIGNAL	SANITARY SANITARY FORCEMAIN STORM DRAIN WATER GAS ELECTRICAL ROAD CURB EDGE OF PAVEMENT DRIVEWAY SIDEWALK PROPERTY LINE EASEMENT	FENCE SLOPE - TOP SLOPE - BOTTOM CONTOUR - MAJOR CONTOUR - MINOR BOUNDARY BUILDING ENVELOPE VEGETATION LINE	N/A	BENCHMARK: ELEVATION:		
				*SUBSTITUTE L,C,T AS REQUIRED							




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DESIGN	LS	SEAL
DRAWN	MT	
CHECKED	DM	
ENGINEER	LS	


PROJECT:	<b>ALLANDEALE PIT</b>	COLWOOD FILE NO.	RFP-2017-01
TITLE:	<b>PUMPING SYSTEM STEEL STORAGE CONTAINER GENERAL ARRANGEMENT</b>	COLWOOD CONTRACT NO.	RFP-2017-01
DATE:	2017-03-21	SCALE:	AS NOTED
DRAWING NO.	DWG-J0007	SHEET:	7 of 9
		REV:	INP



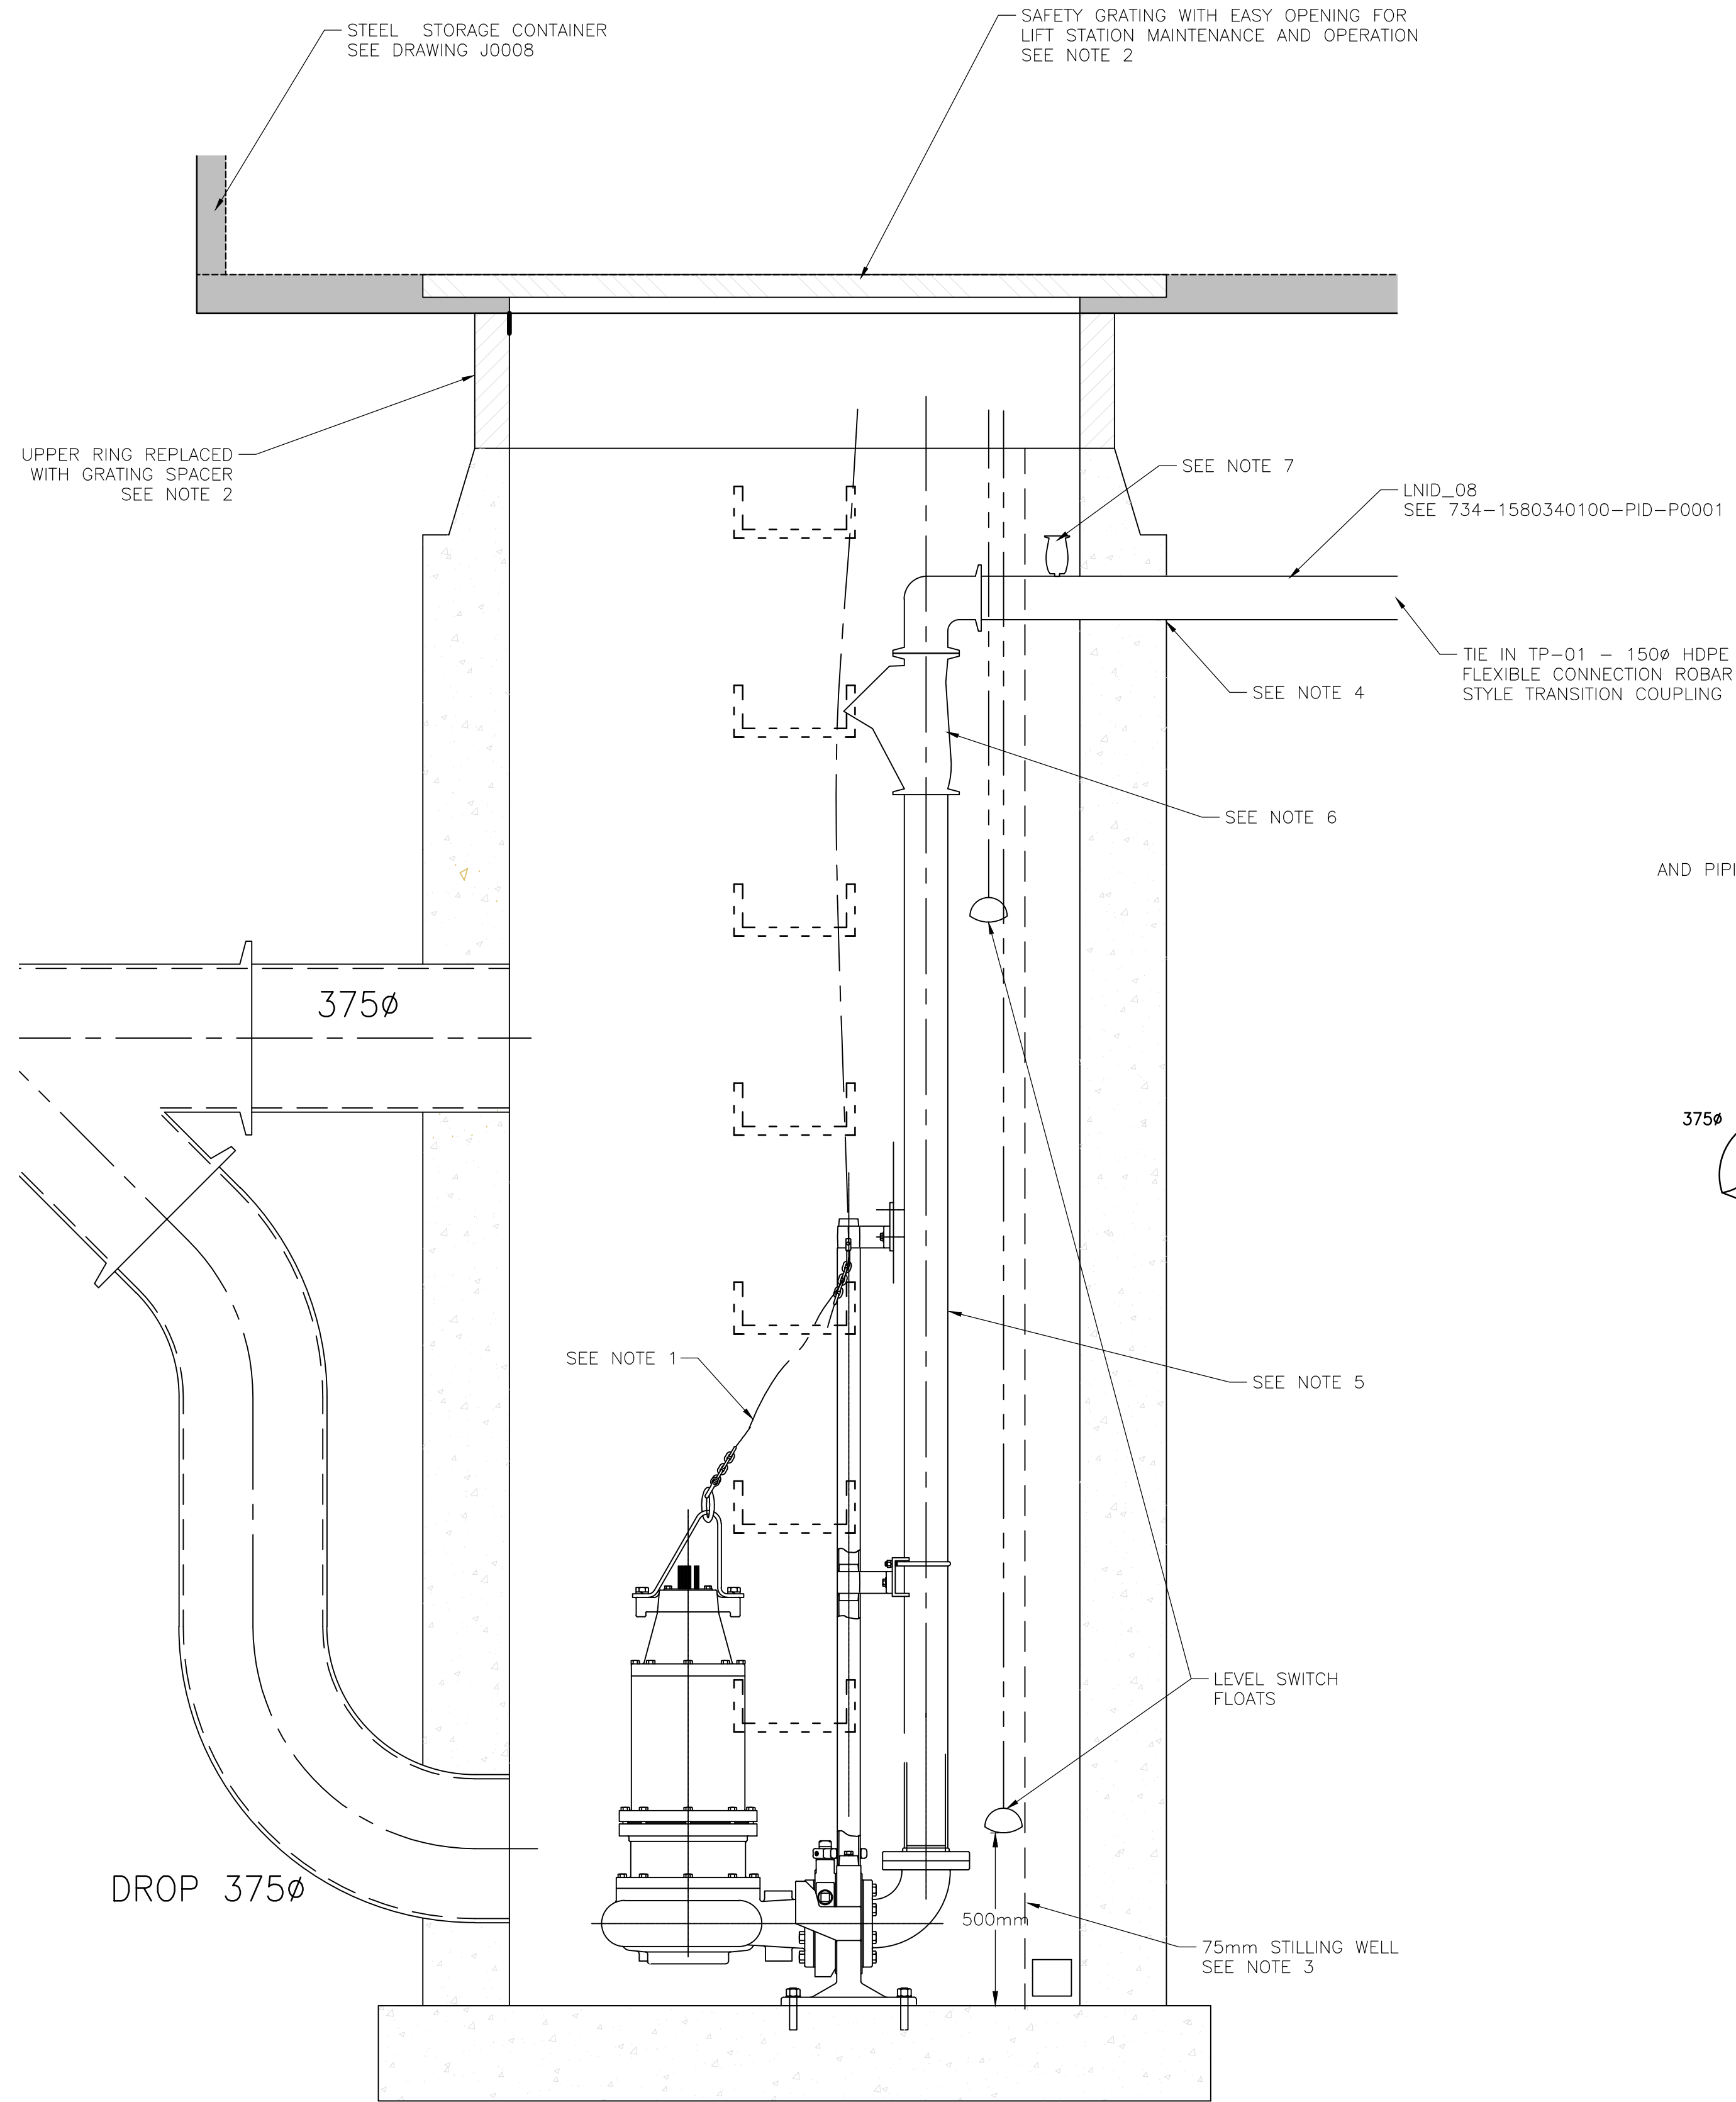

ELEVATION VIEW - SMH ALL 05 (SMH 0173)  
FIRST LIFT STATION

NOTE 2

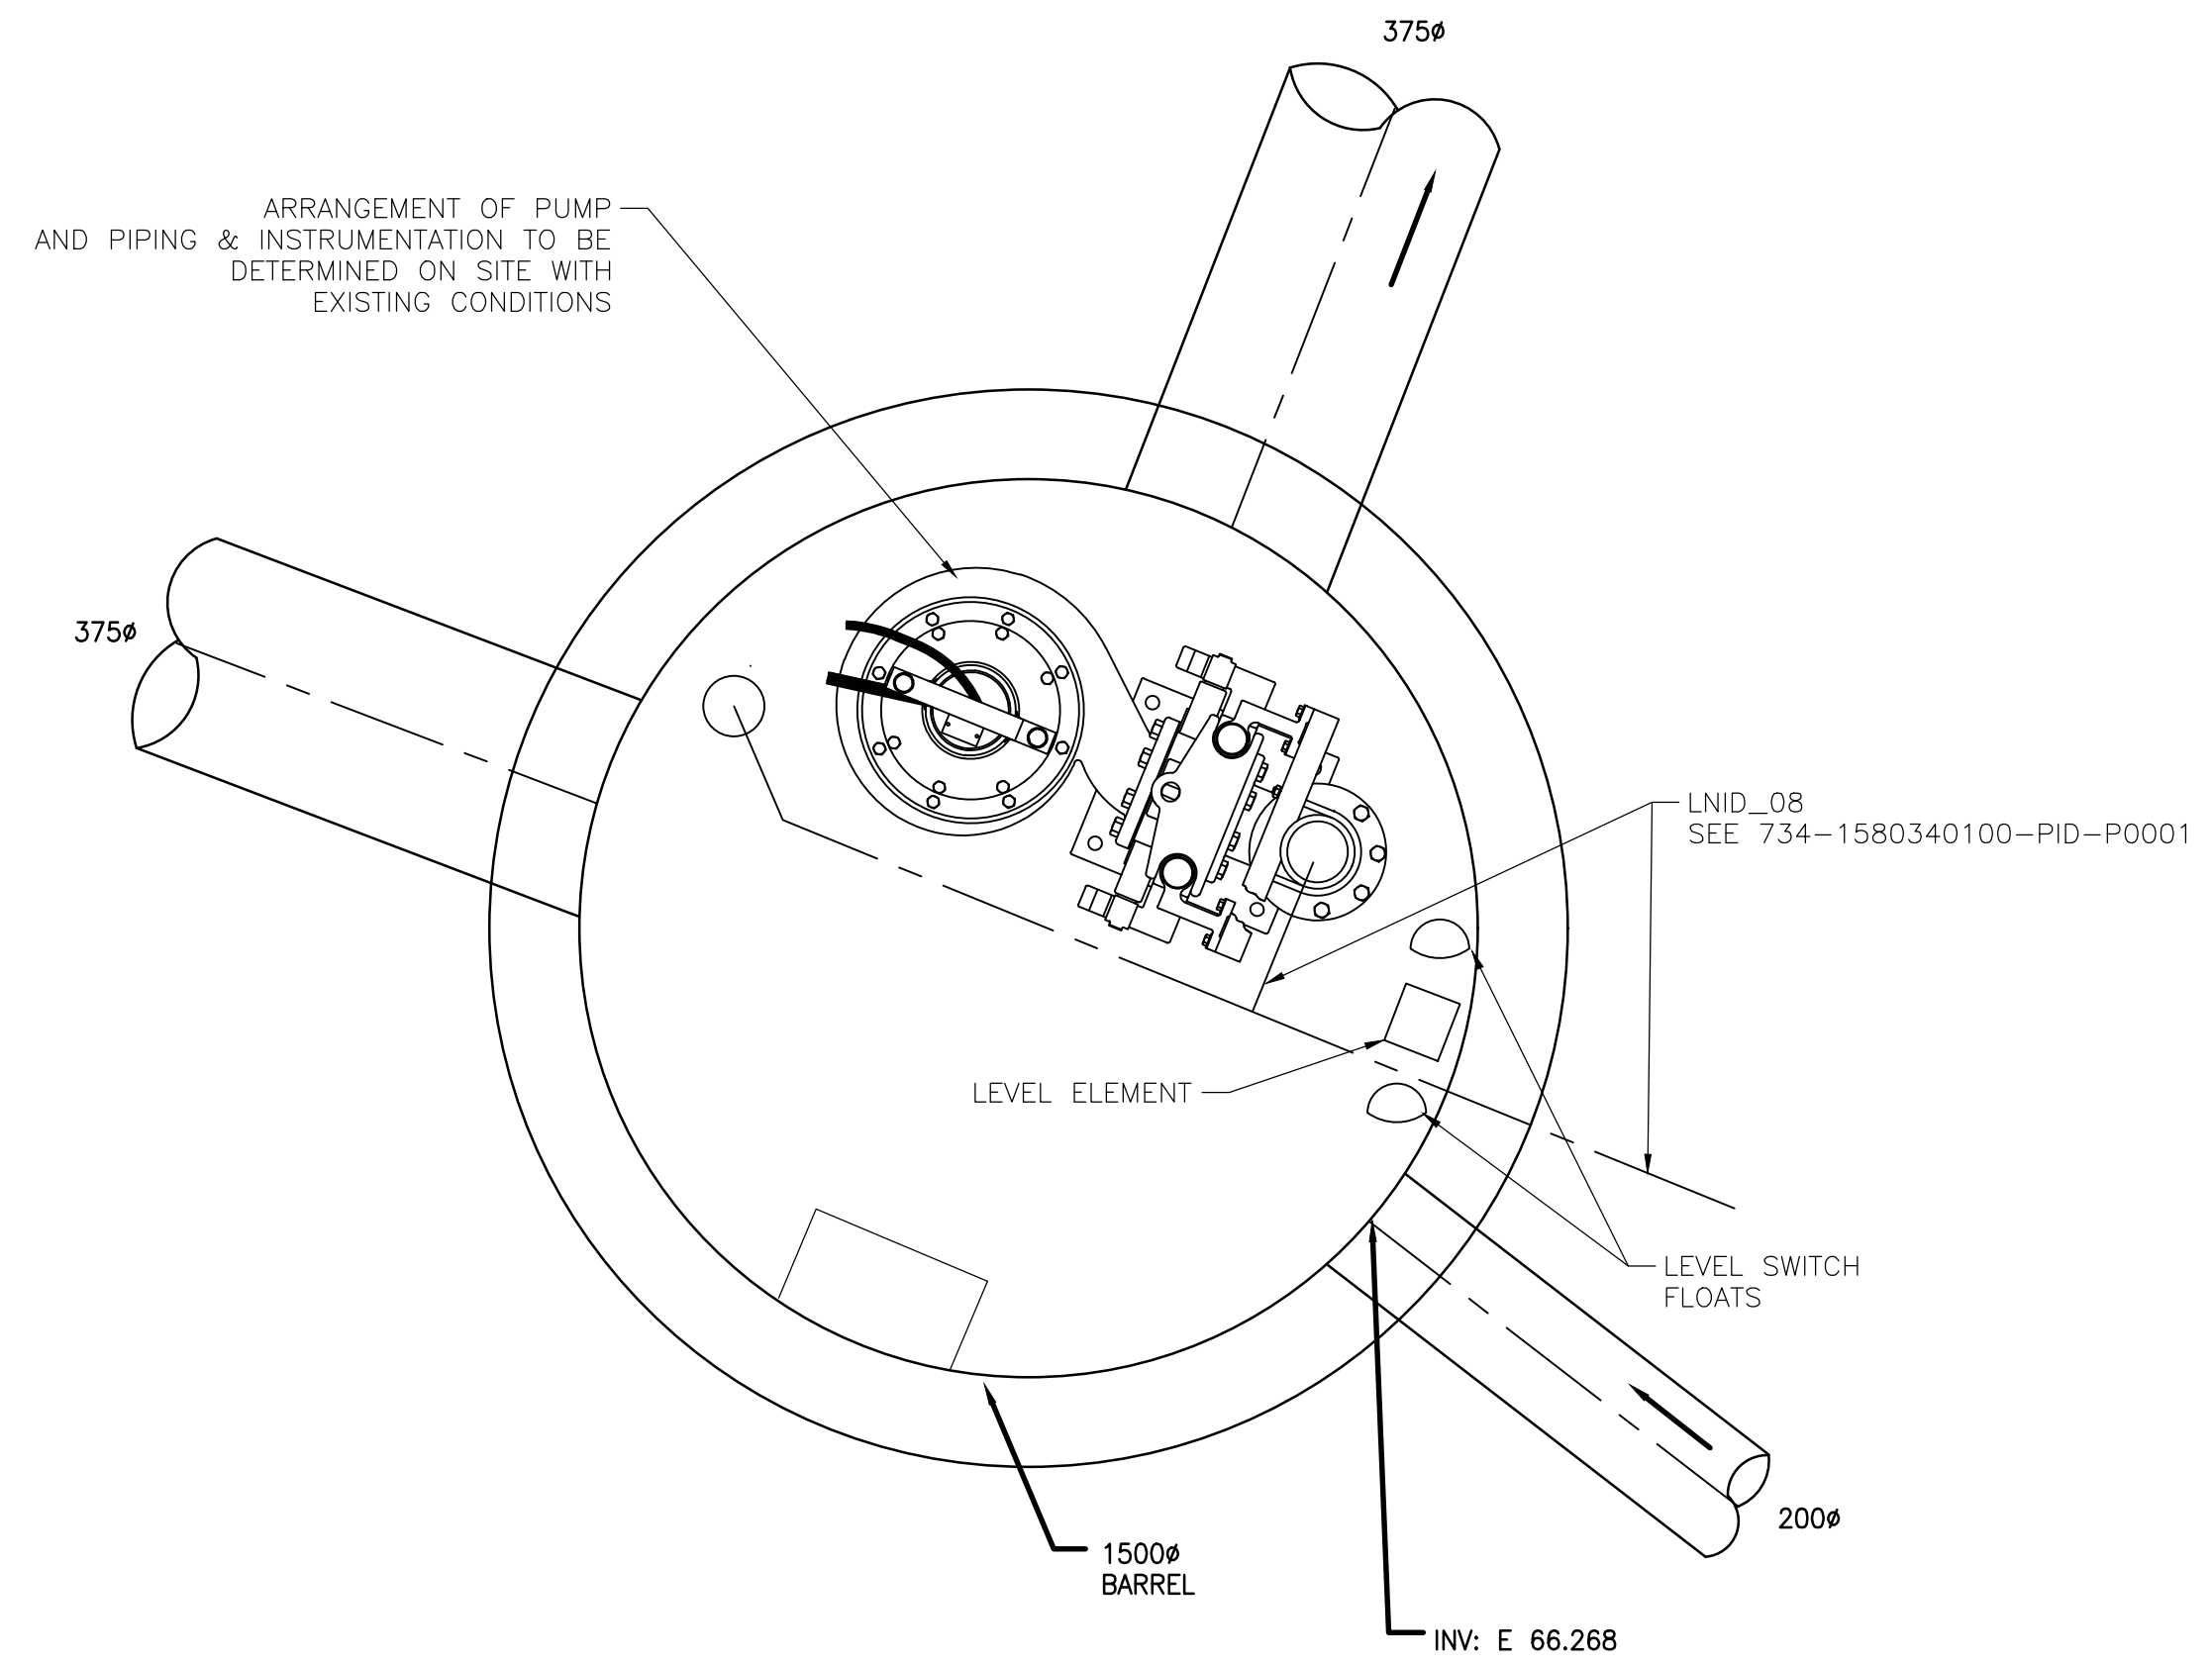

TOP VIEW - SMH ALL 05 (SMH 0173)  
FIRST LIFT STATION

NOTES:

1. GALVANIZED OR STAINLESS STEEL CHAIN TO FACILITATE REMOVAL OF PUMP(S). PROVIDE CHAIN SUPPORT AT TOP OF MANHOLE OR UNDERSIDE OF ENCLOSURE.
2. PROVIDE WATERTIGHT CLOSURE BETWEEN FLOOR OF ENCLOSURE AND MANHOLE.
3. PROVIDE A STILLING WELL TO PROTECT CONTINUOUS LEVEL DEVICE.
4. SEAL OPENING USING NO SHRINK GROUT.
5. 150Ø DISCHARGE PIPE SUITABLE FOR SEWAGE APPLICATION, PRESSURE RATING 150psi WORKING PRESSURE C/W FLANGED ENDS AND FLANGED CHECK VALVE AND ROBAR TRANSITION COUPLING.
6. CONTRACTOR TO LOCATE SELECTED FLANGED CHECK VALVE ON PUMP DISCHARGE LINE AND CONNECTION TO PRESSURE TRANSMITTER TO PROVIDE EASE OF INSTALLATION AND MAINTENANCE.
7. CONTRACTOR TO SUPPLY AND INSTALL 2" AIR RELIEF VALVE WITHIN THE ENCLOSURE. VENT TO BE LOCATED AT HIGHEST POINT OF PIPE DISCHARGE PIPING IN WET WELL. CONTRACTOR TO INCLUDE VENT LINE AND RETURN AIR LINE VENTING BACK INTO WET WELL. EXACT LOCATION TO BE CONFIRMED BY CONTRACTOR BASED ON CONTRACTOR'S PREFERENCE FOR LOCATION. VALVE MUST BE IN LOCATION CLEAR OF AREA REQUIRED FOR PUMP REMOVAL.

No.	DATE	REVISION	ENGR	EXISTING	PROPOSED	EXISTING	PROPOSED	EXISTING	PROPOSED	EXISTING	PROPOSED
A	3/2017	INDICATIVE DESIGN	LS	MANHOLE CLEANOUT LIFT STATION INSPECTION CHAMBER CATCH BASIN SILT TRAP SEEPAGE PIT CULVERT DITCH HYDRANT WATER VALVE FLUSH VALVE	AIR VALVE WATER METER IRRIGATION VALVE UTILITY MANHOLE * SERVICE BOX * LPT UTILITY POLE * POLE-MOUNT LS ORNAMENTAL LUMINAIRE TRAFFIC SIGNAL *SUBSTITUTE L,C,T AS REQUIRED	SANITARY SANITARY FORCEMAIN STORM DRAIN WATER GAS ELECTRICAL ROAD CURB EDGE OF PAVEMENT DRIVEWAY SIDEWALK PROPERTY LINE EASEMENT	FENCE SLOPE - TOP SLOPE - BOTTOM CONTOUR - MAJOR CONTOUR - MINOR BOUNDARY BUILDING ENVELOPE VEGETATION LINE	BENCHMARK: ELEVATION:			




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DESIGN LS  
 DRAWN MT  
 CHECKED DM  
 ENGINEER LS

SEAL

PROJECT:	<b>ALLANDALE PIT</b>	COLWOOD FILE NO.	RFP-2017-01
TITLE:	<b>PUMPING SYSTEM PROPOSED SITE LIFT STATION</b>	COLWOOD CONTRACT NO.	RFP-2017-01
DATE:	2017-03-21	SCALE:	AS NOTED
DRAWING NO.	DWG-J0008	SHEET:	8 of 10
		REV:	INP



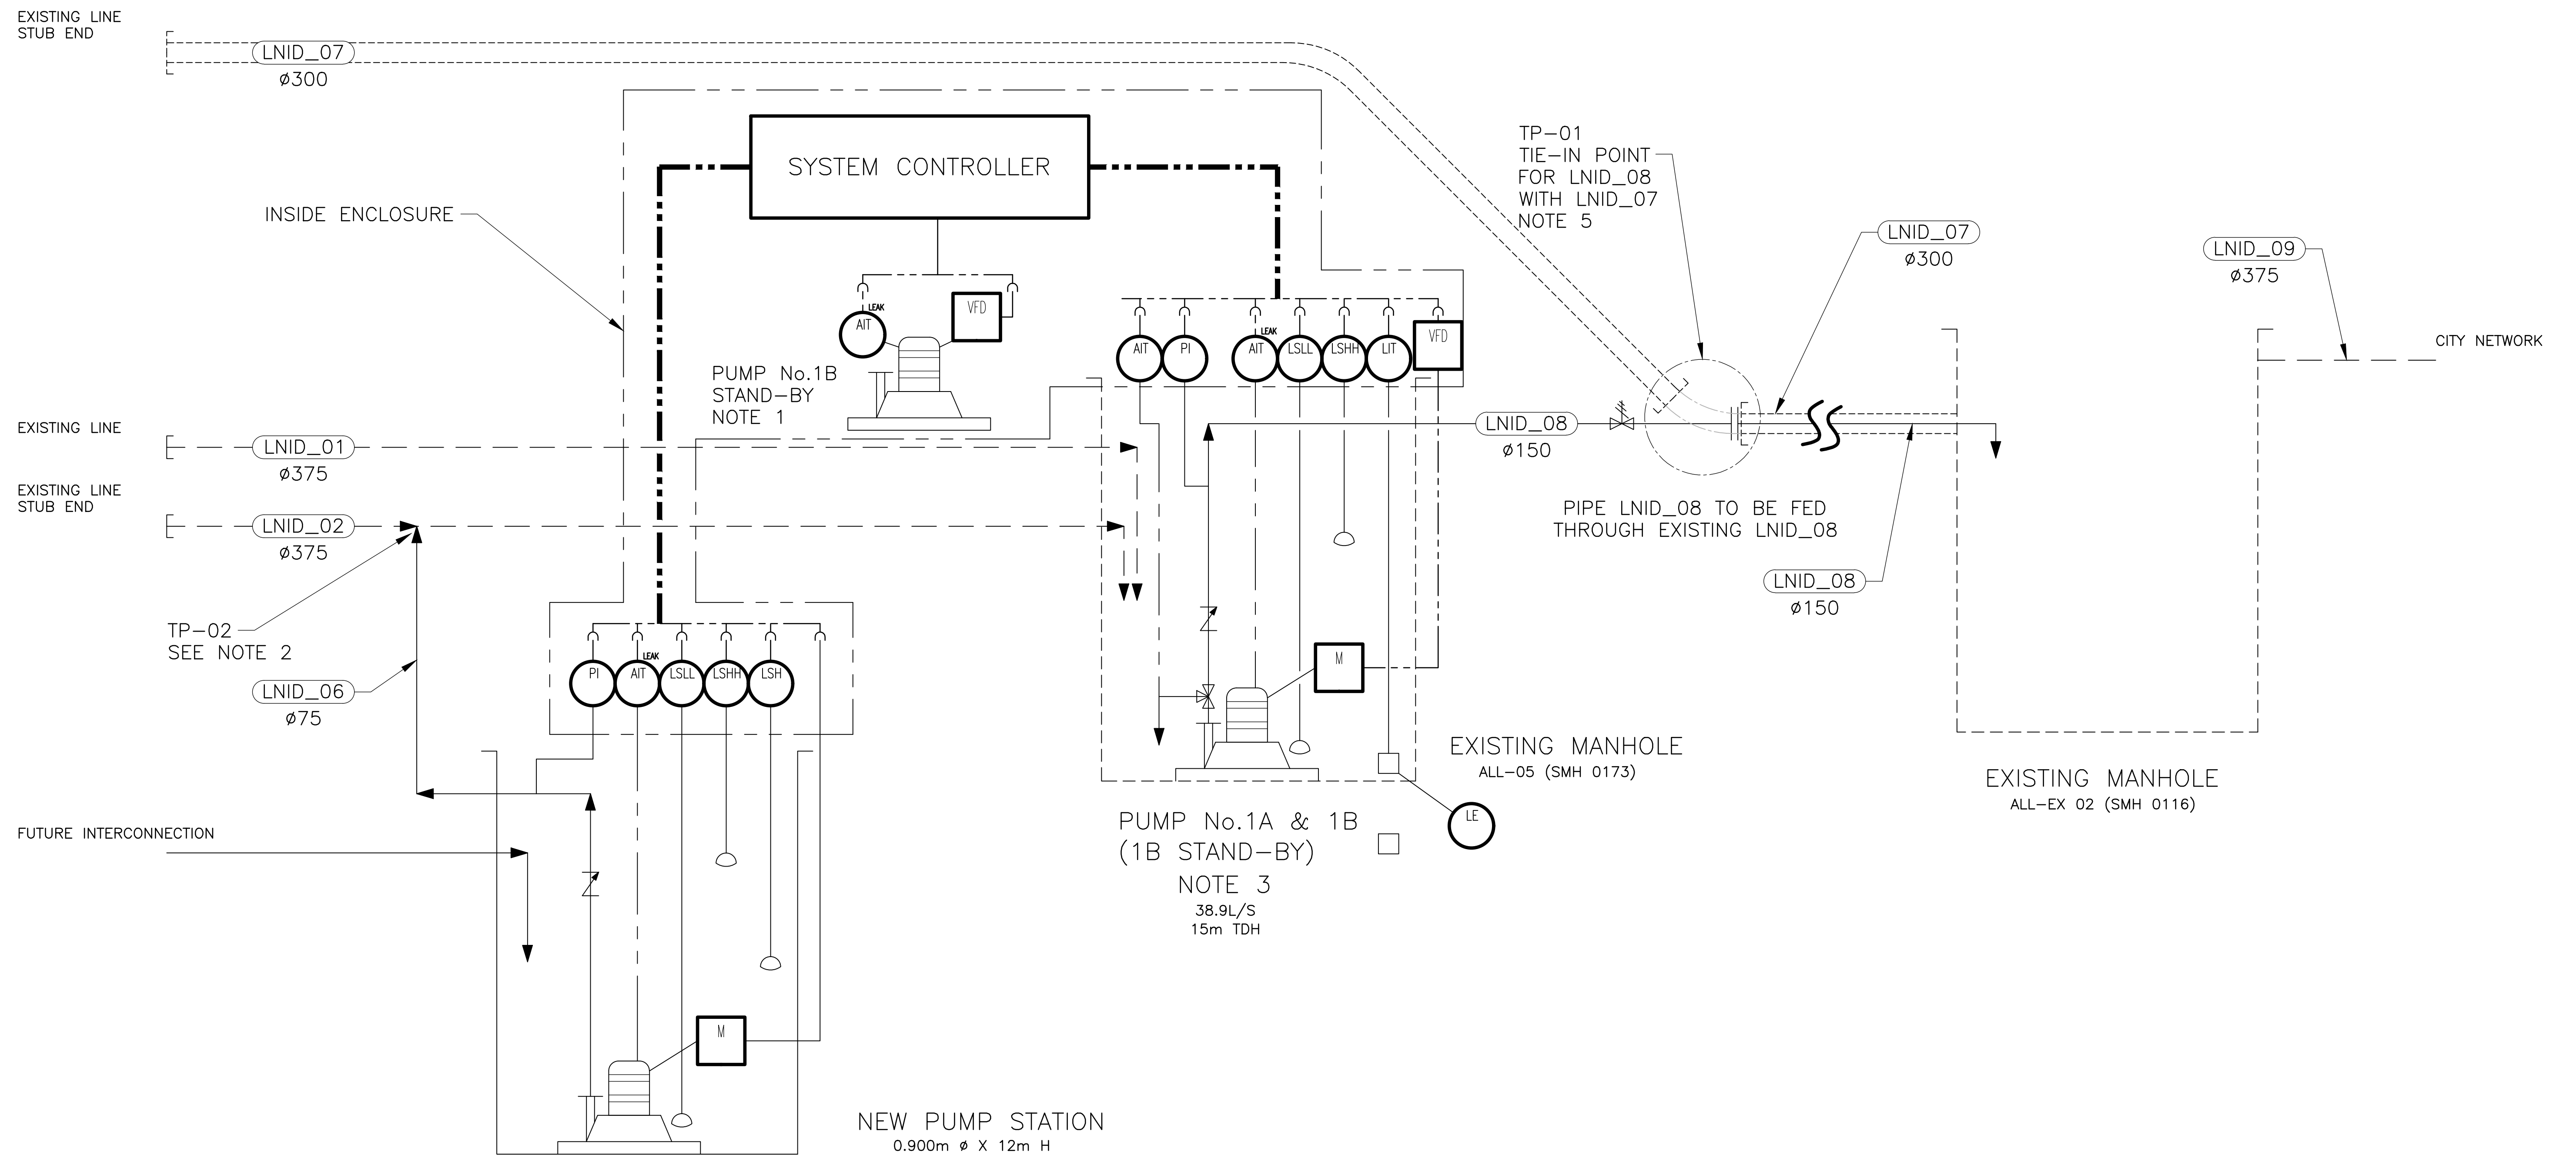

- NOTES:
1. STAND-BY PUMP TO BE WIRED AND READY FOR IMMEDIATE USE.
  2. ALTERNATE LOCATIONS FOR TIE POINT OTHER THAN AS SHOWN, DIRECTLY TO SMH0173 OR LNID\_07 TO EXISTING DRAINAGE LINES. CONTRACTOR TO SELECT BEST TIE POINT BASED ON CONSTRUCTION PREFERENCE AND ACCESS TO EXISTING PIPING ELEMENTS.
  3. PUMP TO INCLUDE INTEGRAL FLUSH VALVE.
  4. SPARE PUMP TO BE A SHELF SPARE LOCATED IN ENCLOSURE.
  5. PIPE CONNECTION TO BE REMOVED TO ACCESS LNID\_08.

No.	DATE	REVISION	ENGR	EXISTING	PROPOSED	EXISTING	PROPOSED	EXISTING	PROPOSED	EXISTING	PROPOSED
A	3/2017	INDICATIVE DESIGN	LS	MANHOLE CLEANOUT LIFT STATION INSPECTION CHAMBER CATCH BASIN SILT TRAP SEEPAGE PIT CULVERT DITCH HYDRANT WATER VALVE FLUSH VALVE	AIR VALVE WATER METER IRRIGATION VALVE UTILITY MANHOLE * SERVICE BOX * LPT UTILITY POLE * POLE-MOUNT LS ORNAMENTAL LUMINAIRE TRAFFIC SIGNAL	SANITARY SANITARY FORCEMAIN STORM DRAIN WATER GAS ELECTRICAL ROAD CURB EDGE OF PAVEMENT DRIVEWAY SIDEWALK PROPERTY LINE EASEMENT	FENCE SLOPE - TOP SLOPE - BOTTOM CONTOUR - MAJOR CONTOUR - MINOR BOUNDARY BUILDING ENVELOPE VEGETATION LINE	BENCHMARK: ELEVATION:			



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DESIGN LS  
 DRAW MT  
 CHECKED DM  
 ENGINEER LS

PROJECT:	<b>ALLANDALE PIT</b>	COLWOOD FILE NO.	RFP-2017-01
TITLE:	<b>PUMPING SYSTEM STATION</b>	COLWOOD CONTRACT NO.	RFP-2017-01
	<b>PIPING AND INSTRUMENTATION DIAGRAM</b>	SCALE:	AS NOTED
DATE:	2017-03-21	COPYRIGHT OF THIS DRAWING RETAINED BY CITY OF COLWOOD. APPLY FOR PERMISSION TO USE ANY PORTION.	
DRAWING NO.	PID-P0001	SHEET:	9 of 9
		REV:	INP